



STATE OF NORTH CAROLINA  
DEPARTMENT OF TRANSPORTATION

BEVERLY EAVES PERDUE  
GOVERNOR

EUGENE A. CONTI, JR.  
SECRETARY

October 3, 2012

Wilmington Regulatory Field Office  
US Army Corps of Engineers  
69 Darlington Avenue  
Wilmington, North Carolina 28403

ATTN: Mr. Brad Shaver  
NCDOT Coordinator

Dear Mr. Shaver:

**Subject: Application for Individual Section 404 Permit and Section 401 Water Quality Certification**  
for the proposed construction of an extension of SR 1163 (Old Georgetown Rd) from SR 1184 (Ocean Isle Beach Rd) to NC 179 in Brunswick County, State Project 6.231023, TIP R-3432.  
Debit \$570.00 from WBS 35501.1.1

The North Carolina Department of Transportation (NCDOT), Division of Highways proposes to construct an extension of SR 1163 (Georgetown Road) from SR 1184 to NC 179 in Brunswick County.

The purpose of this letter is to request approval for a Section 404 Individual Permit and a Section 401 Water Quality Certification. In addition to the cover letter and ENG Form 4345, this application package includes the following for R-3432: stormwater management plan, permit drawings, utility plans, half size roadway plans, and EEP Acceptance Letter.

## 1.0 Purpose and Need

The purpose for this project, as identified in the Final State Environmental Assessment (SEA), is to alleviate traffic congestion and improve safety along NC 179 and to establish a more efficient travel route between the towns of Shallotte and Calabash.

## 2.0 Project Description

The NCDOT proposes to extend SR 1163 (Old Georgetown Road) from SR 1184 (Ocean Isle Beach Road) to NC 179 (Bricklanding Road). Dual lane roundabouts will be constructed at each of the abovementioned intersections. Total project length is 2.9 miles.

**MAILING ADDRESS:**  
NC DEPARTMENT OF TRANSPORTATION  
PROJECT DEVELOPMENT AND ENVIRONMENTAL ANALYSIS  
1598 MAIL SERVICE CENTER  
RALEIGH NC 27699-1598

TELEPHONE: 919-707-6100  
FAX: 919-212-5785  
**WEBSITE:** [WWW.NCDOT.ORG](http://WWW.NCDOT.ORG)

**LOCATION:**

1020 BIRCH RIDGE DRIVE  
RALEIGH NC 27610-4328

### **3.0 Summary of Impacts**

Waters of the U.S.: Proposed impacts to jurisdictional areas total 0.73 acre of permanent riparian wetland impacts, 0.10 acre of surface water impacts, 0.01 acre of temporary surface water impacts, 366 feet of permanent stream impacts, and 25 feet of temporary stream impacts.

### **4.0 Summary of Mitigation**

The proposed construction of R-3432 will impact 0.73 acre of jurisdictional riparian wetlands that will require mitigation. The unavoidable impacts to the 0.73 acre of jurisdictional riparian wetlands will be offset by compensatory mitigation provided by the NC Ecosystem Enhancement Program (EEP). In addition, the unavoidable impacts to 366 linear feet of jurisdictional stream will also be offset by compensatory mitigation provided by EEP.

### **5.0 Project Schedule**

Currently, R-3432 has a review date of April 30, 2013 and is scheduled to let June 18, 2013; it will be available for construction shortly thereafter. The let date, however, may advance as additional funds become available.

### **6.0 SEPA Document Status**

The NCDOT completed the SEA March 25, 2009 in compliance with SEPA guidelines. The SEA explains the purpose and need for the project, provides a description of the alternatives considered, and characterizes the social, economic, and environmental effects. The SEA was approved and circulated to federal, state, and local agencies. Then following the SEA, a State Finding of No Significant Impact (SFONSI) Statement was completed January 8, 2010, and an Environmental Document Update was completed August 29, 2011. Copies of the project documents have been provided to regulatory review agencies involved in the approval process. Additional copies will be provided upon request.

#### ***6.1 Independent Utility***

R-3432 meets the criteria for independent utility as discussed below:

- The project has logical termini and independent utility and is of sufficient length to address environmental matters on a broad scope;
- The project is usable and a reasonable expenditure of funds, even if no additional transportation improvements are made in the area; and
- The project does not restrict consideration of alternatives for other reasonably foreseeable transportation improvements.

### **7.0 Resource Status**

The project is located in the Lumber River Basin and lies within Hydrologic Unit 03040207. This is within the Southern Outer Coastal Plain eco-region.

#### ***7.1 Wetland Delineations***

A wetland identification and preliminary assessment analysis for the study area was performed and summarized in the 2008 Natural Resources Technical Report (NRTR). The wetlands within the study area were delineated based on the 1987 U.S. Army Corps of Engineers (USACE) Wetland Delineation Manual and a preliminary design was prepared to avoid and minimize wetlands to the maximum extent possible.

Wetland delineations were completed in early 2006 and field verified by Mr. Dave Timpy of the USACE, Wilmington District on March 6, 2006. Subsequently, wetland delineations were updated in June 2011. This delineation was then field verified by Mr. Brad Shaver of the USACE, Wilmington District on October 14, 2011.

## 7.2 Stream Delineations

Data collected for streams were derived from USGS topographic maps, the Brunswick County Soil Survey (USDA, 1986), and site reconnaissance. The data included stream classification, which was presented in the NRTR. The USACE concurred on stream classifications on October 14, 2011, when Mr. Brad Shaver with the USACE visited the site.

## 7.3 R-3432: Characterization of Jurisdictional Sites

### 7.3.1 Wetlands

There are two wetland communities (classified under NCWAM Guidelines) found within the project study area: Headwater Forest and Pine Flat. In the SEA and the NRTR Cowardin *et al.* 1979 along with a Riverine/Non-Riverine designation were used to classify wetland communities. Therefore these two communities are described as PFO3,4 Riverine and PFO4 Non-Riverine respectively.

### 7.3.2 Streams

Best Usage Classifications for jurisdictional streams are provided in the SEA. Due to the project's proximity to the coast, several waters designated as High Quality Water (HQW) SA occur within 1.0 mile of the project area. These waters are HQW due to their supplemental classification (SA) of Tidal Salt Waters that are used for commercial shellfishing or marketing purposes. As such, NCDOT's Design Standards in Sensitive Watersheds will be implemented for this project.

Neither Water Supplies (WS-I: undeveloped watersheds or WS-II: predominately undeveloped watersheds), nor Outstanding Resource Waters (ORW) occur within 1.0 mile of the project study area. The tributaries impacted by this project are not designated as North Carolina Natural or Scenic Rivers, or as National Wild and Scenic Rivers. Additionally, these waters are not listed on the Final 2010 303(d) list of impaired waters due to sedimentation or turbidity for the Lumber River Basin, nor do they drain into any Section 303(d) impaired waters due to sedimentation or turbidity within 1.0 mile of the project study area.

## 7.4 Impacts to Jurisdictional Resources

Impacts to jurisdictional wetlands and surface waters for R-3432 are summarized below in Tables 1 & 2 respectively. Wetland impacts have increased since the completion of the SFONSI; however, this was noted in the Environmental Document Update, dated August 29, 2011. Additionally, stream impacts have increased since the Environmental Document Update due to the need to realign the stream at site 5 to correct problems with scour and headcutting.

**Table 1. R-3432 Wetlands Impacts**

Permit Drawing Site Number (2012)	Map Label in SEA (2009)/Label for JD (2011)	Type	Permanent Impacts (ac.)	Temporary Impacts (ac.)	Mitigation Required
2	WC/WC	Riparian	0.03	0	Yes
3	WC/WC	Riparian	0.51	0	Yes
4	WC/WD	Riparian	0.19	0	Yes
<b>Total:</b>			<b>0.73</b>	<b>0</b>	

**Table 2. R-3432 Surface Water Impacts**

<b>Permit Drawing Site Number</b>	<b>Map Label in SEA (2009)/Label for JD (2011)</b>	<b>Permanent (ft)</b>	<b>Temporary (ft)</b>	<b>Permanent (ac.)</b>	<b>Temporary (ac.)</b>	<b>Mitigation Required*</b>
1	Not Listed/SC	0	0	0.03	< 0.01	No
2	Not Listed/SB	200	10	0.05	< 0.01	Yes
5	SE/SA	166	15	0.02	< 0.01	Yes
<b>Total:</b>		<b>366</b>	<b>25</b>	<b>0.10</b>	<b>0.01</b>	

\*For permanent linear impacts

**Permanent Impacts:** Proposed permanent impacts for R-3432 include fill, excavation, and mechanized clearing to 0.73 acre of riparian wetlands. Proposed permanent impacts to surface waters are 366 linear feet (0.10 acre), which includes two pipes proposed to be installed in unnamed tributaries (UT) to Jinnys Branch (sites 2 & 5) and a pipe installation in a tributary to Waters of the U.S. (site 1).

**Temporary Impacts:** There will be 25 linear feet (0.01 acre) of temporary impacts to surface water due to pipe installations.

**Utility Impacts:** There will be no impacts to jurisdictional resources resulting from project construction.

## 8.0 Protected Species

The United States Fish and Wildlife Service (USFWS) list 13 federally protected species for Brunswick County as of the March 21, 2011 listing (Table 3).

**Table 3. Federally Protected Species in Brunswick County**

<b>Scientific Name</b>	<b>Common Name</b>	<b>Federal Status</b>	<b>Habitat</b>	<b>Biological Conclusion</b>
<i>Alligator mississippiensis</i>	American alligator	T(S/A)	No	N/A
<i>Chelonia mydas</i>	Green sea turtle	T	No	No Effect
<i>Lepidochelys kempii</i>	Kemp's ridley sea turtle	E	No	No Effect
<i>Dermochelys coriacea</i>	Leatherback sea turtle	E	No	No Effect
<i>Caretta caretta</i>	Loggerhead sea turtle	T	No	No Effect
<i>Charadrius melanotos</i>	Piping plover	T	No	No Effect
<i>Picoides borealis</i>	Red-cockaded woodpecker	E	Yes	No Effect
<i>Mycteria americana</i>	Wood stork	E	No	No Effect
<i>Acipenser brevirostrum</i>	Shortnose sturgeon	E	No	No Effect
<i>Trichechus manatus</i>	West Indian manatee	E	No	No Effect
<i>Thalictrum cooleyi</i>	Cooley's meadowrue	E	Yes	No Effect
<i>Lysimachia asperulaefolia</i>	Rough-leaved loosestrife	E	Yes	No Effect
<i>Amaranthus pumilus</i>	Seabeach amaranth	T	No	No Effect

Key: E= Endangered, T= Threatened, T(S/A)= Threatened(Similarity of Appearance)

A review of the North Carolina Natural Heritage Program (NCNHP) database, updated April 2012, indicated no known occurrences of protected species within one mile of the project study area.

## 8.1 Bald and Golden Eagle Protection Act (BGPA)

In the July 9, 2007 Federal Register (72:37346-37372), the bald eagle was declared recovered, and removed

(de-listed) from the Federal List of Threatened and Endangered wildlife. This delisting took effect August 8, 2007. After delisting, the Bald and Golden Eagle Protection Act (Eagle Act) (16 U.S.C. 668-668d) became the primary law protecting bald eagles. For this project, it has been concluded that no nesting or foraging habitat exists in or within 660 feet of the project limits.

## **8.2      *Moratoria***

No moratoria have been recommended for R-3432.

## **9.0      Cultural Resources**

An updated archaeological investigation was completed for the project area in November 2009. No eligible sites were discovered in the project area. On December 10, 2009, the State Historic Preservation Office (SHPO) sent a letter to NCDOT stating that they had reviewed and concurred with the conclusions in the updated archaeological report; therefore, no additional investigations will be necessary.

In letters dated April 4, 1996 and August 8, 2006, the North Carolina Historic Preservation Office (NCHPO) determined that this project as it is proposed will not affect any historic structures.

## **10.0     FEMA Compliance**

The project has been coordinated with appropriate state and local officials and the Federal Emergency Management Agency (FEMA) to assure compliance with FEMA, state, and local floodway regulations.

## **11.0     Mitigation Options**

The NCDOT is committed to incorporating all reasonable and practicable design features to avoid and minimize jurisdictional impacts, and to provide full compensatory mitigation of all remaining, unavoidable jurisdictional impacts. Avoidance measures were taken during the planning and NEPA compliance stages; minimization measures were incorporated as part of the project design.

### ***11.1    Avoidance and Minimization***

All jurisdictional features were delineated, field verified and surveyed within the corridor for R-3432. Using these surveyed features, preliminary designs were adjusted to avoid and/or minimize impacts to jurisdictional areas. NCDOT employs many strategies to avoid and minimize impacts to jurisdictional areas in all of its designs. Many of these strategies have been incorporated into BMP documents that have been reviewed and approved by the resource agencies and which will be followed throughout construction. All wetland areas not affected by the project will be protected from unnecessary encroachment. Individual avoidance and minimization items are as follows:

- No staging of construction equipment or storage of construction supplies will be allowed in wetlands or near surface waters.
- The project was designed to avoid or minimize disturbance to aquatic life movements.
- The selected alternative was chosen to avoid a potential Environmental Justice issue as well as minimize wetland impacts.
- NCDOT and its contractors will not excavate, fill, or perform land clearing activities within Waters of the U.S. or any areas under the jurisdiction of the USACE, except as authorized by the USACE. To ensure that all borrow and waste activities occur on high ground, except as authorized by permit, the NCDOT shall require its contractors to identify all areas to be used to borrow material, or to dispose of dredged, fill or waste material. Documentation of the location and characteristics of all borrow and disposal sites associated with the project will be available to the USACE on request.

- Storm water will be treated using grass swales.
- The use of 3:1 fill slopes in all jurisdictional areas.
- Design Standards in Sensitive Watersheds will be implemented.
- Grassed ditches, shoulders, and slopes were incorporated to aid in treatment of runoff.
- Re-alignment of stream and pipe at -Y10- STA. 29+50 is necessary to correct issues of scour and headcutting.
- Minimized use of curb and gutter and maintained grass shoulder sheet flow throughout project to the maximum extent practical.

### **11.3 Compensation**

The NCDOT has avoided and minimized impacts to jurisdictional resources to the greatest extent possible as described above. The unavoidable impacts to jurisdictional riparian wetlands and surface waters will be offset by compensatory mitigation provided by the EEP. A copy of the EEP acceptance letter, dated June 7, 2012, is attached.

### **12.0 Indirect and Cumulative Effects**

As detailed in the 2008 Indirect and Cumulative Effects (ICE) analysis, Land use change is anticipated to occur within the boundaries of the Future Land Use Study Area (FLUSA) along US Highway 17 and NC 179 regardless of the construction of the proposed project. This will be facilitated primarily by the notable increase in population that has been projected over the next decade. According to local planning officials, the population growth in Brunswick County is expected to continue.

Brunswick County adheres to a Unified Development Ordinance and has a central permitting office and planning department that oversees the enforcement of the zoning ordinances. The two largest zoning districts within Brunswick County are Residential Agriculture and Residential. These two districts account for 92.1 percent of the County's land that is not included within a municipality's corporate limits or extraterritorial jurisdiction. The FLUSA is not within a municipality's corporate limits or extraterritorial jurisdiction, but is adjacent to the satellite range where Ocean Isle Beach supply's sewer service. There are currently no public sewers in the project area.

To accommodate growth that has already occurred and to prepare for future growth, the County has developed goals for managed growth, infrastructure, economic development, job growth, and quality of life issues. Brunswick County has developed a CAMA Land Use Plan titled, *Brunswick County Core Land Use Plan* (2007, recertified 2011), which includes the implementation of the improved stormwater rules in coastal counties.

Brunswick County also considers the protection of environmentally sensitive resources including NWI wetland areas and Significant Natural Heritage Areas to be imperative in consideration of the development pressures that have recently been experienced by the County. There are a notable amount of NWI identified wetlands and a designated Significant Natural Heritage Areas (specifically the Sandy Branch Sand Ridge and Bay Complex) within the FLUSA.

Although the project may improve accessibility to some developable land within the FLUSA, the lack of municipal sewer service, the existence of environmentally sensitive areas, and coastal county stormwater regulations, are anticipated to constrain the development of parcels immediately adjacent to the proposed project. Future development within the FLUSA is expected to be concentrated along US Highway 17, and NC 179, where infrastructure is already available to support both commercial and residential growth.

## **13.0 Regulatory Approvals**

Section 404: Application is hereby made for a USACE Individual 404 Permit as required for the above-described activities.

Section 401: We are also requesting a Section 401 Water Quality Certification from the NCDWQ. We are providing five (5) copies of this application to the NCDWQ, for their approval.

CAMA: Under separate cover, NCDOT is submitting a request for a CAMA Federal Consistency Review from the N. C. Division of Coastal Management for R-3432.

A copy of this permit application and its distribution list will be posted on the NCDOT website at:  
<http://www.ncdot.org/doh/preconstruct/pe/neu/permit.html>

If you have any questions or need additional information, please contact Tyler Stanton at 919-707-6156 or [tstanton@ncdot.gov](mailto:tstanton@ncdot.gov).

Sincerely,

*for*

*E.J. Lusk*

Gregory J. Thorpe, Ph.D., Manager  
Project Development and Environmental Analysis Unit

cc:

NCDOT Permit Application Standard Distribution List.

**APPLICATION FOR DEPARTMENT OF THE ARMY PERMIT  
(33 CFR 325)**

**OMB APPROVAL NO. 0710-0003  
EXPIRES: 31 August 2012**

Public reporting burden for this collection of information is estimated to average 11 hours per response, including the time for reviewing instructions, searching existing data sources, gathering and maintaining the data needed, and completing and reviewing the collection of information. Send comments regarding this burden estimate or any other aspect of this collection of information, including suggestions for reducing this burden, to Department of Defense, Washington Headquarters, Executive Services and Communications Directorate, Information Management Division and to the Office of Management and Budget, Paperwork Reduction Project (0710-0003). Respondents should be aware that notwithstanding any other provision of law, no person shall be subject to any penalty for failing to comply with a collection of information if it does not display a currently valid OMB control number. Please DO NOT RETURN your form to either of those addresses. Completed applications must be submitted to the District Engineer having jurisdiction over the location of the proposed activity.

**PRIVACY ACT STATEMENT**

Authorities: Rivers and Harbors Act, Section 10, 33 USC 403; Clean Water Act, Section 404, 33 USC 1344; Marine Protection, Research, and Sanctuaries Act, Section 103, 33 USC 1413; Regulatory Programs of the Corps of Engineers; Final Rule 33 CFR 320-332. Principal Purpose: Information provided on this form will be used in evaluating the application for a permit. Routine Uses: This information may be shared with the Department of Justice and other federal, state, and local government agencies, and the public and may be made available as part of a public notice as required by Federal law. Submission of requested information is voluntary, however, if information is not provided the permit application cannot be evaluated nor can a permit be issued. One set of original drawings or good reproducible copies which show the location and character of the proposed activity must be attached to this application (see sample drawings and instructions) and be submitted to the District Engineer having jurisdiction over the location of the proposed activity. An application that is not completed in full will be returned.

**(ITEMS 1 THRU 4 TO BE FILLED BY THE CORPS)**

1. APPLICATION NO.	2. FIELD OFFICE CODE	3. DATE RECEIVED	4. DATE APPLICATION COMPLETE
--------------------	----------------------	------------------	------------------------------

**(ITEMS BELOW TO BE FILLED BY APPLICANT)**

5. APPLICANT'S NAME: First – Greg Middle - Last – Thorpe, Ph.D. Company – NC Department of Transportation (NCDOT) E-mail Address – gthorpe@ncdot.gov	8. AUTHORIZED AGENT'S NAME AND TITLE (an agent is not required) First – Middle - Last – Company – E-mail Address –
6. APPLICANT'S ADDRESS. Address – 1598 Mail Service Center City – Raleigh State – NC Zip – 27699-1598 Country – USA	9. AGENT'S ADDRESS Address – 1 City – State – Zip – Country – USA
7. APPLICANT'S PHONE NOS. W/AREA CODE. a. Residence- NA b. Business- c. Fax	10. AGENT'S PHONE NOS. W/AREA CODE a. Residence- NA b. Business- c. Fax

**STATEMENT OF AUTHORIZATION**

11. I hereby authorize, \_\_\_\_\_ to act in my behalf as my agent in the processing of this application and to furnish, upon request, supplemental information in support of this permit application.

APPLICANT'S SIGNATURE

DATE

**NAME, LOCATION, AND DESCRIPTION OF PROJECT OR ACTIVITY**

12. PROJECT NAME OR TITLE (see instructions) R-3432 – Extension of SR 1163 (Georgetown Rd) From SR 1184 (Ocean Isle Beach Rd) to NC 179	
13. NAME OF WATERBODY, IF KNOWN (if applicable),	14. PROJECT STREET ADDRESS (if applicable) Address - NA
15. LOCATION OF PROJECT: Decimal degrees NAD 83, center coordinates are approximately Latitude: 33.932002 N Longitude: -78.427885 W	City - State - Zip -
16. OTHER LOCATION DESCRIPTIONS, IF KNOWN (see instructions) State Tax Parcel ID – Municipality – Section - Township - Range -	

17. DIRECTIONS TO THE SITE:

**Please see attached permit drawings**

18. Nature of Activity (Description of project, include all features)

The NCDOT proposes to extend SR 1163 (Old Georgetown Road) from SR 1184 (Ocean Isle Beach Road) to NC 179 (Bricklanding Road). Dual lane roundabouts will be constructed at each of the abovementioned intersections. Total project length is 2.9 miles.

19. Project Purpose (Describe the reason or purpose of the project, see Instructions)

**The purpose for this project, as identified in the Final State Environmental Assessment (SEA), is to alleviate traffic congestion and improve safety along NC 179 and to establish a more efficient travel route between the towns of Shallotte and Calabash.**

**USE BLOCKS 20-23 IF DREDGED AND/OR FILL MATERIAL IS TO BE DISCHARGED**

20. Reason(s) for Discharge

**Construction of roadway and pipe installations**

21. Type(s) of Material Being Discharged and the Amount of Each Type in Cubic Yards:

**Please see attached permit drawings**

22. Surface Area in Acres of Wetlands or Other Waters Filled (see instructions) Acres Or Liner Feet

**Permanent: 0.73 acre riparian wetlands, 0.10 acre surface waters, 366 feet of stream**

**Temporary: 0.01 acre of surface waters, 25 feet of stream**

23. Description of Avoidance, Minimization, and Compensation (see instructions)

**Please see attached permit application cover letter**

24. Is Any Portion of the Work Already Complete? Yes    No   X  

IF YES, DESCRIBE THE COMPLETED WORK

25. Addresses of Adjoining Property Owners, Lessees, Etc., Whose Property Adjoins the Waterbody (If more than can be entered here, please attach a supplemental list).

Please see attached

26. List of Other Certifications or Approvals/Denials Received from other Federal, State, or Local Agencies for Work Described in This Application.

Agency	Type Approval*	Identification Number	Date Applied	Date Approved	Date Denied

\* Would include but is not restricted to zoning, building, and flood plain permits

27. Application is hereby made for a permit or permits to authorize the work described in this application. I certify that the information in this application is complete and accurate. I further certify that I possess the authority to undertake the work described herein or am acting as the duly authorized agent of the applicant.

E.L. Lusk for Gregory J. Thayko, PhD  
SIGNATURE OF APPLICANT

DATE

Oct 3, 2012  
DATE

SIGNATURE OF AGENT

The application must be signed by the person who desires to undertake the proposed activity (applicant) or it may be signed by a duly authorized agent if the statement in block 11 has been filled out and signed.

18 U.S.C. Section 1001 provides that: Whoever, in any manner within the jurisdiction of any department or agency of the United States knowingly and willfully falsifies, conceals, or covers up any trick, scheme, or disguises a material fact or makes any false, fictitious or fraudulent statements or representations or makes or uses any false writing or document knowing same to contain any false, fictitious or fraudulent statements or entry, shall be fined not more than \$10,000 or imprisoned not more than five years or both.



June 7, 2012

Mr. Gregory J. Thorpe, Ph.D.  
Manager, Project Development and Environmental Analysis Unit  
North Carolina Department of Transportation  
1548 Mail Service Center  
Raleigh, North Carolina 27699-1548

Dear Dr. Thorpe:

Subject: EEP Mitigation Acceptance Letter:

R-3432, SR 1163 (Georgetown Road Extension) from SR 1184 (Ocean Isle Beach Road) to NC 179, Brunswick County

The purpose of this letter is to notify you that the Ecosystem Enhancement Program (EEP) will provide the compensatory stream and riparian wetland mitigation for the subject project. Based on the information supplied by you on June 5, 2012, the impacts are located in CU 03040207 of the Lumber River basin in the Southern Outer Coastal Plain (SOCP) Eco-Region, and are as follows:

Lumber 03040207 SOCP	Stream			Wetlands			Buffer (Sq. Ft.)	
	Cold	Cool	Warm	Riparian	Non-Riparian	Coastal Marsh	Zone 1	Zone 2
Impacts (feet/acres)	0	0	366	0.73	0	0	0	0

EEP commits to implementing sufficient compensatory stream and riparian wetland mitigation credits to offset the impacts associated with this project as determined by the regulatory agencies in accordance with the N.C. Department of Environment and Natural Resources' Ecosystem Enhancement Program In-Lieu Fee Instrument dated July 28, 2010. If the above referenced impact amounts are revised, then this mitigation acceptance letter will no longer be valid and a new mitigation acceptance letter will be required from EEP.

If you have any questions or need additional information, please contact Ms. Beth Harmon at 919-715-1929.

Sincerely,



Michael Ellison  
EEP Deputy Director

cc: Mr. Brad Shaver, USACE – Wilmington Regulatory Field Office  
Mr. David Wainwright, Division of Water Quality, Wetlands/401 Unit  
File: R-3432

*Restoring... Enhancing... Protecting Our State*



RECEIVED

OCT 18 2011

U.S. ARMY CORPS OF ENGINEERS  
WILMINGTON DISTRICT

DIVISION OF HIGHWAYS  
PDEA OFFICE OF NATURAL ENVIRONMENT

County: Brunswick

U.S.G.S. Quad: Shallotte

**NOTIFICATION OF JURISDICTIONAL DETERMINATION**

Applicant: NCDOT – NEU  
Address: attn: Mr. Tyler Stanton  
1598 Mail Service Center  
Raleigh, NC 27699-1598

Property description:

Size (acres) +/- 130 Nearest Town Ocean Isle  
Nearest Waterway Shallotte River River Basin Lower Pee Dee  
USGS HUC 03040201 Coordinates N 33.9359 W -78.4273

Location description The subject new location project (R 3432) would be an extension of Old Georgetown Road located north of Ocean Isle and would connect Ocean Isle Beach Road to Hale Swamp Rd. in Brunswick County.

Indicate Which of the Following Apply:

**A. Preliminary Determination**

- Based on preliminary information, there may be wetlands and waters on the above described property. We strongly suggest you have this property inspected to determine the extent of Department of the Army (DA) jurisdiction. To be considered final, a jurisdictional determination must be verified by the Corps. This preliminary determination is not an appealable action under the Regulatory Program Administrative Appeal Process ( Reference 33 CFR Part 331).

**B. Approved Determination**

- There are Navigable Waters of the United States within the above described property subject to the permit requirements of Section 10 of the Rivers and Harbors Act and Section 404 of the Clean Water Act. Unless there is a change in the law or our published regulations, this determination may be relied upon for a period not to exceed five years from the date of this notification.

- There are wetlands on the above described property subject to the permit requirements of Section 404 of the Clean Water Act (CWA)(33 USC § 1344). Unless there is a change in the law or our published regulations, this determination may be relied upon for a period not to exceed five years from the date of this notification.

We strongly suggest you have the wetlands on your property delineated. Due to the size of your property and/or our present workload, the Corps may not be able to accomplish this wetland delineation in a timely manner. For a more timely delineation, you may wish to obtain a consultant. To be considered final, any delineation must be verified by the Corps.

The wetland on your property have been delineated and the delineation has been verified by the Corps. We strongly suggest you have this delineation surveyed. Upon completion, this survey should be reviewed and verified by the Corps. Once verified, this survey will provide an accurate depiction of all areas subject to CWA jurisdiction on your property which, provided there is no change in the law or our published regulations, may be relied upon for a period not to exceed five years.

The wetlands and streams within your study area (R 3432) have been delineated and the delineation has been verified by the Corps. For reference purposes the Corps is utilizing the package submitted by Tyler Stanton of NEU (specifically the JD map received via email on 10/13/2011, attached) as the approximate location of the verified delineation. The delineation to date has been located by GPS.

- There are no waters of the U.S., to include wetlands, present on the above described property which are subject to the permit requirements of Section 404 of the Clean Water Act (33 USC 1344). Unless there is a change in the law or our published regulations, this determination may be relied upon for a period not to exceed five years from the date of this notification.

- The property is located in one of the 20 Coastal Counties subject to regulation under the Coastal Area Management Act (CAMA). You should contact the Division of Coastal Management in Washington, NC, at (252) 946-6481 to determine their requirements.

Placement of dredged or fill material within waters of the US and/or wetlands without a Department of the Army permit may constitute a violation of Section 301 of the Clean Water Act (33 USC § 1311). If you have any questions regarding this determination and/or the Corps regulatory program, please contact **Brad Shaver** at **910-251-4611**.

#### C. Basis For Determination

**The subject features appear to have both an ordinary high water mark and characteristics described in the 1987 Corps Delineation Manual. The aforementioned features ultimately drain to Jinnys Branch and the Shallotte River, both navigable waters of the US.**

#### D. Remarks

**The site was reviewed with Tyler Stanton of NCDOT (NEU) on 6/17/2010 and 6/14/2011. Individual property owners have been sent their appeal rights and instructions how to view the JD map. The property owners have until December 14, 2011 to appeal the JD call or provide information that could warrant another review.**

Corps Regulatory Official:




Date 10/14/2011

Expiration Date 10/14/2016

The Wilmington District is committed to providing the highest level of support to the public. To help us ensure we continue to do so, please complete the attached customer Satisfaction Survey or visit <http://www.saw.usace.army.mil/WETLANDS/index.html> to complete the survey online.

Copy furnished:

NC DOT Division 3 attn: Mr. Stonewall Mathis, 5501 Barbados Blvd Castle Hayne, NC 28429  
Emily Hughes, USACE Brunswick Project Manager

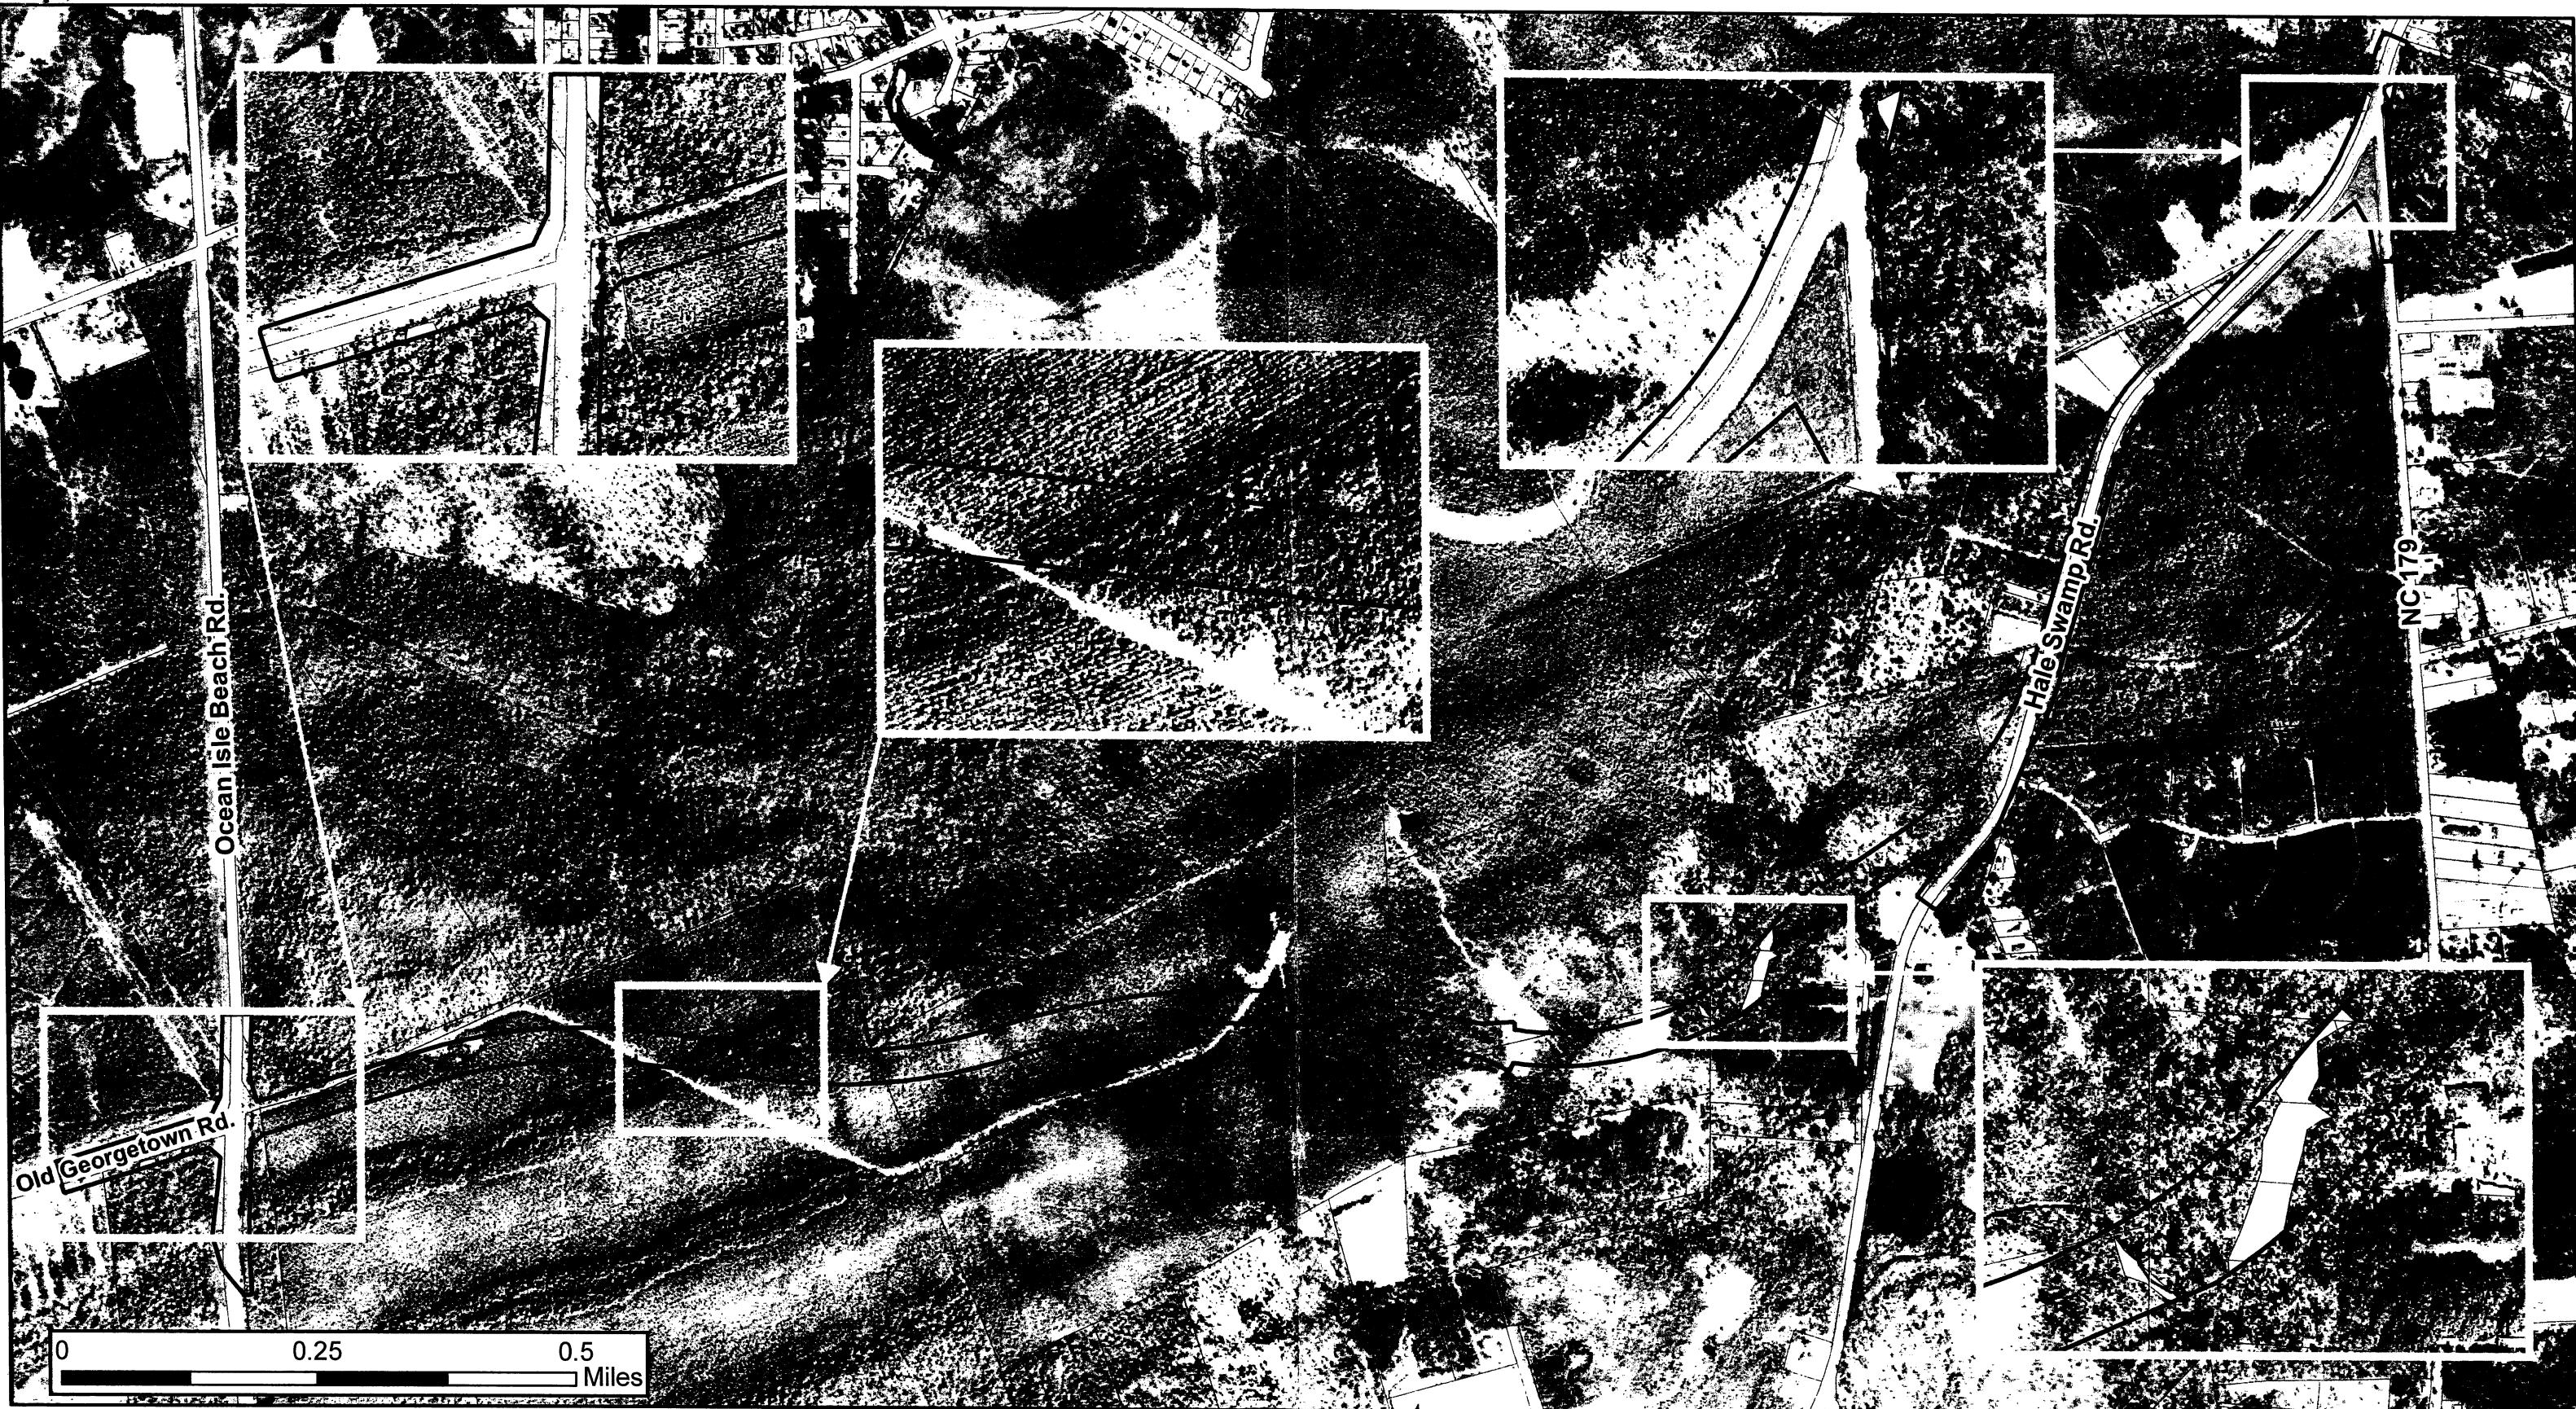

- Proposed Project Area\*
- Brunswick Co. Parcels (2010)
- Jurisdictional Tributaries
- Jurisdictional Wetlands

## NCDOT TIP R-3432

### Brunswick County

Proposed Extension of SR 1163 (Old Georgetown Rd.) from SR 1184 (Ocean Isle Beach Rd.) to NC 179



Prepared by the NCDOT  
Project Development &  
Environmental Analysis Branch  
Natural Environment Unit



North Carolina Department of Transportation  
Highway Stormwater Program  
**STORMWATER MANAGEMENT PLAN**  
FOR LINEAR ROADWAY PROJECTS




Project/TIP No.: R-3432

County(ies): Brunswick

Page 1 of 1

General Project Information			
Project No.:	R-3432	Project Type:	New Location
NCDOT Contact:	John W. Twisdale, Jr., PE	Date:	5/3/2012
Address:	1020 Birch Ridge Drive Raleigh, NC 27610	Contractor / Designer:	Paul Atkinson, PE
Phone:	919-707-6754	Address:	1020 Birch Ridge Drive Raleigh, NC 27610
Email:		Phone:	919-707-6707
City/Town:	Ocean Isle and Shallotte	Email:	
River Basin(s):	Lumber	County(ies):	Brunswick
Primary Receiving Water:	Unnamed Tributary Jinny's Branch	CAMA County?	Yes
NCDWQ Surface Water Classification for Primary Receiving Water	Primary: Supplemental:	NCDWQ Stream Index No.:	15-25-2-16-1-(1)
Other Stream Classification:	Class C Swamp Waters (Sw)		
303(d) Impairments:	None		
Buffer Rules in Effect	N/A		
Project Description			
Project Length (in. Miles or feet):	2.859 miles	Surrounding Land Use:	forestry land with some residential development along existing roadways at end of project
Project Built-Upon Area (ac.)	Proposed Project	Existing Site	
Typical Cross Section Description:	40' ROAD SHOULDER SECTION; 2 12 LANES, 8' SHOULDERS a.c.	Existing Site	a.c.
Average Daily Traffic (veh/h/day):	Design/Future: ADT 2032= 12,592 VPD	Existing:	ADT 2013= 7,312 VPD
General Project Narrative:	Minimizing use of curb and gutter and maintaining grass shoulder sheet flow throughout project to the maximum extent practical. In wetland areas, using 3:1 side slopes to minimize impacts. Using grassed ditches, shoulders, and slopes to aid in treatment of runoff. Re-alignment of stream and pipe at -Y10- STA. 29+50 is necessary to correct issues of scour and headcutting.		

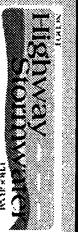

\* List all stream and surface water impact locations regardless of jurisdiction or size

Equalizer Pines to be noted as a minimization of impacts

All proposed SCMs listed must also be listed under Swales, Preformed Sour Holes and other Energy Dissipation or Other Stormwater Control Measures.

**\*\*SEE WETLAND PERMIT SUMMARY**

## Description of Minimization of Impacts or Mitigation


## References

**CONTRACT:**

**TIP PROJECT: R-3432**

09/08/99

See Sheet 1-A For Index of Sheets  
See Sheet 1-B For Conventional symbols

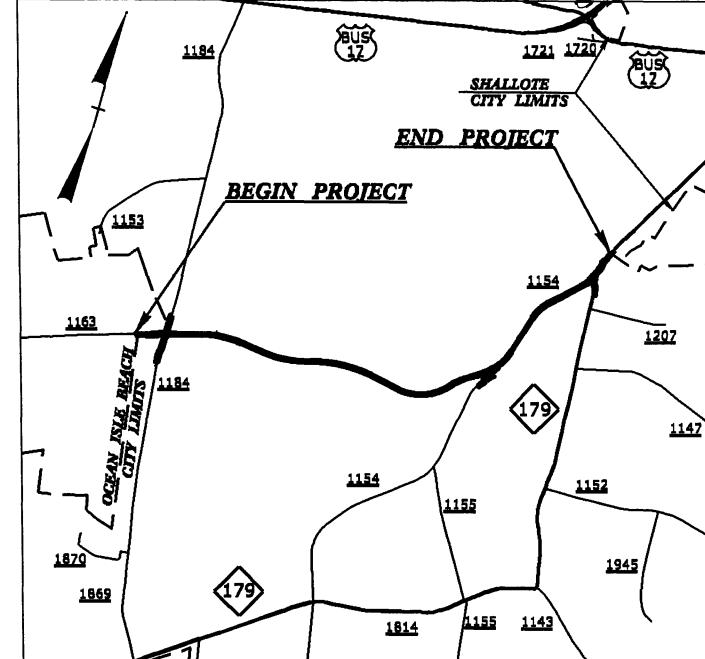

**VICINITY MAP**

**STATE OF NORTH CAROLINA  
DIVISION OF HIGHWAYS**



STATE	STATE PROJECT REFERENCE NO.	SHRIFT NO.	TOTAL SHEETS
N.C.	R-3432	1	
STATE PROJ. NO.	F.A. PROJ. NO.	DESCRIPTION	
35501.1.1		P.E.	
35501.2.1		RAW, UTL.	


# BRUNSWICK COUNTY

**LOCATION: SR 1163 (OLD GEORGETOWN ROAD EXTENSION) FROM SR 1184 (OCEAN ISLE BEACH ROAD) TO NC 179**


**TYPE OF WORK: GRADING, DRAINAGE, AND PAVING**

Permit Drawing  
Sheet 1 of 29

STA. 164 + 00.00 -L- END TIP PROJECT R-3432

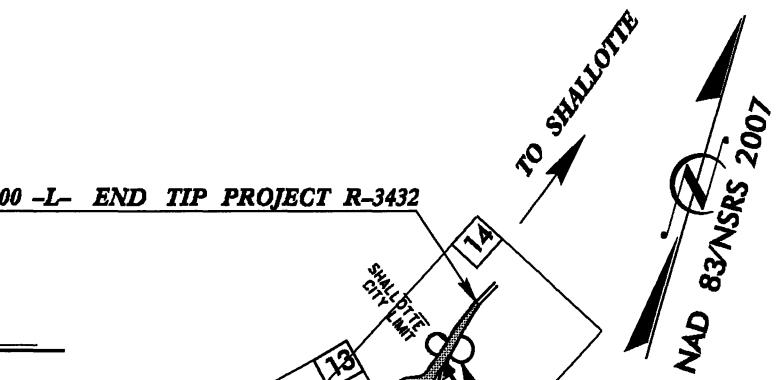


## WETLAND & SURFACE WATER PERMIT DRAWING

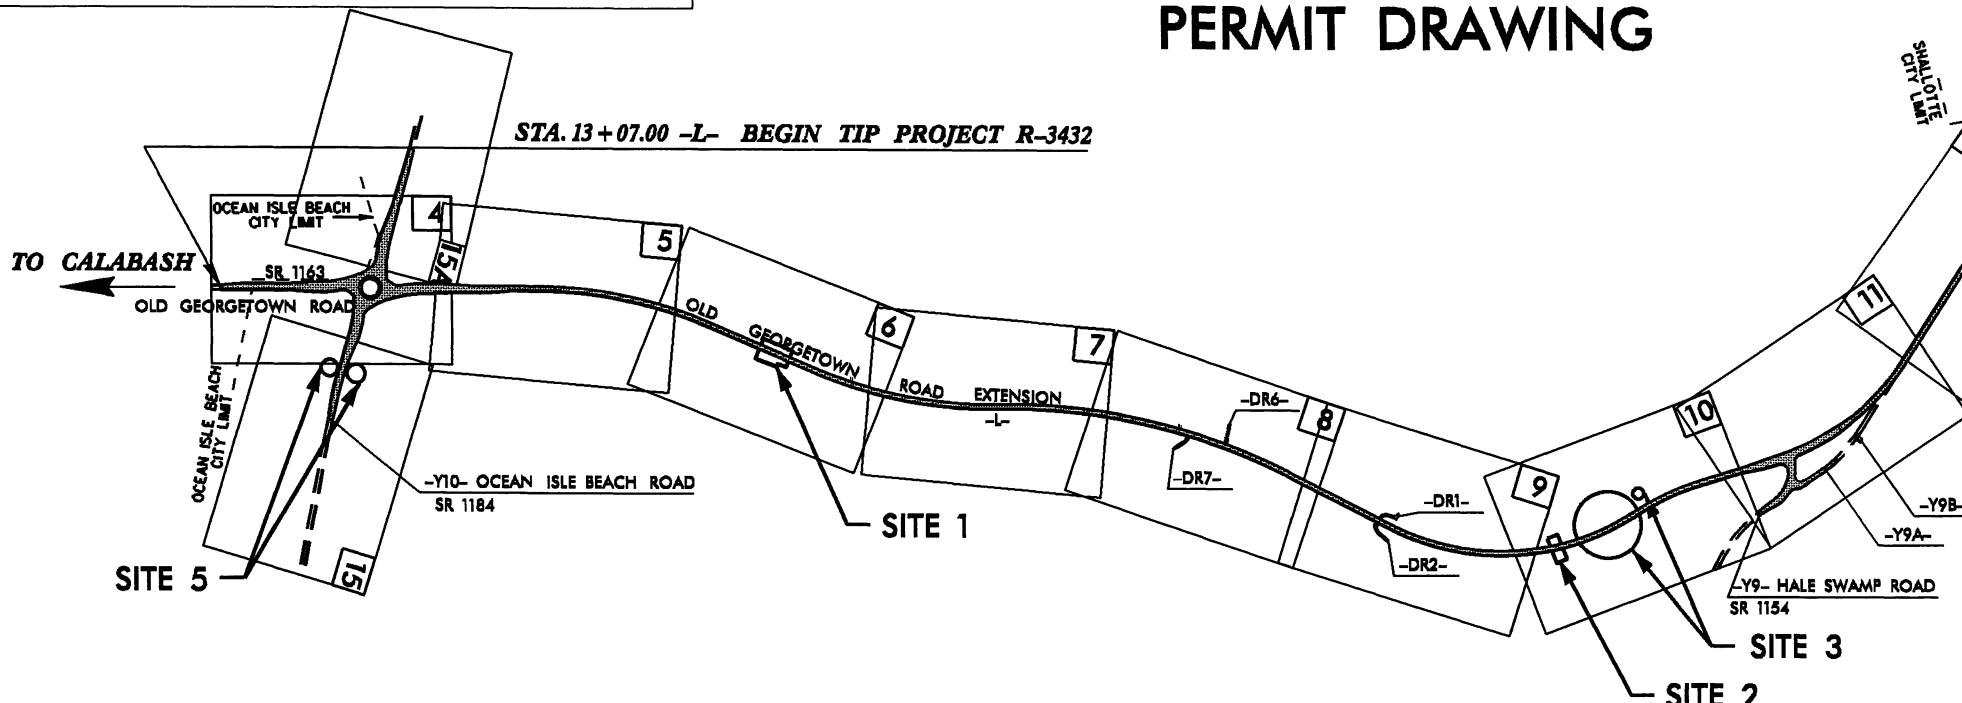

THIS IS A PARTIAL CONTROLLED-ACCESS PROJECT WITH ACCESS BEING LIMITED TO POINTS AS SHOWN ON THE PLANS.  
A PORTION OF THIS PROJECT IS WITHIN THE MUNICIPAL BOUNDARIES OF OCEAN ISLE BEACH AND SHALLOTTE.  
CLEARING ON THIS PROJECT SHALL BE PERFORMED TO THE LIMITS ESTABLISHED BY METHOD III.

**PRELIMINARY PLANS**  
DO NOT USE FOR CONSTRUCTION

**GRAPHIC SCALES**

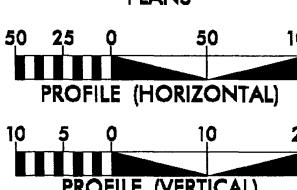

PLANS

**DESIGN DATA**

ADT 2013 = 7,312  
ADT 2033 = 12,592  
DHV = 55 %  
D = 13 %  
T = 3 % \*  
V = 60 MPH  
\* (TTST 1 % + DUAL 2 %)  
FUNC. CLASS. = COLLECTOR  
SUB-REGIONAL TIER

**PROJECT LENGTH**

LENGTH ROADWAY TIP PROJECT R-3432 = 2.859 MILES  
TOTAL LENGTH TIP PROJECT R-3432 = 2.859 MILES

*Prepared in the Office of:*  
**DIVISION OF HIGHWAYS**

1000 Birch Ridge Dr., Raleigh NC, 27610

2012 STANDARD SPECIFICATIONS

**RIGHT OF WAY DATE:**  
NOVEMBER 29, 2011

**LETTING DATE:**  
JUNE 18, 2013

**HYDRAULICS ENGINEER**

*P.E.*

SIGNATURE:

ROADWAY DESIGN  
ENGINEER

*P.E.*

SIGNATURE:

STATE HIGHWAY DESIGN ENGINEER

**DIVISION OF HIGHWAYS  
STATE OF NORTH CAROLINA**



*P.E.*

STATE HIGHWAY DESIGN ENGINEER

Permit Drawing  
STATE OF NORTH CAROLINA  
DIVISION OF HIGHWAYS

BRUNSWICK COUNTY

R-3432

Y9-105 (OLD GEORGETOWN RD.)  
EXTENSION FROM SR 105 OCEAN  
ISLE BEACH RD. TO NC 109

STA. 13+00.00 L BEGIN TIP PROJECT R-3432

**WETLAND & SURFACE WATER  
PERMIT DRAWING**

STA. 13+09.00 L BEGIN TIP PROJECT R-3432

TO CALABASH

OLD GEORGETOWN ROAD

OLD GEORGETOWN ROAD EXTENSION

SITE 5

OCEAN ISLE BEACH ROAD

SITE 1

DR 6

DR 7

DR 8

DR 9

DR 10

DR 11

DR 12

DR 13

DR 14

DR 15

DR 16

DR 17

DR 18

DR 19

DR 20

DR 21

DR 22

DR 23

DR 24

DR 25

Y9-HALFWAY ROAD  
SR 105A

SITE 3

Gravel  
Pit

PR

Gravel  
Pit

PR


Gravel  
Pit

PR

Gravel  
Pit

PR

Gravel  
Pit

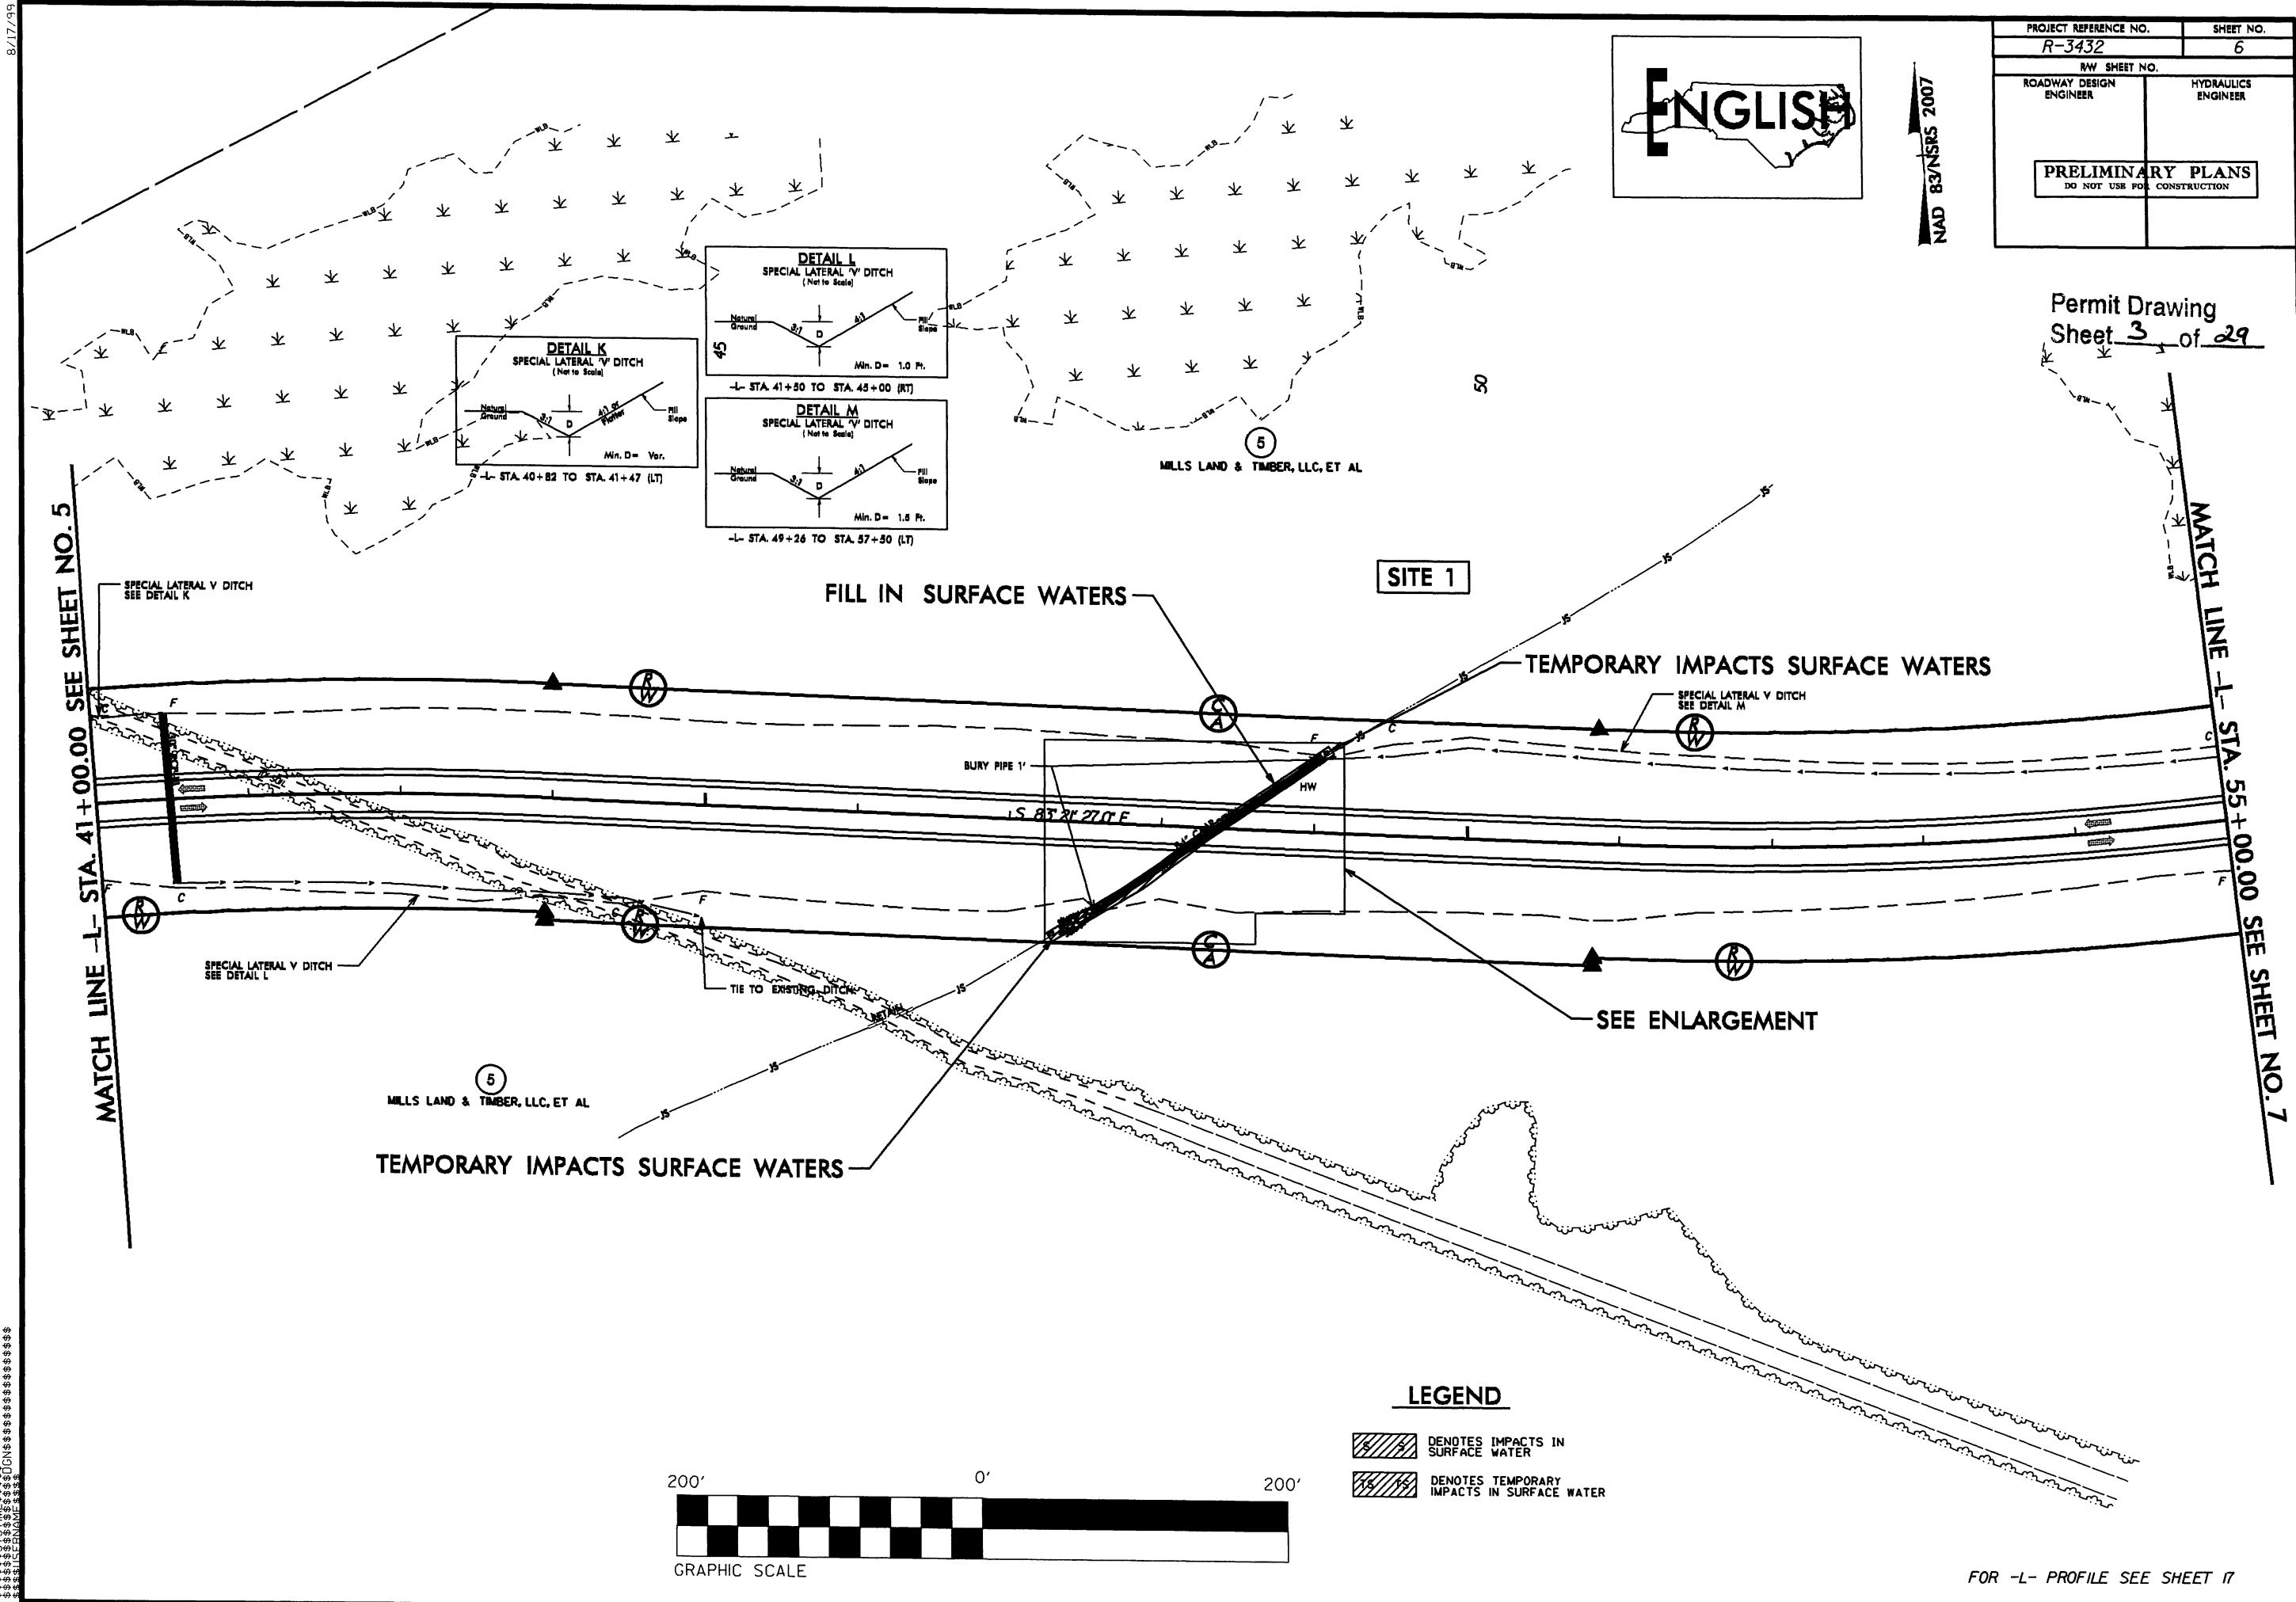


R/W REV: REVISING PDE ON PARCEL 5. 5/9/12 TFD

*R/W REV: REMOVING PDE ON PARCEL 5. 5/14/12 TFD*

SYSTIME\$\$\$\$\$DGN\$\$\$\$\$FNAME\$\$\$\$\$

8/17/99

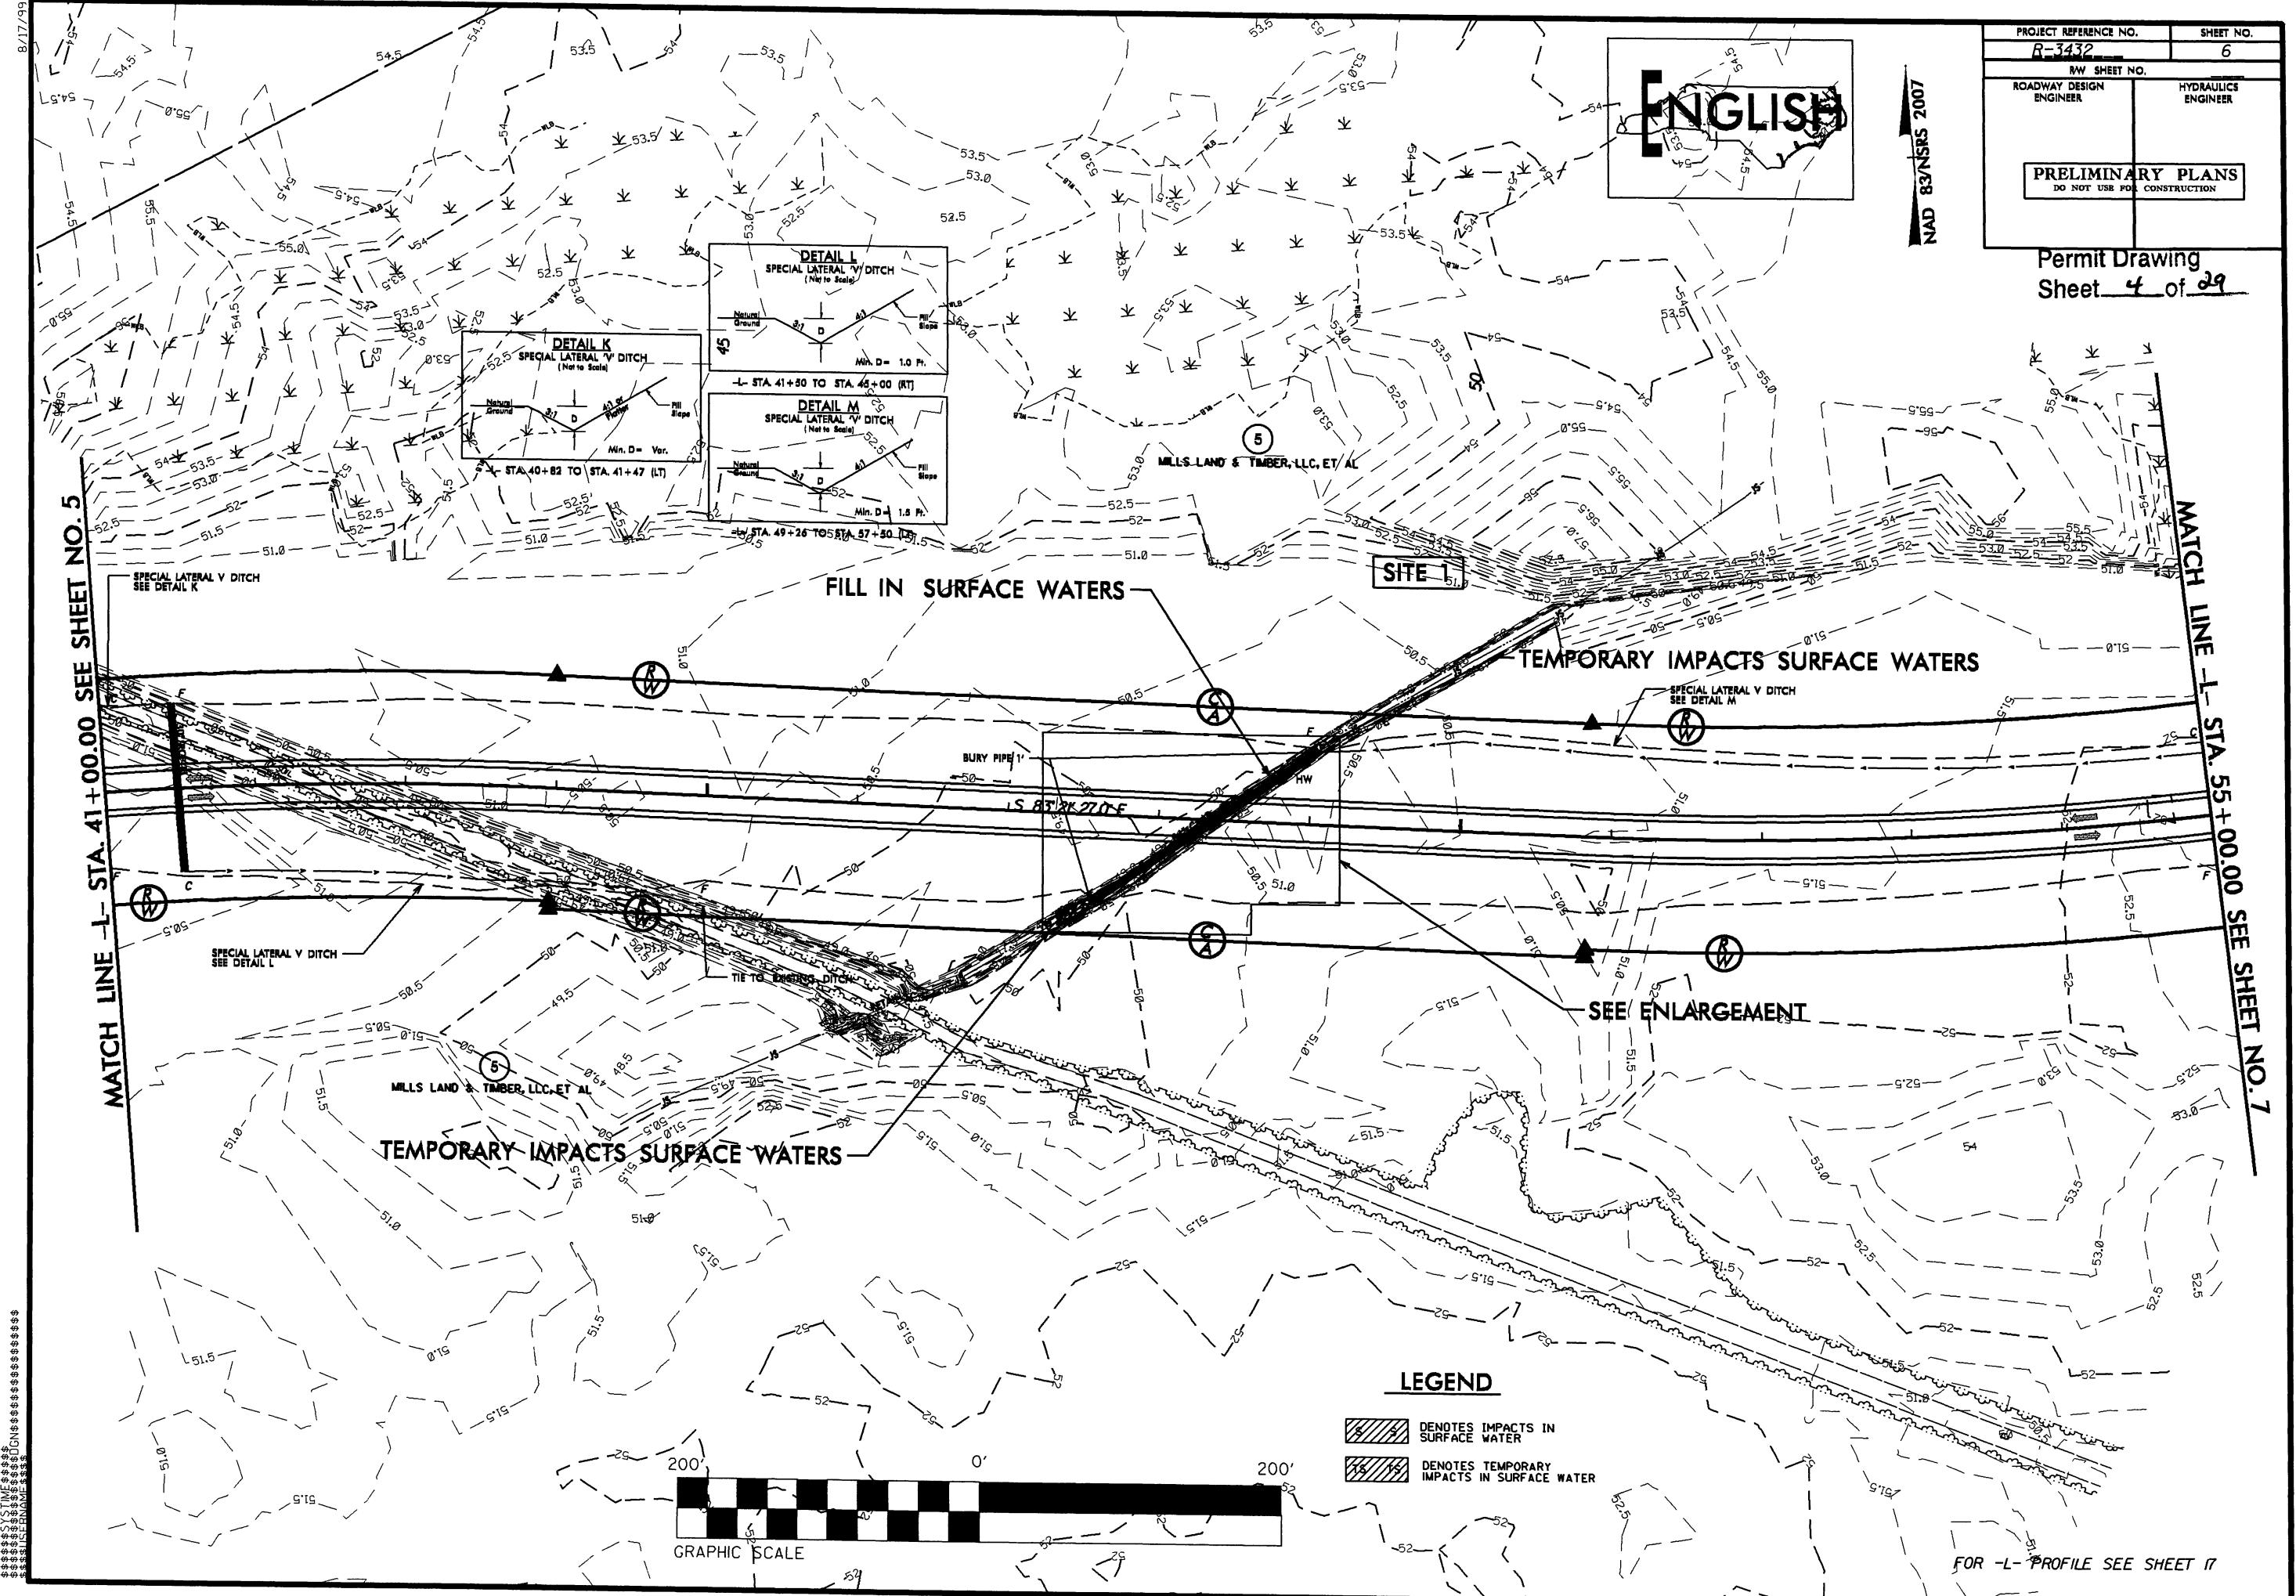


**TEMPORARY IMPACTS SURFACE WATERS**

**FILL IN SURFACE WATERS**


**HW**

$3^{\circ} 21' 27.0'' E$

**TEMPORARY IMPACTS  
SURFACE WATERS**

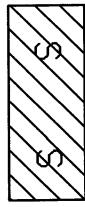

DENOTES IMPACTS IN  
SURFACE WATER

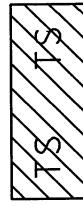

DENOTES TEMPORARY  
IMPACTS IN SURFACE WATER

NC GRID  
NAD 83/95

**NCDOT**


**DIVISION OF HIGHWAYS**

BRUNSWICK COUNTY  
PROJECT: 35501.1.1 (R-3432)  
SR 1163 (OLD GEORGETOWN RD.  
EXTENSION) FROM SR 1184 (OCEAN  
ISLE BEACH RD.) TO NC 179

SHEET 5 OF 29 05 / 03 / 12

**SITE 1**

**ENLARGEMENT**

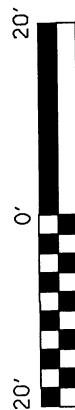

GRAPHIC SCALE


**SITE 1**  
**JURISDICTIONAL**  
**STREAM PROFILE**

NCDOT  
 DIVISION OF HIGHWAYS


BRUNSWICK COUNTY

PROJECT: 3450111 (R-3432)  
 SR 1163 (OLD GEORGETOWN RD.  
 EXTENSION FROM SR 1184 (OCEAN  
 ISLE BEACH RD.) TO NC 179  
 SHEET OF 05 / 03 / 12


150' LT 100' LT 50' LT 0 50' RT 100' RT 150' RT

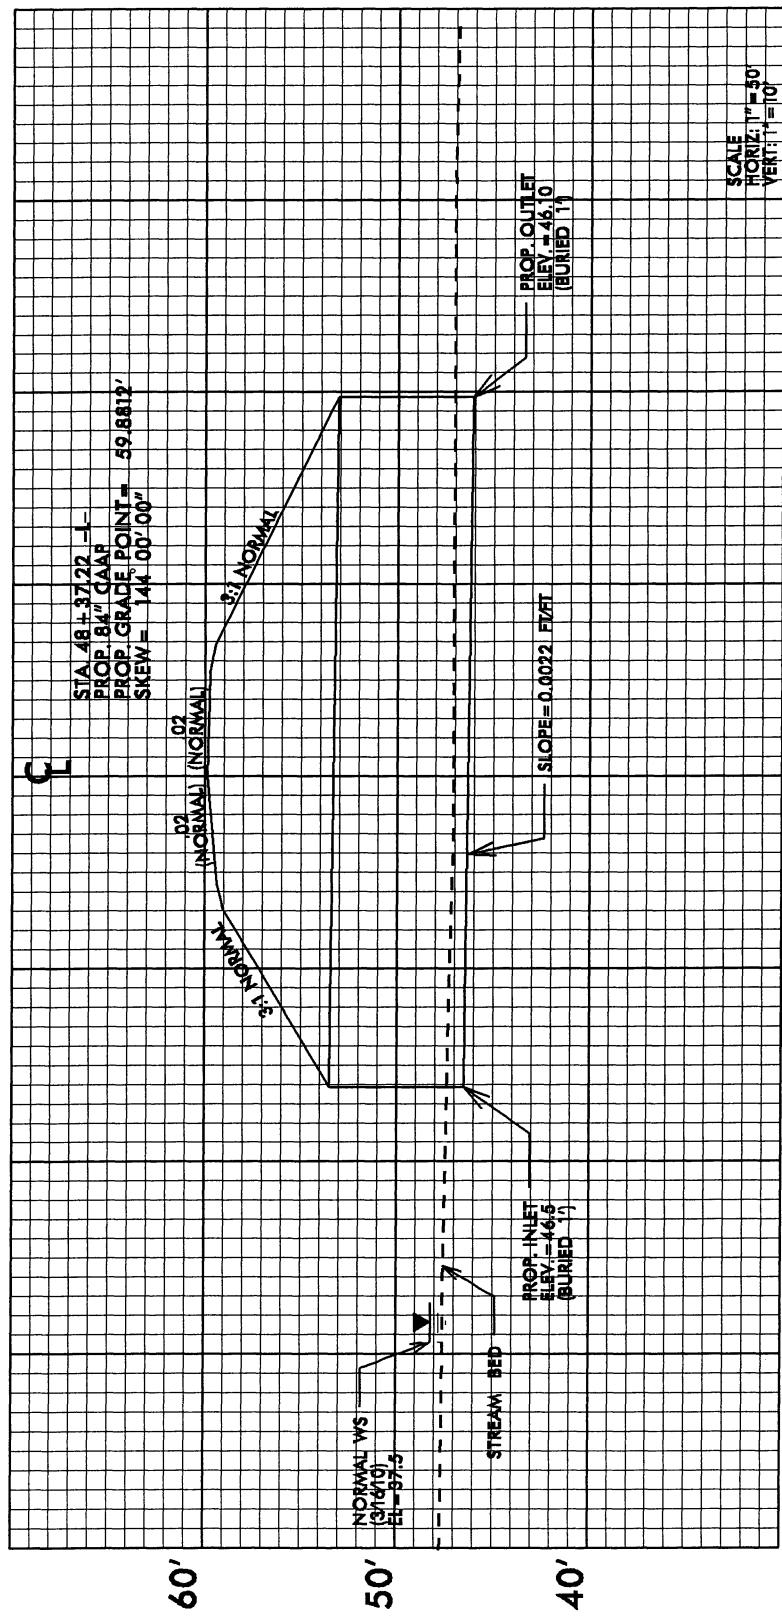


Permit Drawing  
 Sheet 6 of 6

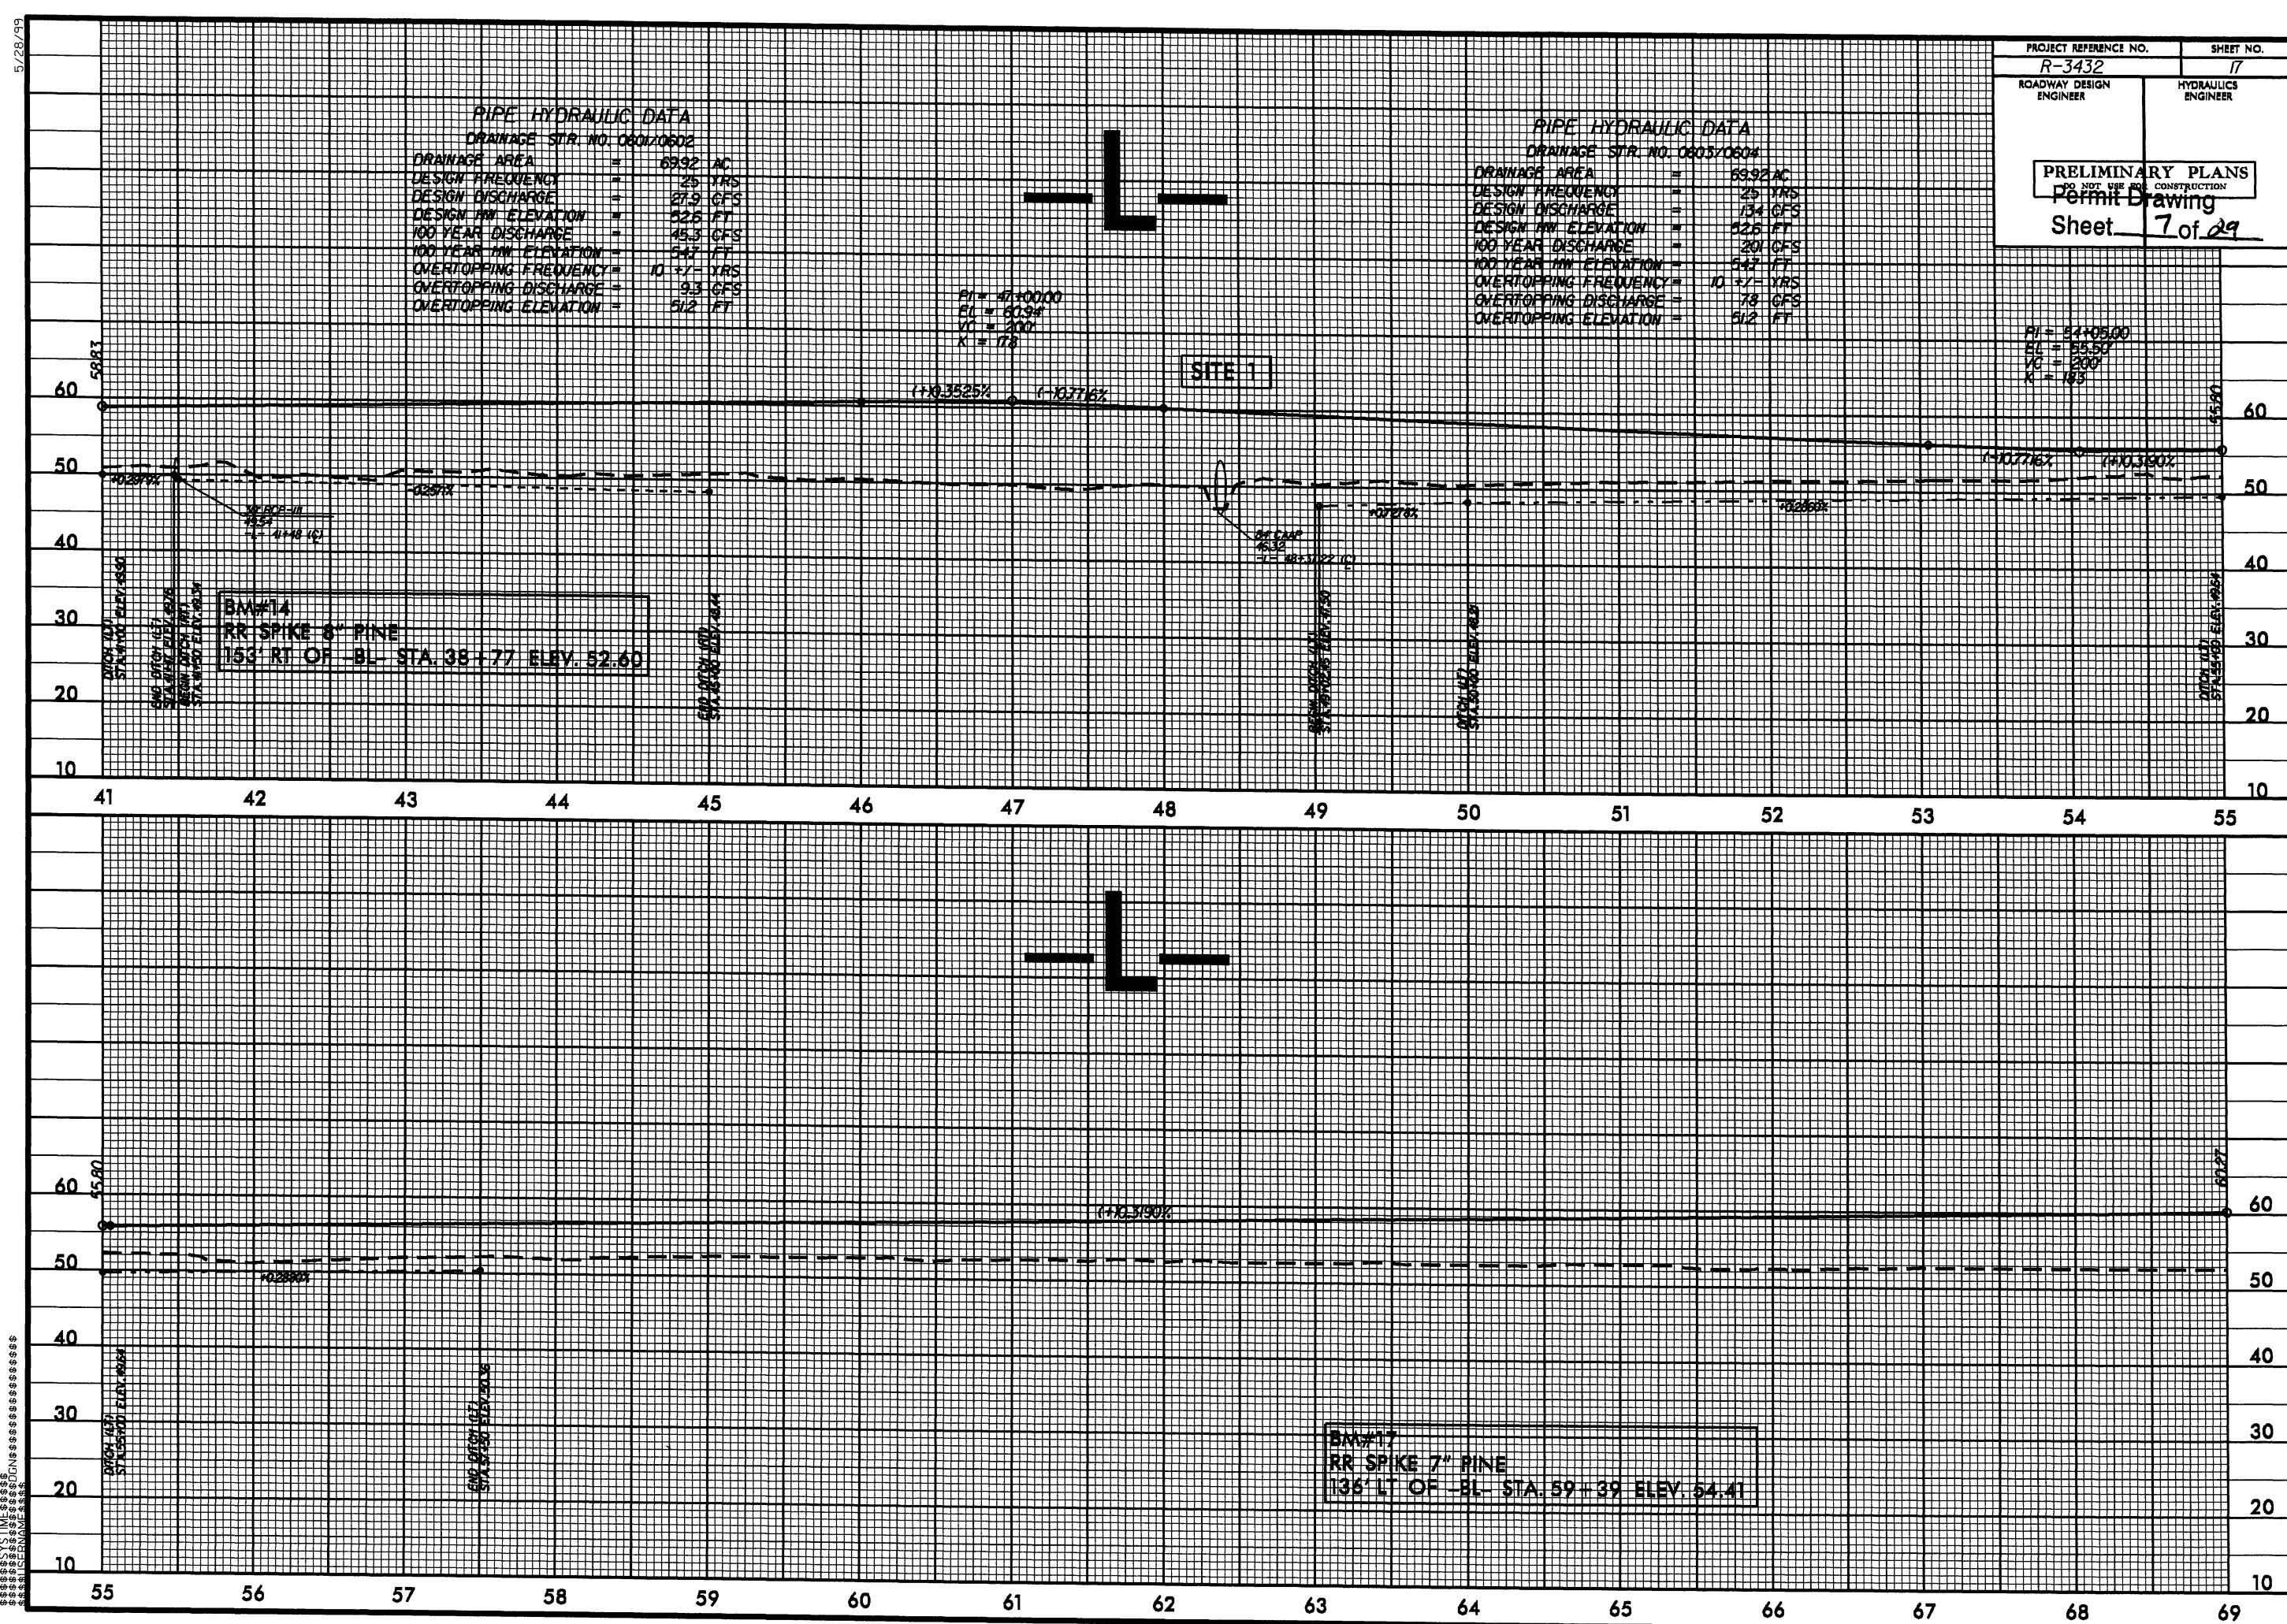



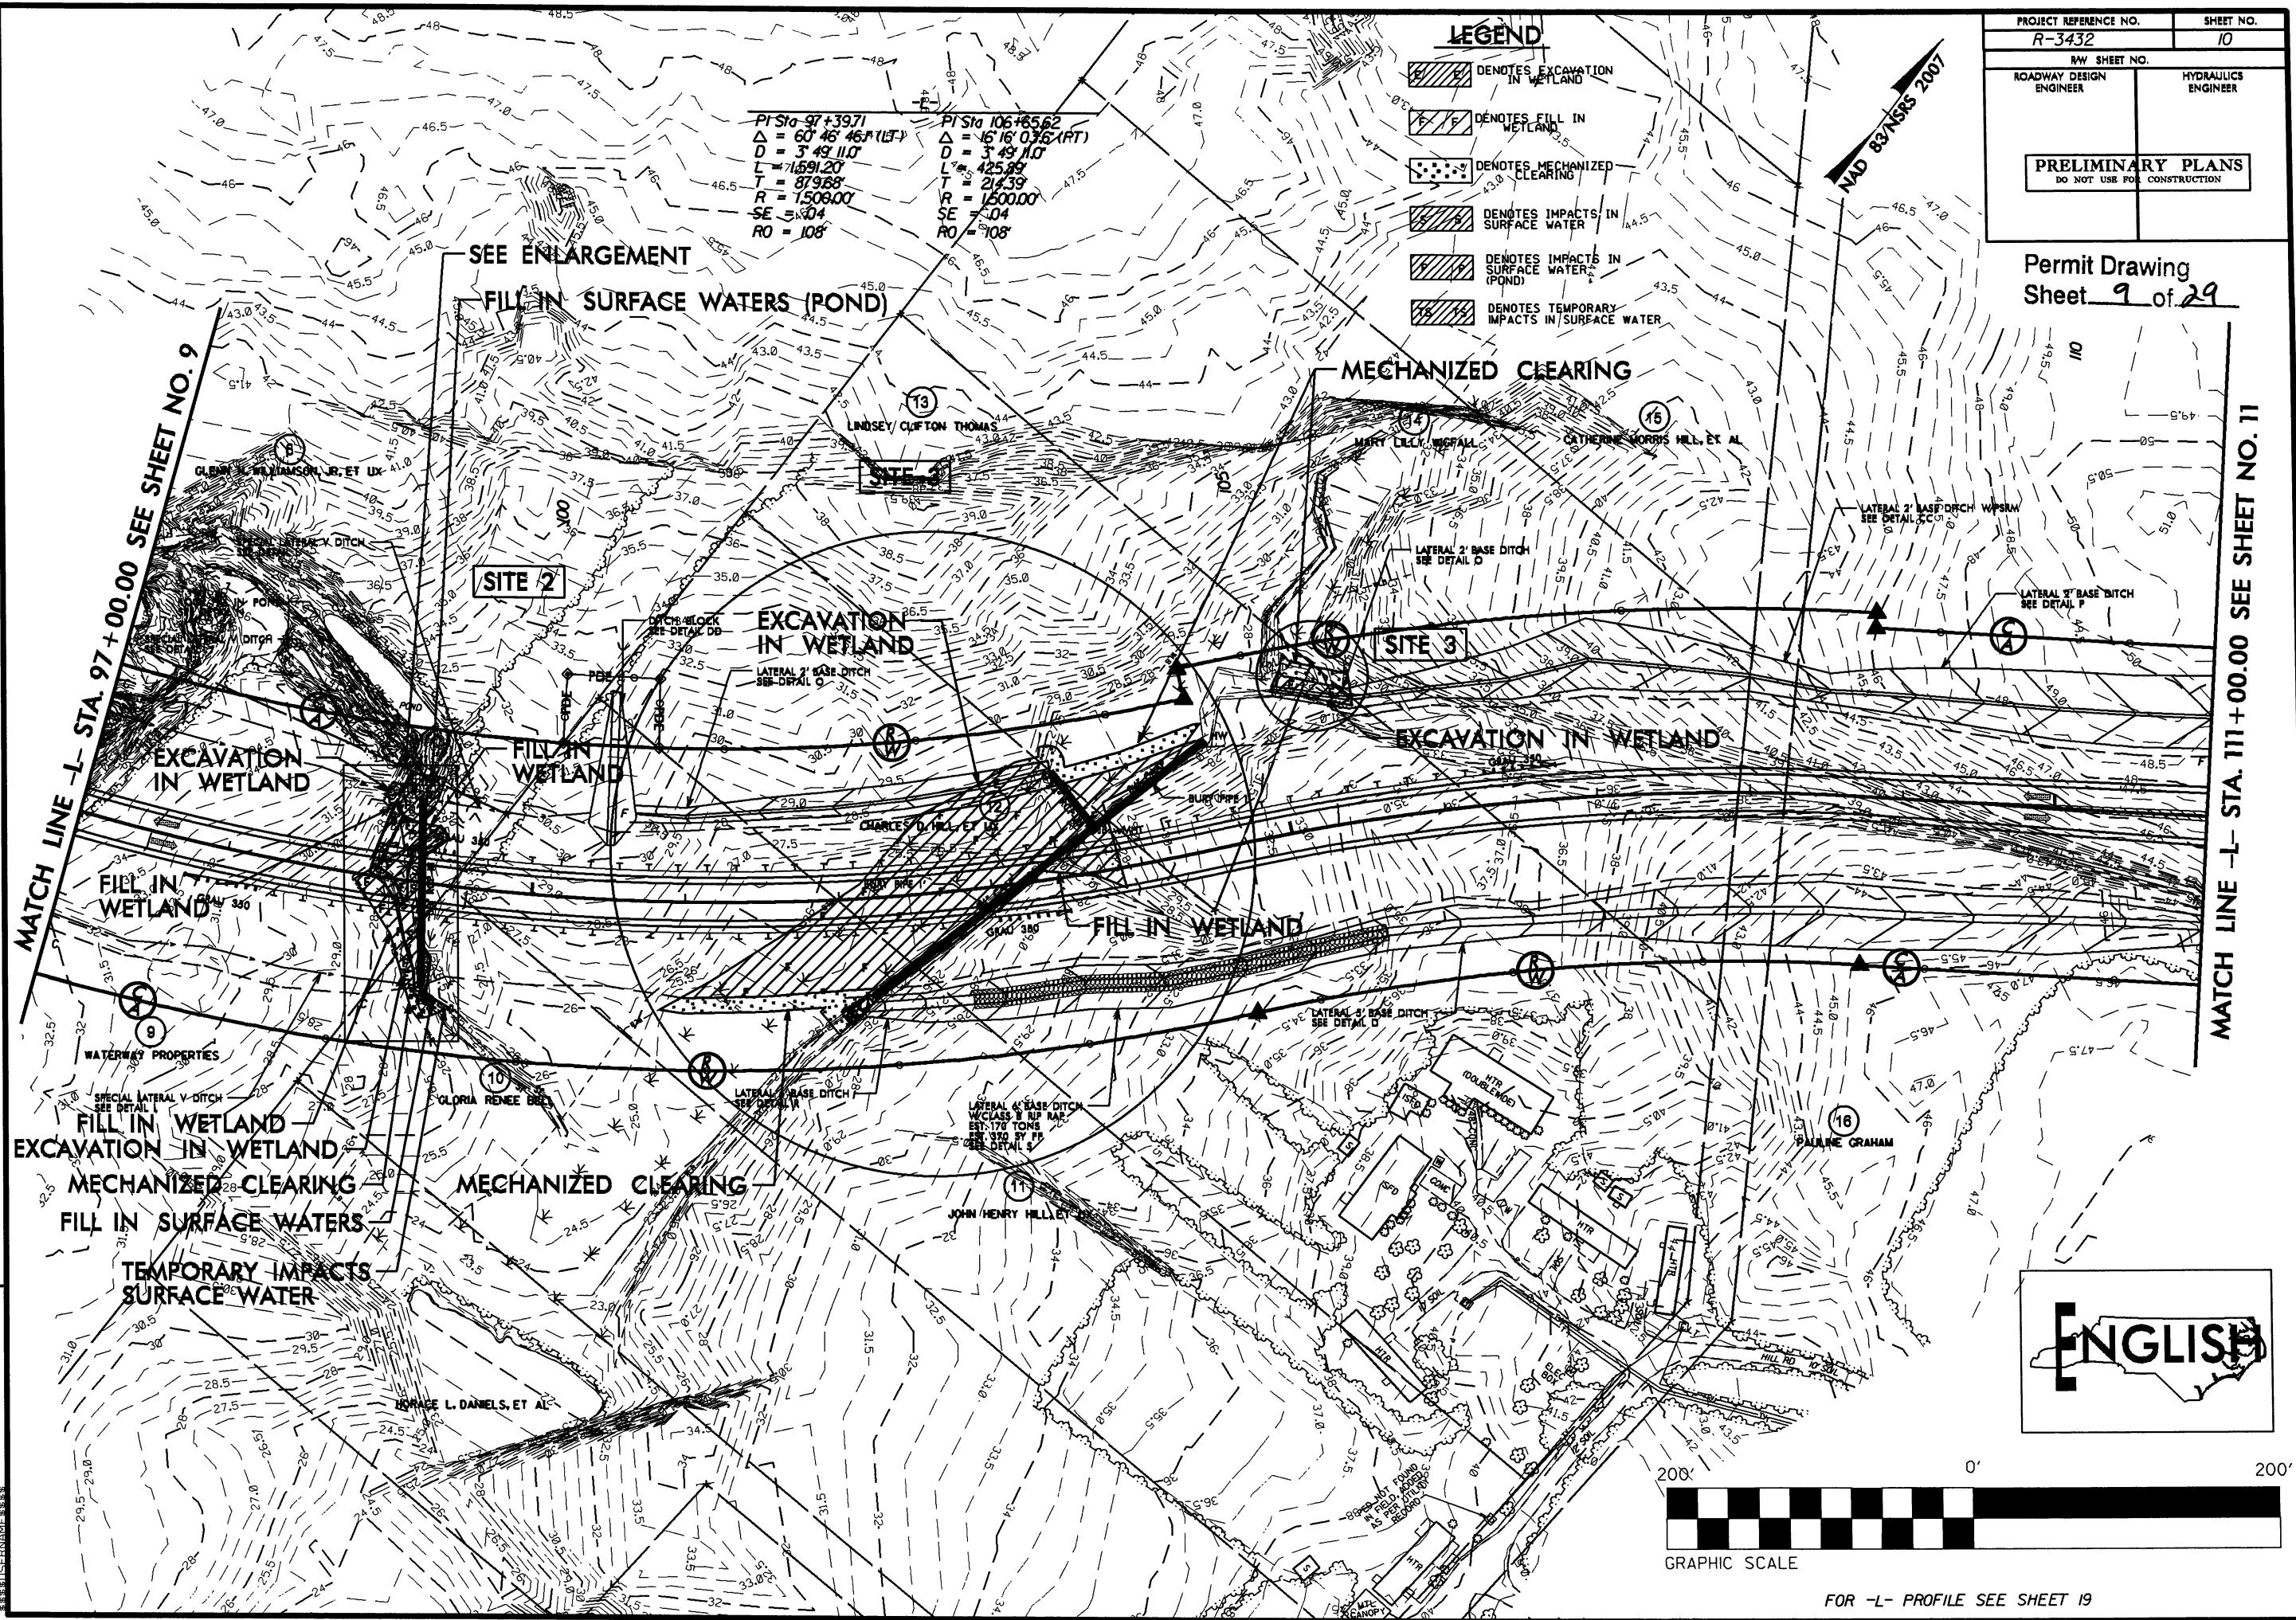

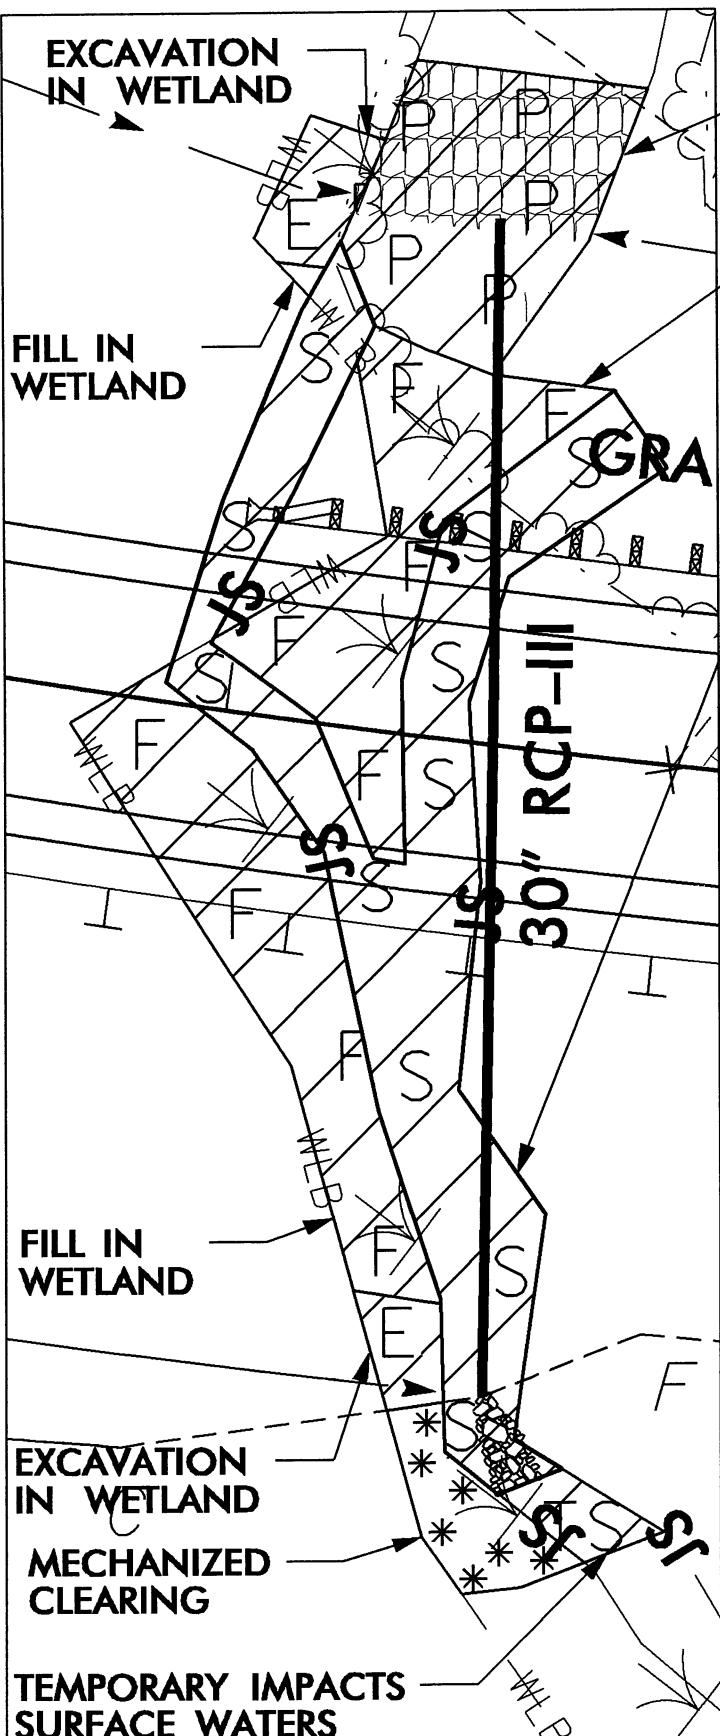

FILL IN SURFACE  
WATERS (POND)

FILL IN WETLAND

FILL IN  
WETLAND

FILL IN SURFACE WATERS

FILL IN  
WETLAND

EXCAVATION  
IN WETLAND

MECHANIZED  
CLEARING

TEMPORARY IMPACTS  
SURFACE WATERS

E E  
P P  
S S

DENOTES EXCAVATION  
IN WETLAND

\* \* \* \* \*  
F F

DENOTES IMPACTS IN  
SURFACE WATER  
(POND)

S S  
\* \* \* \* \*

DENOTES IMPACTS IN  
SURFACE WATER

\* \* \* \* \*  
F F

DENOTES MECHANIZED  
CLEARING

F F  
WEB

DENOTES FILL IN  
WETLAND

TS TS  
WEB

DENOTES TEMPORARY  
IMPACTS IN SURFACE  
WATER

20' 0' 20'

GRAPHIC SCALE


**NCDOT**  
**DIVISION OF HIGHWAYS**

BRUNSWICK COUNTY  
PROJECT: 35501.1.1 (R-3432)  
SR 1163 (OLD GEORGETOWN RD.  
EXTENSION) FROM SR 1184 (OCEAN  
ISLE BEACH RD.) TO NC 179

SHEET **05 / 03 / 12** OF

Permit Drawing  
Sheet 10 of 29


**SITE 2**  
**ENLARGEMENT**

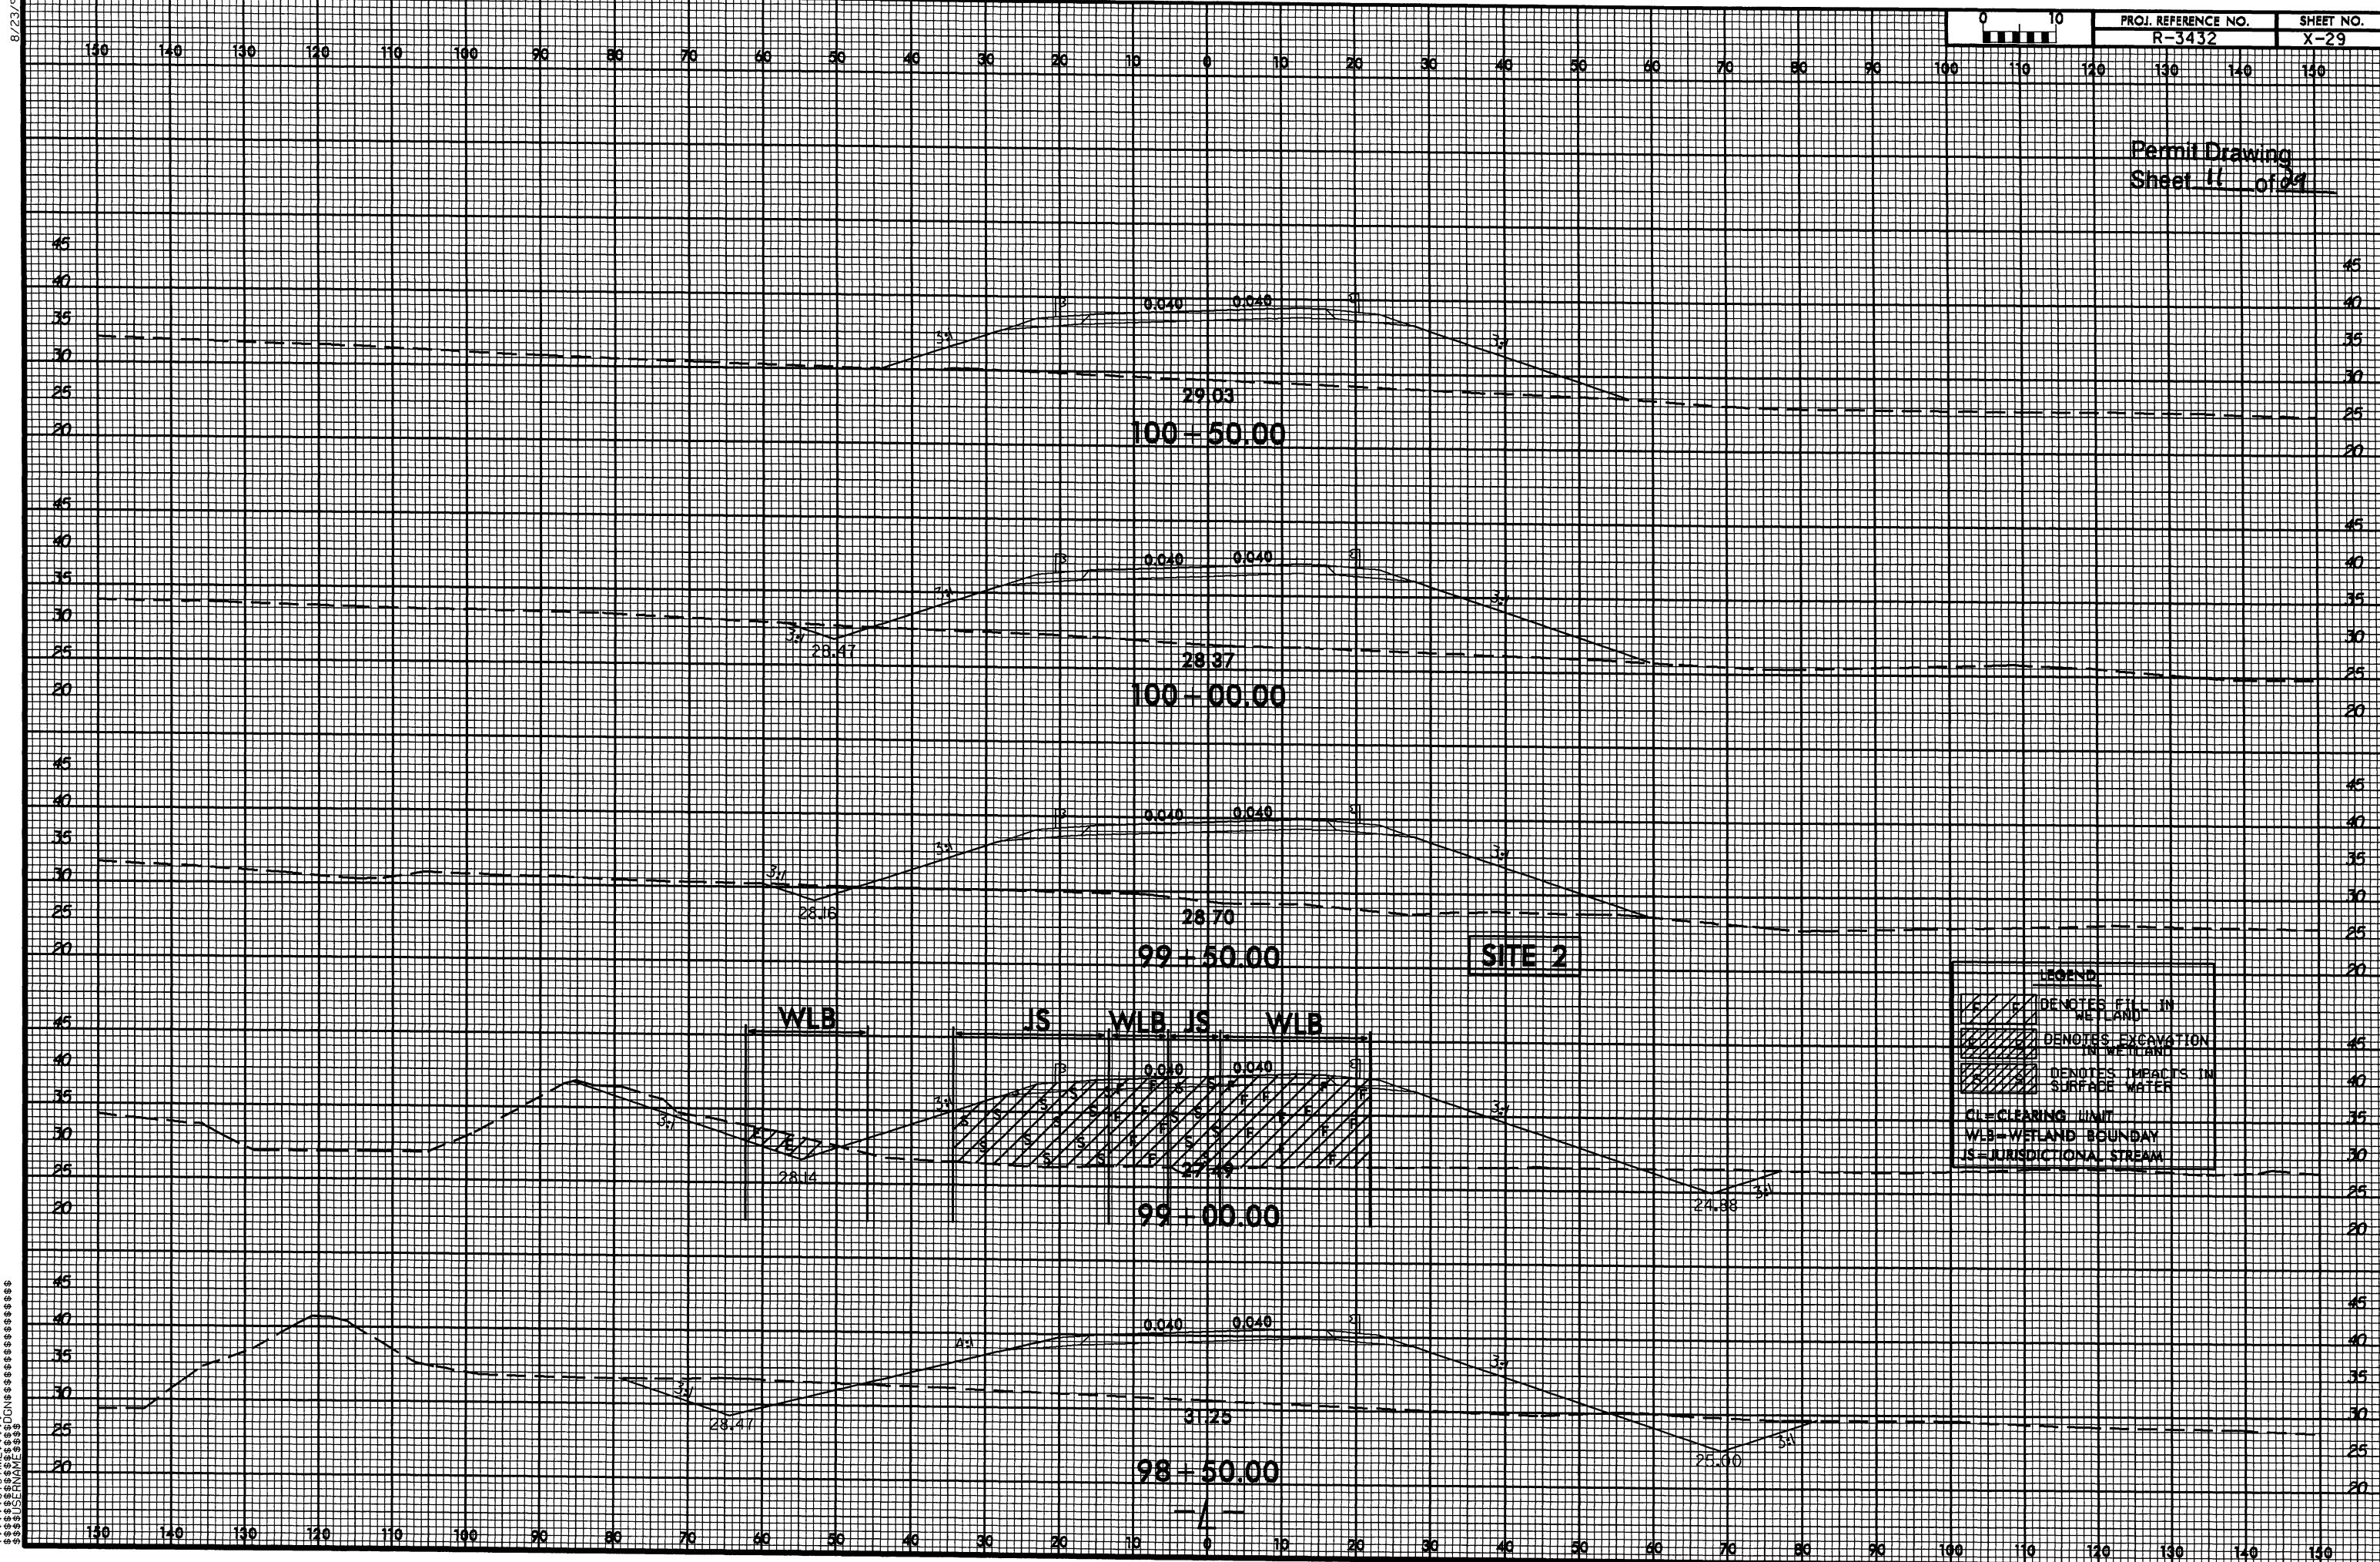

## PIPE HYDRAULIC DATA

**DRAINAGE STR. NO. 1005/100**

DRAINAGE AREA	145 A
DESIGN FREQUENCY	25 YR
DESIGN DISCHARGE	26 CFS
DESIGN TIN ELEVATION	303 F
100 YEAR DISCHARGE	34 CFS
100 YEAR TIN ELEVATION	312 FT
OVERTOPPING FREQUENCY	500/YR
OVERTOPPING DISCHARGE	44 CFS
OVERTOPPING ELEVATION	33 F

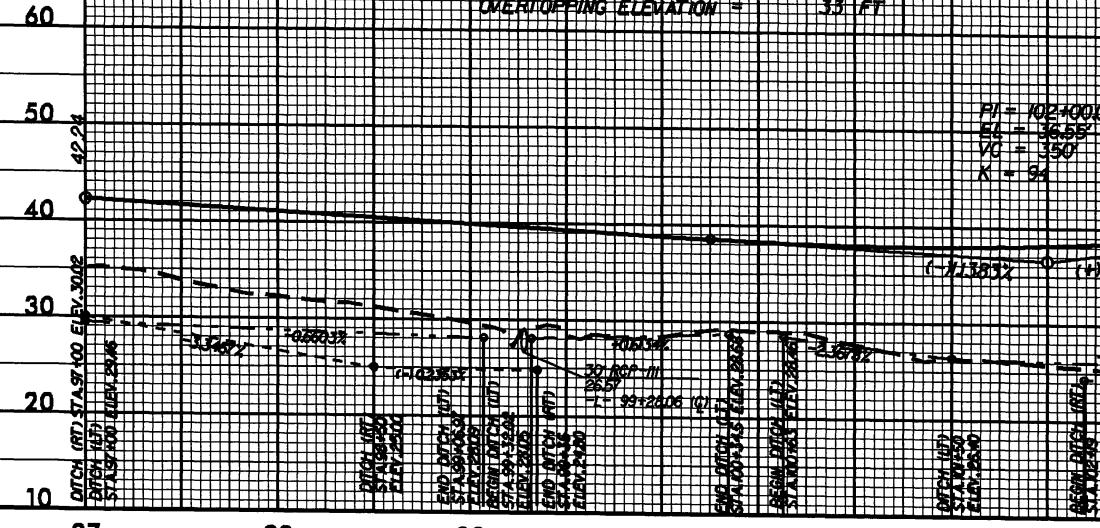


## PIPE HYDRAULIC DATA

DRAINAGE STA NO 1022100

DRAINAGE AREA	=	62
DESIGN FREQUENCY	=	2
DESIGN DISCHARGE	=	1
DESIGN MM ELEVATION	=	2
100 YEAR DISCHARGE	=	24
100 YEAR MM ELEVATION	=	3
OVERTOPPING FREQUENCY	=	10
OVERTOPPING DISCHARGE	=	2
OVERTOPPING ELEVATION	=	-

$$\begin{aligned} F1 &= 108 + 15.00 \\ F1 &= 123.00 \\ VC &= 52.97 \\ VC &= 300 \\ K &= \sqrt{31} \end{aligned}$$

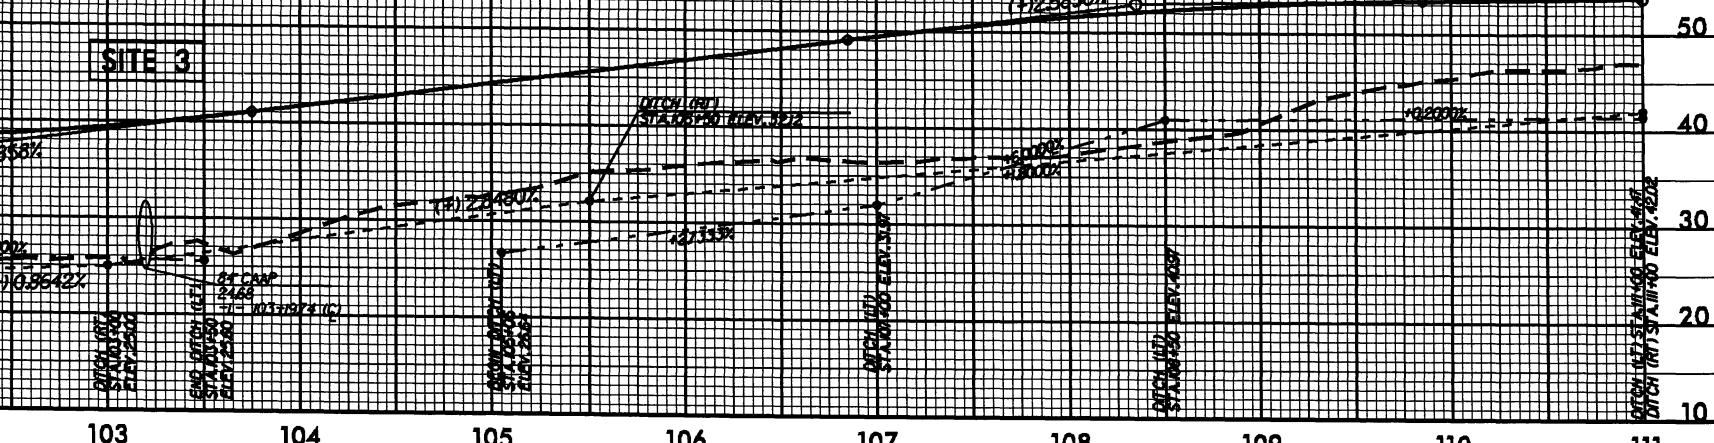

ESTER


$$PI = 102.00000$$

$$E4 = 36.55^{\circ}$$

$$VC = 150^{\circ}$$

$$K = 94$$


Permit Drawing  
Sheet 1A of 27

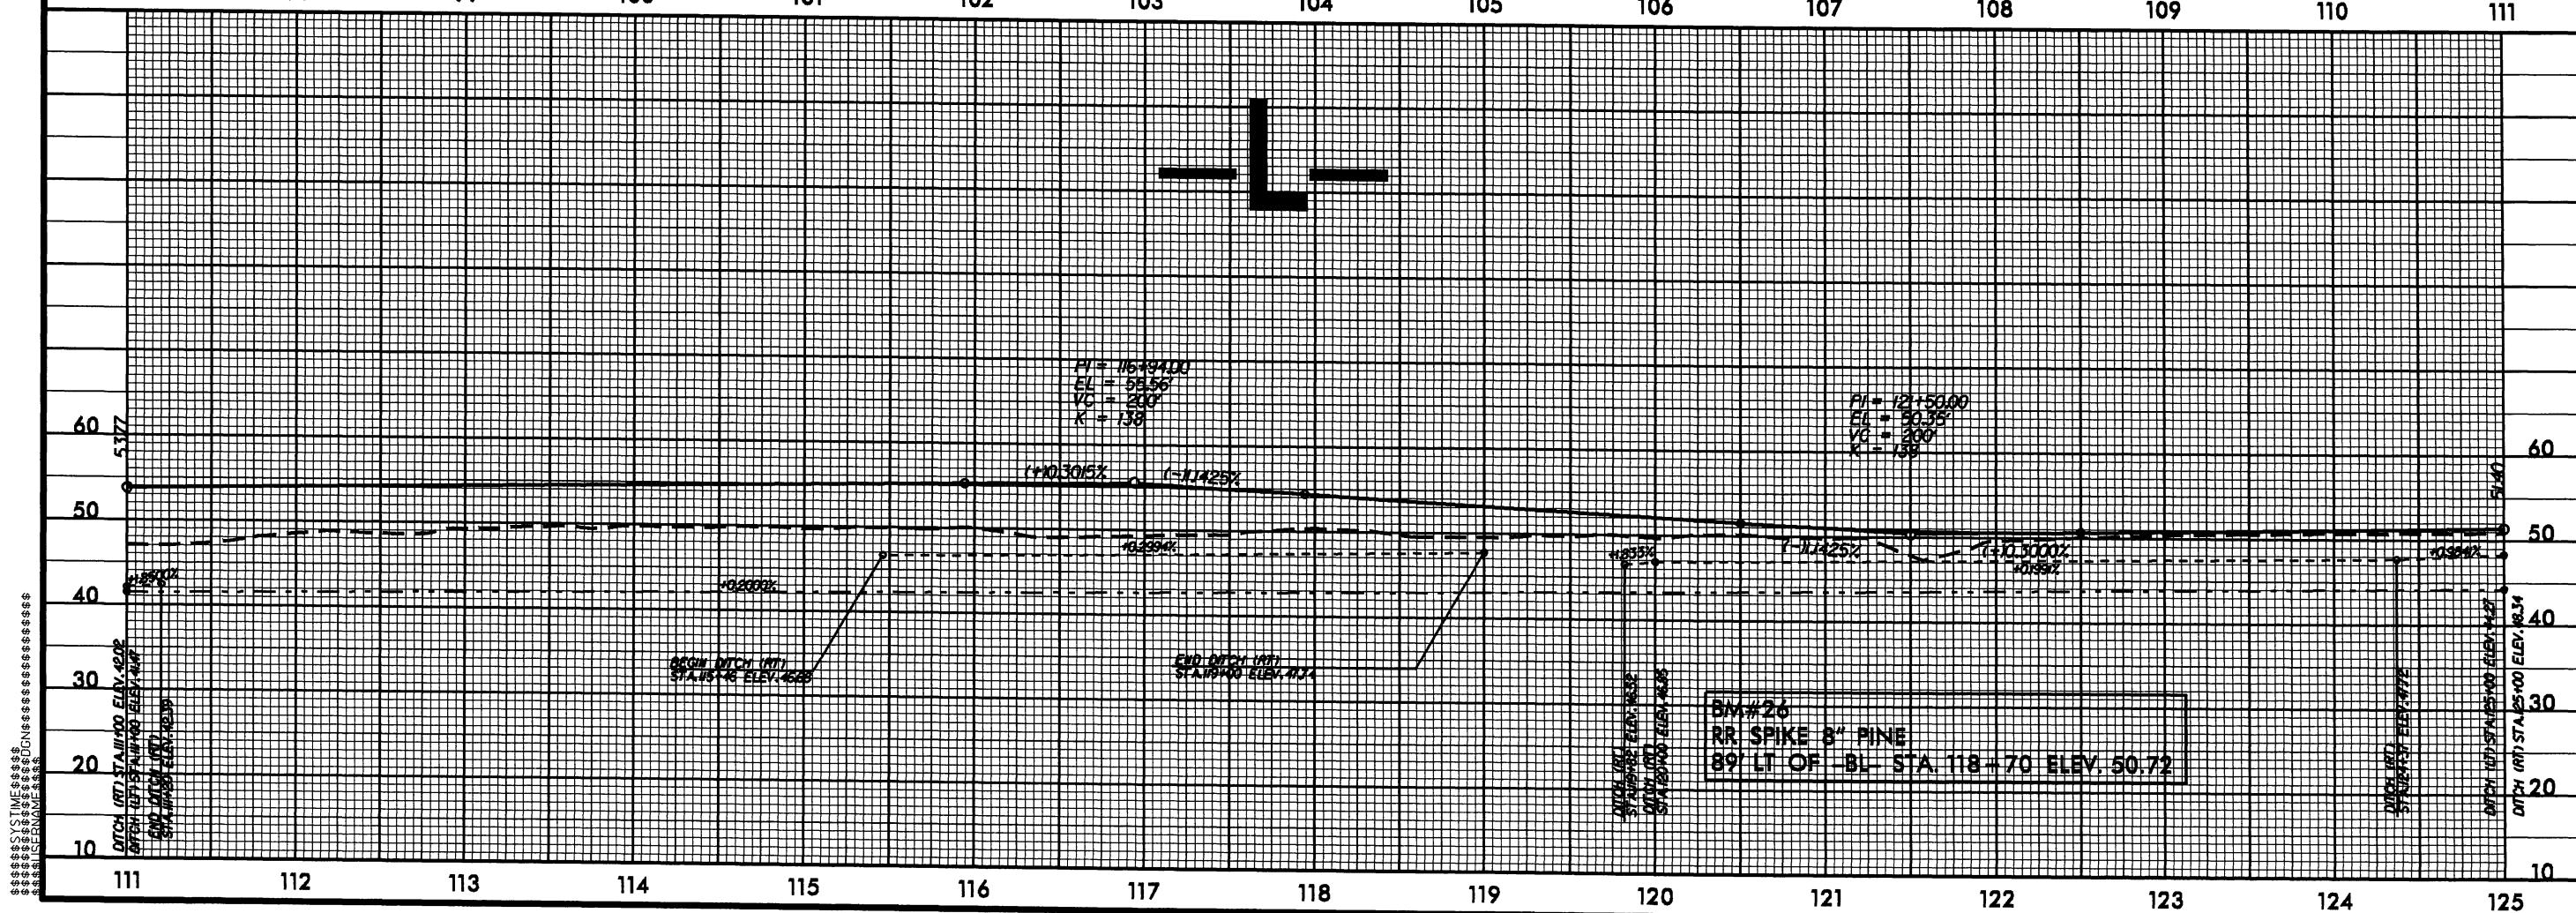

SITE 3

# Permit Drawing


Sheet 13 of 24

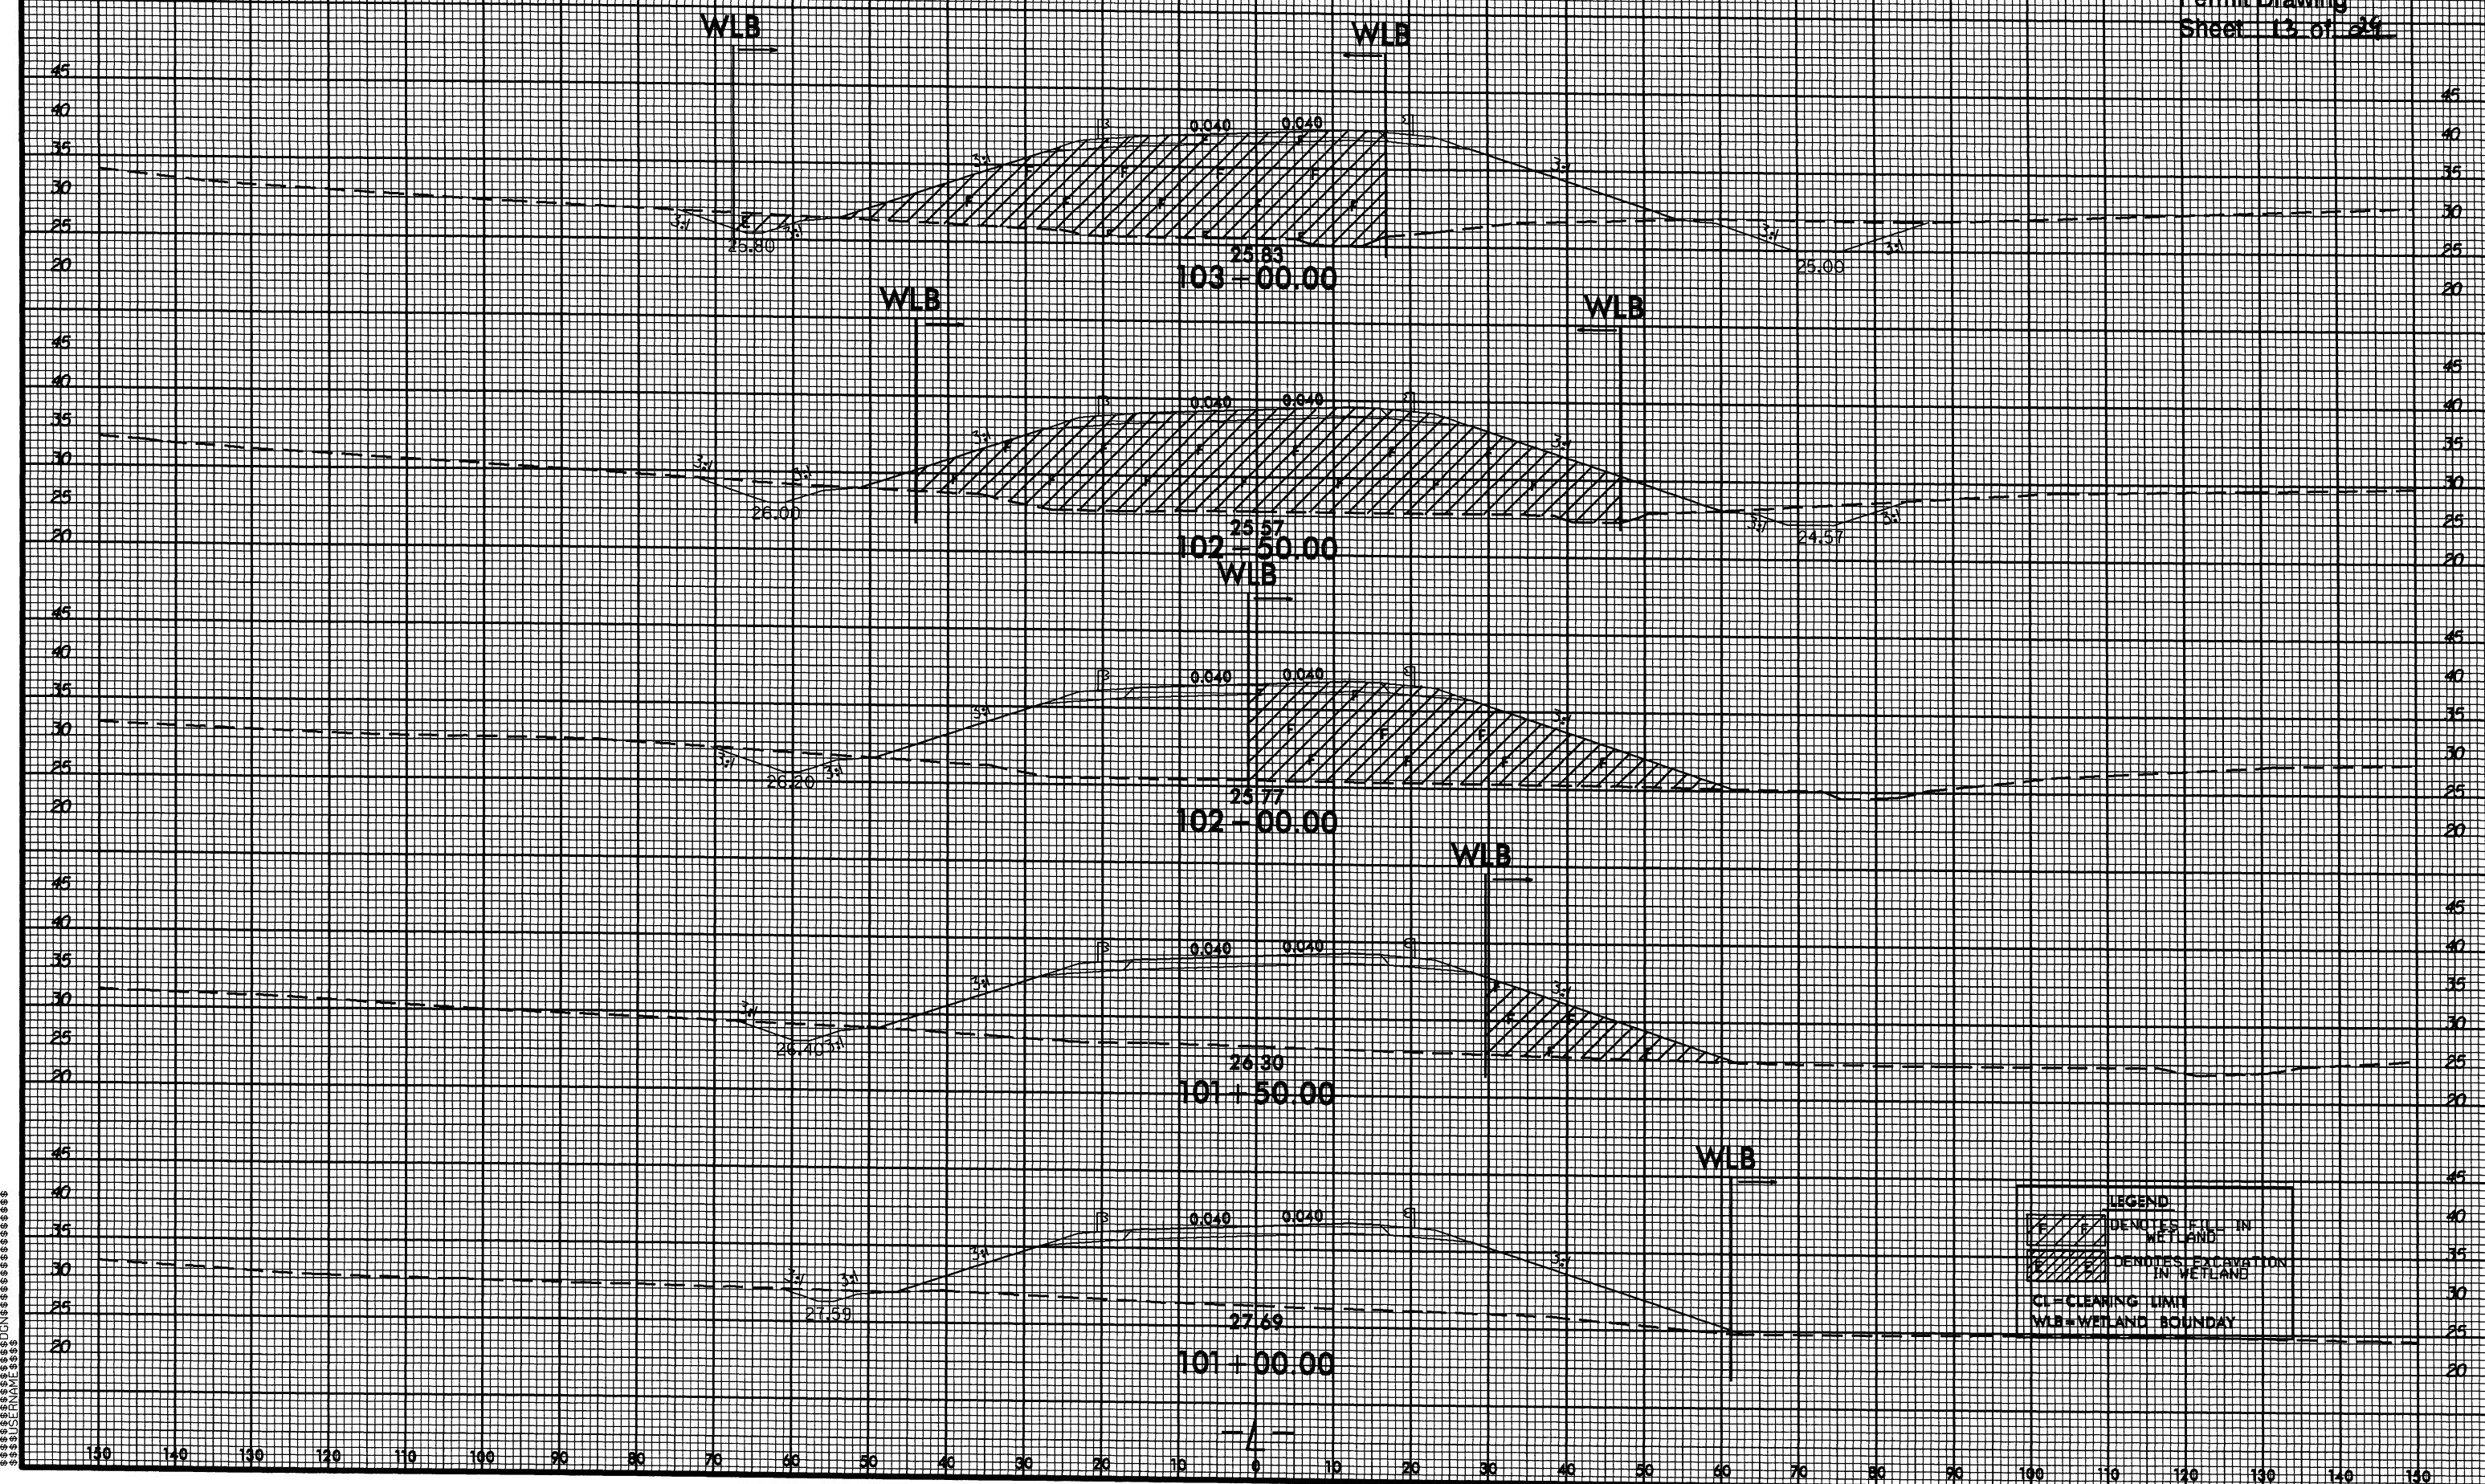


130 140 130 120 110 100 90 80 70 60 50 40 30 20 10 0 10 20 30 40 50 60 70 80 90 100 110 120 130 140 150

WLB


SITE 3

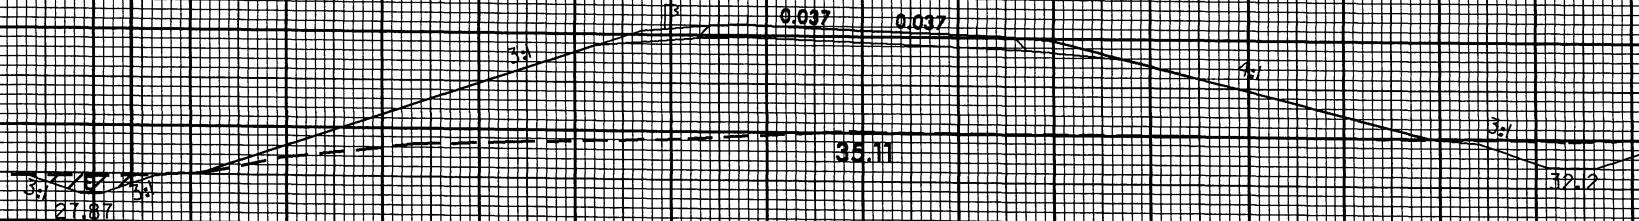 Permit Drawing  
Sheet 14 of 29


105 - 50.00

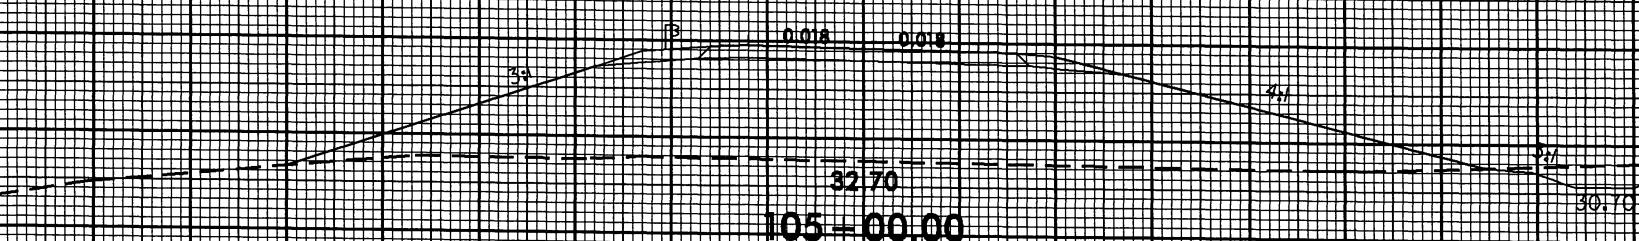


105 - 00.00

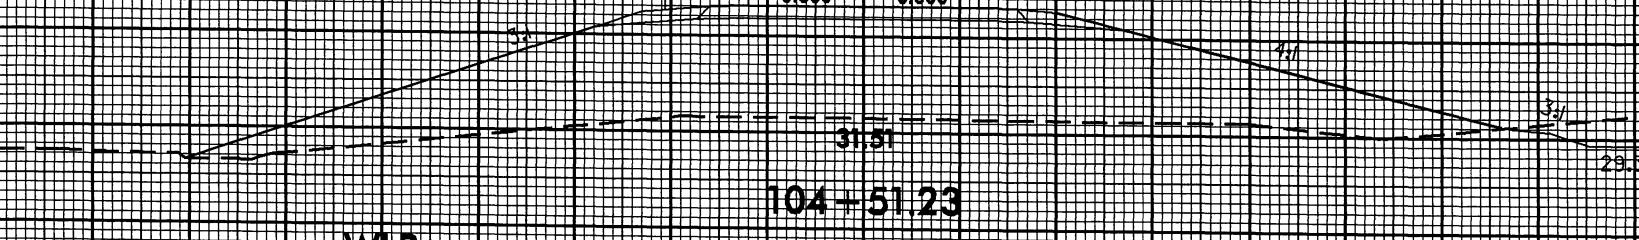


104 + 51.23

WLB

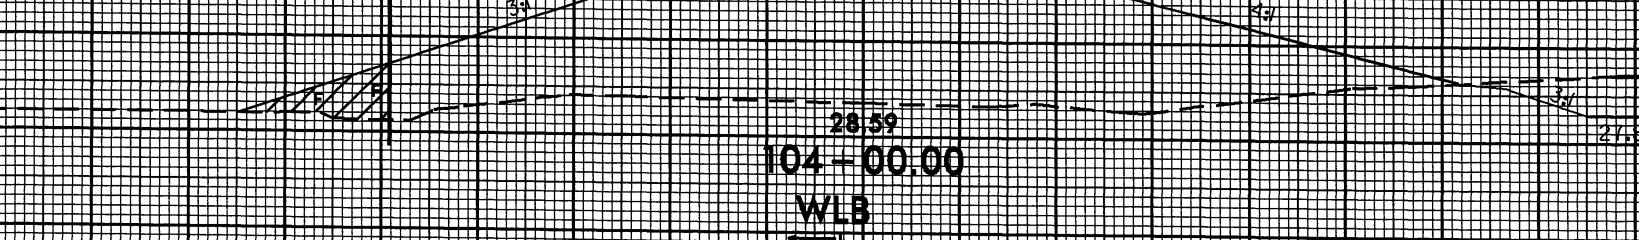


104 - 00.00

WLB

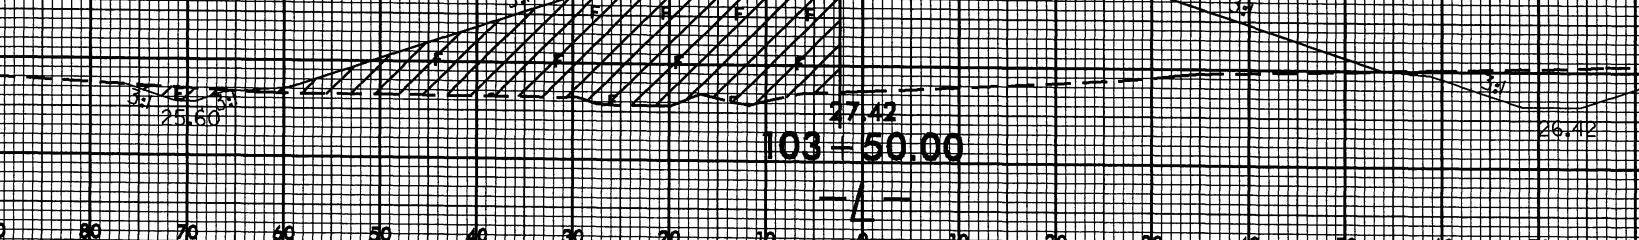

103 - 50.00

LEGEND	
	DENOTES FILL IN WETLAND
	DENOTES EXCAVATION IN WETLAND
	CL = CLEARING LIMIT
	WLB = WETLAND BOUNDARY

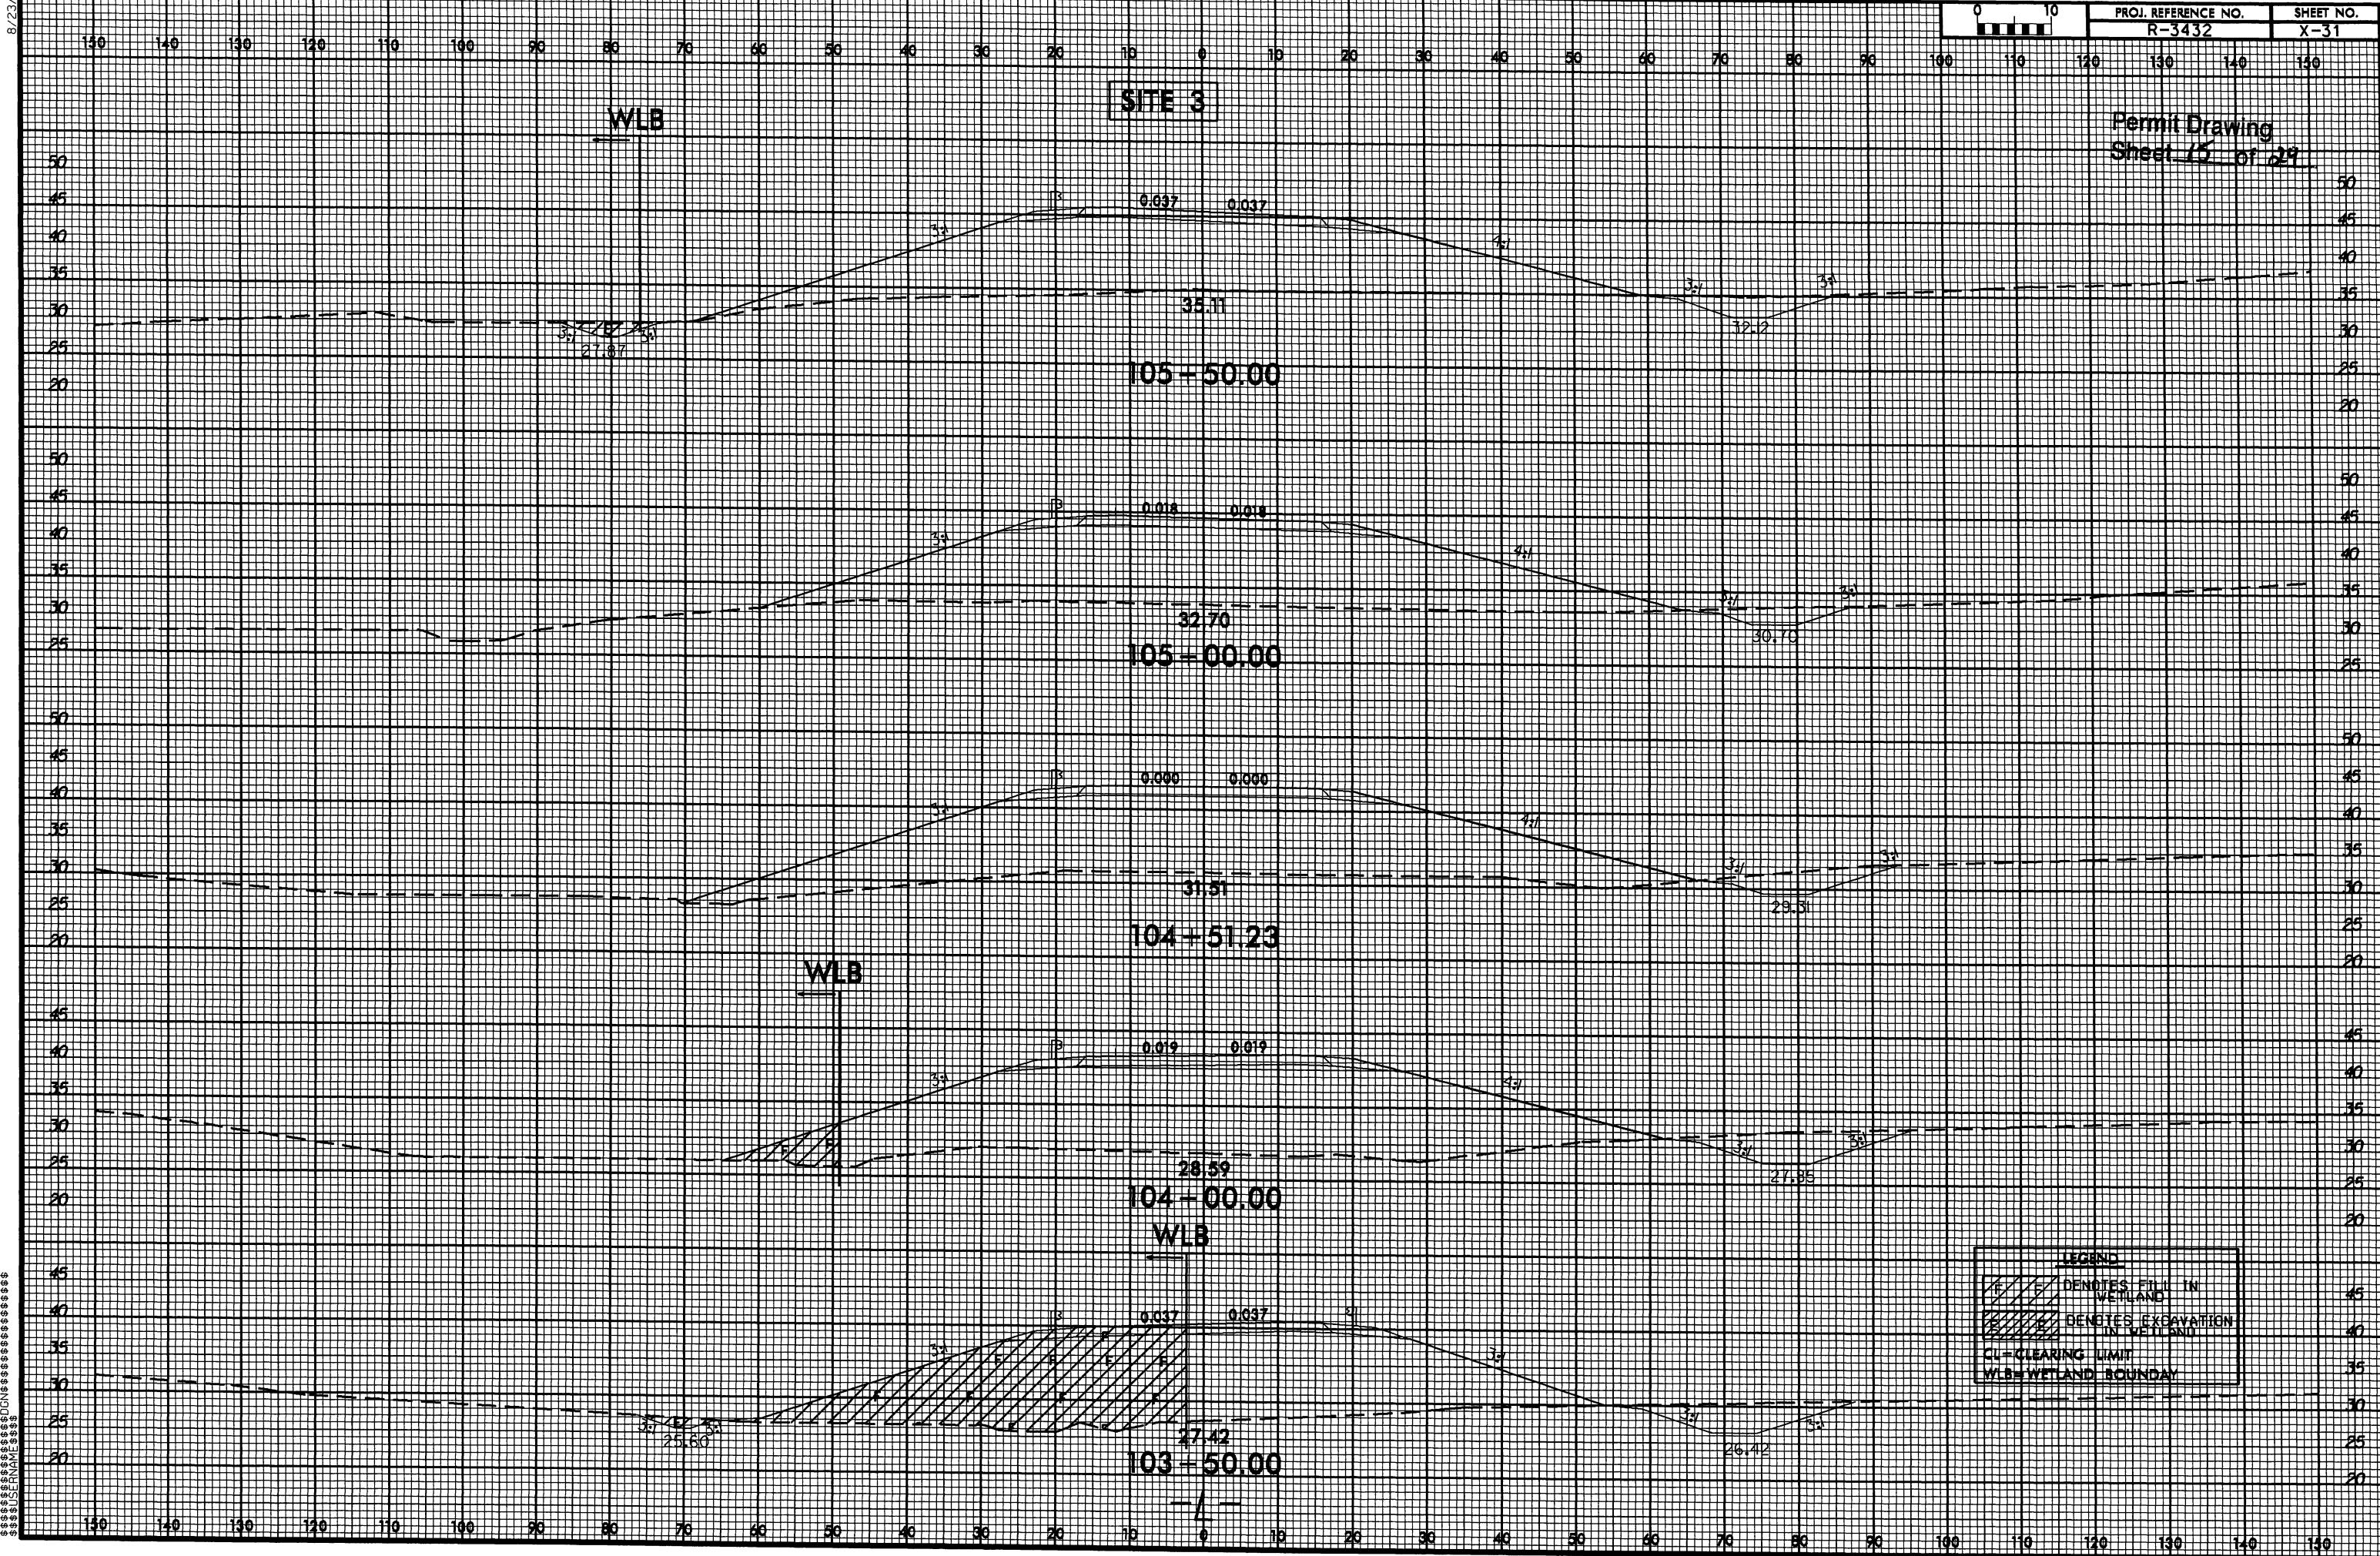

PROJECT REFERENCE NO.		SHEET NO.
R-3432		14
R/W SHEET NO.		
ROADWAY DESIGN ENGINEER		HYDRAULICS ENGINEER
<b>PRELIMINARY PLANS</b>		
DO NOT USE FOR CONSTRUCTION		

Permit Drawing  
Sheet 14 of 24

-L-

PI Sta 154+03.8	PI Sta 158+72.07	PI Sta 161+87.25
$\Delta = 20^{\circ} 06' 07.7''$ (LT)	$\Delta = 12^{\circ} 41' 11.4''$ (LT)	$\Delta = 17^{\circ} 34' 37.6''$ (RT)
D = 4' 48" 53.2"	D = 4' 48" 53.2"	D = 4' 48" 53.2"
L = 475'	L = 263.49'	L = 365.07'
T = 210.92'	T = 132.29'	T = 183.98'
R = 1,190.00'	R = 1,190.00'	R = 1,190.00'
SE = .04	SE = .04	SE = .04
RO = 100'	RO = 100'	RO = 76'

-Y6-

PI Sta 12+23.87	
$\Delta = 56^{\circ} 34' 11.9''$ (RT)	
D = 15' 26" 37.0"	
L = 366.30'	
T = 199.64'	
R = 371.00'	
SE = .04	
RO = 76'	

SEE ENLARGEMENT 4A

GARY D. JUSTICE, ET UX

### EXCAVATION IN WETLAND

### MECHANIZED CLEARING


SPECIAL LATERAL V DITCH  
SEE DETAIL M


SPECIAL CUT DITCH  
SEE DETAIL Y

SPECIAL LATERAL V DITCH  
SEE DETAIL M

### FILL IN WETLAND

PUE

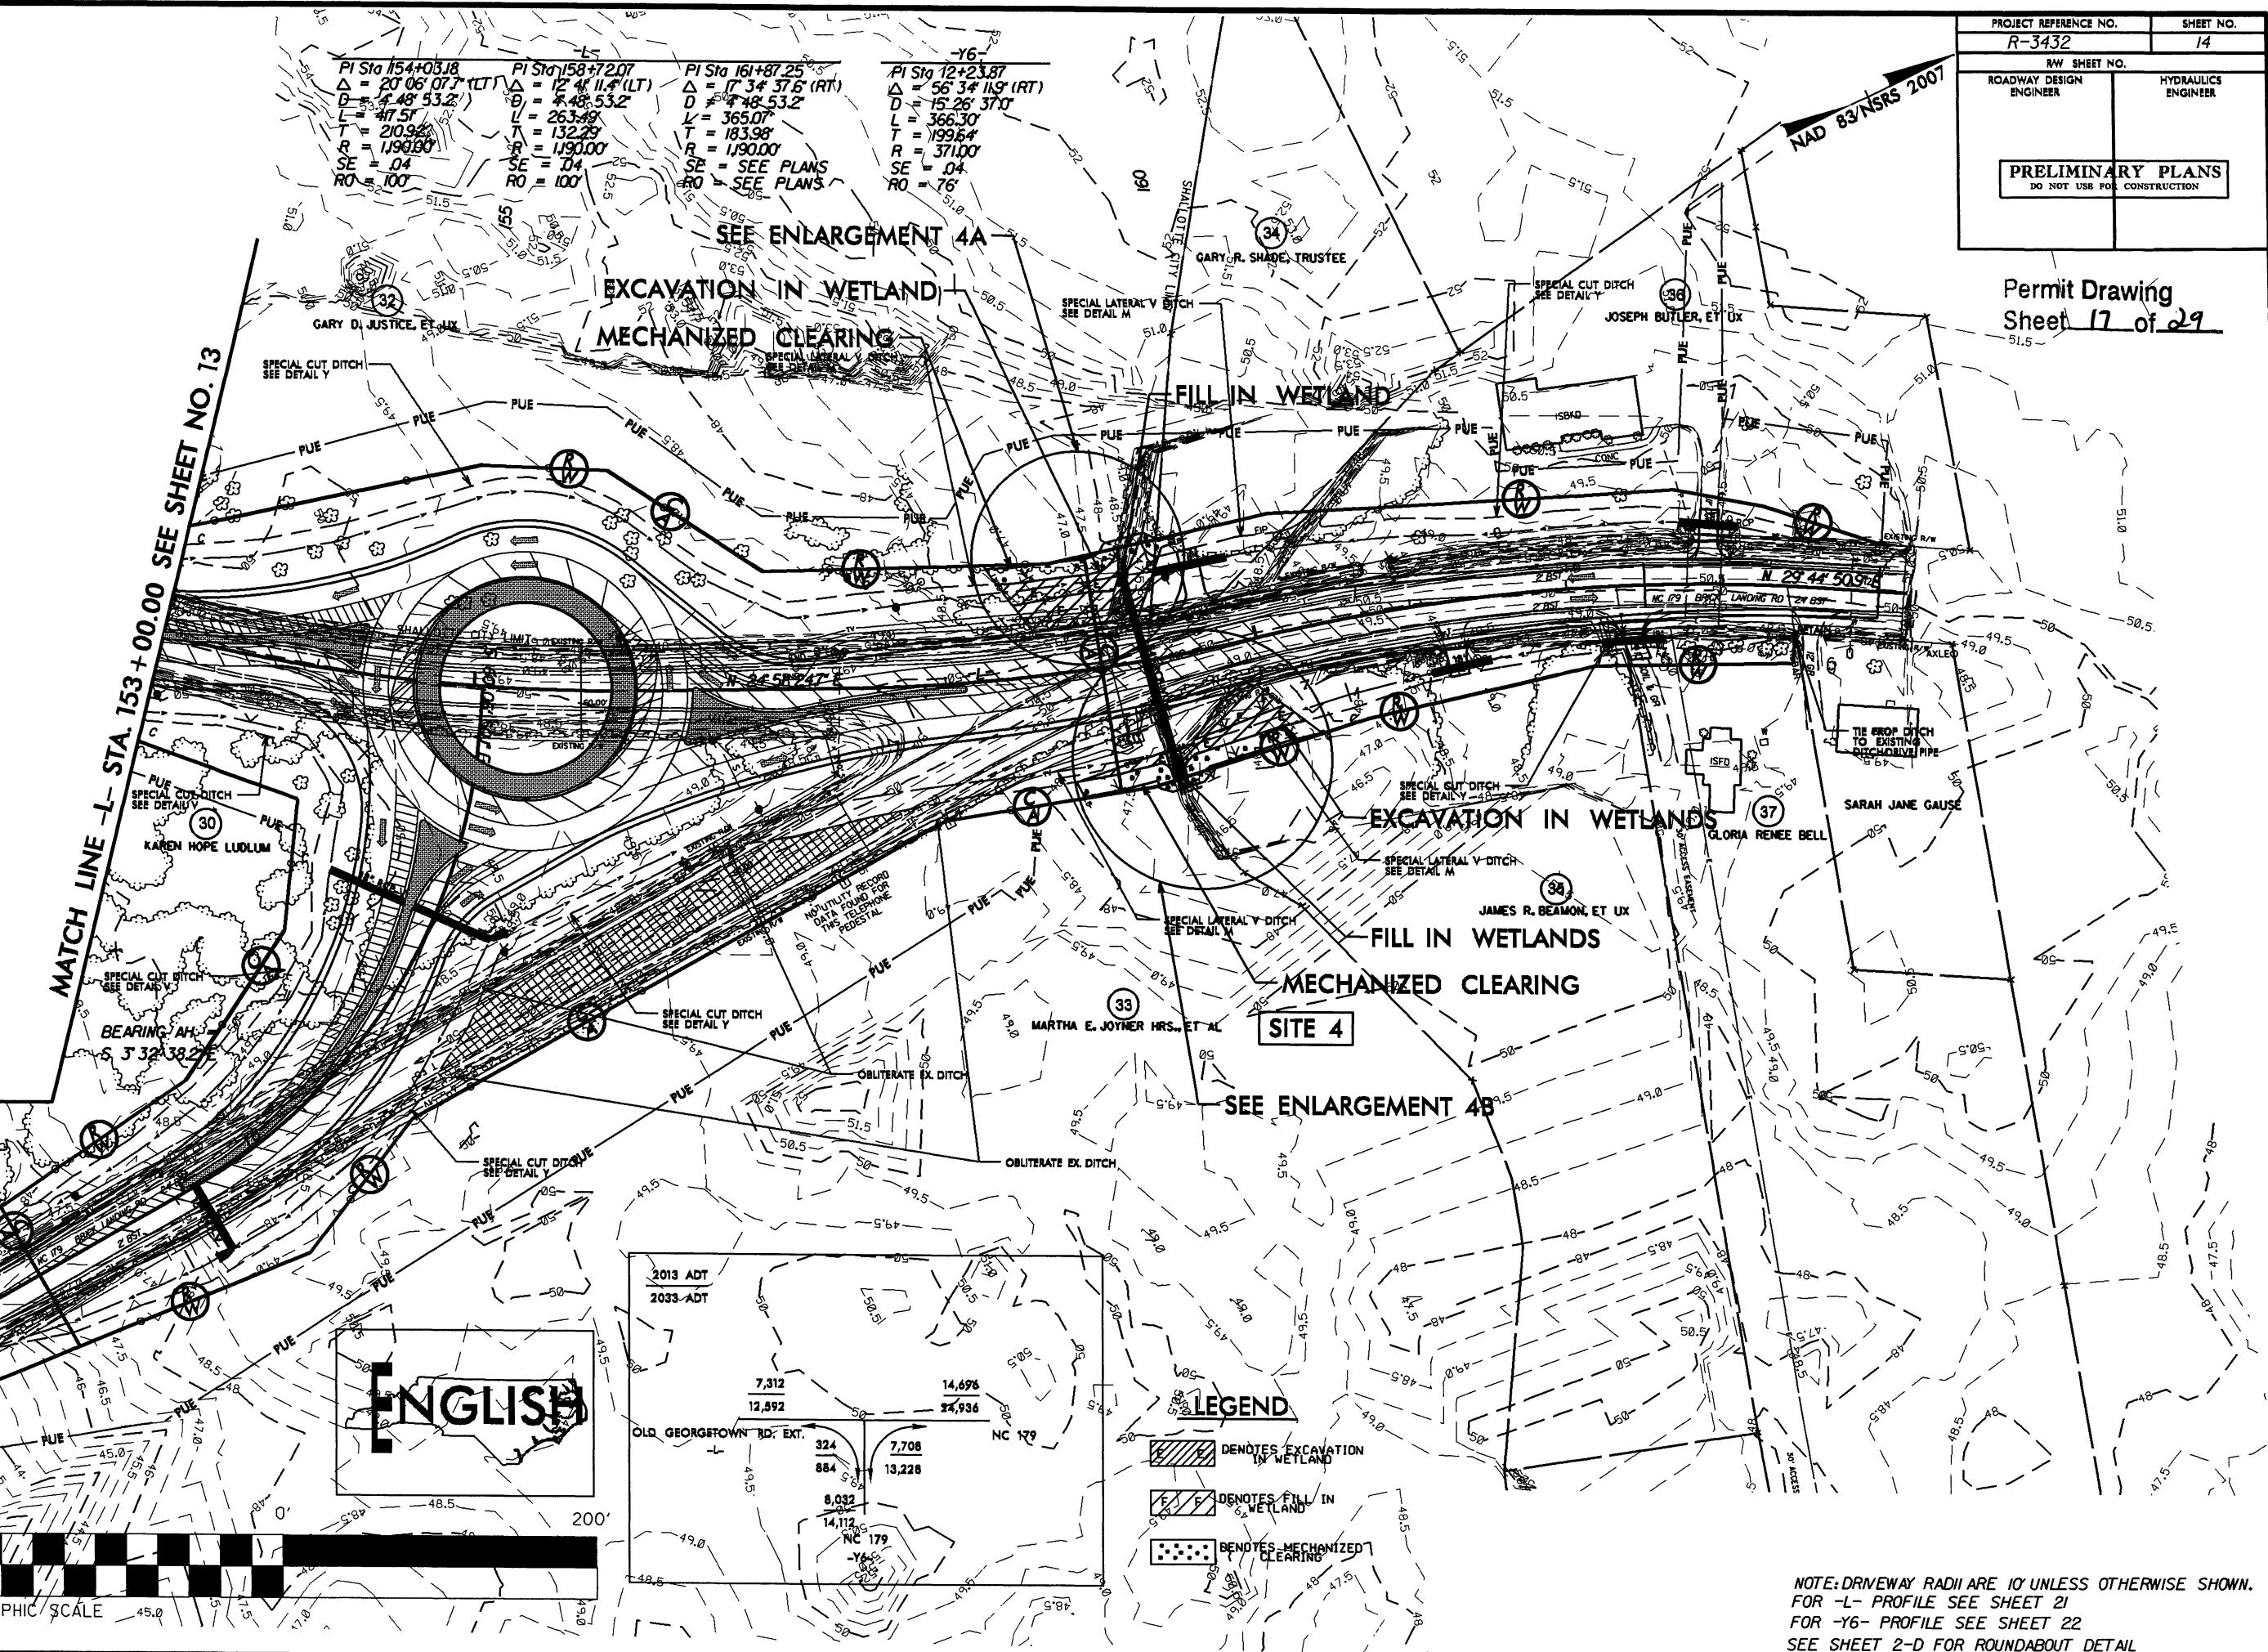

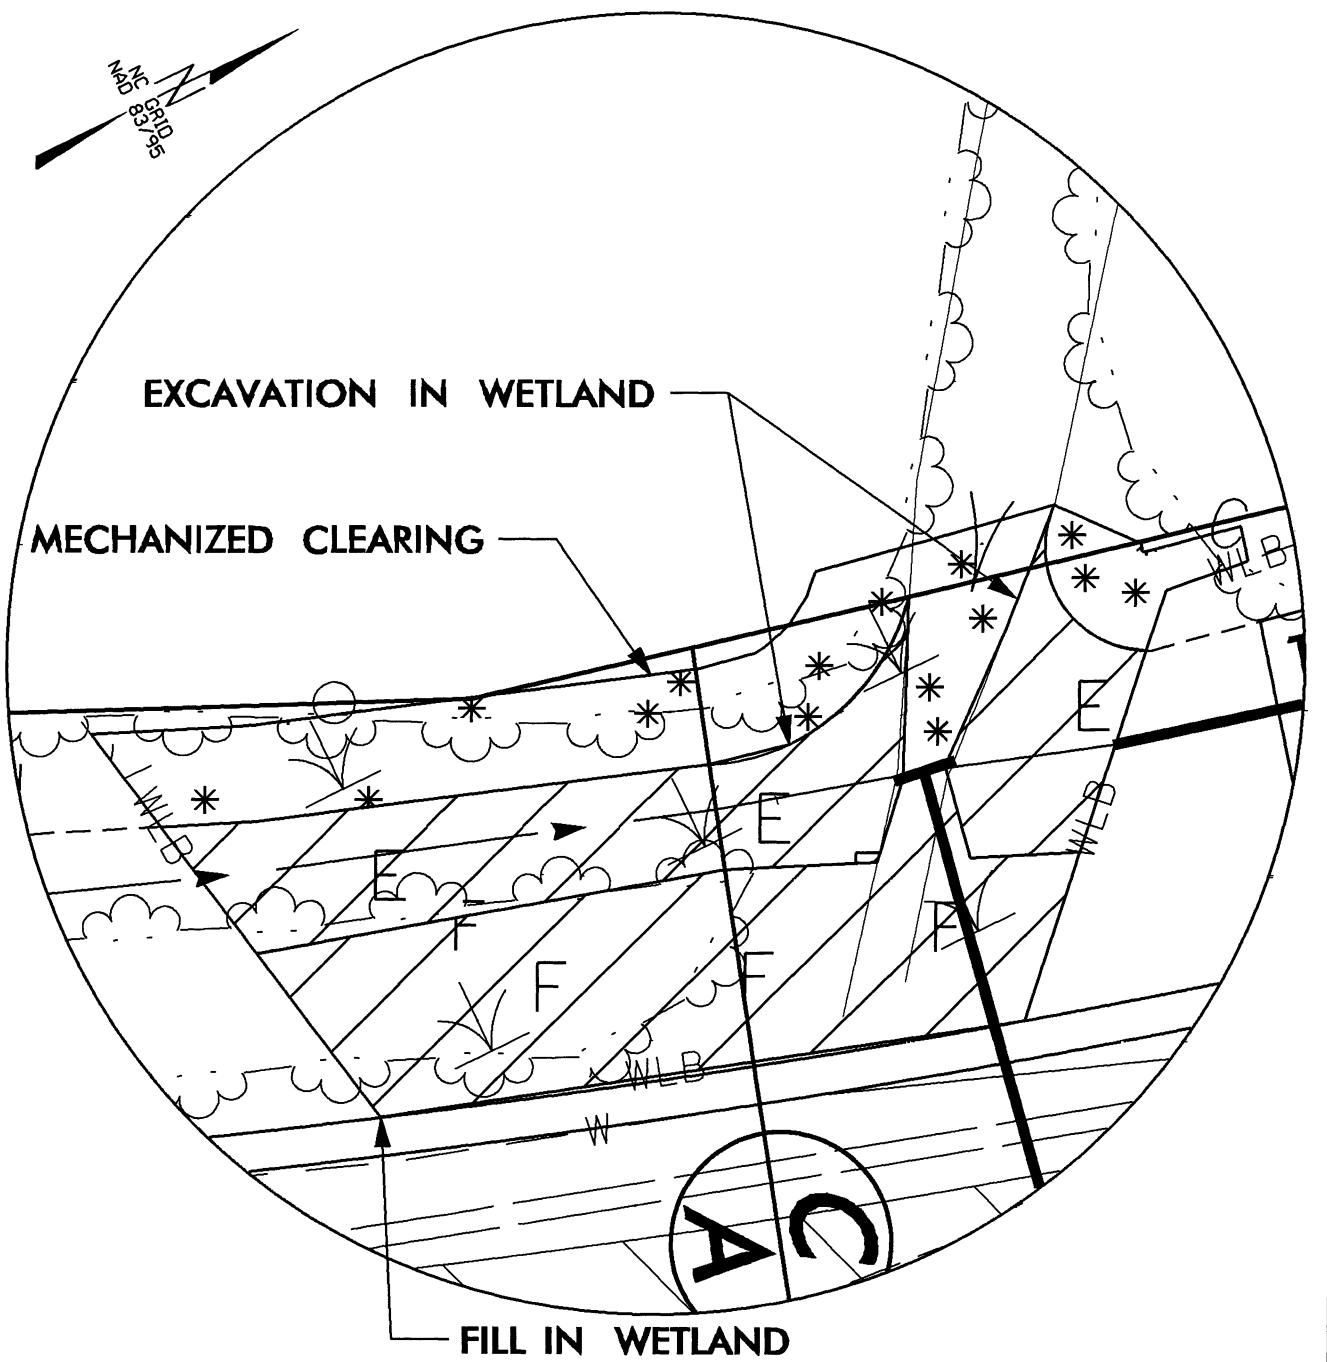


## SITE 4A ENLARGEMENT



DENOTES EXCAVATION  
IN WETLAND



DENOTES FILL IN  
WETLAND

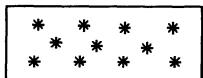

DENOTES MECHANIZED  
CLEARING

Permit Drawing  
Sheet 18 of 29

20'

0'

207

GRAPHIC SCALE

**NCDOT**  
**DIVISION OF HIGHWAYS**

BRUNSWICK COUNTY  
PROJECT: 355011.1 (R-3432)  
R 1163 (OLD GEORGETOWN RD.  
TENSION FROM SR 1184 (OCEAN  
ISLE BEACH RD) TO NC 179

SHEET

OF

04 / 25 / 12

MECHANIZED  
CLEARING

EXCAVATION  
IN  
WETLAND

FILL IN  
WETLAND

CD  
83/95  
GRID

54' RCP-V

PDE

E E  
F F  
\* \* \* \* \*  
DENOTES EXCAVATION  
IN WETLAND  
DENOTES FILL IN  
WETLAND  
DENOTES MECHANIZED  
CLEARING





## SITE 4B ENLARGEMENT

Permit Drawing  
Sheet 19 of 29

NCDOT  
DIVISION OF HIGHWAYS

BRUNSWICK COUNTY  
PROJECT: 35501.1.1 (R-3432)  
SR 1163 (OLD GEORGETOWN RD.  
EXTENSION) FROM SR 1184 (OCEAN  
ISLE BEACH RD.) TO NC 179

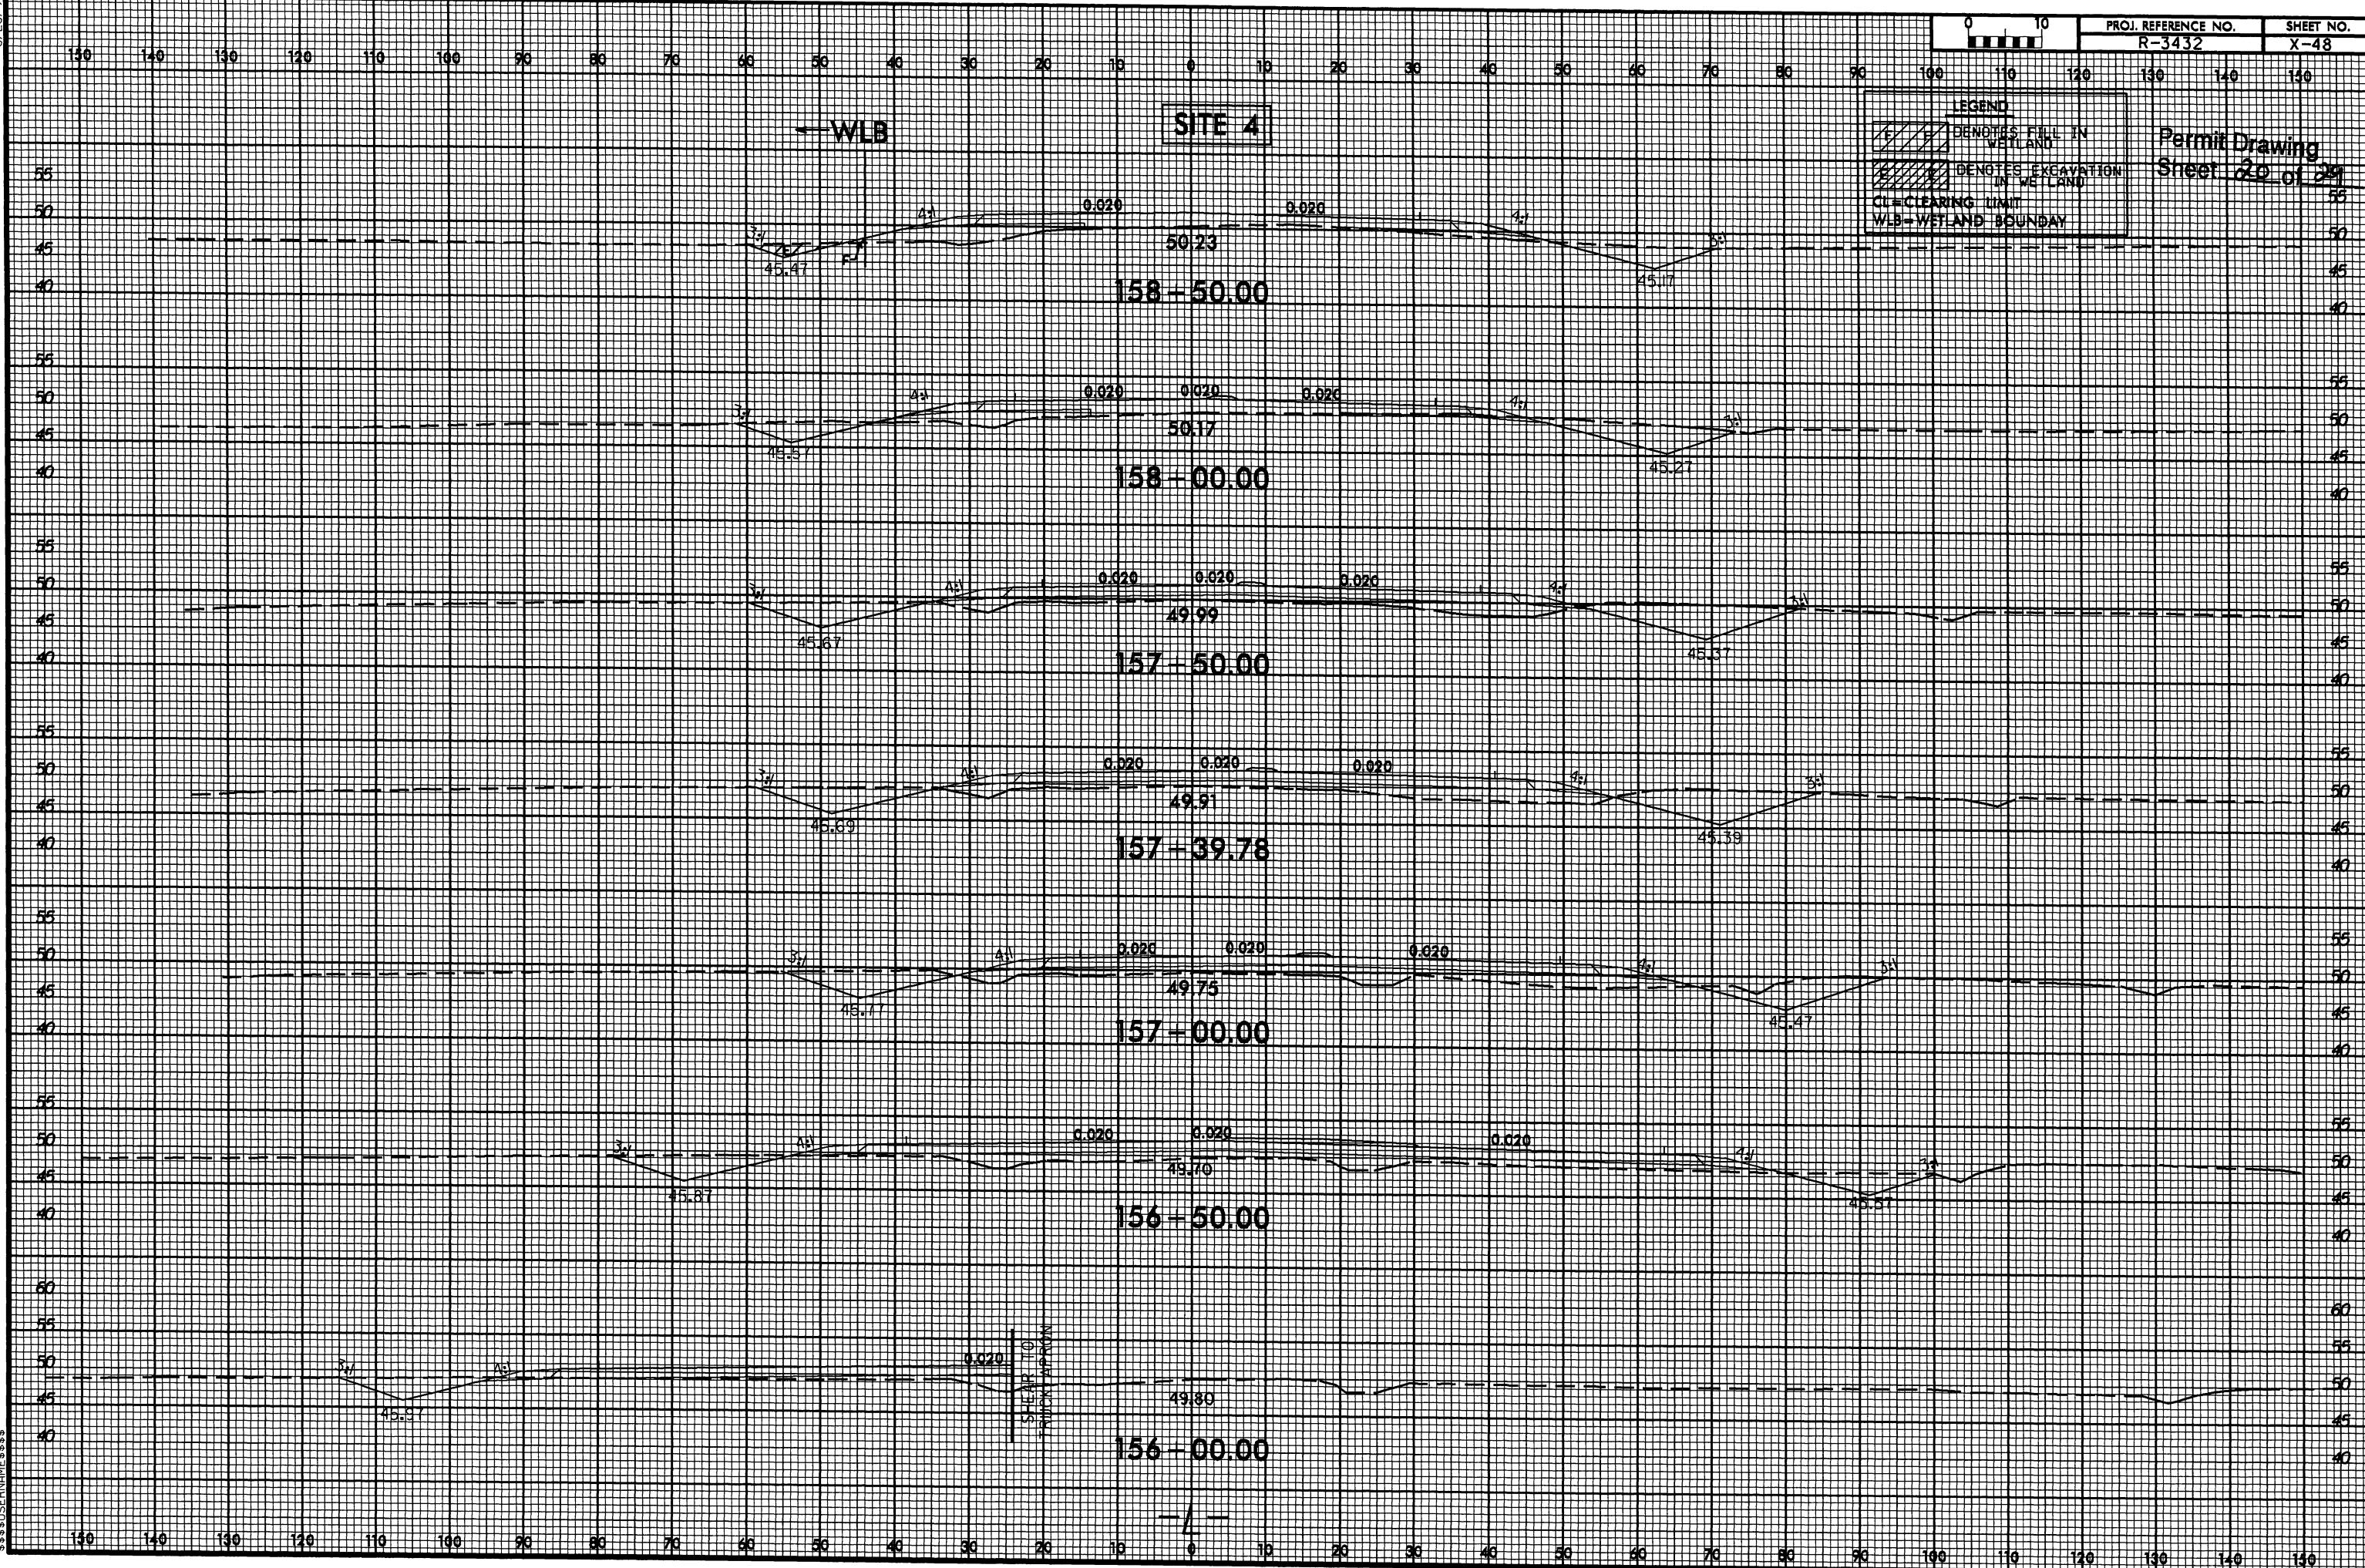

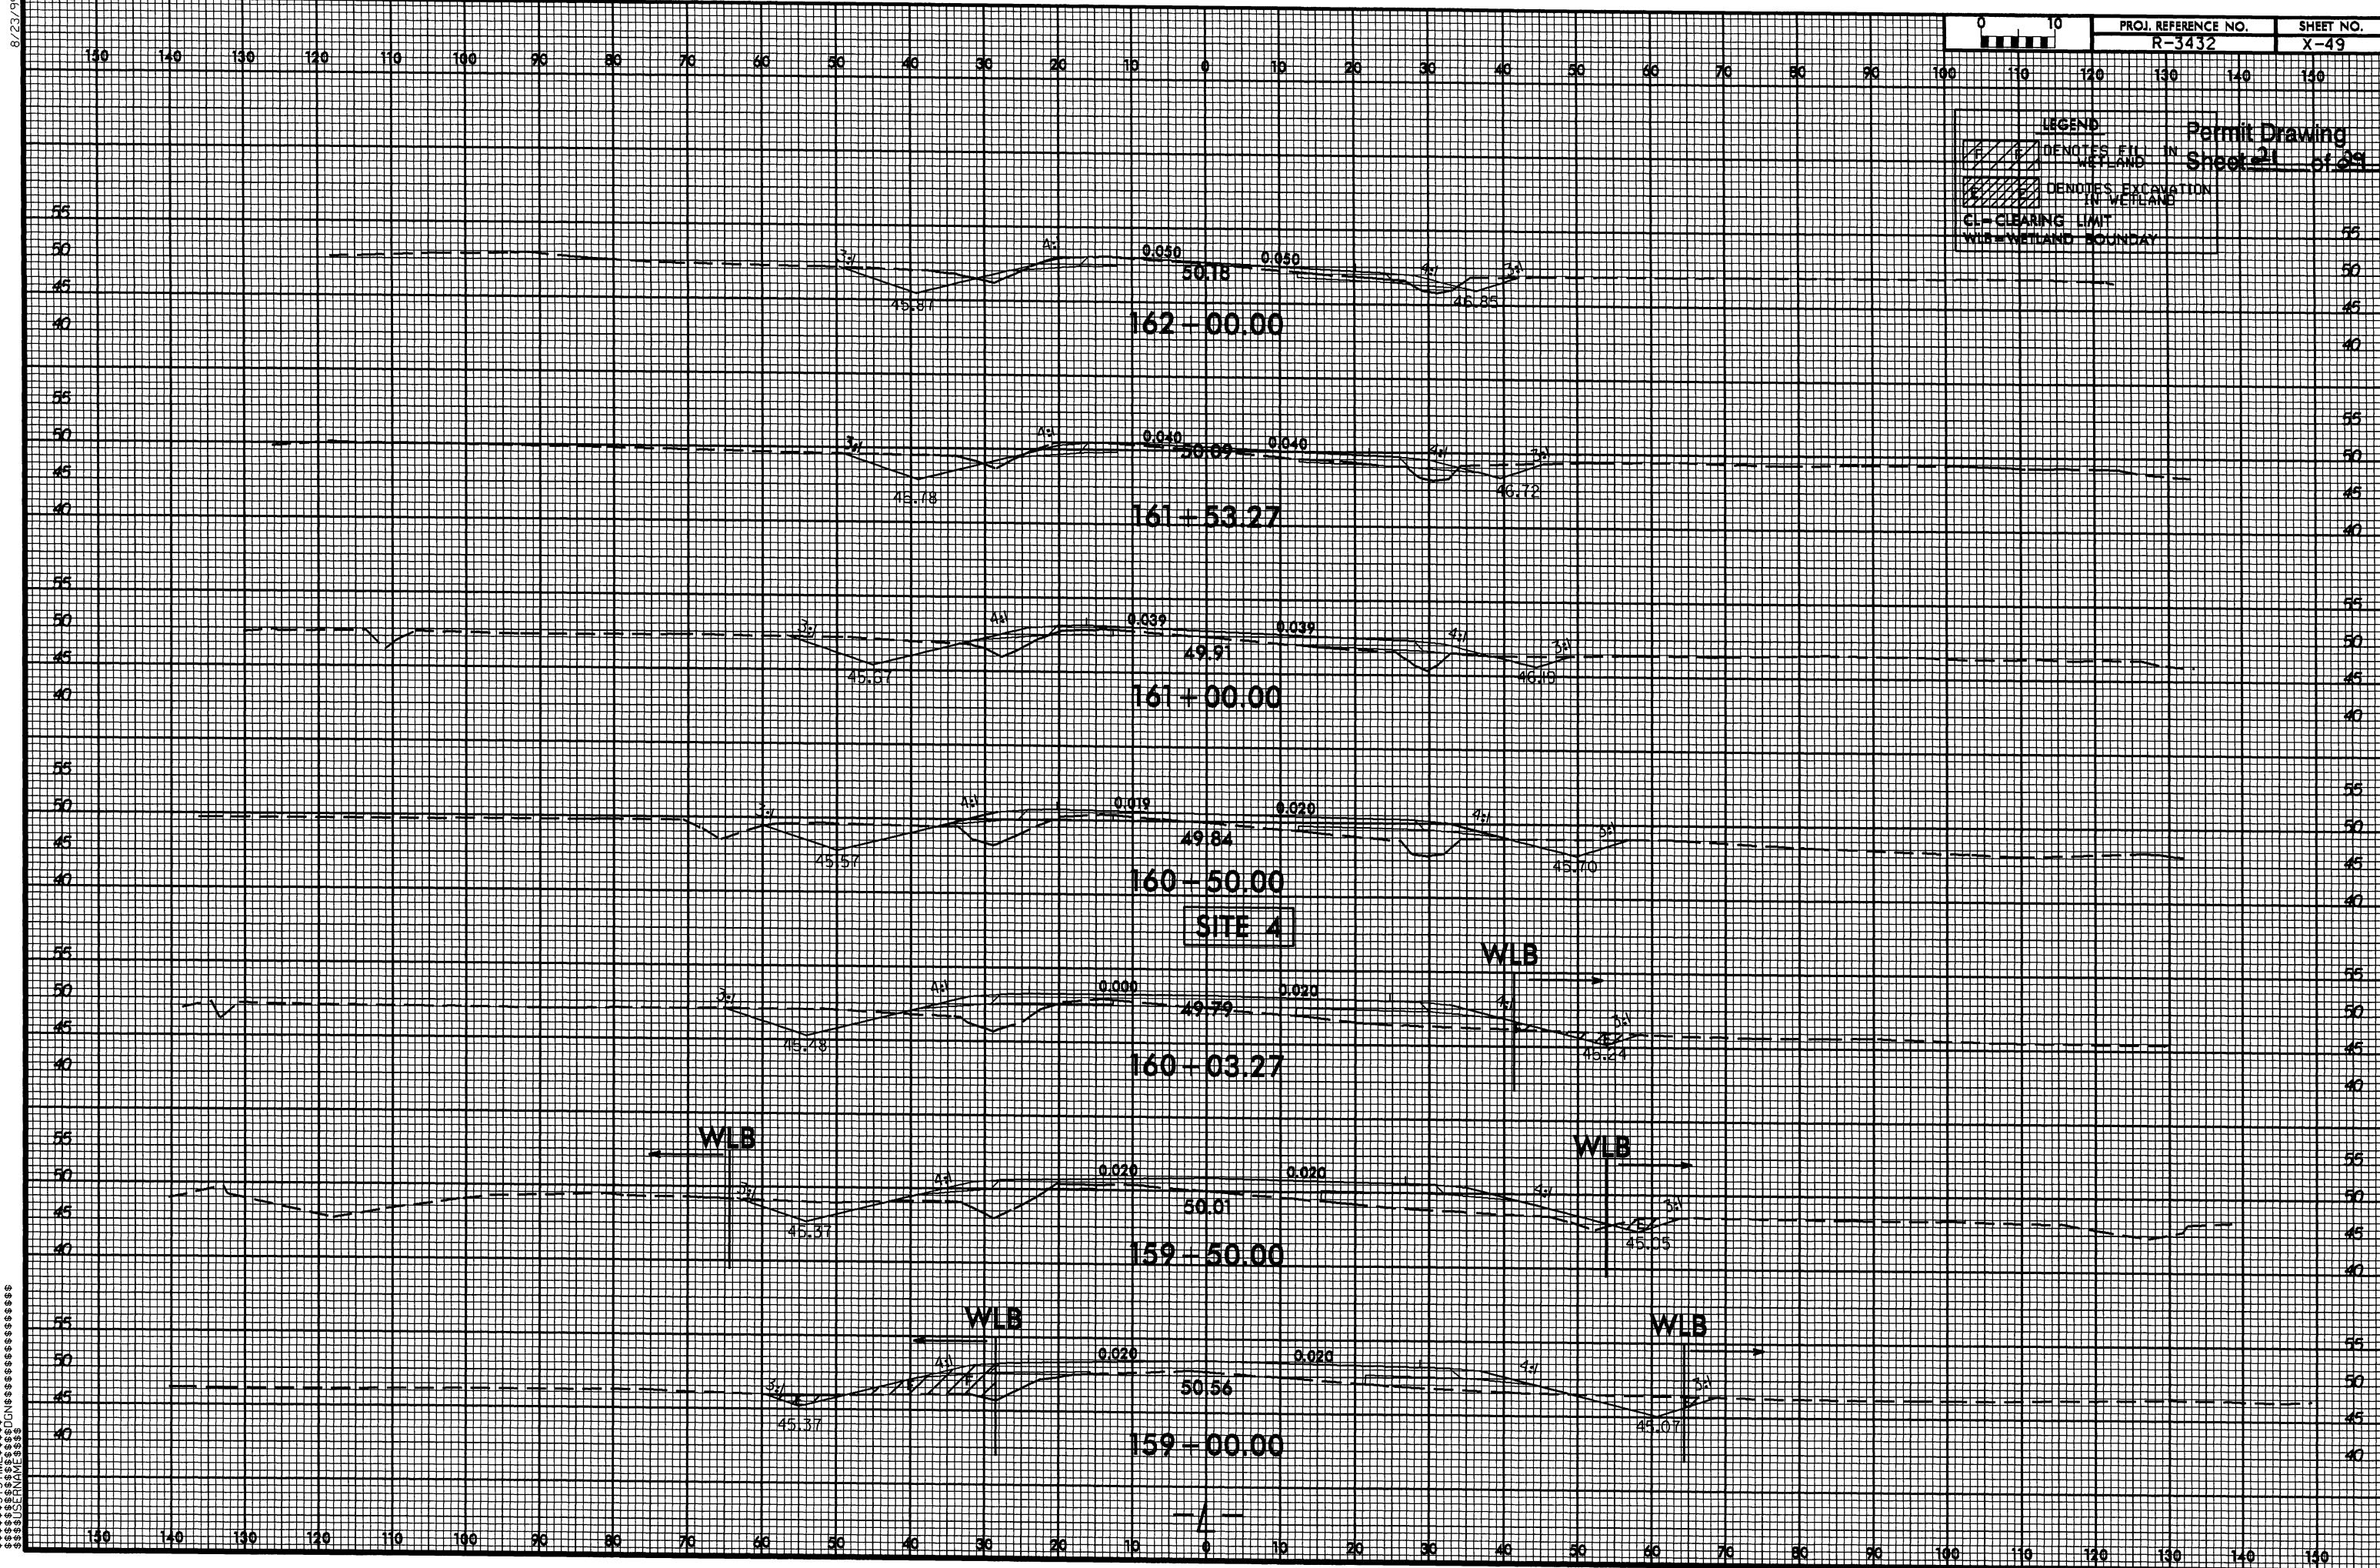






NAD 83/NSRS 2007

TEMPORARY IMPACTS SURFACE WATERS

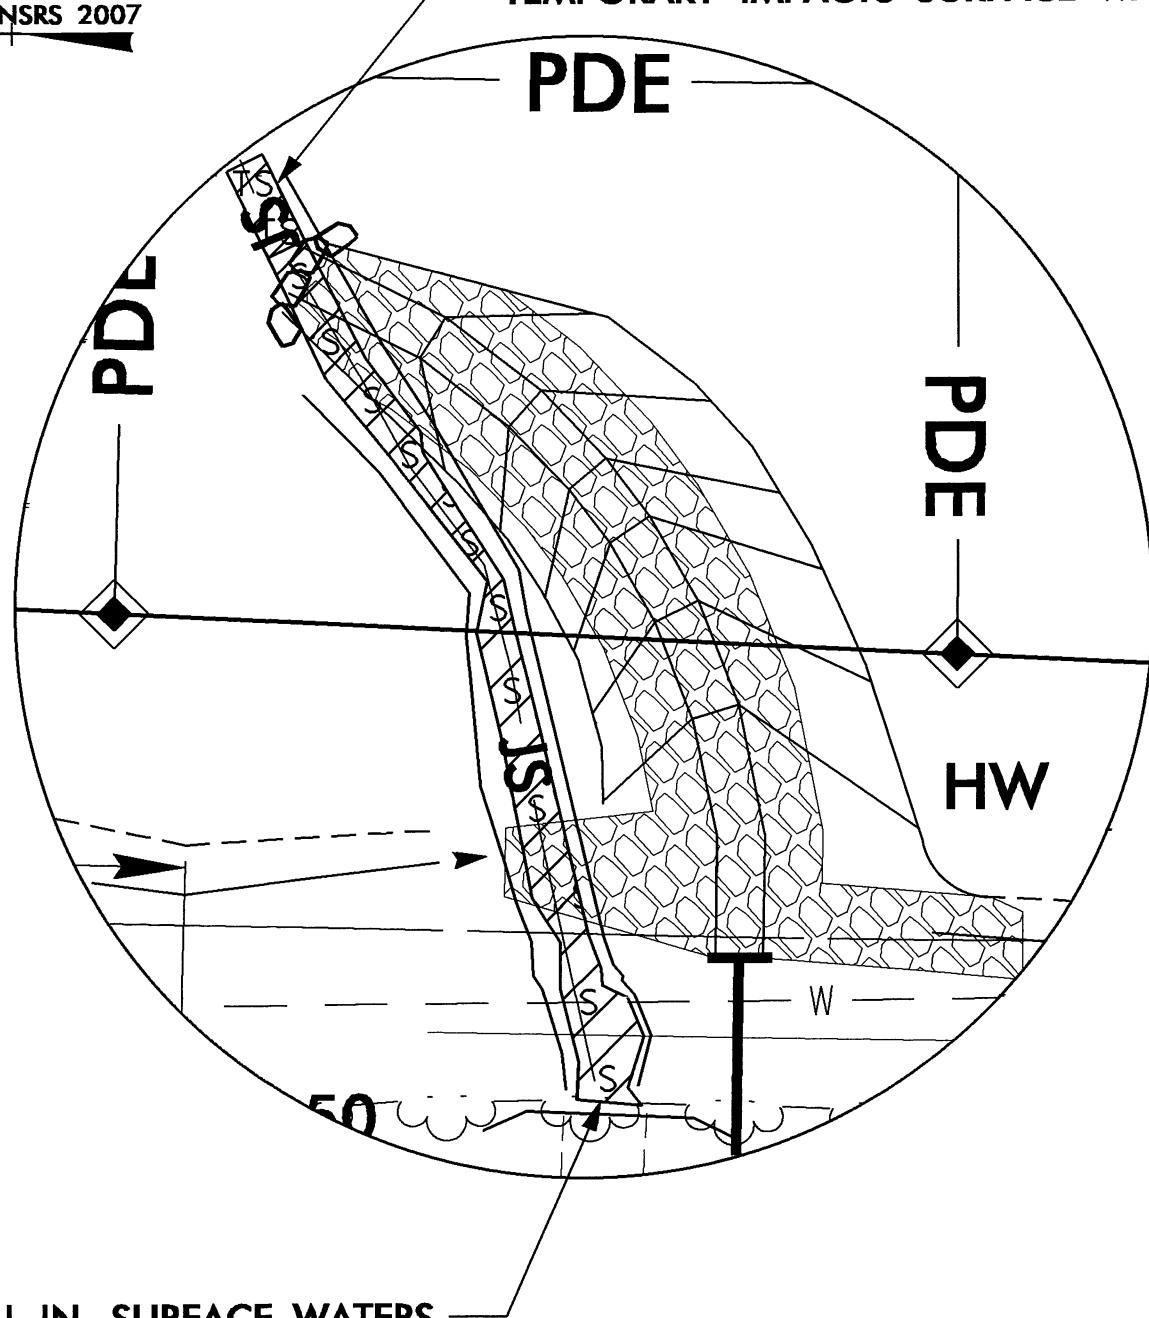

DENOTES TEMPORARY  
IMPACTS IN SURFACE WATER

DENOTES IMPACTS IN  
SURFACE WATER


Permit Drawing  
Sheet 24 of 29

20' 0' 20'  
  
GRAPHIC SCALE

**NCDOT**  
DIVISION OF HIGHWAYS

BRUNSWICK COUNTY  
PROJECT: 35501.1.1 (R-3432)  
SR 1163 (OLD GEORGETOWN RD.  
EXTENSION) FROM SR 1184 (OCEAN  
ISLE BEACH RD.) TO NC 179


NAD 83/NSRS 2007

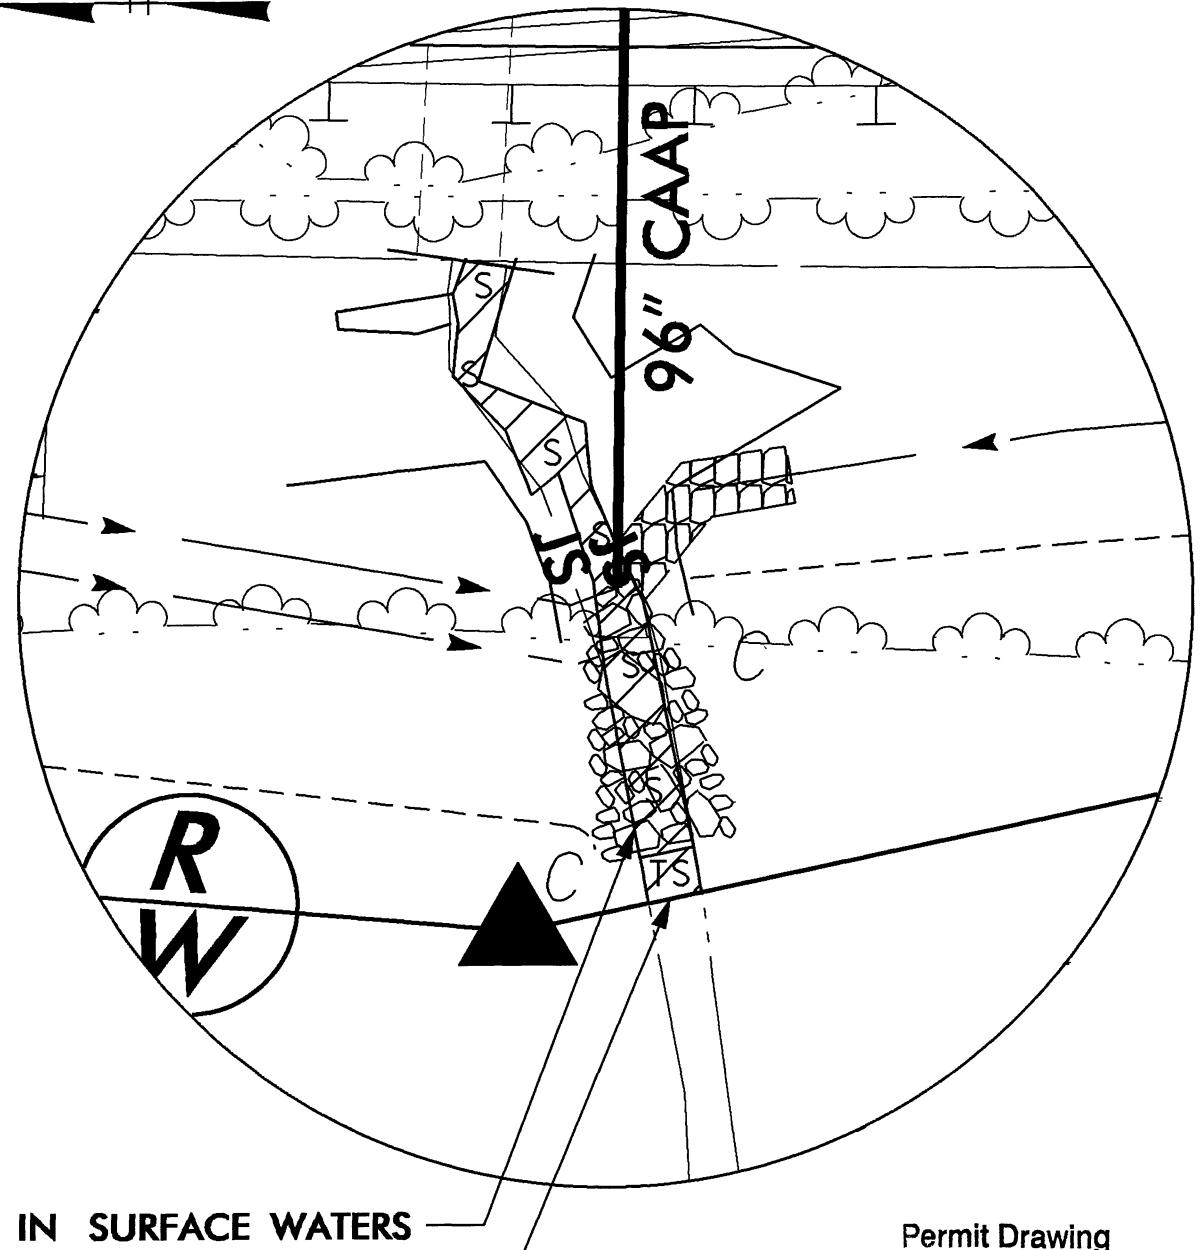


FILL IN SURFACE WATERS

TEMPORARY IMPACTS  
SURFACE WATERS

## SITE 5B ENLARGEMENT

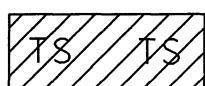

DENOTES TEMPORARY  
IMPACTS IN SURFACE  
WATER

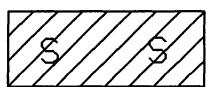

DENOTES IMPACTS IN  
SURFACE WATER

20'

0'

20'



GRAPHIC SCALE

NCDOT

DIVISION OF HIGHWAYS

BRUNSWICK COUNTY

PROJECT: 35501.1.1 (R-3432)

SR 1163 (OLD GEORGETOWN RD.  
EXTENSION) FROM SR 1184 (OCEAN  
ISLE BEACH RD.) TO NC 179

SHEET

OF

05 / 03 / 12

# SITE 5 JURISDICTIONAL STREAM PROFILE


**NCDOT**  
**DIVISION OF HIGHWAYS**

## **BRUNSWICK COUNTY**

PROJECT: 35501.1.1 (R-3432)

SR 1163 (OLD GEORGETOWN RD.  
EXTENSION) FROM SR 1184 (OCEAN

SHEET OF 05 / 03 / 12

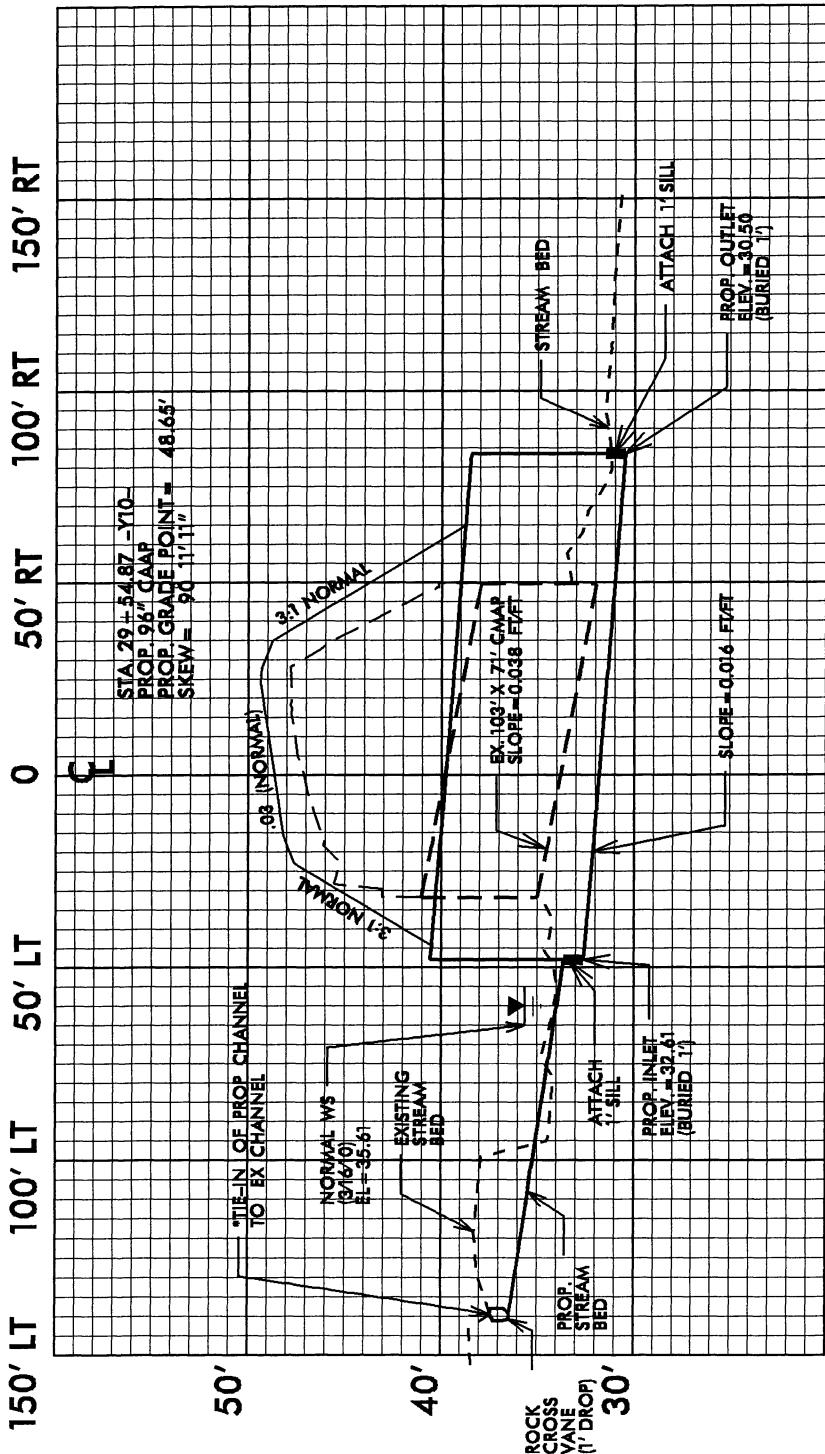

**SCALE  
HORZ: 1" = 50'  
VERT: 1"**

Permit Drawing  
Sheet 24 of 29



**PROPERTY OWNERS**  
NAMES AND ADDRESSES

PARCEL NO.	NAMES	ADDRESSES
3	Odell & Glenn N. Williamson	PO BOX 1602, Shallotte, NC 28459
4, 39	MAS Properties, LLC	131 Ocean Blvd. West, Holden Beach, NC 28462
5	Mills Land and Timber, LLC	131 Ocean Blvd. West, Holden Beach, NC 28462
8	Glen N., Jr. & Sarah S. Williamson	PO BOX 1602, Shallotte, NC 28459
9	Waterway Properties	1625 Woodview Dr., Ocean Isle Beach, NC 28469
10	Gloria Renee Bell	PO BOX 1984, Shallotte, NC 28459
11	John Henry & Mabeline Hill	1060 Hale Swamp Rd., SW, Shallotte, NC 28459
12	Charles D. Hill	PO BOX 374, Shallotte, NC 28459
13	Lindsey Clifton Thomas	PO BOX 181, Shallotte, NC 28459
14	Mary Lily Wigfall	4768 Oakview Dr., Southport, NC 28461
32	Gary D. & Rebecca H. Justice, et ux	3288 Channelside Dr., SW, Supply, NC 28462
33	Martha Joyner HRS, et al	812 N. Caswell Ave., Southport, NC 28461
34	Gary R. Shade, Trustee	PO BOX 1621, Mountain View, CA 94042
35	James R. & Caroline K. Beamon	PO BOX 1403, North Wilkesboro, NC 28659

Permit Drawing  
Sheet 28 of 29

**NCDOT**  
**DIVISION OF HIGHWAYS**

BRUNSWICK COUNTY  
PROJECT: 35501.1.1 (R-3432)  
SR 1163 (OLD GEORGETOWN RD.  
EXTENSION) FROM SR 1184 (OCEAN  
ISLE BEACH RD.) TO NC 179

## WETLAND PERMIT IMPACT SUMMARY

DIVISION OF HIGHWAYS  
BRUNSWICK COUNTY  
WBS - 35501-1-1  
(R-3432)

Permit Drawing  
Sheet 29 of 29

AIN 331/03

## **R-3432 NEU Narrative**

### **Utility Owners:**



- **Power:** Brunswick EMC (Transmission) - Mr. Rodney Scruggs 910-755-4246
- **Power:** Brunswick EMC (Distribution) - Mr. Josh Winslow, PE (910) 754-4391
- **Telephone:** ATMC (Atlantic Telephone Membership Corporation) - Mr. Scott Dutton (910) 755-1701
- **Water:** Brunswick County (water)- John Nicholes (910) 253-2653
- **Cable TV:** Time Warner Cable Mr. Robert John (910) 772-5757

### **General Utility Relocation:**



All utility lines inside project limits currently within construction limits will be adjusted as necessary or relocated away from construction before project let.

### **Existing Utilities:**

- **Power (Transmission):** Existing transmission O/H power poles are in conflict with construction of the project and will be relocated outside the R/W line and inside the PUE line. There is no impact on wetlands.
- **Power (Distribution):** Existing O/H power poles are in conflict with construction of the project and will be relocated inside the PUE line. There is no impact on wetlands.
- **Telephone:** Existing Telephone lines will be adjusted as required.
- **Water:** The water line will be relocated as required, using trenchless method in wetlands areas. There is no impact on the wetlands.
- **Cable TV:** Existing Telephone lines will be adjusted as required.

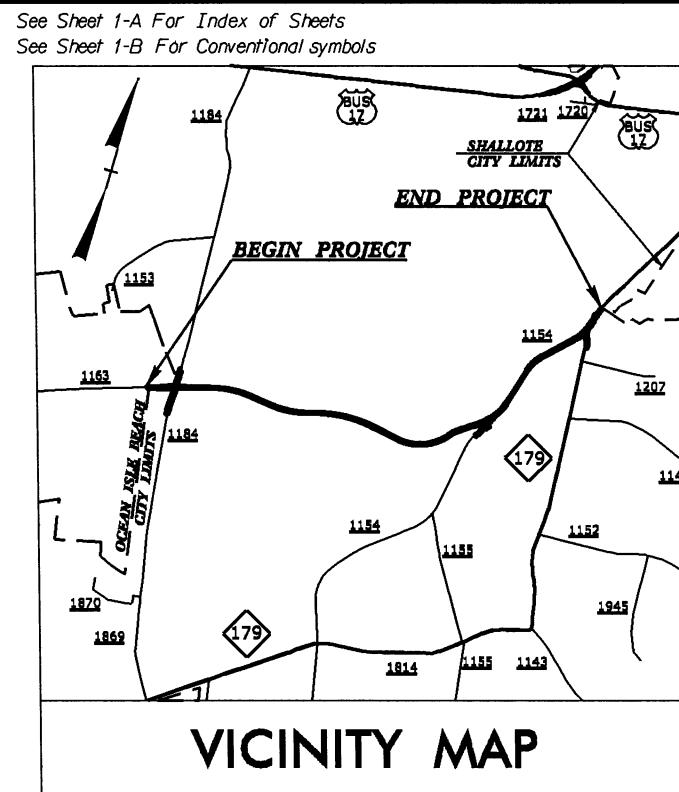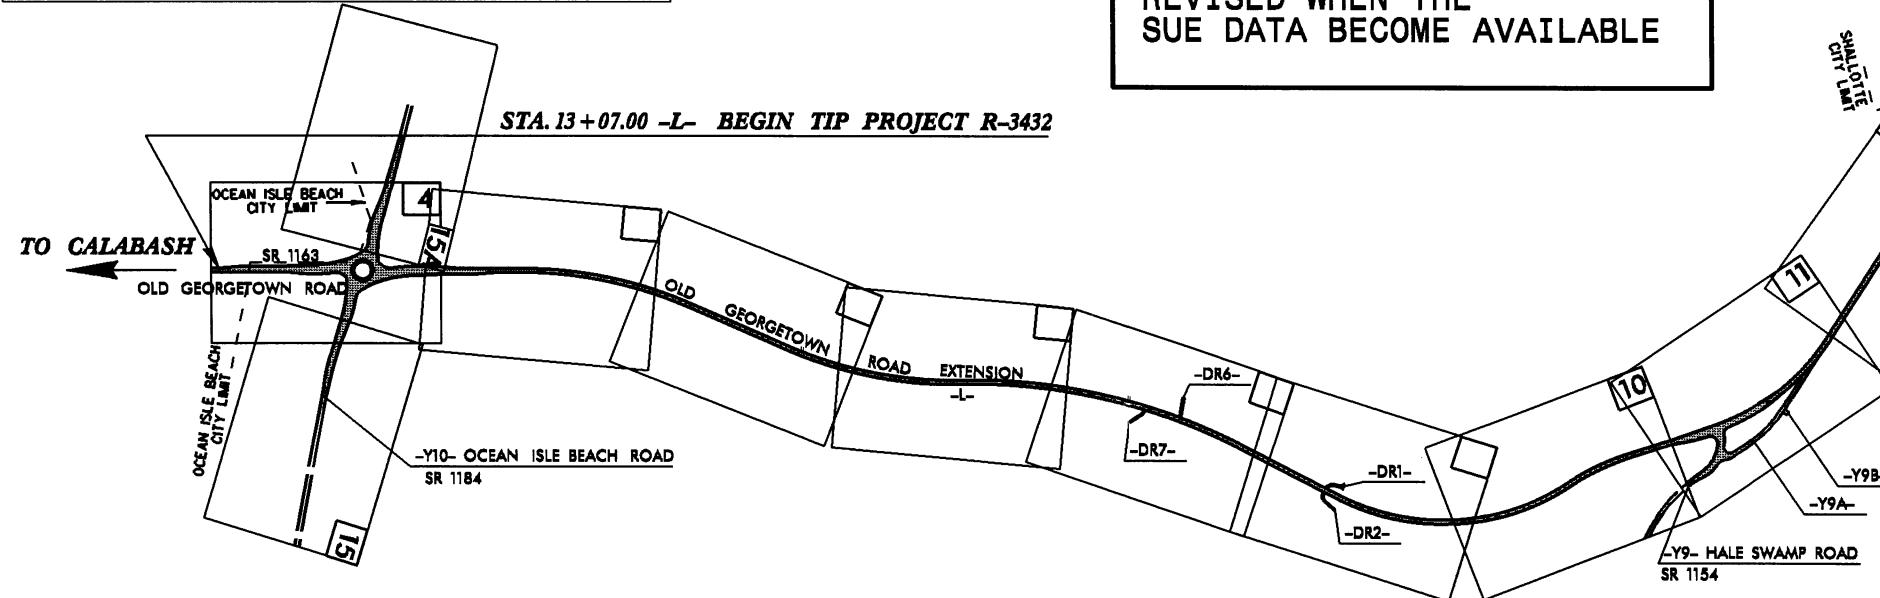**CONTRACT:****TIP PROJECT: R-3432****VICINITY MAP**

THIS IS A PARTIAL CONTROLLED-ACCESS PROJECT WITH ACCESS BEING LIMITED TO POINTS AS SHOWN ON THE PLANS.  
A PORTION OF THIS PROJECT IS WITHIN THE MUNICIPAL BOUNDARIES OF OCEAN ISLE BEACH AND SHALLOTTE.  
CLEARING ON THIS PROJECT SHALL BE PERFORMED TO THE LIMITS ESTABLISHED BY METHOD III.

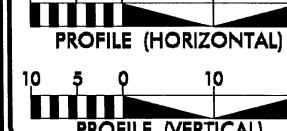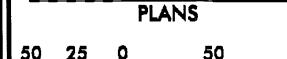PRELIMINARY PLANS  
DRAFT - NOT FOR CONSTRUCTION**GRAPHIC SCALES****DESIGN DATA**

ADT 2013 = 7,312  
ADT 2033 = 12,592

DHV = 55 %

D = 13 %

T = 3 % \*

V = 60 MPH

\* (TTST 1 % + DUAL 2 %)  
FUNC. CLASS. = COLLECTOR  
SUB-REGIONAL TIER

**PROJECT LENGTH**

LENGTH ROADWAY TIP PROJECT R-3432 = 2.859 MILES  
TOTAL LENGTH TIP PROJECT R-3432 = 2.859 MILES

Prepared In the Office of:  
**DIVISION OF HIGHWAYS**

1000 Birch Ridge Dr., Raleigh NC, 27610

2012 STANDARD SPECIFICATIONS

RIGHT OF WAY DATE:

NOVEMBER 29, 2011

LETTING DATE:

JUNE 18, 2013

G. E. BREW, PE  
PROJECT ENGINEER

THAD F. DUNCAN, PE  
PROJECT DESIGN ENGINEER

**HYDRAULICS ENGINEER**

SIGNATURE: P.E.

ROADWAY DESIGN

ENGINEER

SIGNATURE: P.E.

**DIVISION OF HIGHWAYS  
STATE OF NORTH CAROLINA**

STATE HIGHWAY DESIGN ENGINEER

# NEU PERMIT DRAWING PLANS

## BRUNSWICK COUNTY


**LOCATION: SR 1163 (OLD GEORGETOWN ROAD EXTENSION) FROM SR 1184 (OCEAN ISLE BEACH ROAD) TO NC 179**

**TYPE OF WORK: GRADING, DRAINAGE, AND PAVING**

**STA. 164 + 00.00 -L- END TIP PROJECT R-3432**

STATE	STATE PROJECT REFERENCE NO.	SECT NO.	TOTAL SHEETS
N.C.	R-3432	1	
	STATE PROJ. NO.	P. A. PROJ. NO.	DESCRIPTION
	35501.1.1		P.E.
	35501.2.1		R/W, UTL.

Utility Permit Drawing  
Sheet 1 of 10

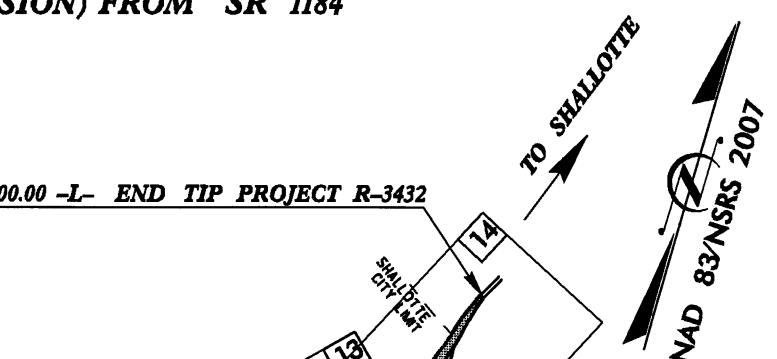

**Utility Permit Drawing  
Sheet 2 of 10**


*STA.13+07.00 -L-*

---

BEGIN STATE PROJECT R-3432


PROP. O/H POWER LI

*E DEEDED TO BRUNSWICK EMC*

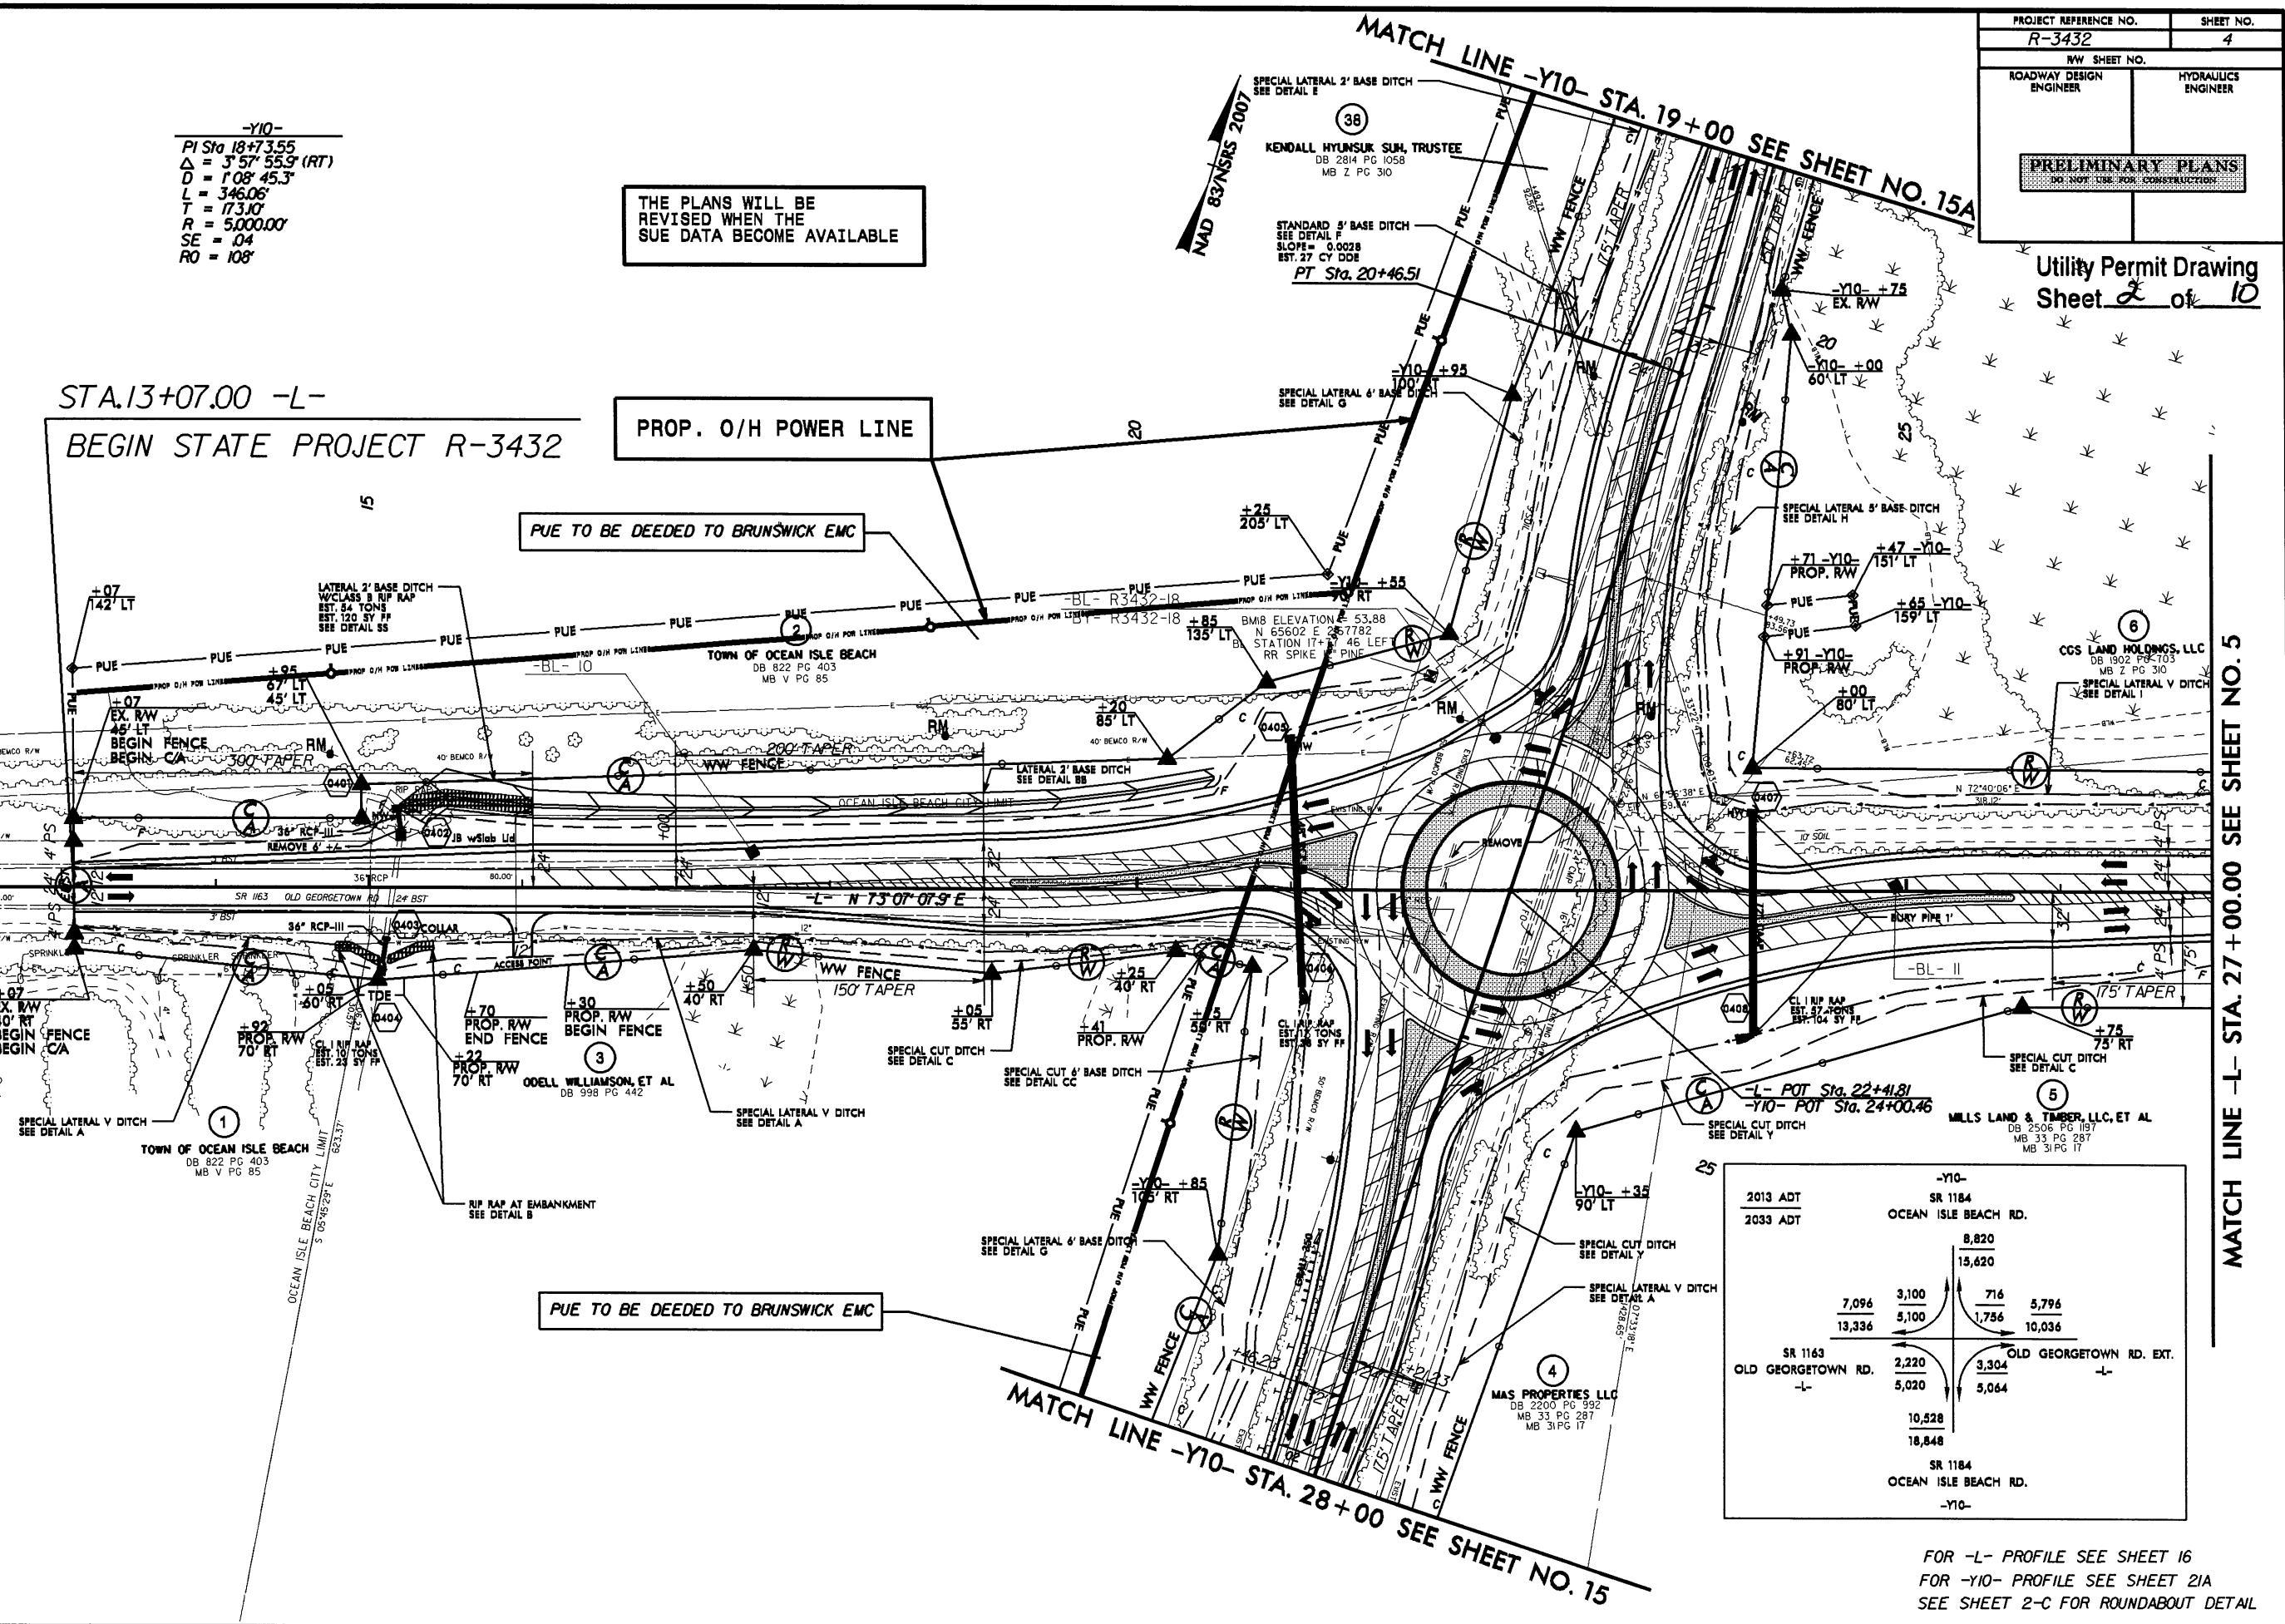


ה-בְּנֵי-עַמָּךְ יְהוָה כִּי-אַתָּה תְּמִימֹן בְּבָנֶיךָ וְבָנָי-עֲמָךָ

MATCH LINE -L STA. 97+00.00 SEE SHEET NO. 9  
GLB  
ROCK SEE DE  
SPECIAL LATEN  
SEE DETAIL L  
C  
105' 105'  
4' BS 2' 4' PS  
GR

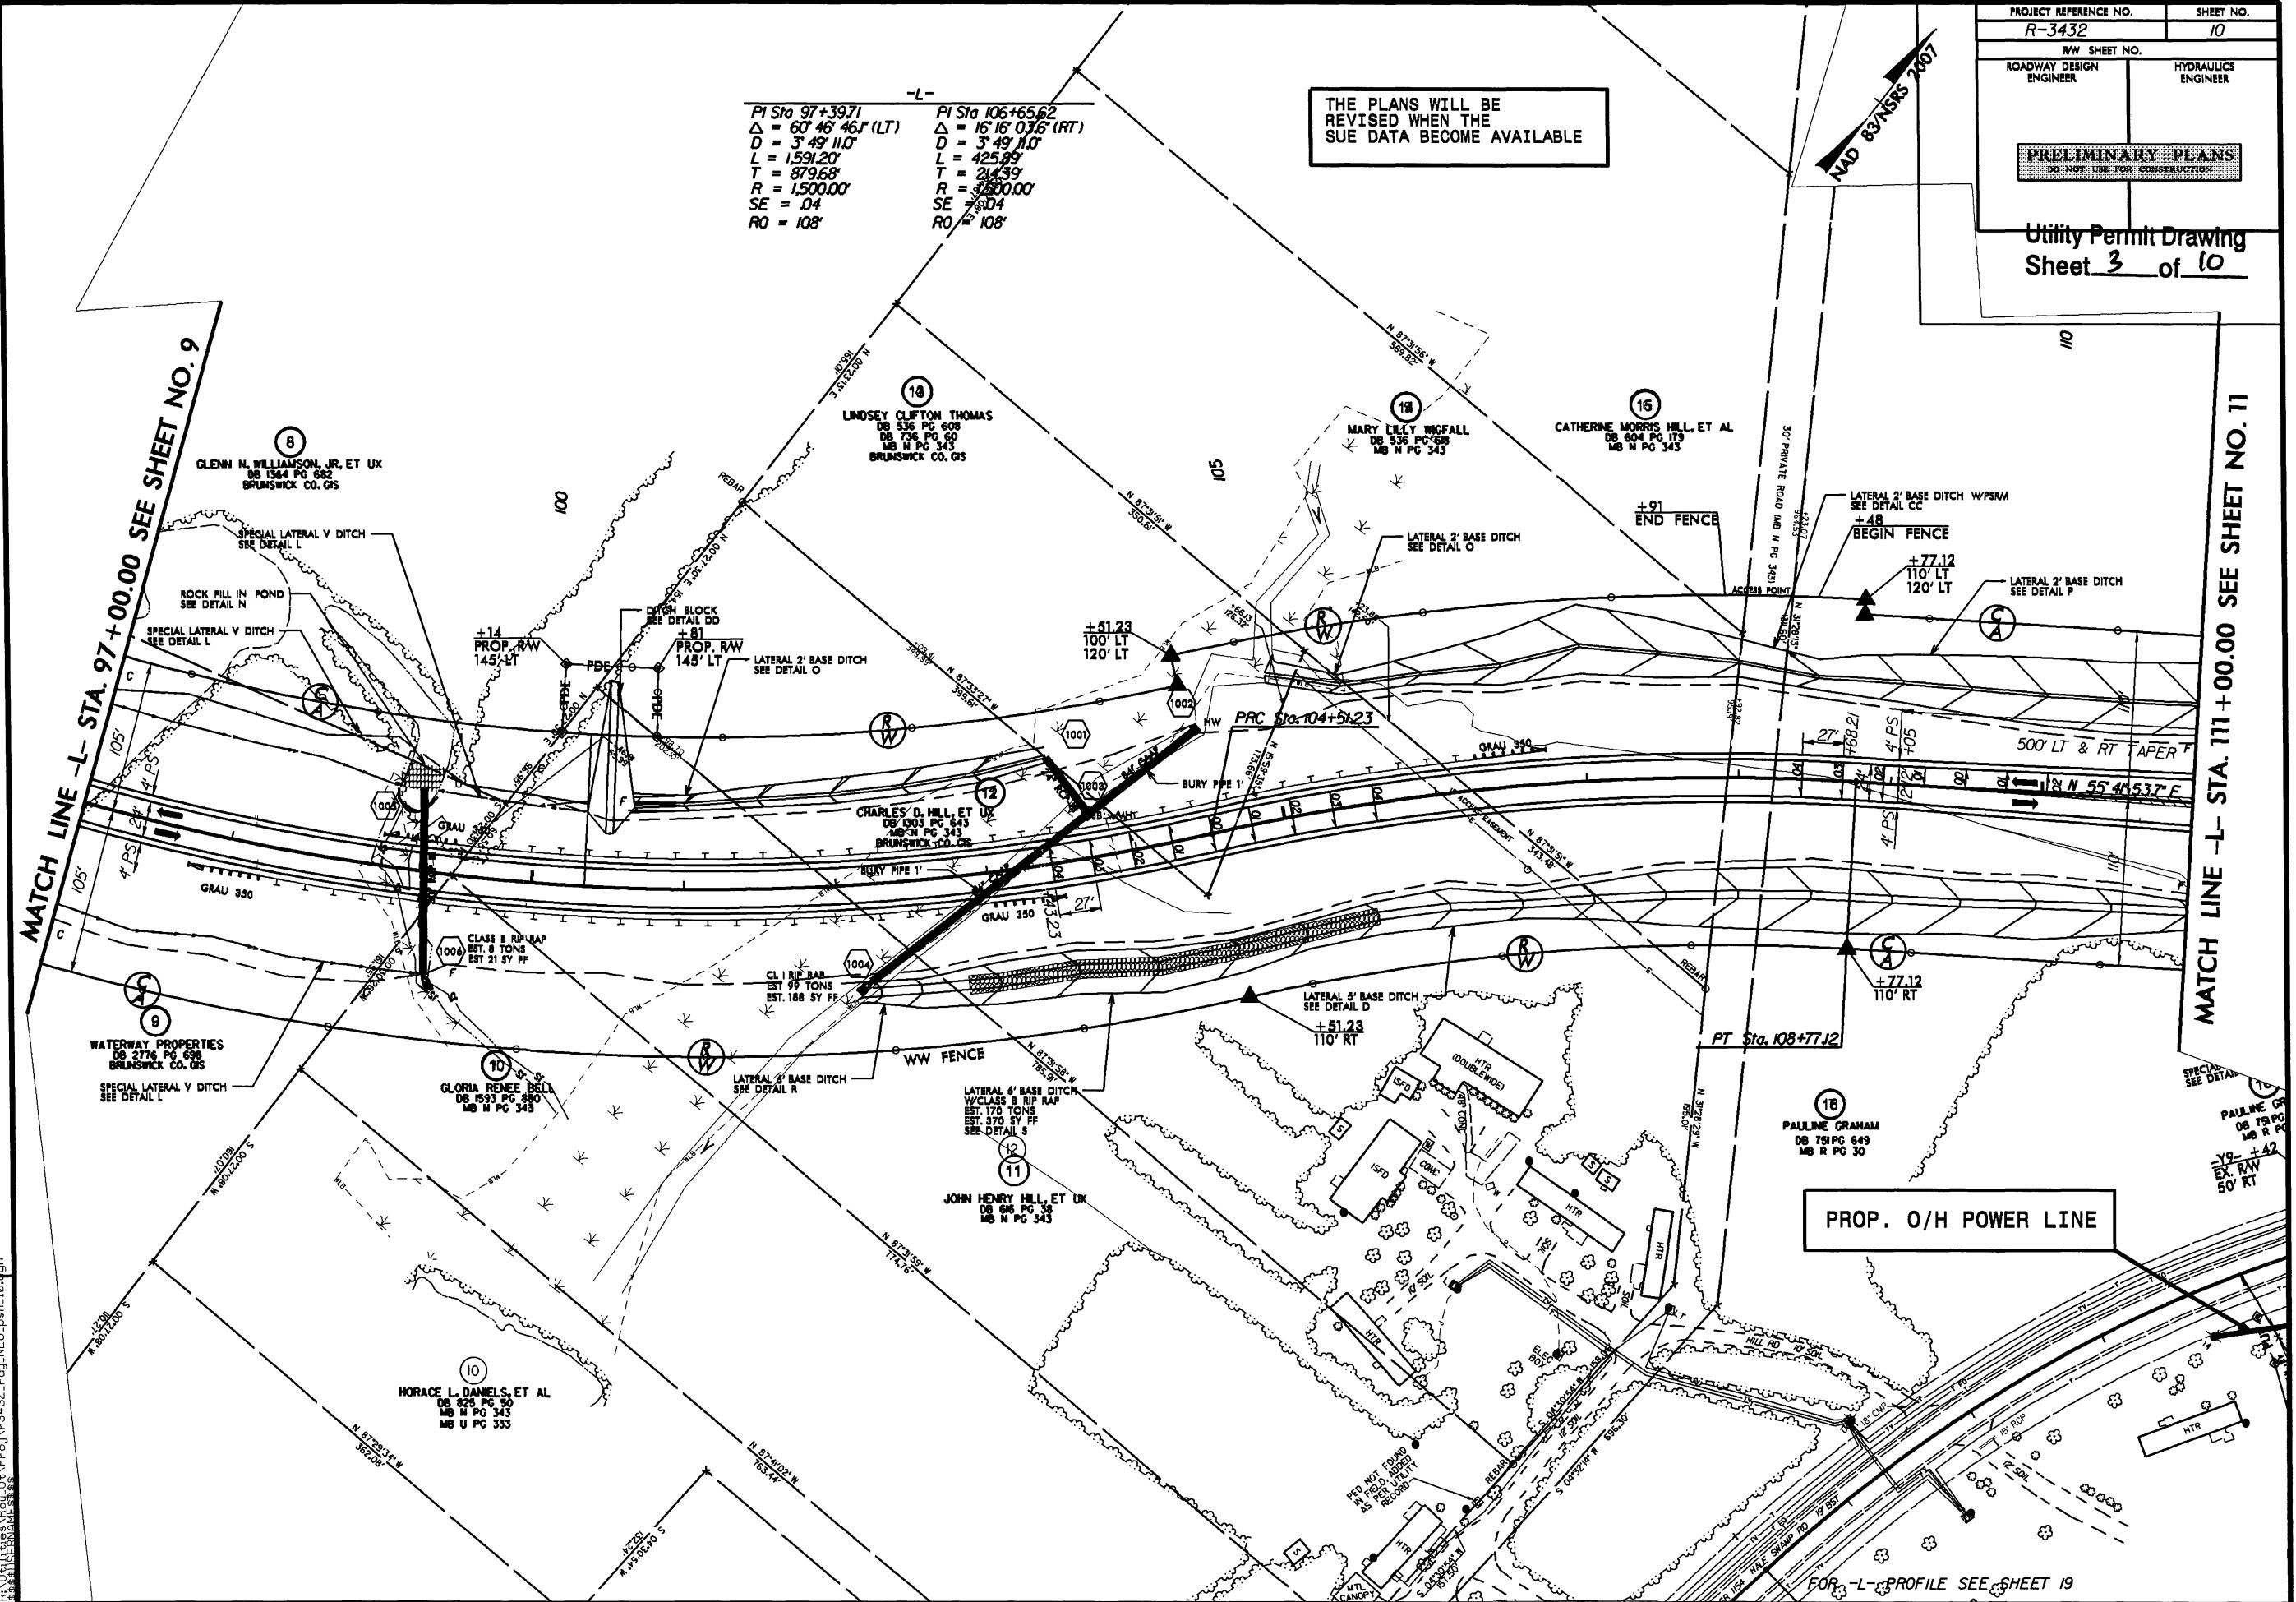

Utility Permit Drawing  
Sheet 4 of 10

~~P1~~  
 P1 Sta 119°40.44  
 $\Delta = 39^{\circ}34'10.4''$  (LT)  
 $D = 3^{\circ}49'11.0''$   
 $L = 1035.93'$   
 $T = 539.58'$   
 $R = 1500.00'$   
 $SE = .04$   
 $RO = 108'$

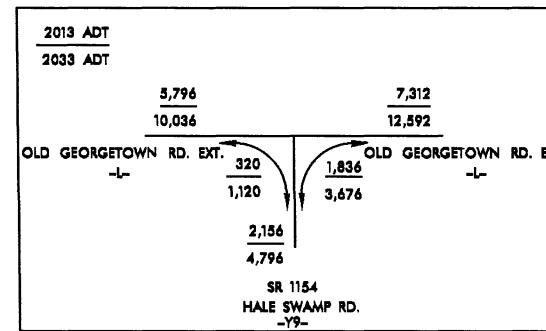

**SHEFFIELD SEAFOOD & GROCERY, INC.**  
DB 1503 PG 859  
MB R PG 90

NAD 83/NSRS 2007

**PRELIMINARY PLANS**  
**DO NOT USE FOR CONSTRUCTION**

Digitized by srujanika@gmail.com

THE PLANS WILL BE  
REVISED WHEN THE  
SUE DATA BECOME AVAILABLE

ROW REV:REVISING PUE ON PARCEL 17 AND 18. 5/14/12 TFD

16

18-MAY-2012 10:53

**MATCH LINE -L- STA 111 + 00.00 SEE SHEET NO. 10**

16  
PAULINE GRAHAM  
DB T51PG 649  
MB R PG 30

PROP. O/H POWER L1

19  
MICHAEL E. W.  
DR. ZELDOS, G.

±04

75' LT  
Sta. 124+36.

DB 704 PG  
MC IPG

2

PROJECT REFERENCE NO.	SHEET NO.
R-3432	12
ROW SHEET NO.	
ROADWAY DESIGN ENGINEER	HYDRAULICS ENGINEER
PRELIMINARY PLANS DO NOT USE FOR CONSTRUCTION	

NAD 83/NSRS 2007

Utility Permit Drawing

Sheet 5 of 10


MATCH LINE -L- STA. 125 + 00.00 SEE SHEET NO. 11


ROW REV: REVISING PUE ON PARCEL 18 AND 21 THRU 25 5/14/12 TFD

g

E:\UTILITIES\RC\U\PRJ\3432\rdl-NEU.pst\12.dwg

8/17/99

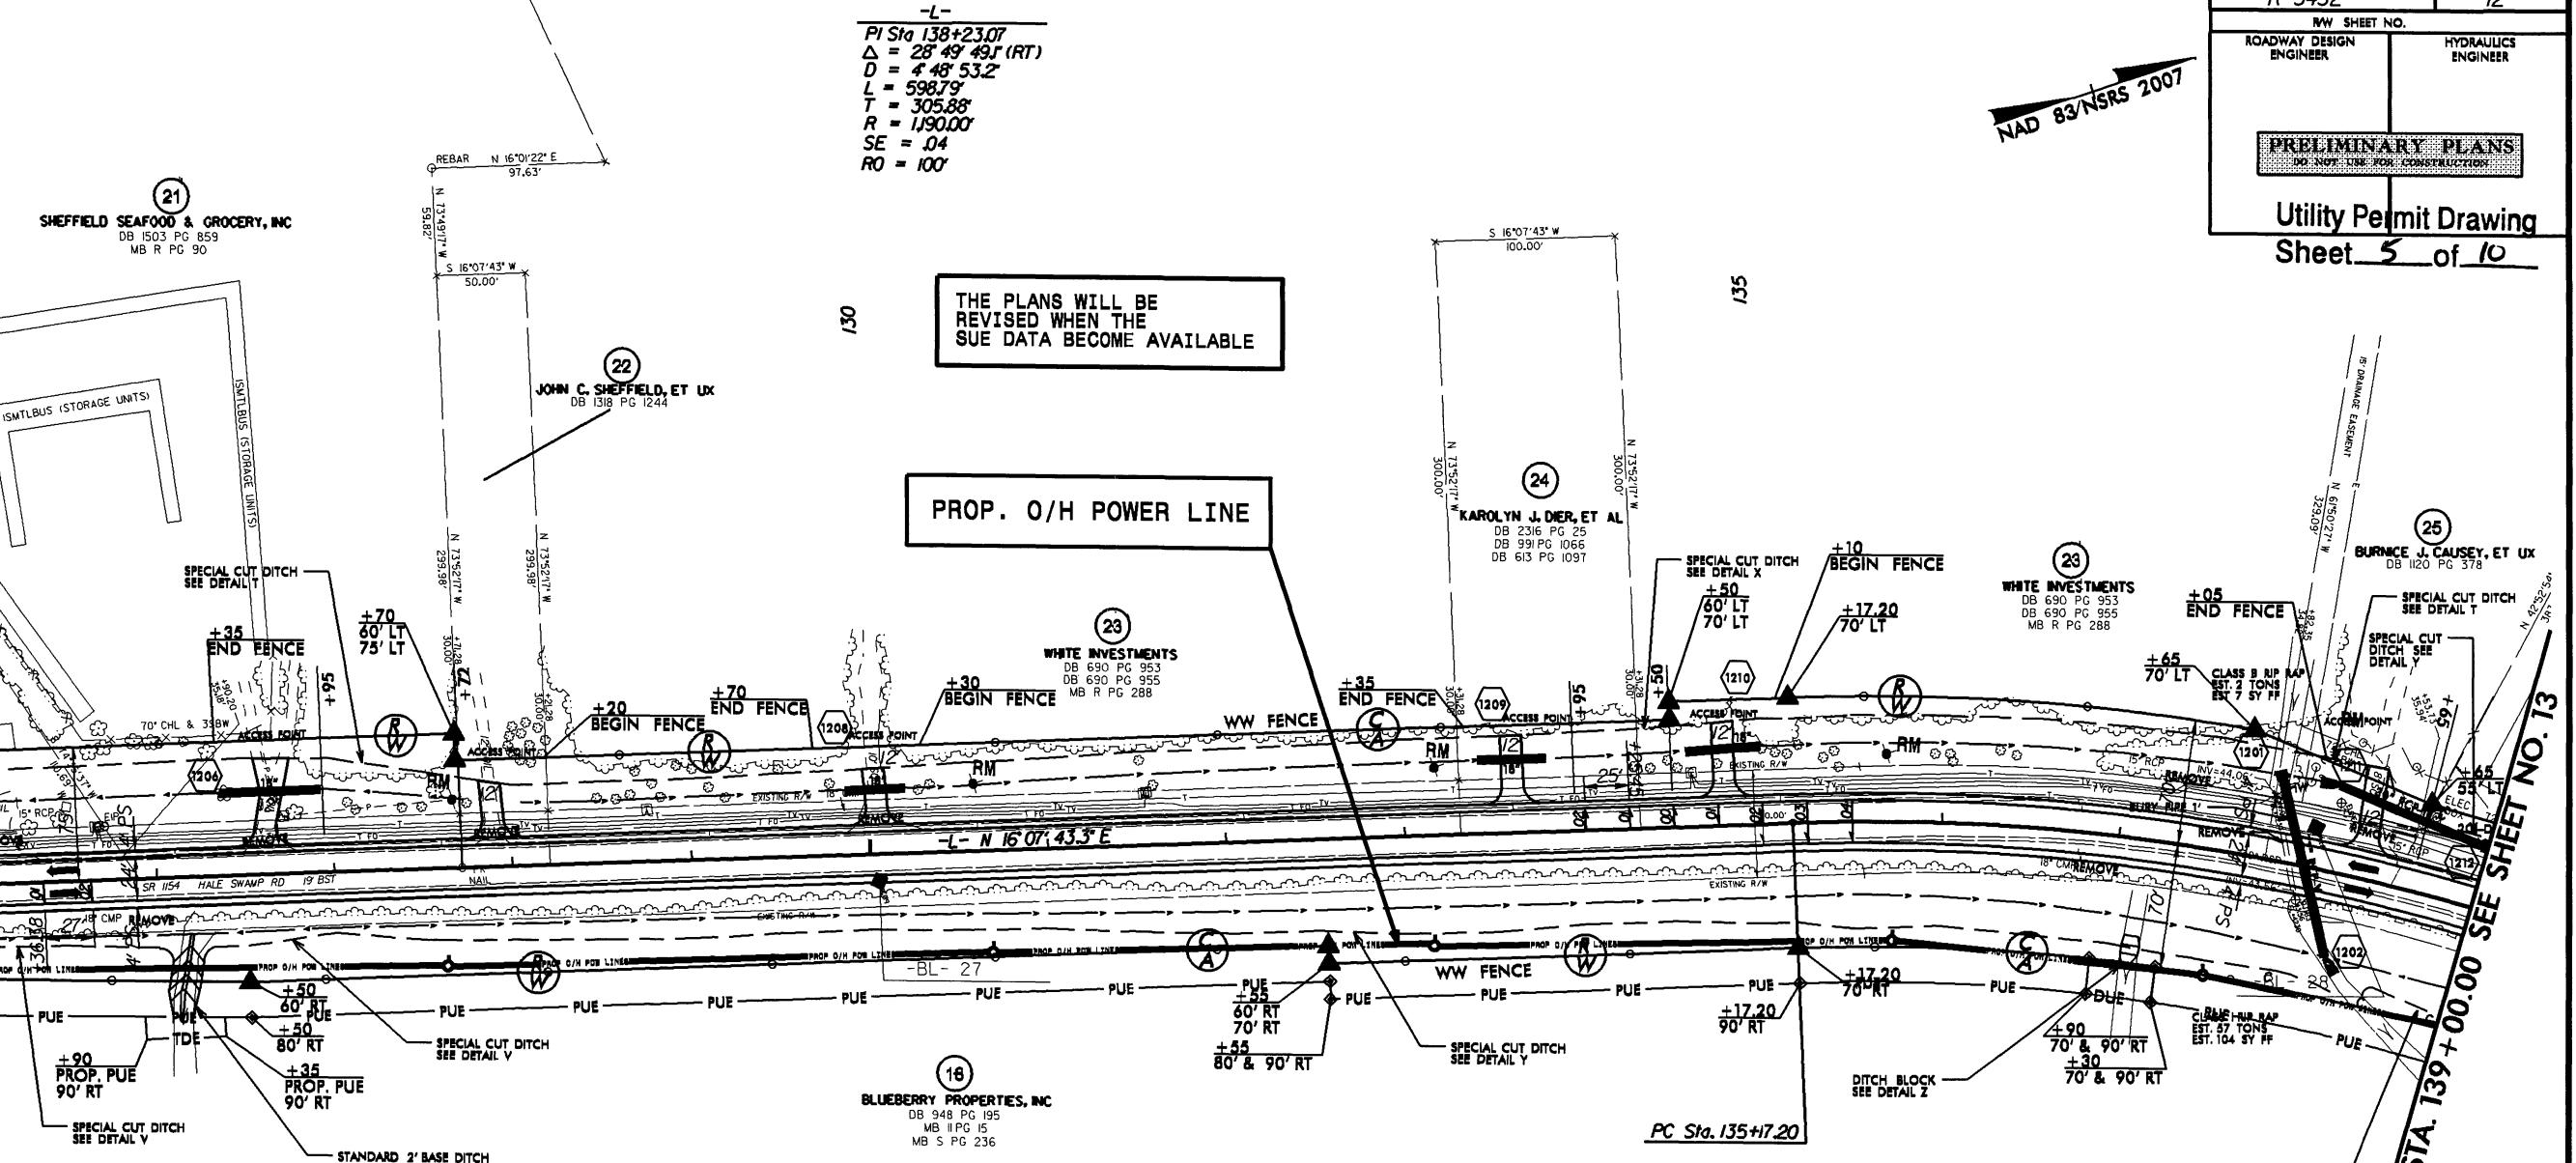


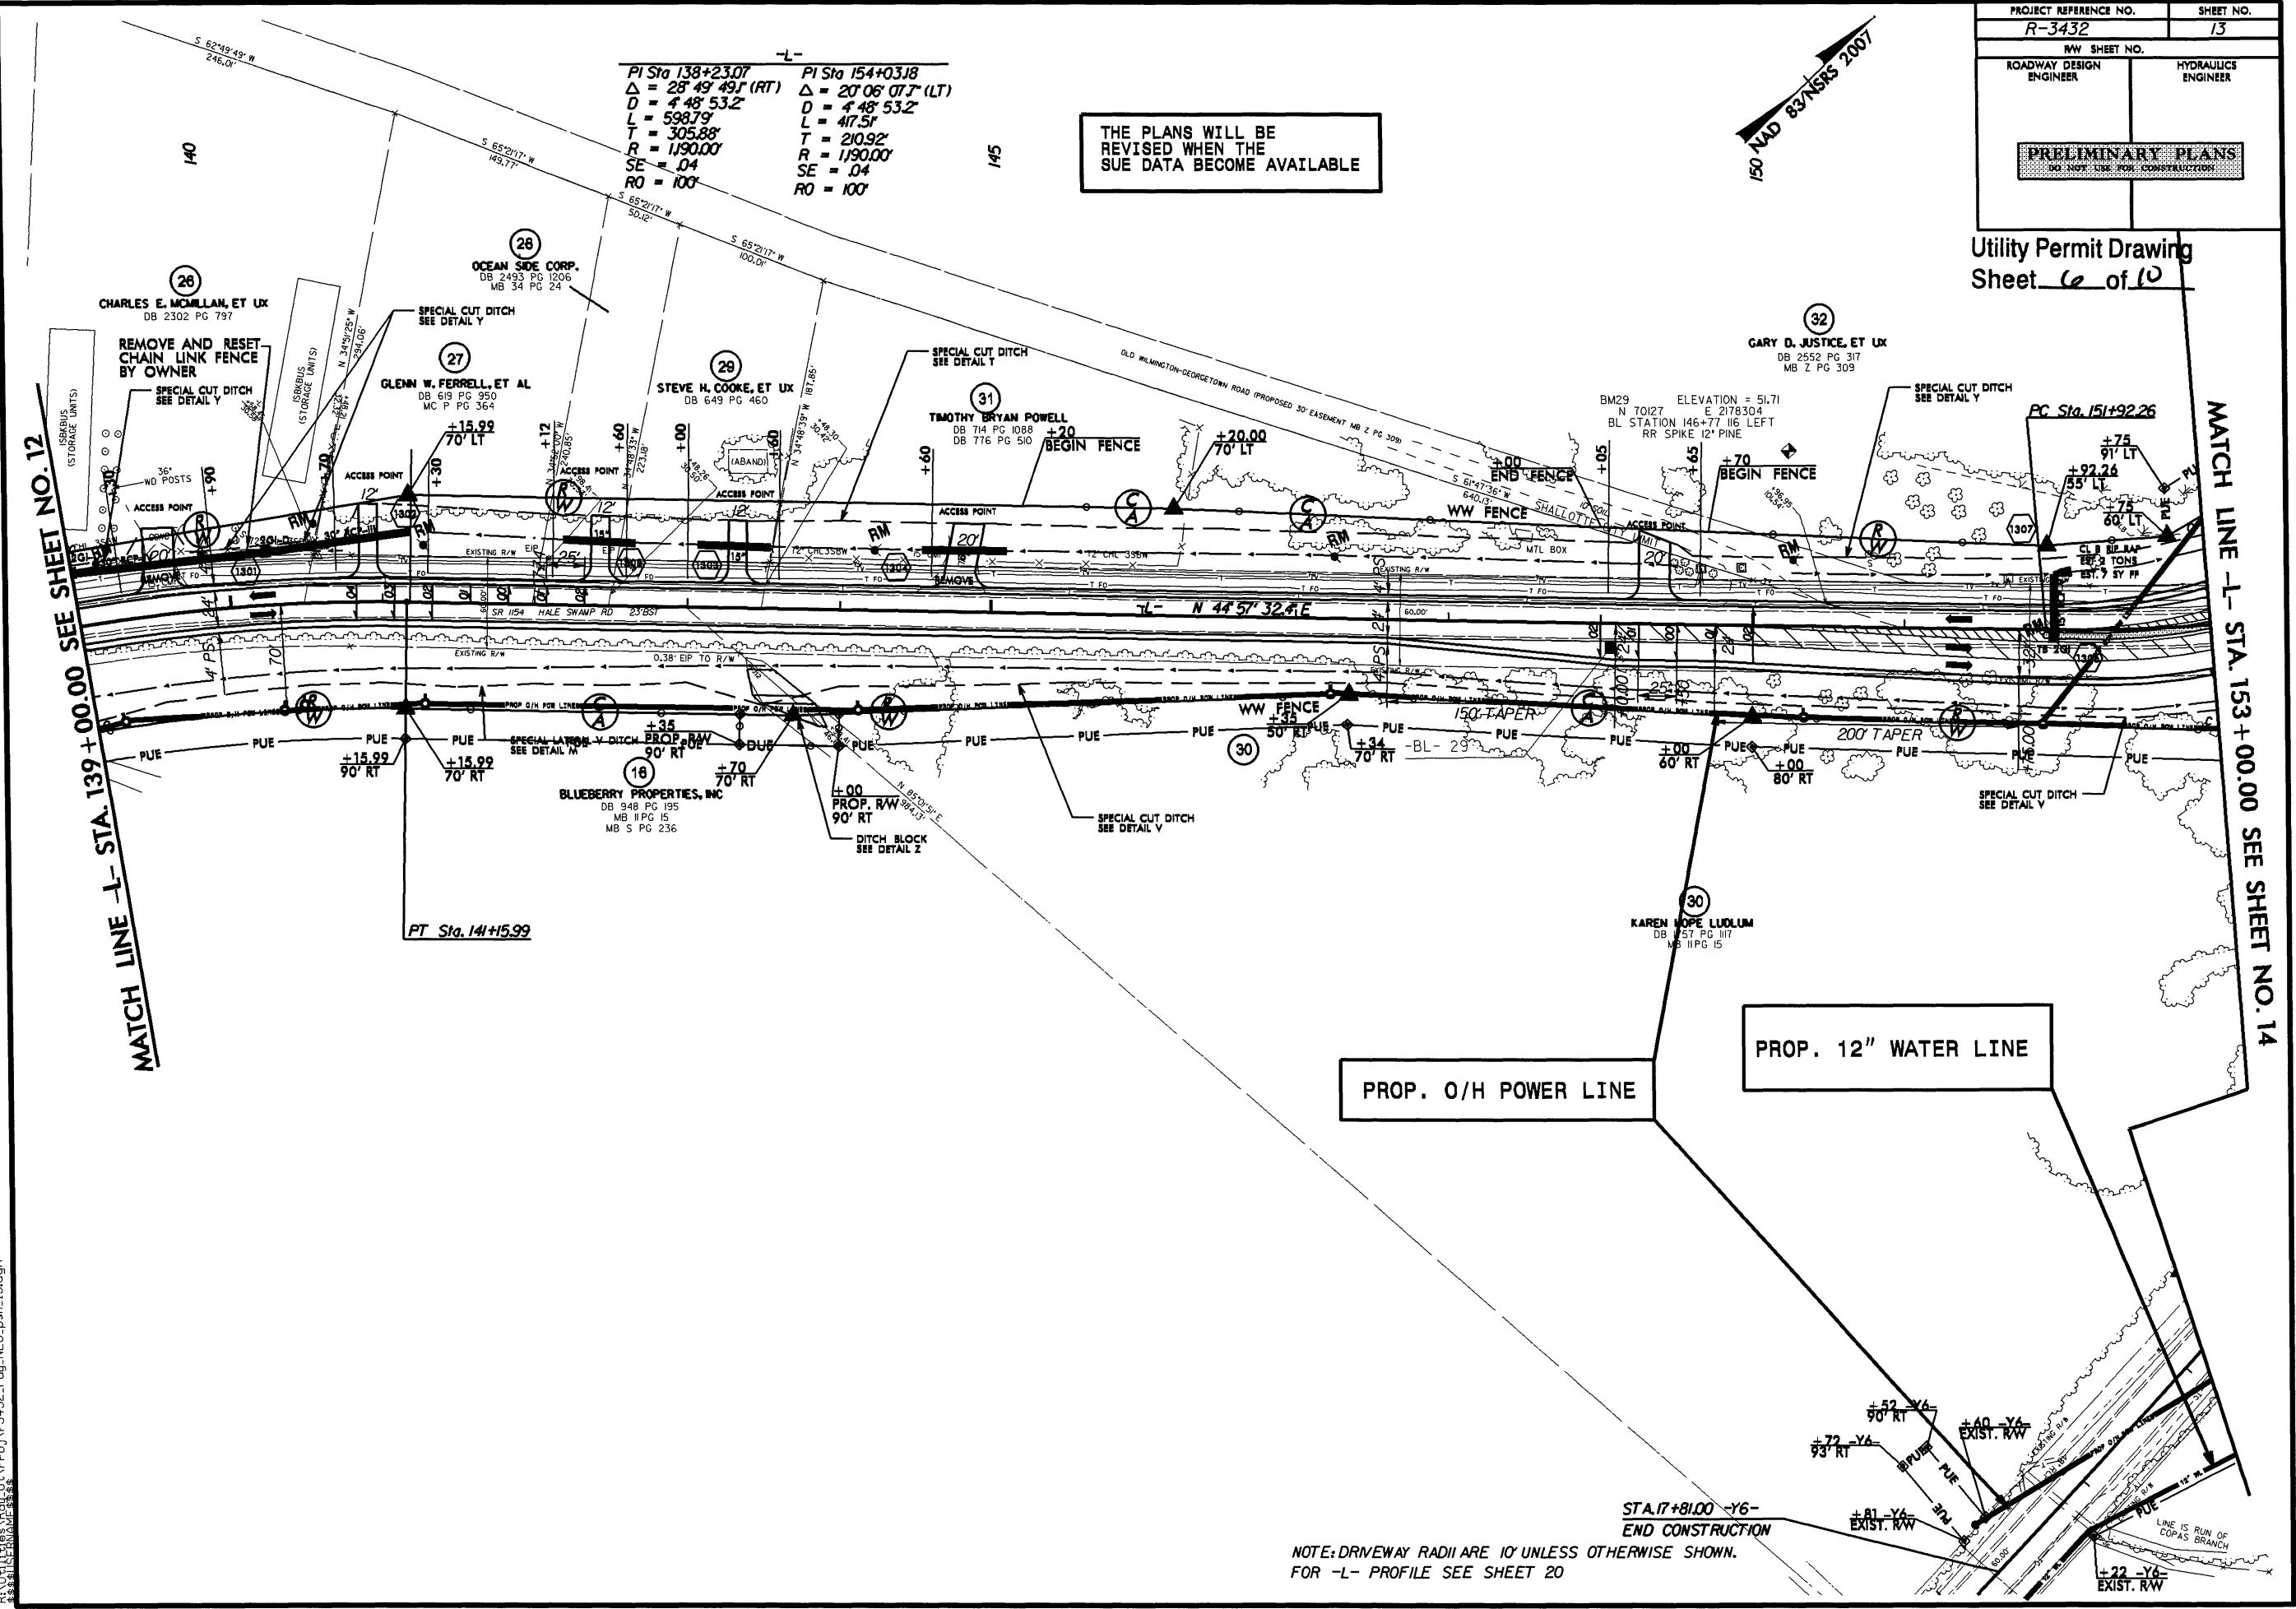

ROW REV: REVISING ROW ON PARCEL 18 AND 26 / HRR 3Z. 3/14/12 /FD

8-MAY-2012 10:58 |||t\Pro |||t\r3432-rdu-NEU-Psh-13,dqn

8/17/99

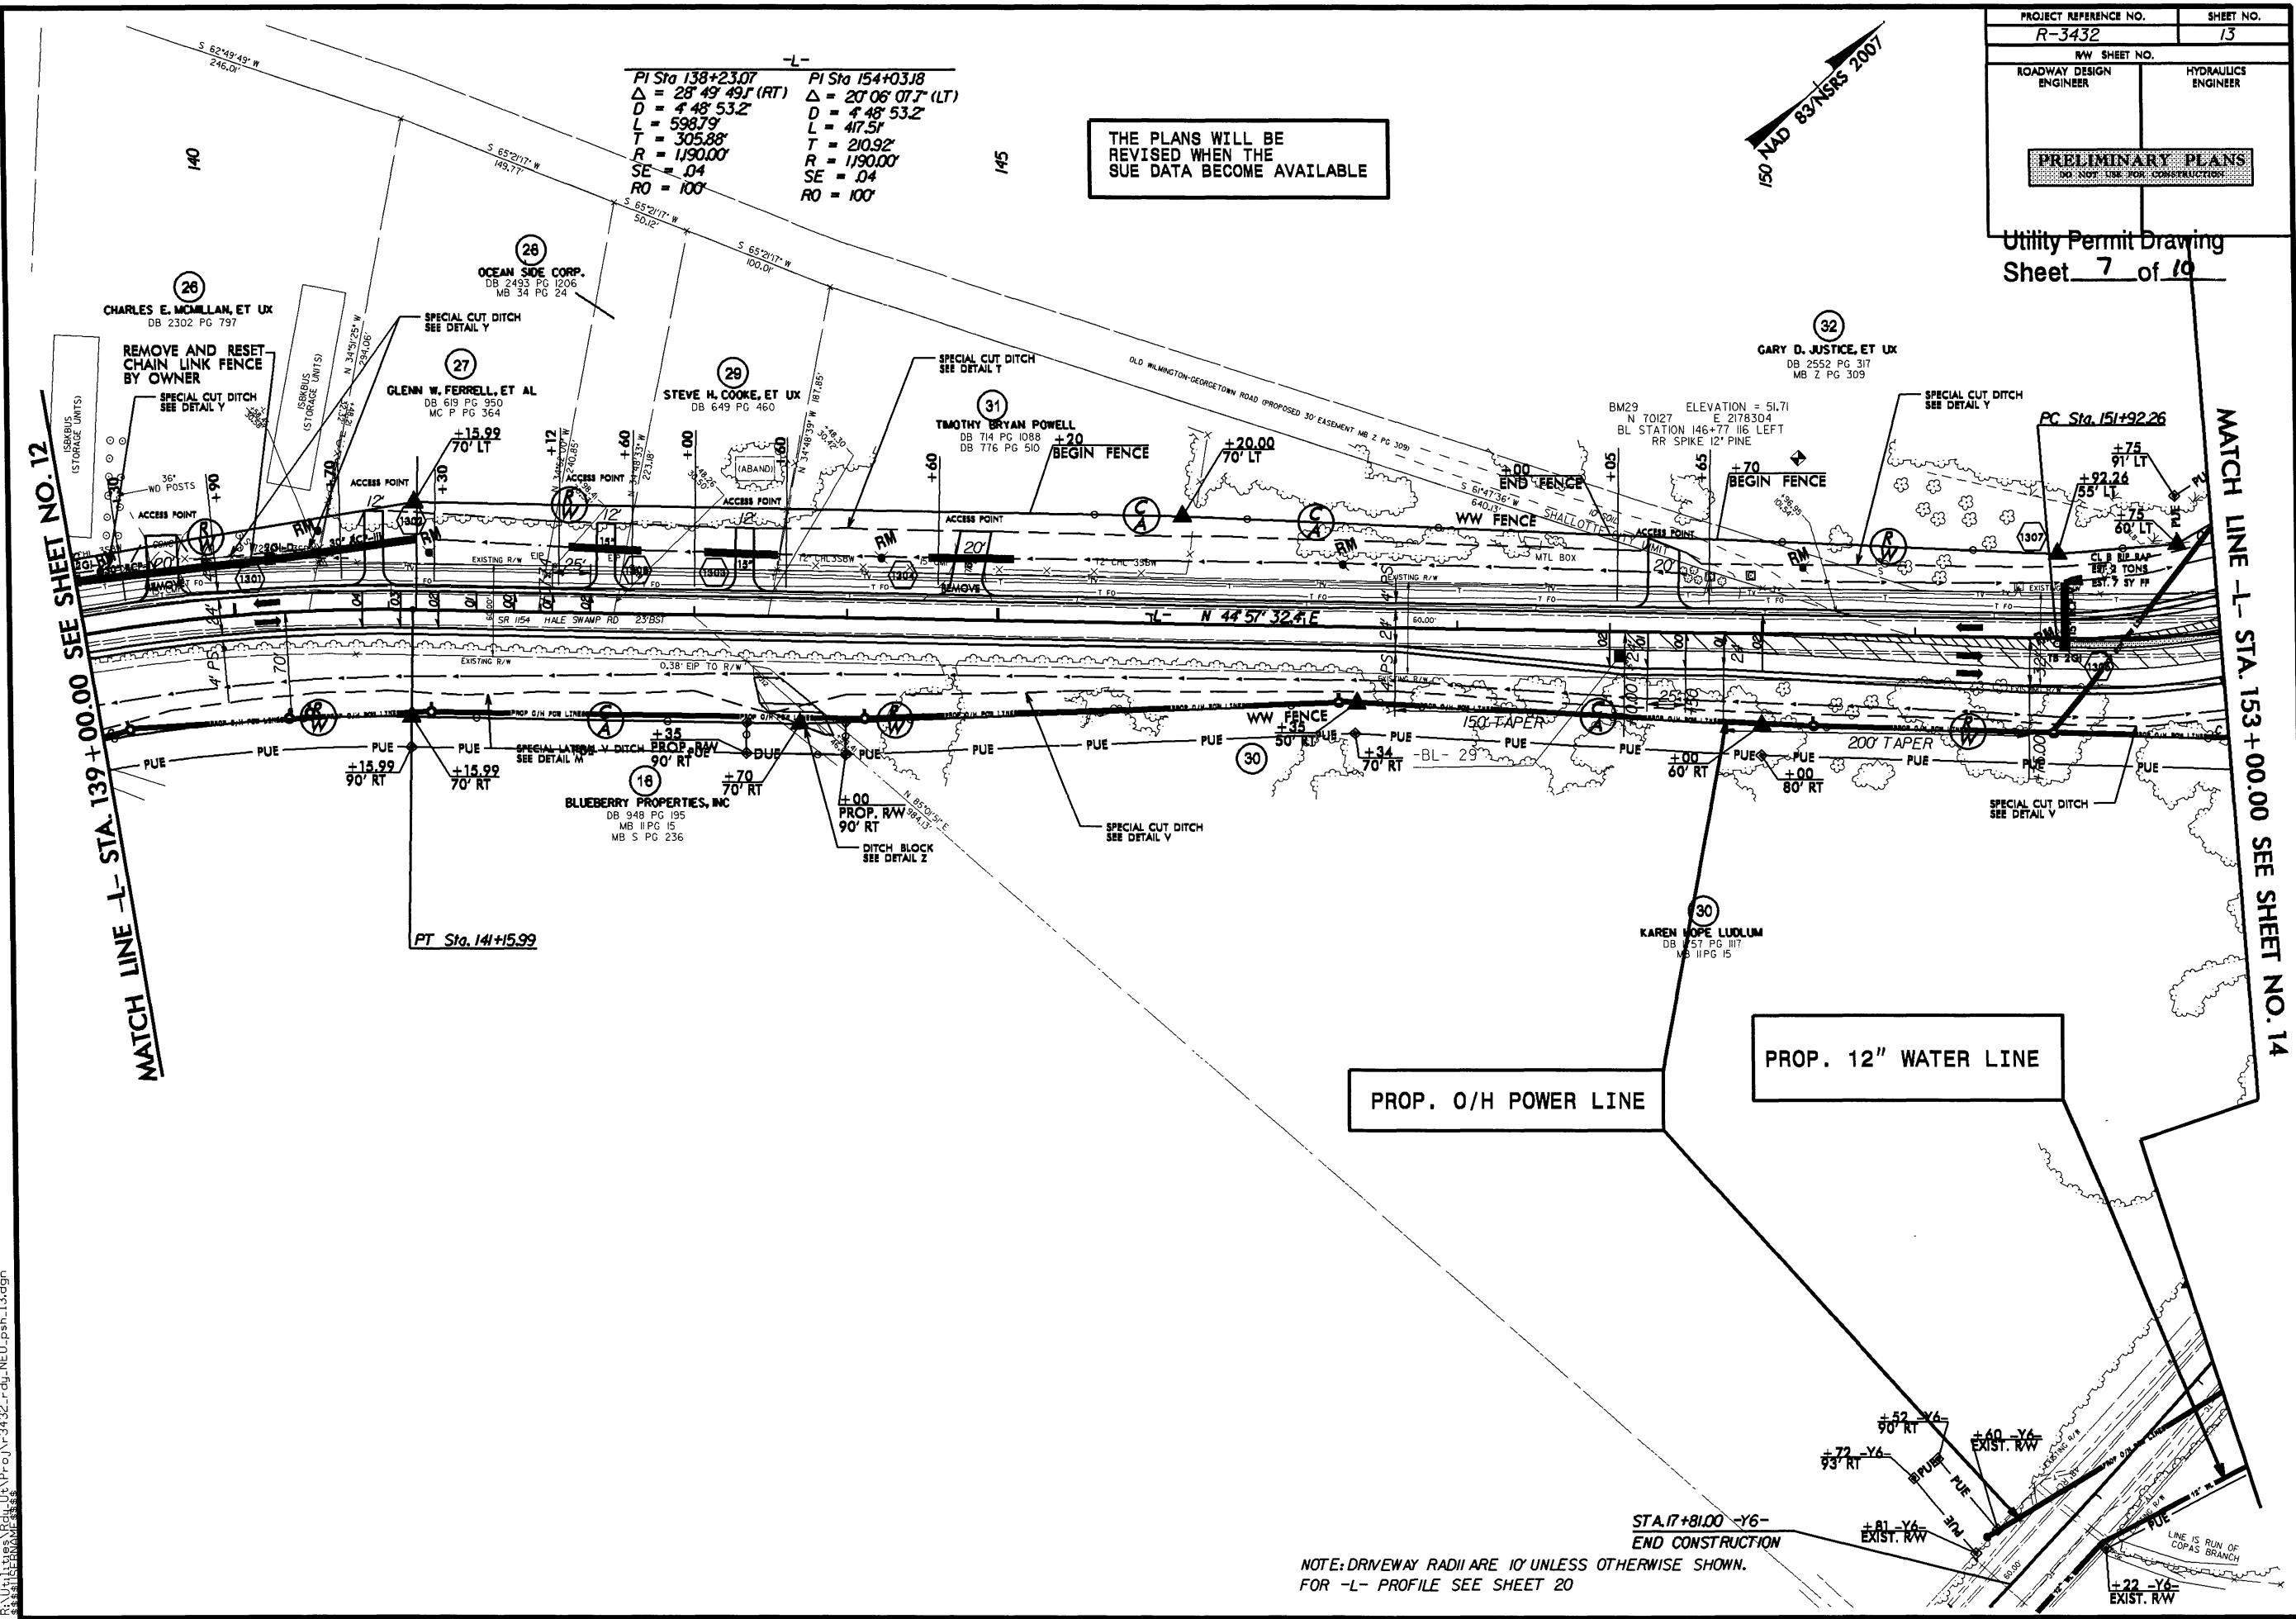

REVISIONS

R/W REV: REVISING PUE ON PARCEL 30. 5/14/12 TFD

8/17/99

-L-

PI Sta 154+03J8	PI Sta 158+7207	PI Sta 161+8725
△ = 20° 06' 07.7" (LT)	△ = 12° 48' 53.2" (LT)	△ = 17° 34' 37.6" (RT)
D = 4' 48" 53.2"	D = 4' 48" 53.2"	D = 15' 26" 37.0"
L = 47.5'	L = 263.49'	L = 366.30'
T = 210.92'	T = 132.29'	T = 183.98'
R = 1,190.00'	R = 1,190.00'	R = 1,190.00'
SE = .04	SE = .04	SE = SEE PLANS
RO = 100'	RO = 100'	RO = SEE PLANS

-Y6-

PI Sta 12+23.87	PI Sta 12+35.11
△ = 56° 34' 11.9" (RT)	△ = 56° 34' 11.9" (RT)
D = 15' 26" 37.0"	D = 15' 26" 37.0"
L = 366.30'	L = 366.30'
T = 199.64'	T = 199.64'
R = 371.00'	R = 371.00'
SE = .04	SE = .04
RO = 76'	RO = 76'

MATCH LINE -L- STA 153+00.00 SEE SHEET NO. 13


THE PLANS WILL BE  
REVISED WHEN THE  
SUE DATA BECOME AVAILABLE

## PROP. O/H POWER LINE

PROJECT REFERENCE NO.		SHEET NO.
R-3432		14
RW SHEET NO.		
ROADWAY DESIGN ENGINEER	HYDRAULICS ENGINEER	
PRELIMINARY PLANS		

Utility Permit Drawing  
Sheet 8 of 10

R-3432

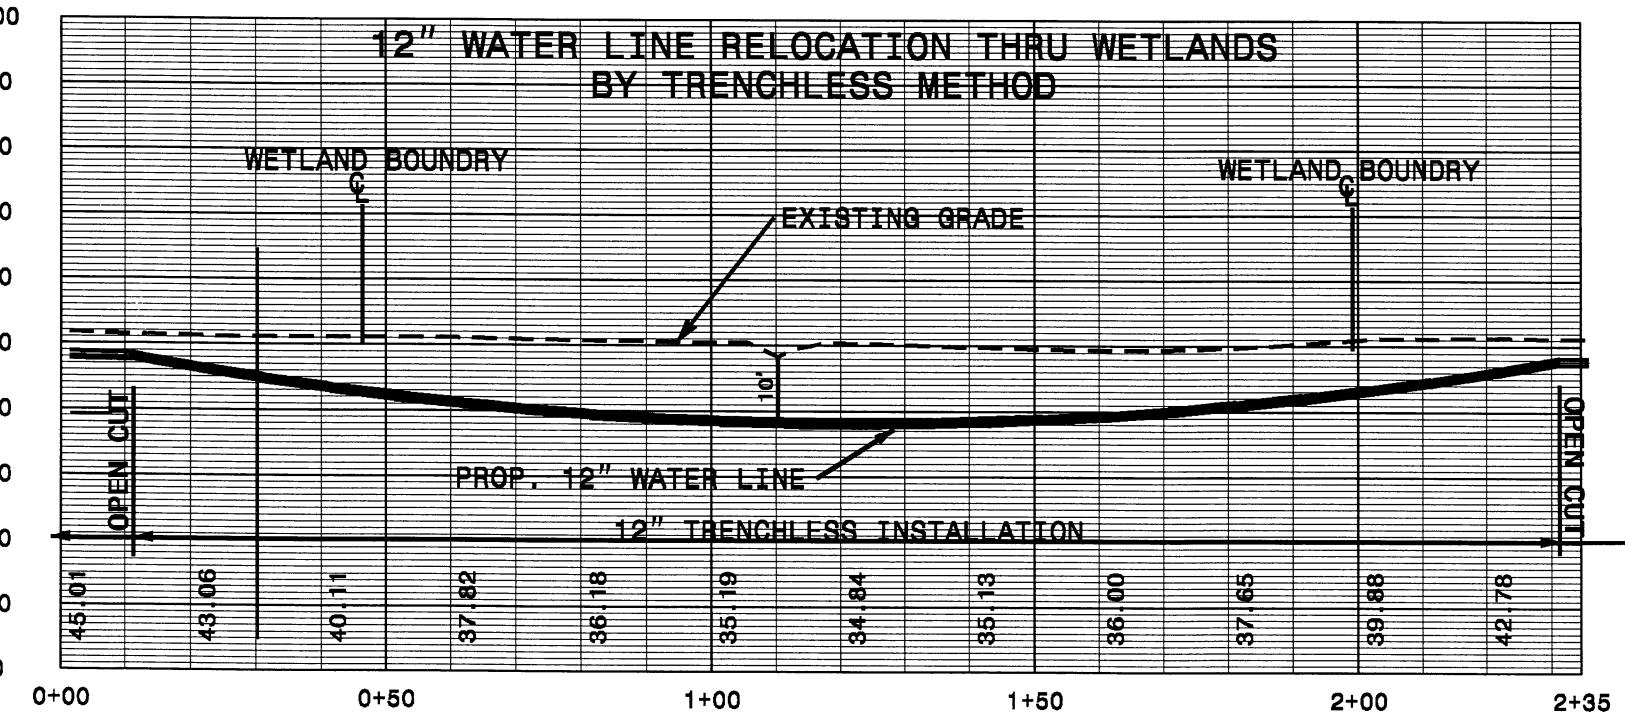

B-MAY-2012 I:\59\Ut\Proj\R-3432.rdy.NEU.Psh\14.gn

-Y10-  
 PI Sta 3I+16JL  
 $\Delta = 7^{\circ}55'47''$  (LT)  
 $D = 1^{\circ}47'25.8''$   
 $L = 43^{\circ}09.07'$   
 $T = 219.88'$   
 $R = 3,200.00'$   
 $SE = .03$   
 $RO = 8'$


NAD 83/NSRS 2007

PROJECT REFERENCE NO.	SHEET NO.
R-3432	15
RW SHEET NO.	
ROADWAY DESIGN ENGINEER	HYDRAULICS ENGINEER
<b>PRELIMINARY PLANS</b> <small>DO NOT USE FOR CONSTRUCTION</small>	

Utility Permit Drawing  
Sheet 9 of 10

THE PLANS WILL BE  
REVISED WHEN THE  
SUE DATA BECOME AVAILABLE

MATCH LINE -Y10- STA. 28+00 SEE SHEET NO. 4

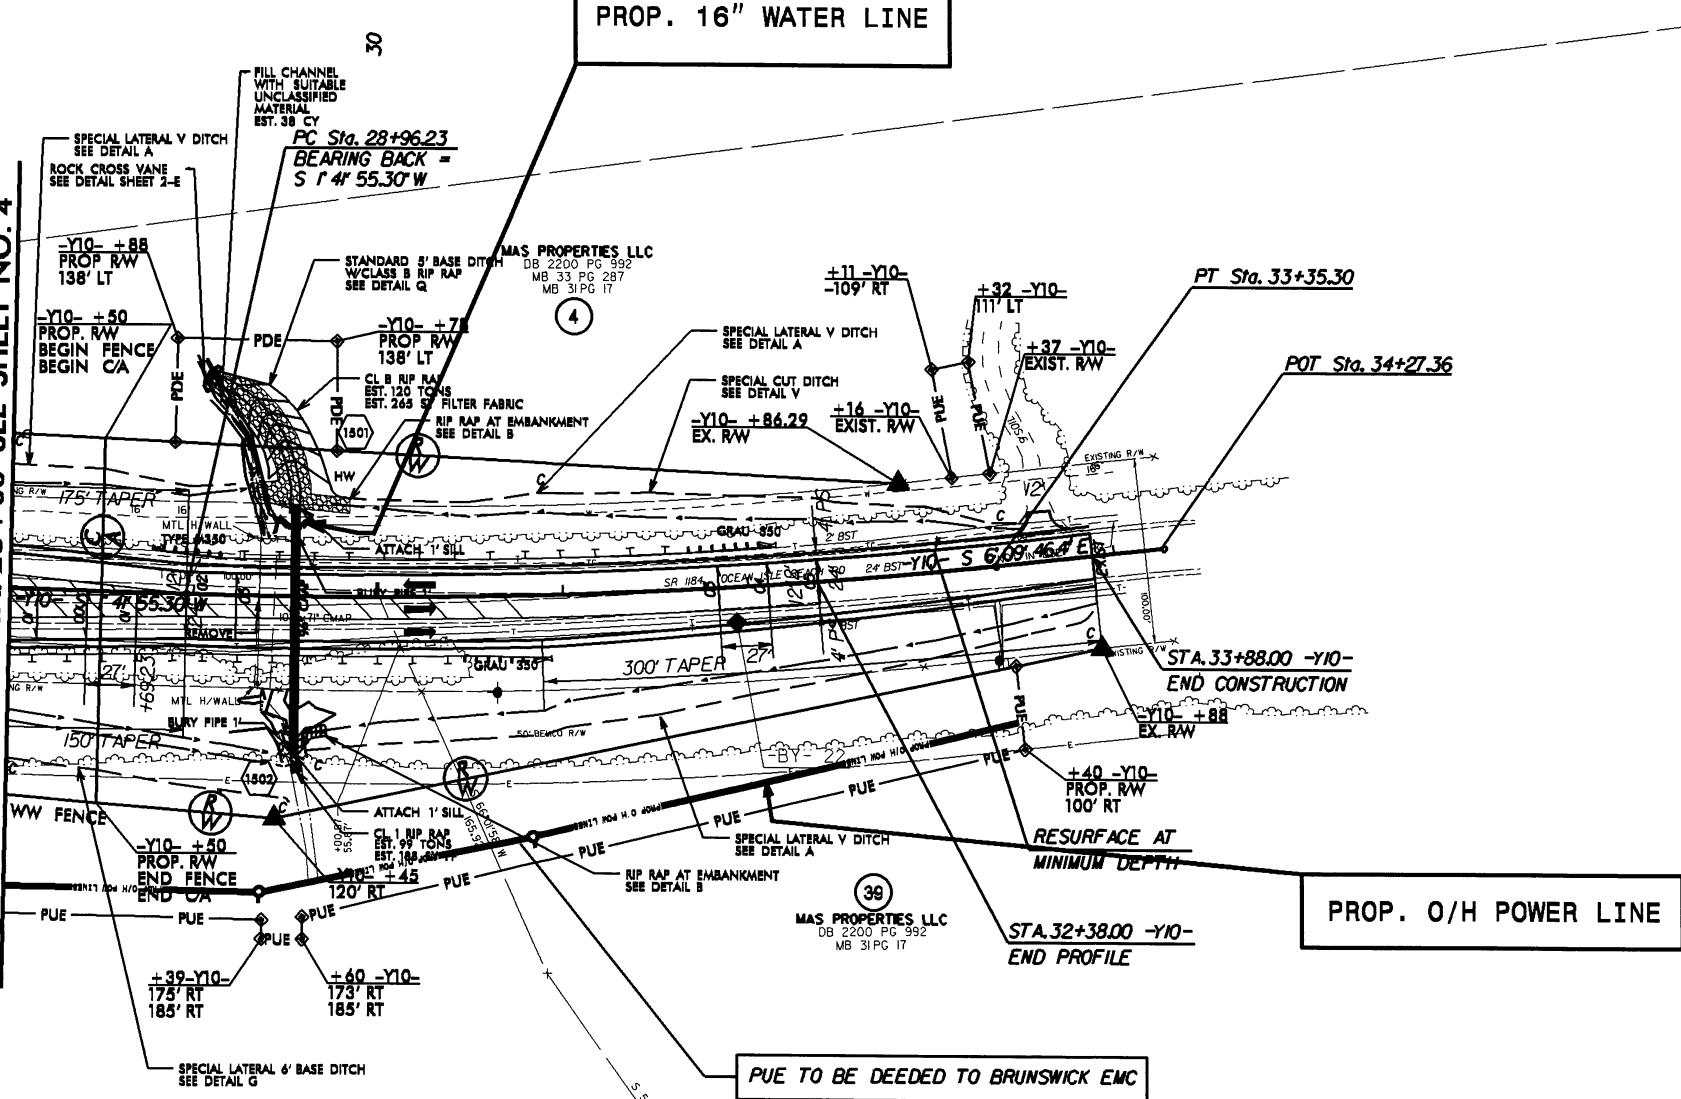

8-MAY-2012 11:04  
R:\UT\11\TEST\NEU\_PSH-15.dgn


PROJECT REFERENCE NO.		SHEET NO.
R-3432		15A
RW SHEET NO.		
ROADWAY DESIGN ENGINEER	HYDRAULICS ENGINEER	
		PRELIMINARY PLANS

Utility Permit Drawing  
Sheet 10 of 10

8/17/99

THE PLANS WILL BE  
REVISED WHEN THE  
SUE DATA BECOME AVAILABLE

REVISIONS

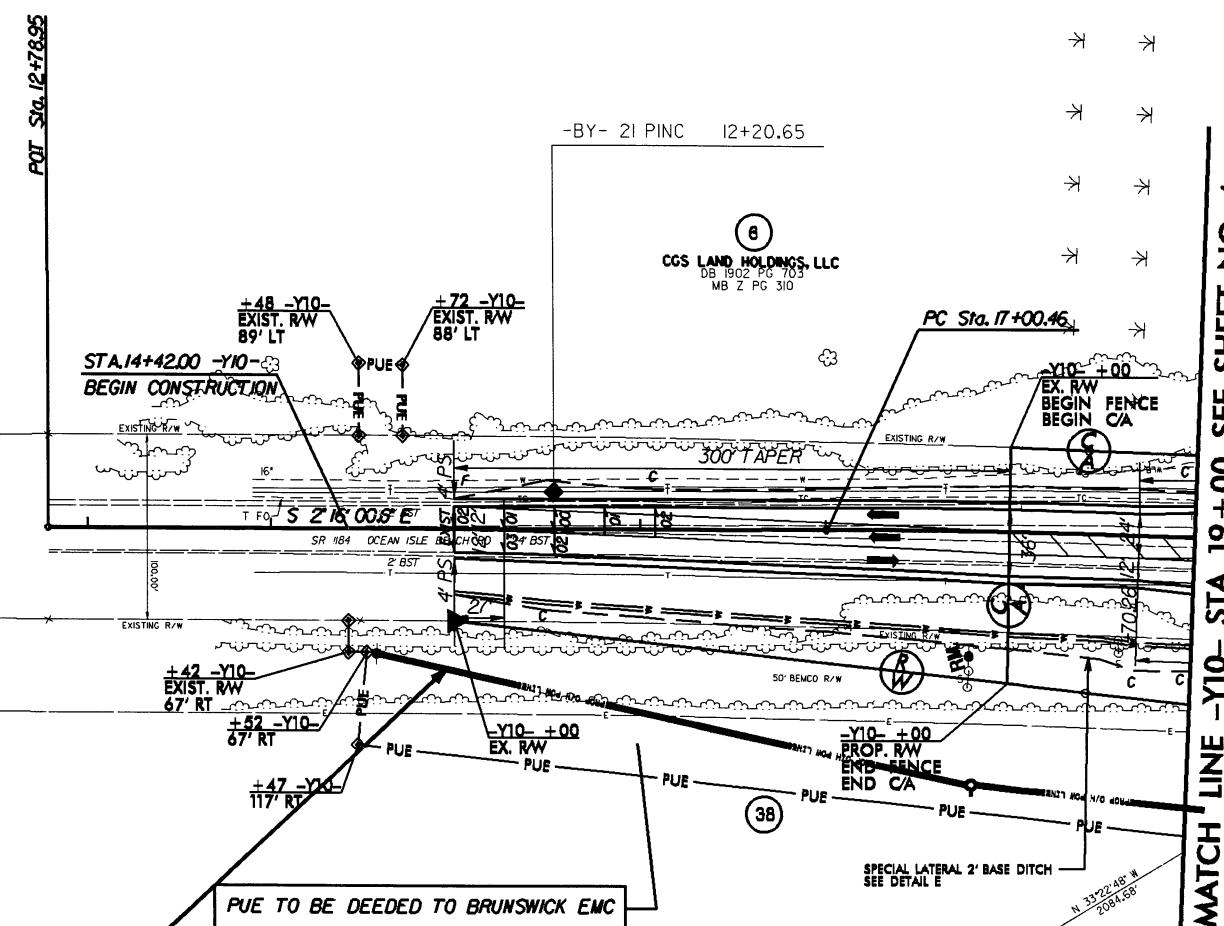


R-3432\_Ut\_Proj\Proj\Ut\_Proj\Proj\NED\NED.dgn

FOR -Y10- PROFILE SEE SHEET 21A

## **CONTRACT:**

**TIP PROJECT: R-3432**

*See Sheet 1-A For Index of Sheets  
See Sheet 1-B For Conventional symbols*

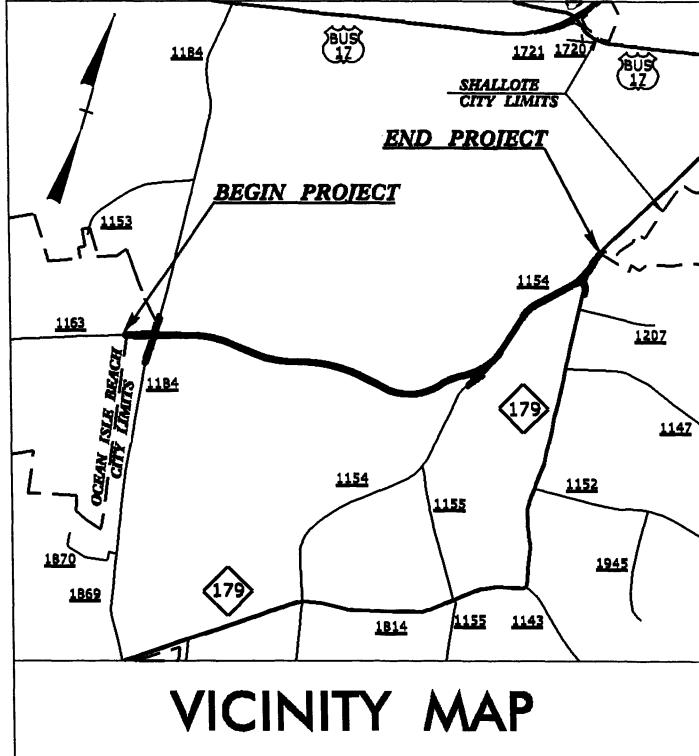


STATE OF NORTH CAROLINA  
DIVISION OF HIGHWAYS

# **BRUNSWICK COUNTY**

**LOCATION: SR 1163 (OLD GEORGETOWN ROAD EXTENSION) FROM SR 1184  
(OCEAN ISLE BEACH ROAD) TO NC 179**


**TYPE OF WORK: GRADING, DRAINAGE, AND PAVING**

STA. 164 +00.00 -L- END TIP PROJECT R-343

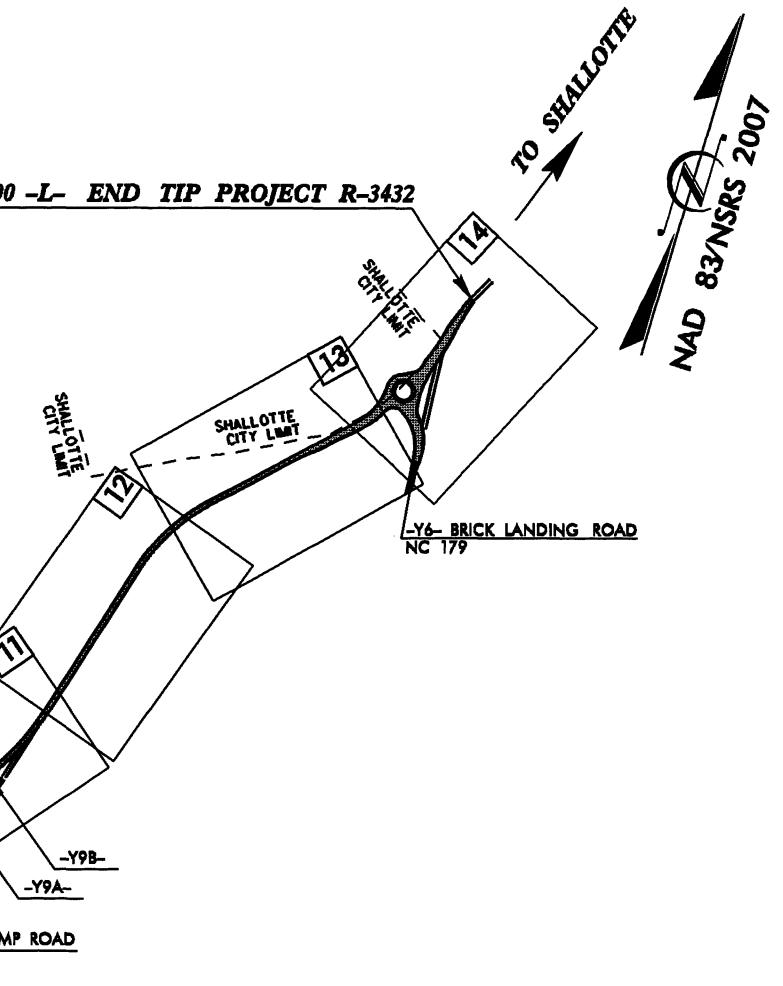

THIS IS A PARTIAL CONTROLLED-ACCESS PROJECT WITH ACCESS BEING LIMITED TO POINTS AS SHOWN ON THE PLANS.  
A PORTION OF THIS PROJECT IS WITHIN THE MUNICIPAL BOUNDARIES OF OCEAN ISLE BEACH AND SHALLOTTE.  
CLEARING ON THIS PROJECT SHALL BE PERFORMED TO THE LIMITS ESTABLISHED BY METHOD III.

**PRE-ELIMINARY PLEAS**  
DO NOT PREPARE CONFESSIONS

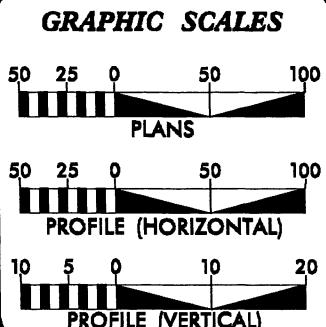

**DESIGN DATA**

ADT 2013 =	7,312
ADT 2033 =	12,592
DHV =	55 %
D ≈	13 %
T =	3 % *
V =	60 MPH
(TTST 1 % +	DUAL 2 %
UNC. CLASS. =	COLLECTOR
SUB-REGIONAL TIER	

**PROJECT LENGTH**

**LENGTH ROADWAY TIP PROJECT R-3432** = **2.859 MILES**  
**TOTAL LENGTH TIP PROJECT R-3432** = **2.859 MILES**

*Prepared In the Office of:*  
**DIVISION OF HIGHWAYS**  
1000 Birch Ridge Dr., Raleigh NC, 27610

2012 STANDARD SPECIFICATION

**RIGHT OF WAY DATE**

**LETTING DATE:**  
**JUNE 18, 2013**


## **HYDRAULICS ENGINEER**

**SIGNATURE:** \_\_\_\_\_

**ROADWAY DESIGN  
ENGINEER**

**P.E.**

**DIVISION OF HIGHWAYS  
STATE OF NORTH CAROLINA**

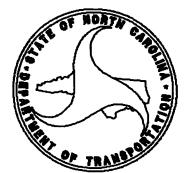

## **STATE HIGHWAY DESIGN ENGINEER**

**Note: Not to Scale****\*S.U.E. = Subsurface Utility Engineering**

**STATE OF NORTH CAROLINA  
DIVISION OF HIGHWAYS**

# **CONVENTIONAL PLAN SHEET SYMBOLS**

**BOUNDARIES AND PROPERTY:**

- State Line \_\_\_\_\_  
 County Line \_\_\_\_\_  
 Township Line \_\_\_\_\_  
 City Line \_\_\_\_\_  
 Reservation Line \_\_\_\_\_  
 Property Line \_\_\_\_\_  
 Existing Iron Pin   
 Property Corner \_\_\_\_\_  
 Property Monument   
 Parcel/Sequence Number   
 Existing Fence Line \_\_\_\_\_  
 Proposed Woven Wire Fence \_\_\_\_\_  
 Proposed Chain Link Fence \_\_\_\_\_  
 Proposed Barbed Wire Fence   
 Existing Wetland Boundary \_\_\_\_\_  
 Proposed Wetland Boundary \_\_\_\_\_  
 Existing Endangered Animal Boundary \_\_\_\_\_  
 Existing Endangered Plant Boundary \_\_\_\_\_  
 Known Soil Contamination: Area or Site   
 Potential Soil Contamination: Area or Site 


**BUILDINGS AND OTHER CULTURE:**

- Gas Pump Vent or UG Tank Cap   
 Sign   
 Well   
 Small Mine   
 Foundation   
 Area Outline   
 Cemetery   
 Building   
 School   
 Church   
 Dam \_\_\_\_\_

**HYDROLOGY:**

- Stream or Body of Water \_\_\_\_\_  
 Hydro, Pool or Reservoir \_\_\_\_\_  
 Jurisdictional Stream   
 Buffer Zone 1   
 Buffer Zone 2   
 Flow Arrow   
 Disappearing Stream   
 Spring   
 Wetland   
 Proposed Lateral, Tail, Head Ditch   
 False Sump 

**RAILROADS:**

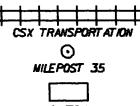- Standard Gauge \_\_\_\_\_  
 RR Signal Milepost   
 Switch \_\_\_\_\_  
 RR Abandoned \_\_\_\_\_  
 RR Dismantled \_\_\_\_\_

**RIGHT OF WAY:**

- Baseline Control Point   
 Existing Right of Way Marker   
 Existing Right of Way Line \_\_\_\_\_  
 Proposed Right of Way Line   
 Proposed Right of Way Line with Iron Pin and Cap Marker   
 Proposed Right of Way Line with Concrete or Granite Marker   
 Existing Control of Access   
 Proposed Control of Access   
 Existing Easement Line   
 Proposed Temporary Construction Easement   
 Proposed Temporary Drainage Easement   
 Proposed Permanent Drainage Easement   
 Proposed Permanent Drainage / Utility Easement   
 Proposed Permanent Utility Easement   
 Proposed Temporary Utility Easement   
 Proposed Aerial Utility Easement   
 Proposed Permanent Easement with Iron Pin and Cap Marker 

**ROADS AND RELATED FEATURES:**

- Existing Edge of Pavement \_\_\_\_\_  
 Existing Curb \_\_\_\_\_  
 Proposed Slope Stakes Cut   
 Proposed Slope Stakes Fill   
 Proposed Curb Ramp   
 Existing Metal Guardrail   
 Proposed Guardrail   
 Existing Cable Guiderrail   
 Proposed Cable Guiderrail   
 Equality Symbol   
 Pavement Removal 

**VEGETATION:**

- Single Tree   
 Single Shrub   
 Hedge   
 Woods Line 

- Orchard   
 Vineyard 

**EXISTING STRUCTURES:****MAJOR:**

- Bridge, Tunnel or Box Culvert   
 Bridge Wing Wall, Head Wall and End Wall   
**MINOR:**  
 Head and End Wall   
 Pipe Culvert \_\_\_\_\_  
 Footbridge   
 Drainage Box: Catch Basin, DI or JB   
 Paved Ditch Gutter \_\_\_\_\_  
 Storm Sewer Manhole   
 Storm Sewer \_\_\_\_\_

**UTILITIES:****POWER:**

- Existing Power Pole   
 Proposed Power Pole   
 Existing Joint Use Pole   
 Proposed Joint Use Pole   
 Power Manhole   
 Power Line Tower   
 Power Transformer   
 U/G Power Cable Hand Hole \_\_\_\_\_  
 H-Frame Pole   
 Recorded U/G Power Line \_\_\_\_\_  
 Designated U/G Power Line (S.U.E.\*). \_\_\_\_\_

**TELEPHONE:**

- Existing Telephone Pole   
 Proposed Telephone Pole   
 Telephone Manhole   
 Telephone Booth   
 Telephone Pedestal   
 Telephone Cell Tower   
 U/G Telephone Cable Hand Hole   
 Recorded U/G Telephone Cable \_\_\_\_\_  
 Designated U/G Telephone Cable (S.U.E.\*). \_\_\_\_\_  
 Recorded U/G Telephone Conduit \_\_\_\_\_  
 Designated U/G Telephone Conduit (S.U.E.\*). \_\_\_\_\_  
 Recorded U/G Fiber Optics Cable \_\_\_\_\_  
 Designated U/G Fiber Optics Cable (S.U.E.\*). \_\_\_\_\_  
 End of Information \_\_\_\_\_

**WATER:**

- Water Manhole \_\_\_\_\_   
 Water Meter \_\_\_\_\_   
 Water Valve \_\_\_\_\_   
 Water Hydrant \_\_\_\_\_   
 Recorded U/G Water Line \_\_\_\_\_  
 Designated U/G Water Line (S.U.E.\*). \_\_\_\_\_  
 Above Ground Water Line \_\_\_\_\_ 

**TV:**

- TV Satellite Dish   
 TV Pedestal   
 TV Tower   
 U/G TV Cable Hand Hole   
 Recorded U/G TV Cable \_\_\_\_\_   
 Designated U/G TV Cable (S.U.E.\*). \_\_\_\_\_  
 Recorded U/G Fiber Optic Cable \_\_\_\_\_   
 Designated U/G Fiber Optic Cable (S.U.E.\*). \_\_\_\_\_ 

**GAS:**

- Gas Valve   
 Gas Meter   
 Recorded U/G Gas Line \_\_\_\_\_  
 Designated U/G Gas Line (S.U.E.\*). \_\_\_\_\_  
 Above Ground Gas Line \_\_\_\_\_ 

**SANITARY SEWER:**


- Sanitary Sewer Manhole   
 Sanitary Sewer Cleanout   
 U/G Sanitary Sewer Line   
 Above Ground Sanitary Sewer \_\_\_\_\_   
 Recorded SS Forced Main Line \_\_\_\_\_   
 Designated SS Forced Main Line (S.U.E.\*). \_\_\_\_\_ 

**MISCELLANEOUS:**


- Utility Pole   
 Utility Pole with Base   
 Utility Located Object   
 Utility Traffic Signal Box   
 Utility Unknown U/G Line   
 U/G Tank; Water, Gas, Oil   
 Underground Storage Tank, Approx. Loc.   
 A/G Tank; Water, Gas, Oil   
 Geoenvironmental Boring   
 U/G Test Hole (S.U.E.\*). \_\_\_\_\_   
 Abandoned According to Utility Records \_\_\_\_\_   
 End of Information \_\_\_\_\_ 

PAVEMENT SCHEDULE (PRELIMINARY PAVEMENT DESIGN)	
A	PROP. 7" CONCRETE TRUCK APRON WITH 4X4 W3.5XW3.5 WIRE MESH
C1	PROP. APPROX. 3" ASPHALT CONCRETE SURFACE COURSE, TYPE SD.5B, AT AN AVERAGE RATE OF 168 LBS. PER SQ. YD. IN EACH OF TWO LAYERS.
C2	PROP. VAR. DEPTH ASPHALT CONCRETE SURFACE COURSE, TYPE SD.5B, AT AN AVERAGE RATE OF 112 LBS. PER SQ. YD. PER 1" DEPTH. TO BE PLACED IN LAYERS NOT TO EXCEED 2" IN DEPTH.
D1	PROP. APPROX. 2.5" ASPHALT CONCRETE INTERMEDIATE COURSE, TYPE I19.0B, AT AN AVERAGE RATE OF 285 LBS. PER SQ. YD.
D2	PROP. VAR. DEPTH ASPHALT CONCRETE INTERMEDIATE COURSE, TYPE I19.0B, AT AN AVERAGE RATE OF 114 LBS. PER SQ. YD. PER 1" DEPTH, TO BE PLACED IN LAYERS NOT LESS THAN 2.5" IN DEPTH OR GREATER THAN 4" IN DEPTH.
E1	PROP. APPROX. 4.0" ASPHALT CONCRETE BABE COURSE, TYPE B25.0B, AT AN AVERAGE RATE OF 456 LBS. PER SQ. YD.
E2	PROP. APPROX. 5.5" ASPHALT CONCRETE BABE COURSE, TYPE B25.0B, AT AN AVERAGE RATE OF 627 LBS. PER SQ. YD.
E3	PROP. VAR. DEPTH ASPHALT CONCRETE BASE COURSE, TYPE B25.0B, AT AN AVERAGE RATE OF 114 LBS. PER SQ. YD. PER 1" DEPTH. TO BE PLACED IN LAYERS NOT LESS THAN 3" IN DEPTH OR GREATER THAN 5½" IN DEPTH.
J1	PROP. 6" AGGREGATE BASE COURSE.
J2	PROP. 8" AGGREGATE BASE COURSE.
R1	1'-6" CONCRETE CURB AND GUTTER.
R2	8"x 18" CONCRETE CURB.
P	PRIME COAT AT THE RATE OF 0.35 GAL. PER SQ. YD.
T	EARTH MATERIAL.
U	EXISTING PAVEMENT.
W	VARIABLE DEPTH ASPHALT PAVEMENT (SEE STANDARD WEDGING DETAIL SHEET NO. 2 & 2A)


NOTE: PAVEMENT EDGE SLOPES ARE 1:1 UNLESS SHOWN OTHERWISE.

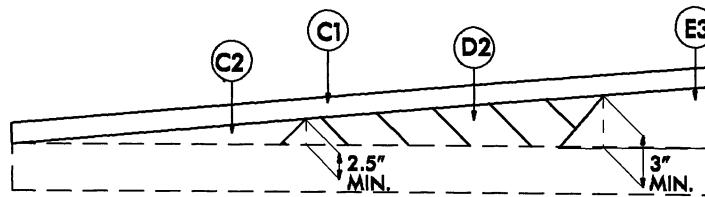

Wedging Detail For Resurfacing  
Use With Typical No. 1

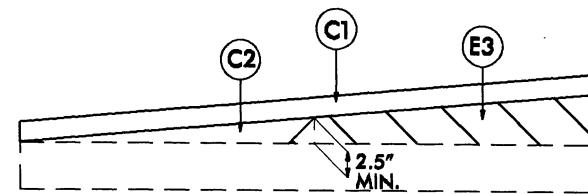


Wedging Detail For Resurfacing  
Use with Typical No. 3

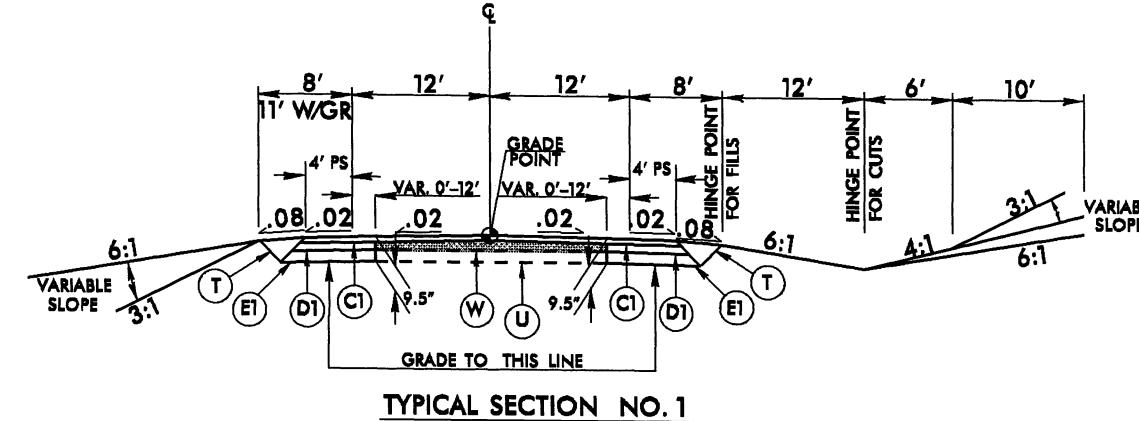


#### USE TYPICAL SECTION NO. 1

- L- STA. 13+07.00 TO -L- STA. 21+39.61
- L- STA. 121+67.33 TO -L- STA. 154+29.55
- L- STA. 156+35.60 TO -L- STA. 162+50.00
- Y10- STA. 15+00.00 TO -Y10- STA. 22+97.27
- Y10- STA. 25+03.26 TO -Y10- STA. 32+38.00

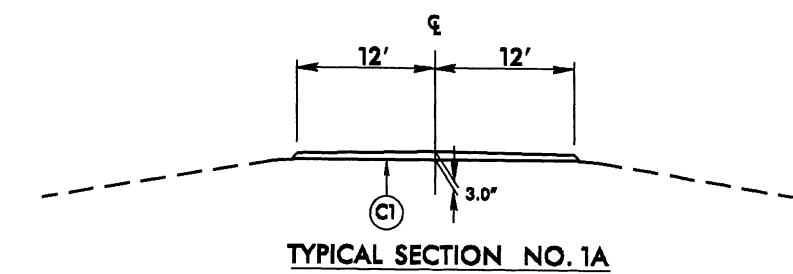


#### USE TYPICAL SECTION NO. 1A

- L- STA. 162+50.00 TO -L- STA. 164+00.00
- Y10- STA. 32+38.00 TO -Y10- STA. 33+88.00

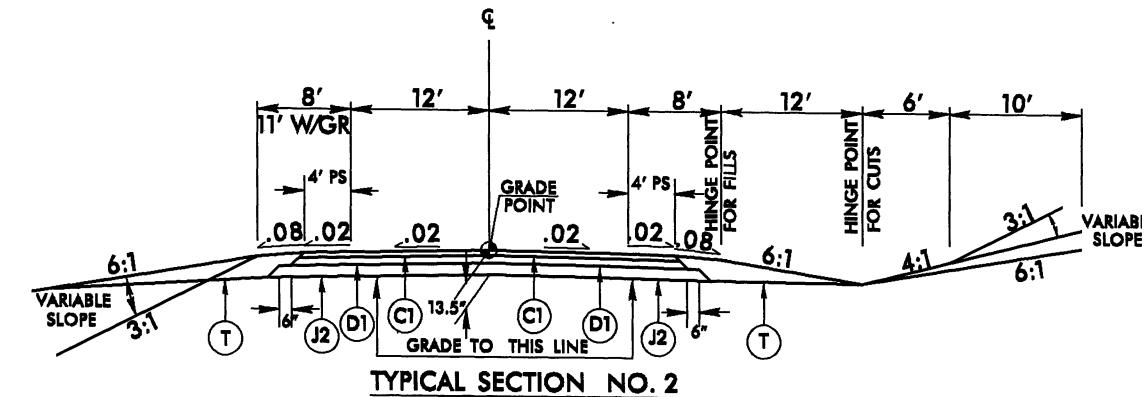

#### USE TYPICAL SECTION NO. 2

- L- STA. 23+45.61 TO -L- STA. 121+67.33

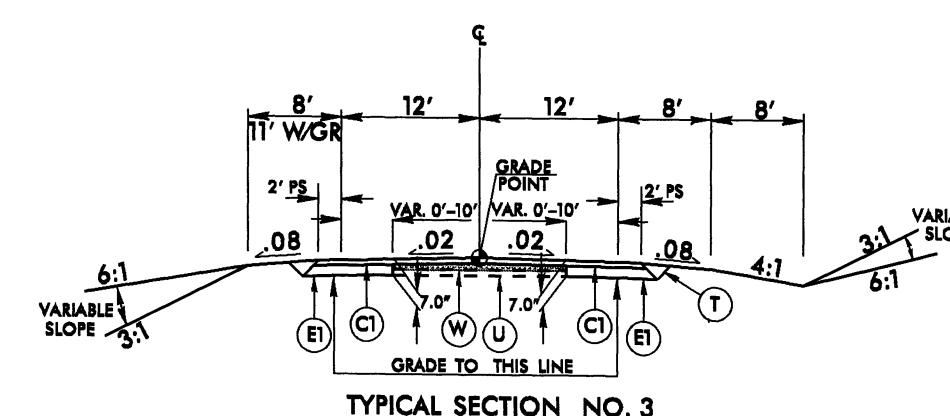


#### USE TYPICAL SECTION NO. 3

- Y9- STA. 10+20.00 TO -Y9- STA. 14+42.00

PROJECT REFERENCE NO.	SHEET NO.
R-3432	2
ROADWAY DESIGN ENGINEER	PAVEMENT DESIGN ENGINEER
PRELIMINARY PLANS	

PROJECT REFERENCE NO.		SHEET NO.
R-3432		2-A
ROADWAY DESIGN ENGINEER	PAVEMENT DESIGN ENGINEER	
PRELIMINARY PLANS DO NOT USE FOR CONSTRUCTION		


PAVEMENT SCHEDULE (PRELIMINARY PAVEMENT DESIGN)	
C1	3" S9.5B
E1	4.0" B25.0B
E2	5.5" B25.0B
E3	VAR. B25.0B
J1	6" ABC
T	EARTH MATERIAL
U	EXIST. PAVEMENT
W	WEDGING

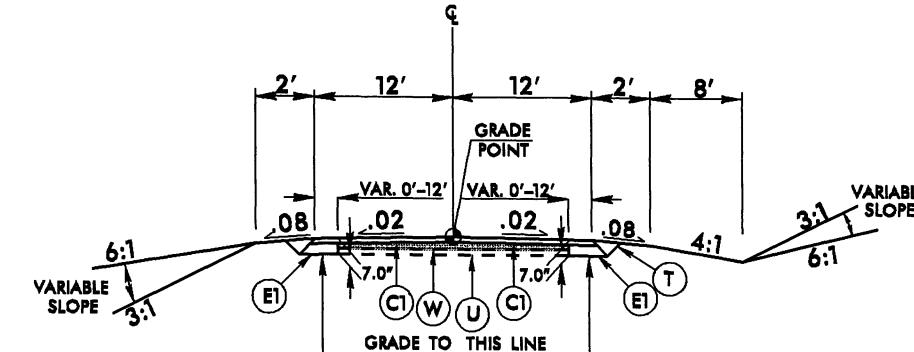

TYPICAL SECTION NO. 4


USE TYPICAL SECTION NO. 4

-Y9A- STA. 10+24.00 TO -Y9A- STA. 12+70.00

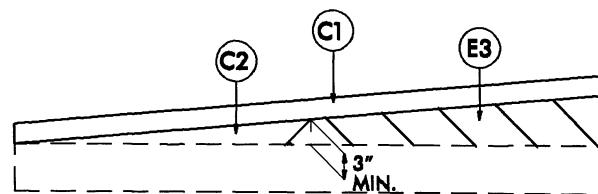

Wedging Detail For Resurfacing


Use with Typical No. 4 &amp; No. 5

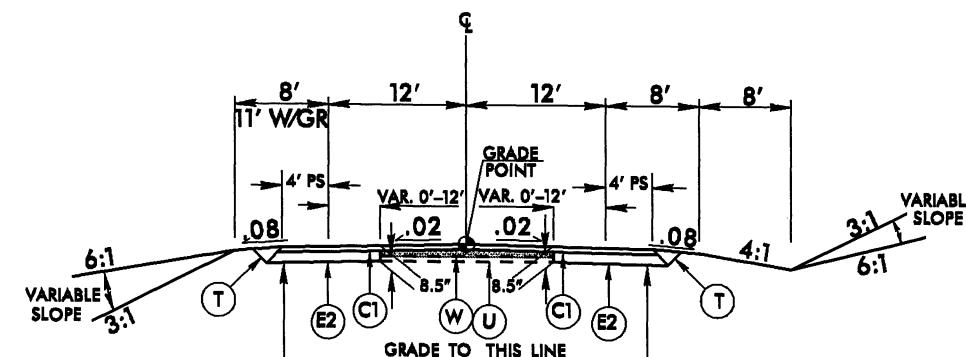

TYPICAL SECTION NO. 5

USE TYPICAL SECTION NO. 5

-Y6- STA. 10+97.24 TO -Y6- STA. 15+56.00

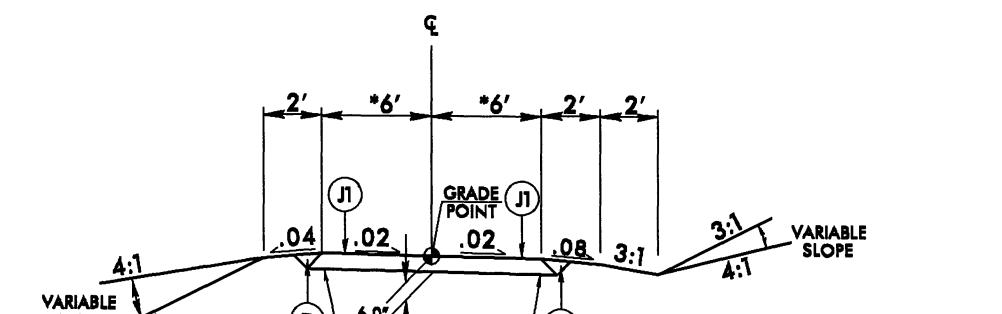

TYPICAL SECTION NO. 6

USE TYPICAL SECTION NO. 6


-DR1- STA. 10+00.00 TO -DR1- STA. 11+21.34

-DR2- STA. 10+16.04 TO -DR2- STA. 11+63.32

-Y9B- STA. 10+09.46 TO -Y9B- STA. 10+44.46


PROJECT REFERENCE NO.		SHEET NO.
R-3432		2-B
ROADWAY DESIGN ENGINEER	PAVEMENT DESIGN ENGINEER	
<b>PRELIMINARY PLANS</b>		
DO NOT USE FOR CONSTRUCTION		

PAVEMENT SCHEDULE (PRELIMINARY PAVEMENT DESIGN)	
A	7" CONCRETE W/4X4 W3.5XW3.5 WIRE MESH
C1	3" S9.5B
D1	2.5" I19.0B
E1	4" 25.0B
J2	8" ABC
P	PRIME COAT
T	EARTH MATERIAL
R1	1'-6" C & G
R2	8"x 18" CURB

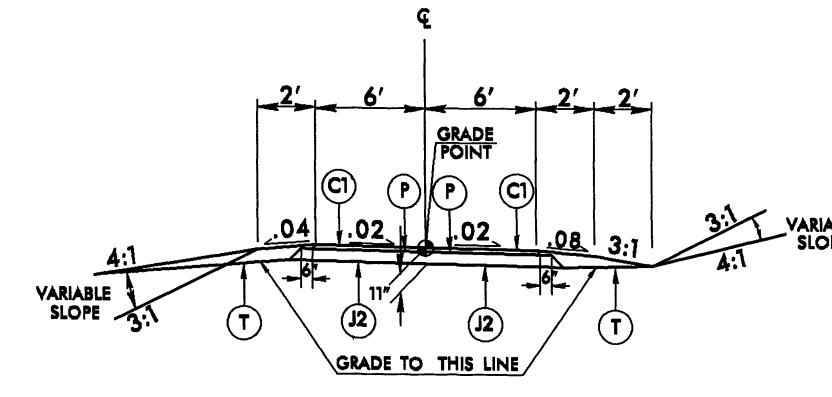


USE TYPICAL SECTION NO. 7

- DR6- STA. 10+00.00 TO -DR6- STA. 11+30.89
- DR7- STA. 10+16.00 TO -DR7- STA. 11+40.00

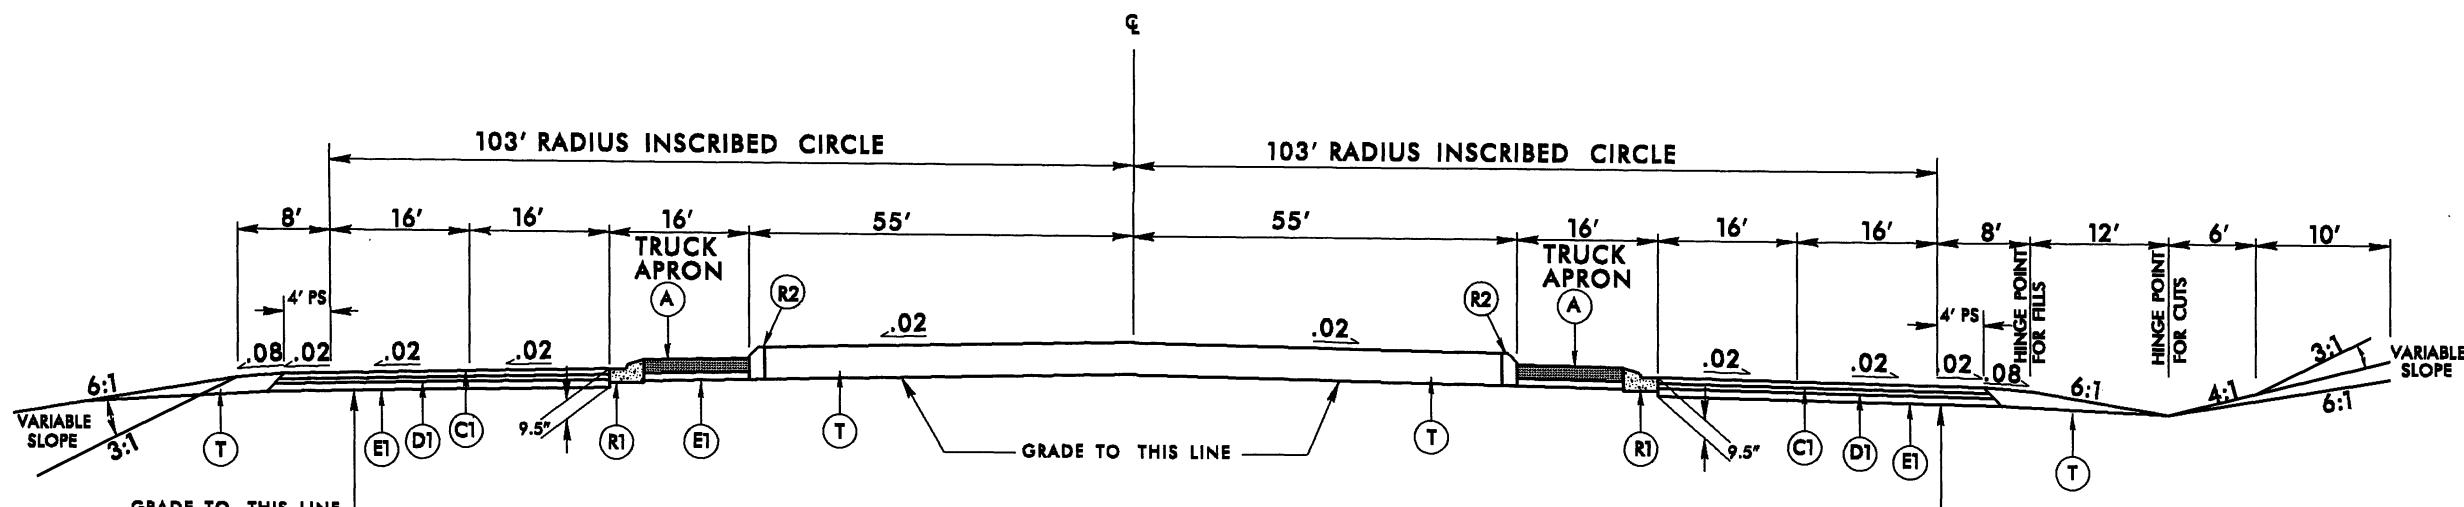


USE TYPICAL SECTION NO. 8


- L- STA. 21+39.61 TO -L- STA. 23+45.61
- L- STA. 154+29.55 TO -L- STA. 156+35.60

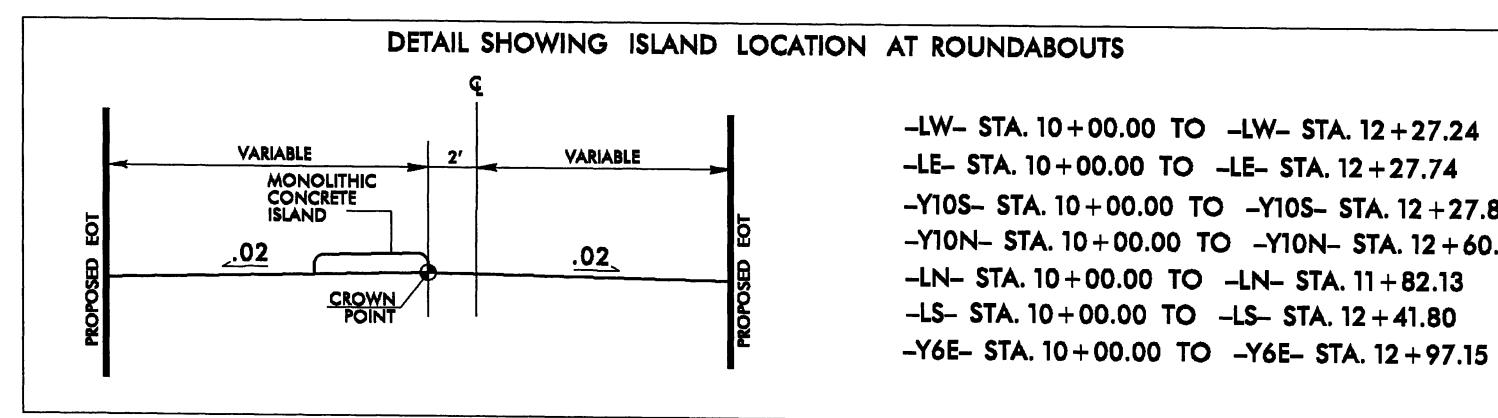


PROJECT REFERENCE NO.	SHEET NO.
ROW SHEET NO.	
R-3432	2-F
ROADWAY DESIGN ENGINEER	HYDRAULICS ENGINEER
<b>PRELIMINARY PLANS</b>	

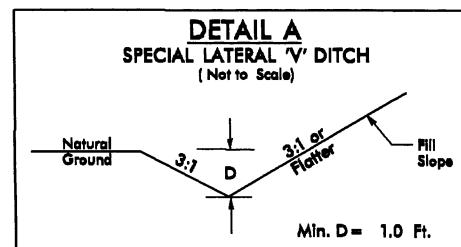


-L- STA. 13+07 TO STA. 14+87 (RT)  
-L- STA. 15+31 TO STA. 18+50 (RT)  
-Y10- STA. 27+00 TO STA. 29+28 (LT)  
-Y10- STA. 29+39 TO STA. 30+50 (LT)  
-Y10- STA. 29+62 TO STA. 33+88 (RT)

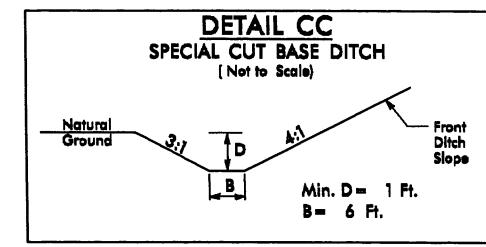


-Y10- STA. 25+03 TO STA. 27+00 (RT)  
-L- STA. 107+00 TO 108+50 (LT)

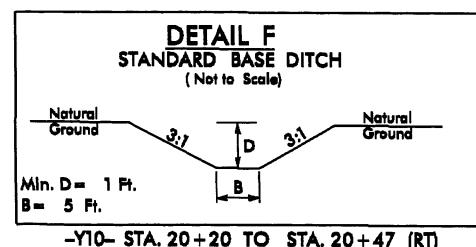


-Y10- STA. 20+20 TO STA. 20+47 (RT)

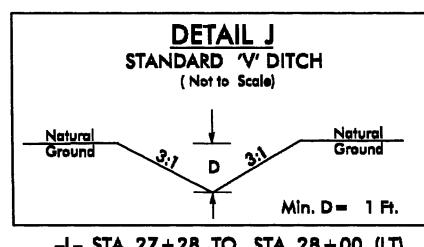


-L- STA. 27+28 TO STA. 28+00 (LT)  
EST. 9.4 CY DDE  
SLOPE = 0.0085

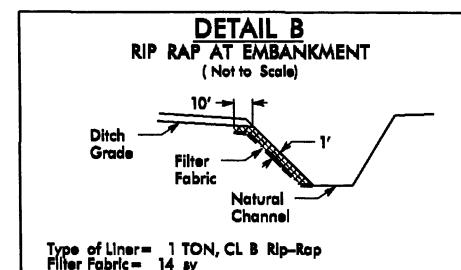


-L- STA. 14+77 TO STA. 15+06 (RT)  
-L- STA. 15+11 TO STA. 15+41 (RT)  
-L- STA. 93+10 TO STA. 93+27 (LT)  
-Y10- STA. 29+30 TO STA. 29+40 (LT)  
-Y10- STA. 29+75 TO STA. 29+85 (LT)  
-Y10- STA. 29+57 TO STA. 29+73 (RT)

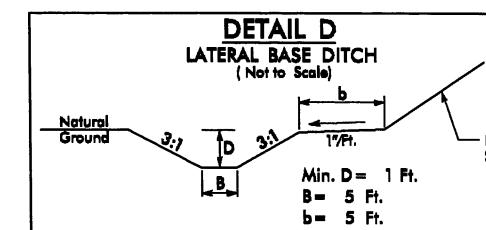


-L- STA. 105+50 TO STA. 111+20 (RT)

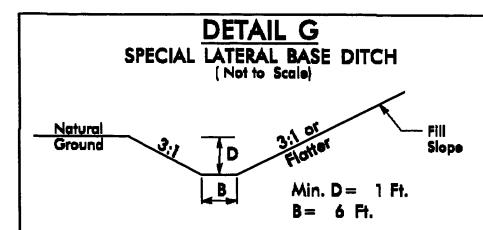


-Y10- STA. 20+47 TO STA. 23+53 (RT)  
-Y10- STA. 27+00 TO STA. 29+55 (RT)

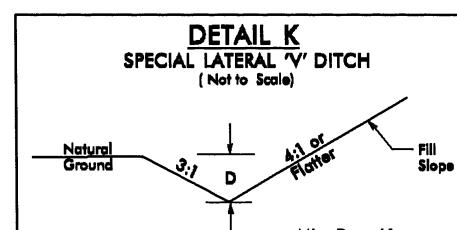


-L- STA. 40+82 TO STA. 41+47 (LT)

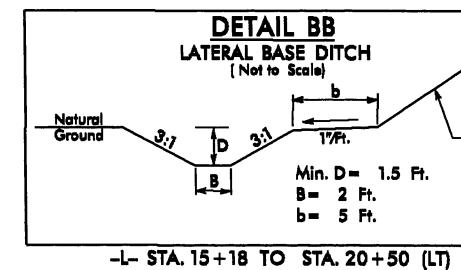


-L- STA. 15+18 TO STA. 20+50 (LT)

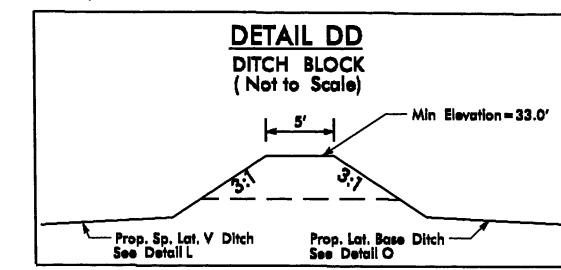


-L- STA. 100+38 TO STA. 100+63 (LT)

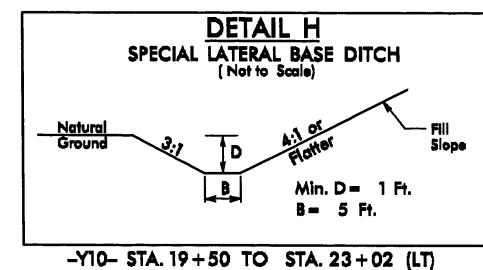


-Y10- STA. 19+50 TO STA. 23+02 (LT)

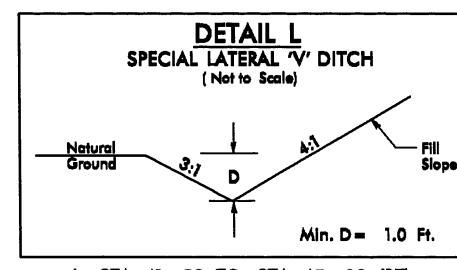


-L- STA. 41+50 TO STA. 45+00 (RT)  
-L- STA. 81+00 TO STA. 86+00 (RT)  
-L- STA. 88+50 TO STA. 99+50 (RT)  
-L- STA. 93+14 TO STA. 99+09 (LT)  
-L- STA. 99+34 TO STA. 100+38 (LT)  
-L- STA. 115+46 TO STA. 119+00 (RT)  
-Y9- STA. 11+11 TO STA. 13+12 (RT)  
-Y9- STA. 10+49 TO STA. 11+21 (LT)  
-Y9- STA. 11+88 TO STA. 12+37 (LT)  
-Y9A- STA. 10+82 TO STA. 12+70 (RT)

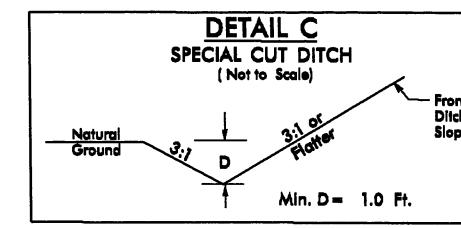


-L- STA. 18+50 TO STA. 21+00 (RT)  
-L- STA. 24+00 TO STA. 26+50 (RT)

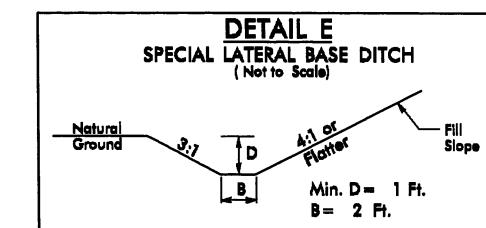

-Y10- STA. 15+00 TO STA. 20+47 (RT)

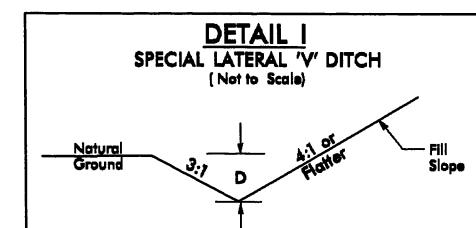















-L- STA. 24+00 TO STA. 28+50 (LT)

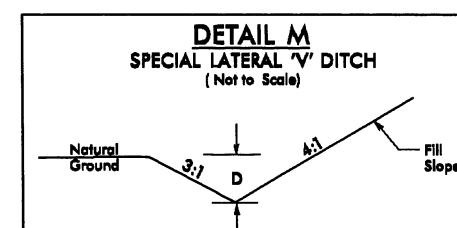

-L- STA. 49+26 TO STA. 57+50 (LT)  
-L- STA. 82+50 TO STA. 87+00 (LT)  
-L- STA. 88+50 TO STA. 93+04 (LT)  
-L- STA. 138+26 TO STA. 141+50 (RT)  
-L- STA. 158+50 TO STA. 160+50 (RT)  
-L- STA. 158+00 TO STA. 161+00 (LT)

PROJECT REFERENCE NO.	SHEET NO.
R-3432	2-G
REV SHEET NO.	
ROADWAY DESIGN ENGINEER	HYDRAULICS ENGINEER


**PRELIMINARY PLANS**

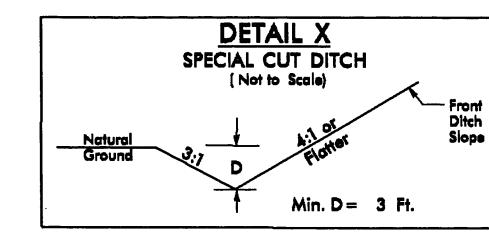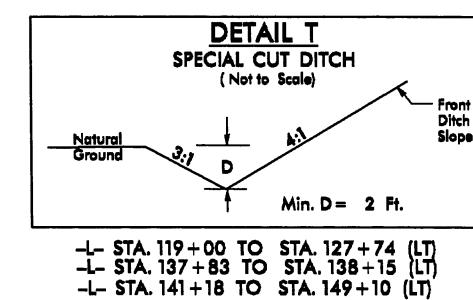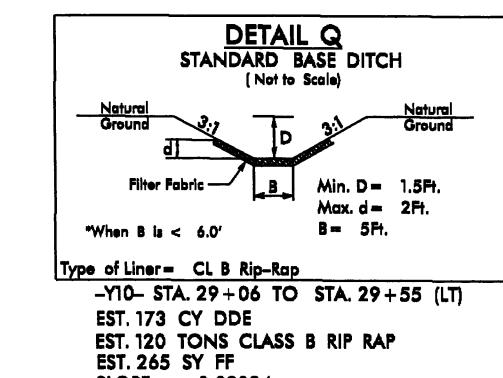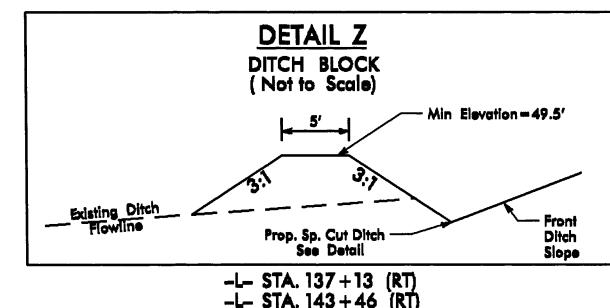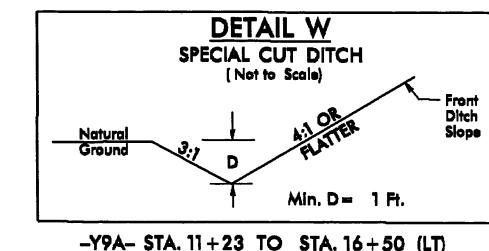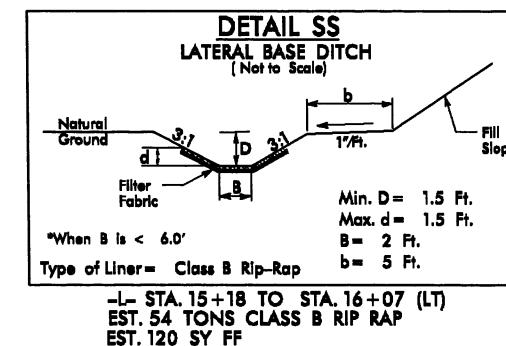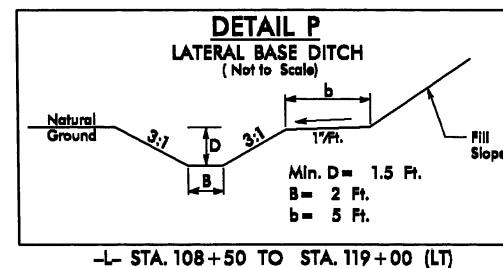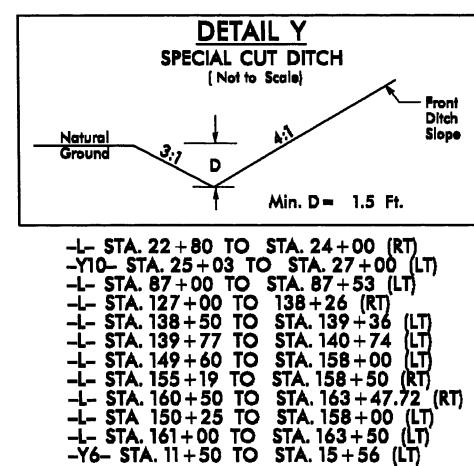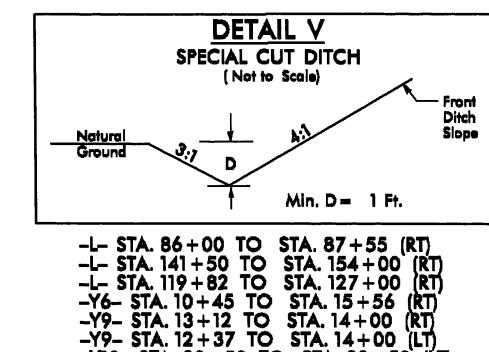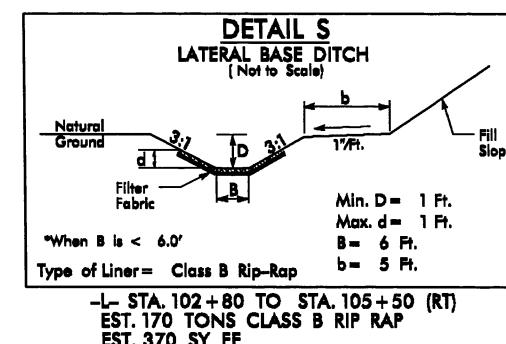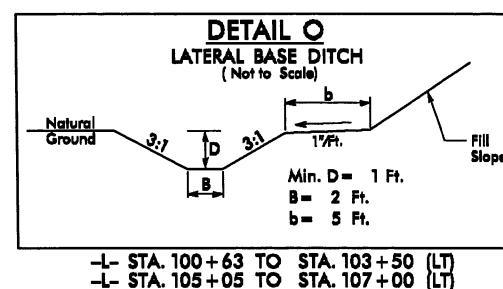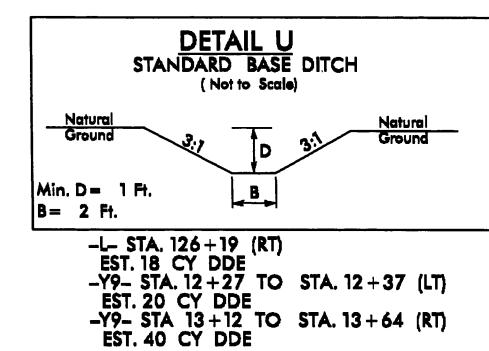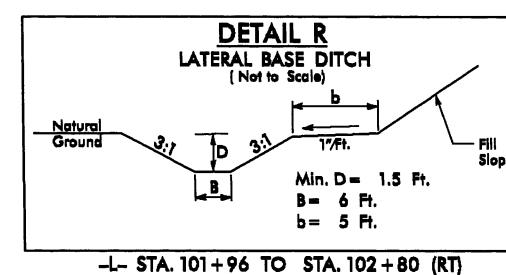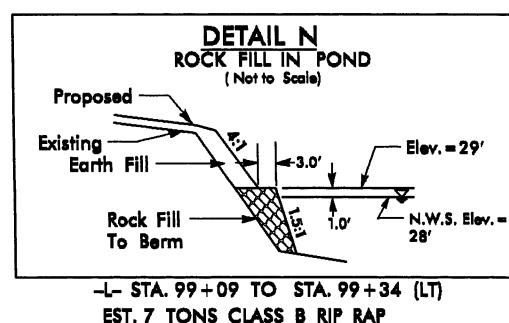


PROJECT REFERENCE NO.	SHEET NO.
R-3432	4
RW SHEET NO.	
ROADWAY DESIGN ENGINEER	HYDRAULICS ENGINEER
PRELIMINARY PLANS PG 307 USE FOR CONSTRUCTION	

STA. 13+07.00 -L-

## BEGIN STATE PROJECT R-3432

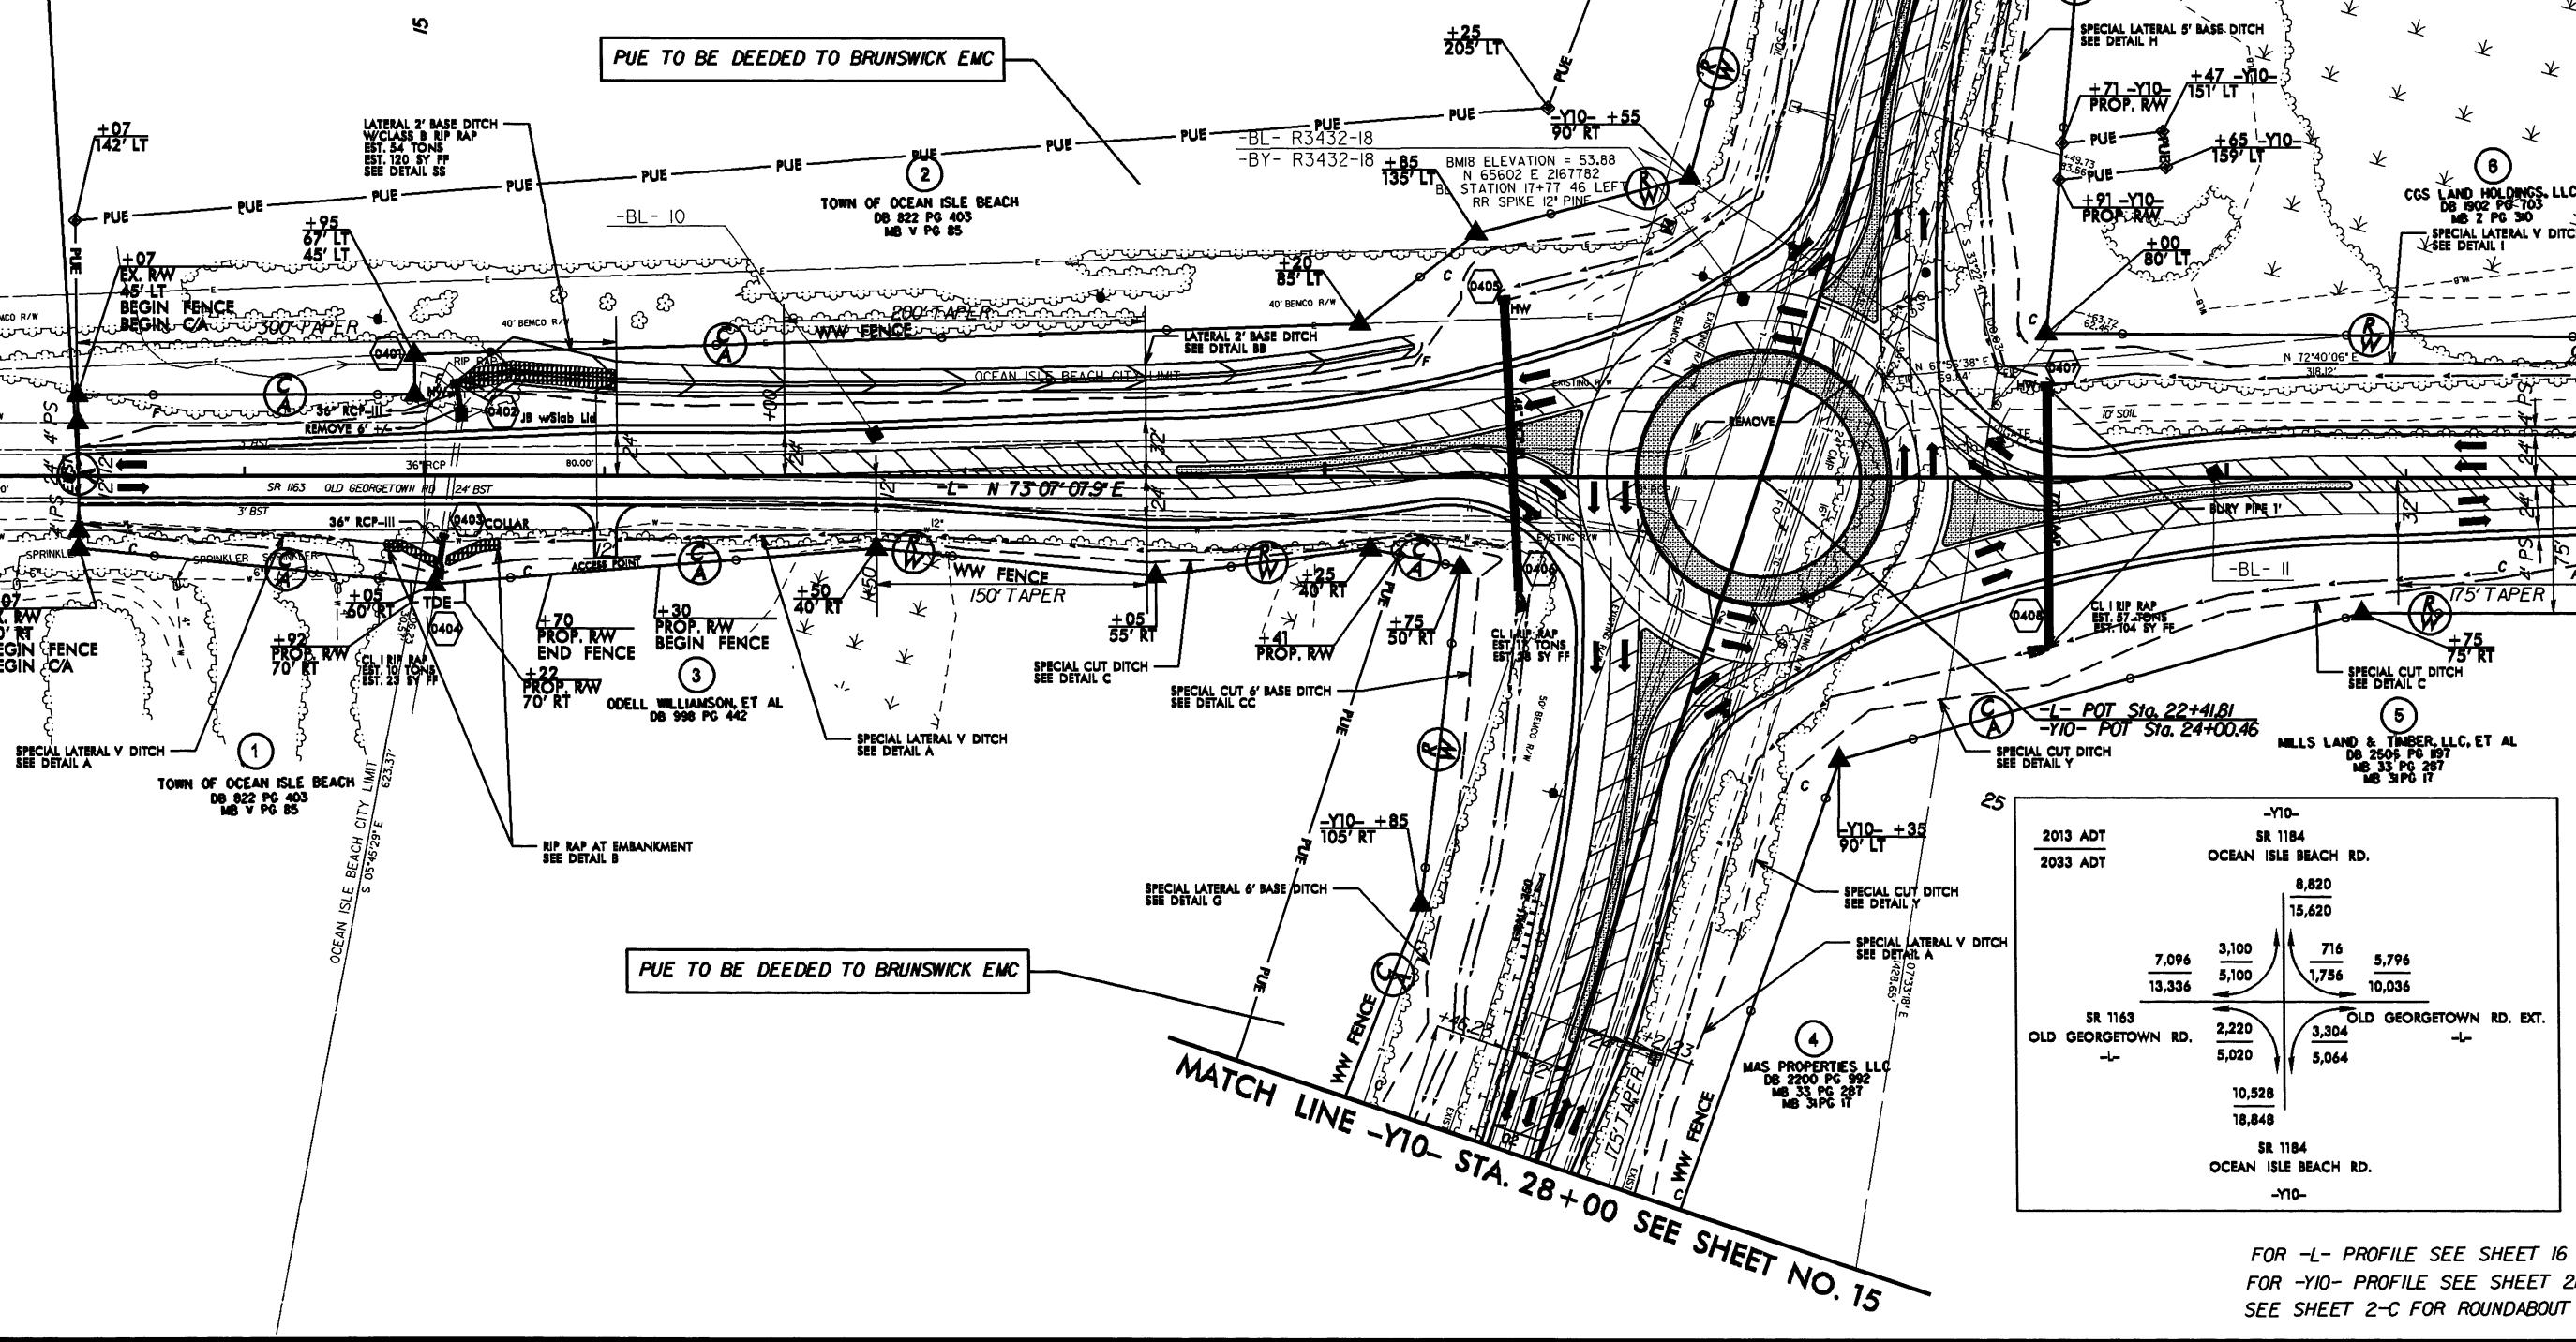




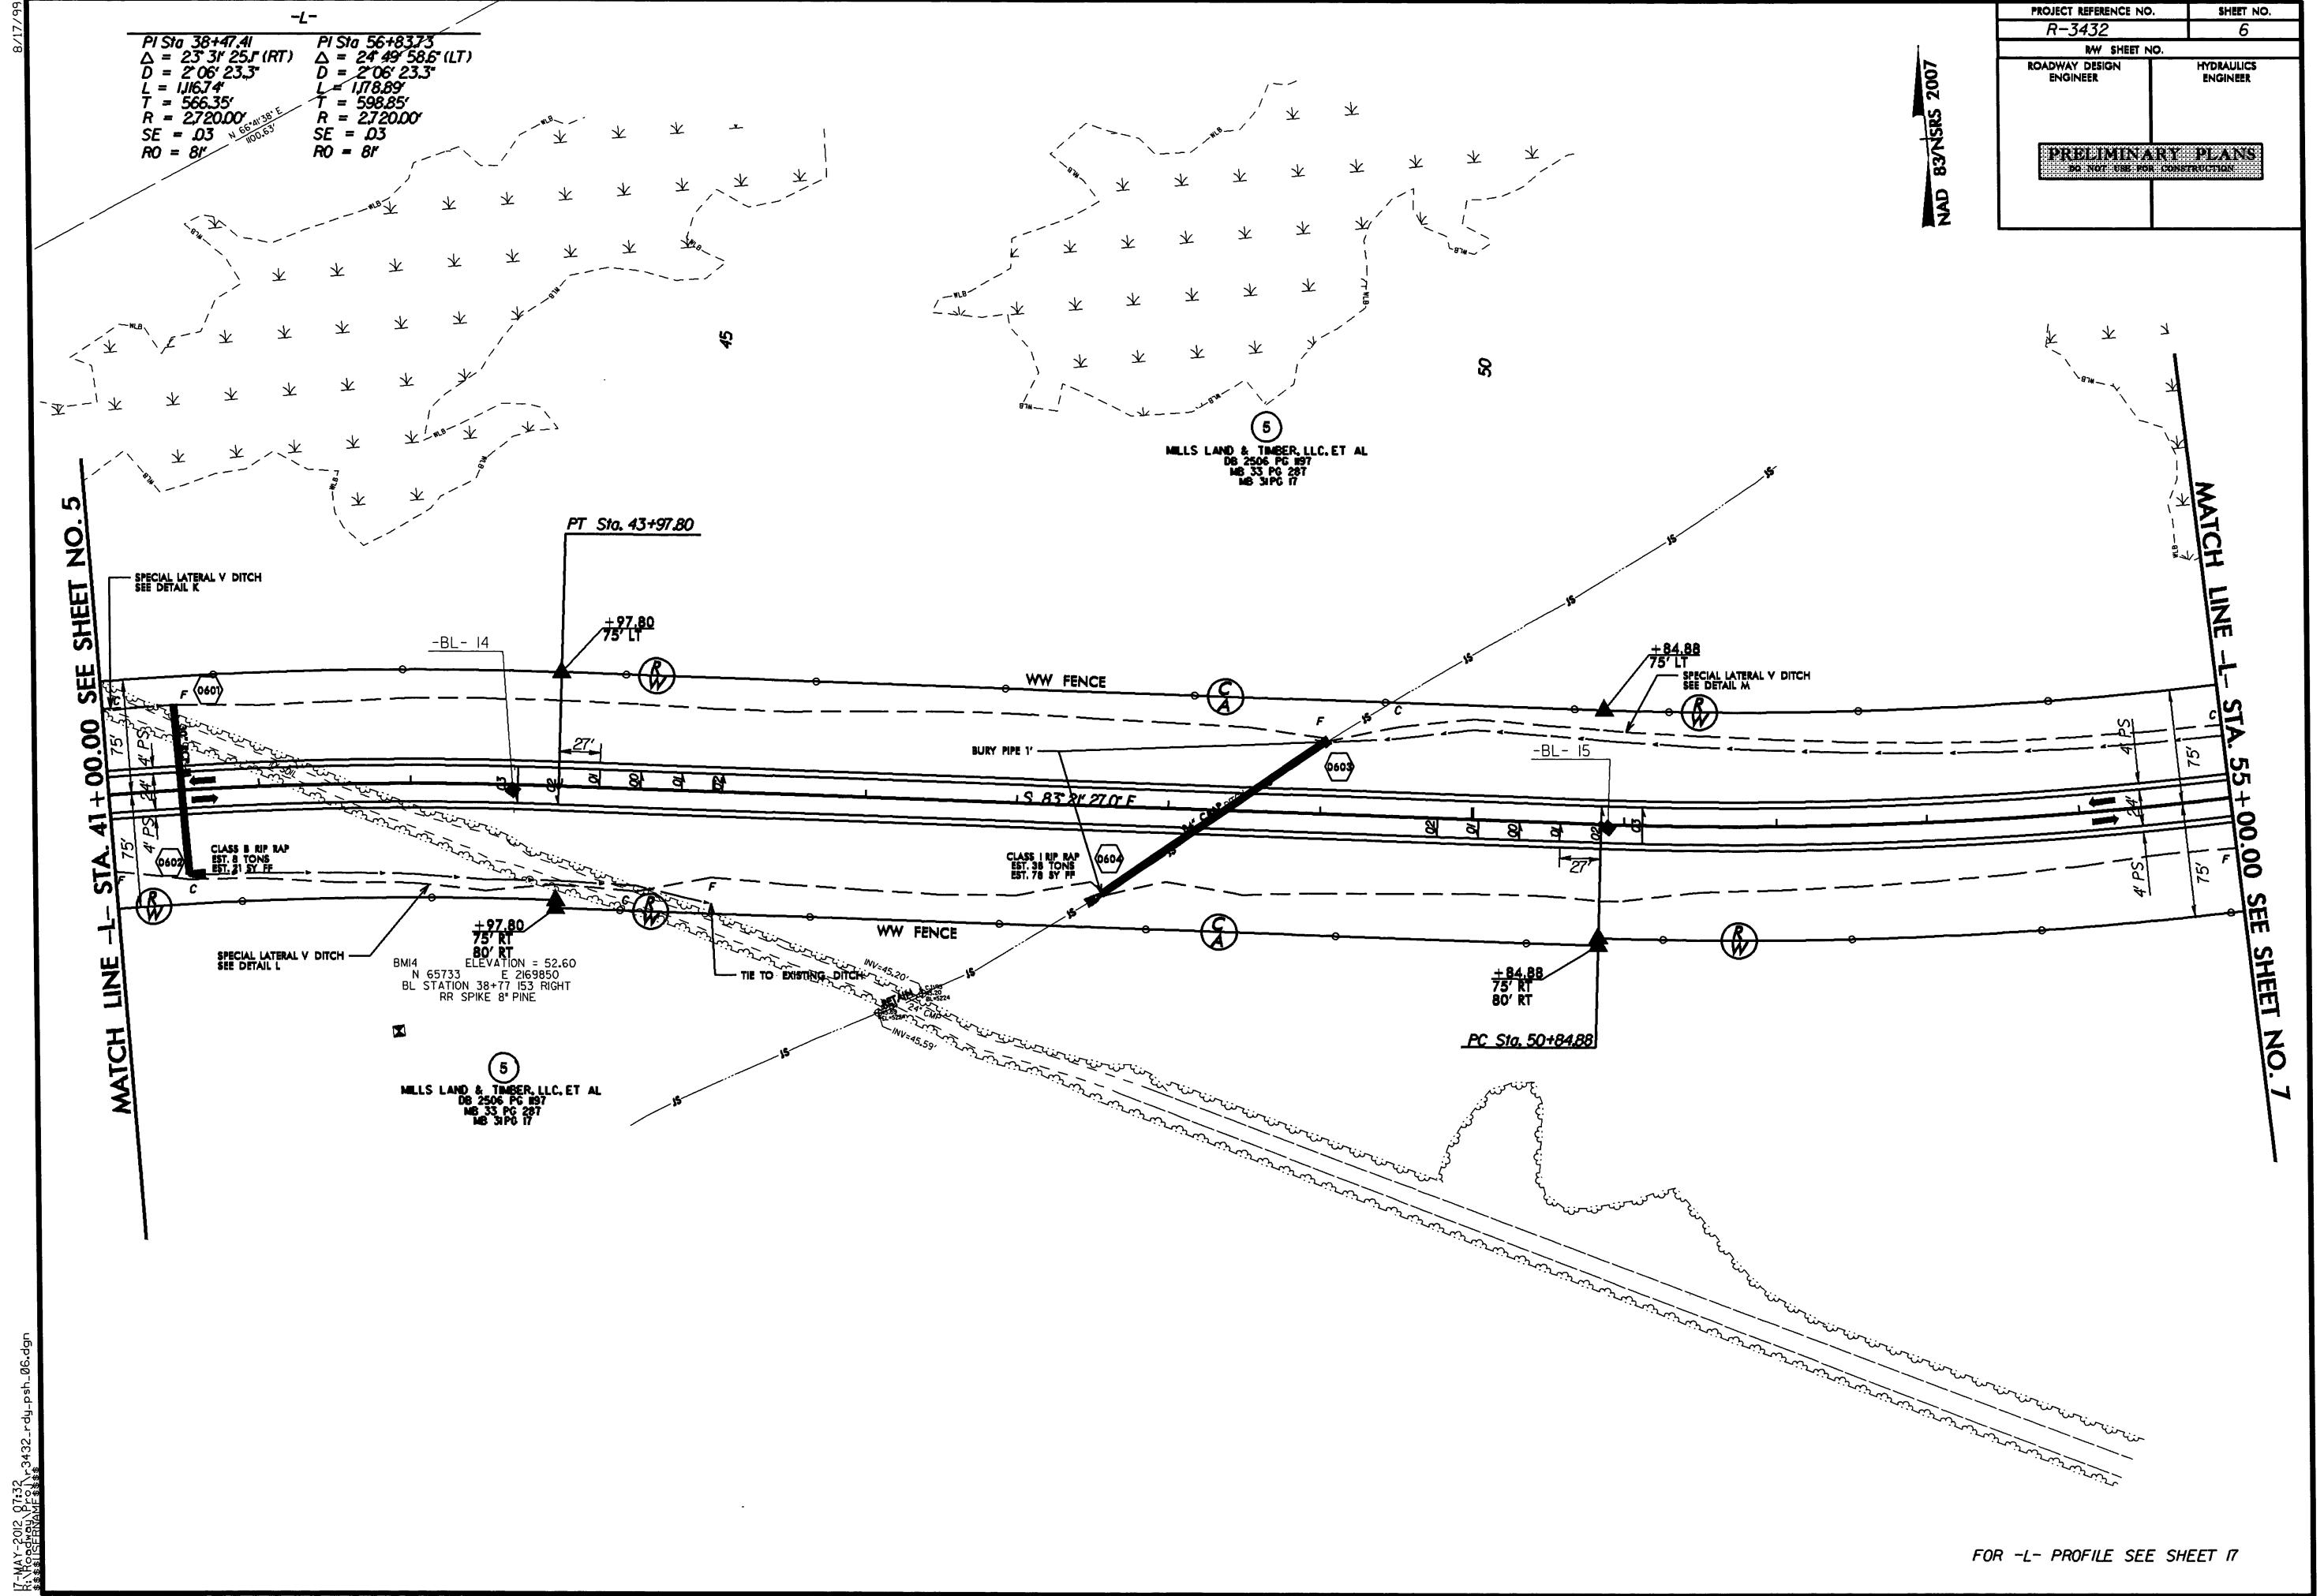

8/17/99

## REVISIONS

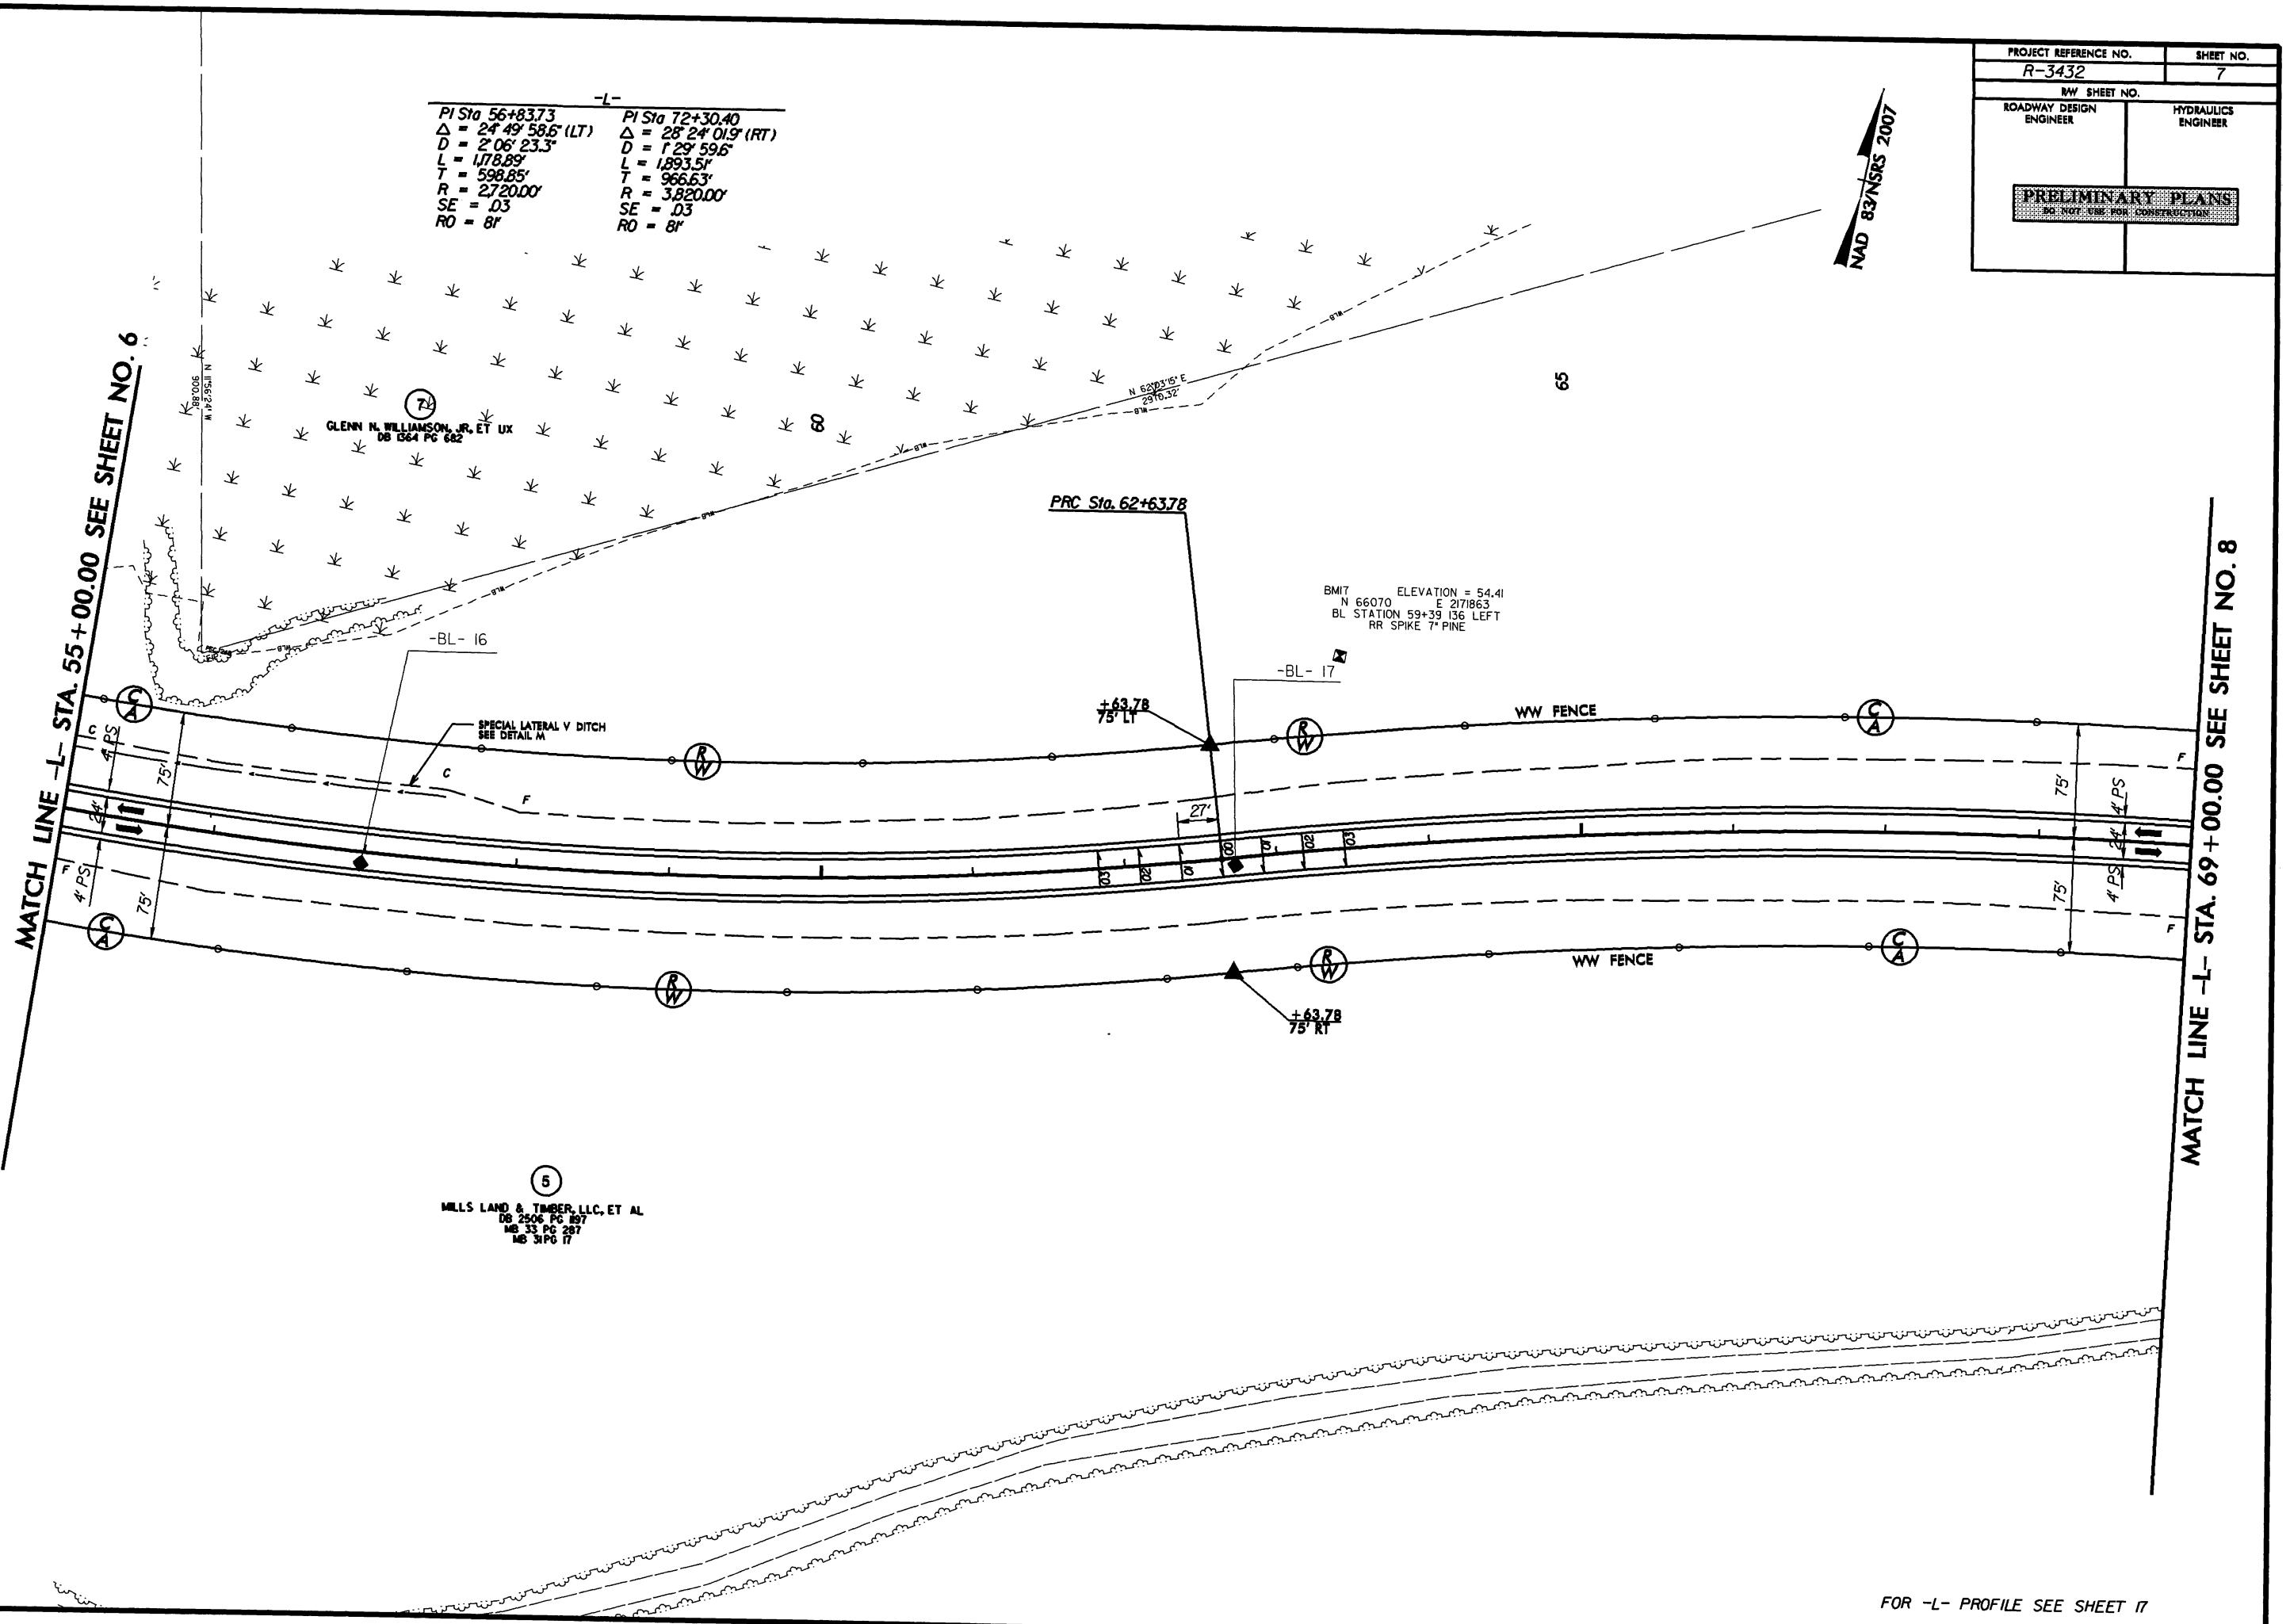

PROJECT REFERENCE NO.	SHEET NO.
R-3432	8
RW SHEET NO.	
ROADWAY DESIGN ENGINEER	
HYDRAULICS ENGINEER	
PRELIMINARY PLANS -3432-1 FOR CONSTRUCTION	

NAD 83/NRHS 2007

-L-  
PI Sta 72+30.40  
 $\Delta = 28^\circ 24' 01.9''$  (RT)  
D = 129' 59.6"  
L = 1,893.5'  
T = 966.63'  
R = 3,820.00'  
SE = .03  
R0 = 8'

-DR6-  
PI Sta II+08.45  
 $\Delta = 10^\circ 55' 41.3''$  (RT)  
D = 57' 17' 44.8"  
L = 19.07'  
T = 9.57'  
R = 100.00'  
SE = SEE PLANS

-DR7-  
PI Sta 10+38.01  
 $\Delta = 40^\circ 43' 33.1''$  (RT)  
D = 114' 35' 29.6"  
L = 35.54'  
T = 18.56'  
R = 50.00'  
SE = SEE PLANS

REVISIONS


MATCH LINE -L- STA. 69+00.00 SEE SHEET NO.7

70

75

80

5  
MILLS LAND & TIMBER, LLC, ET AL  
DB 2506 PG 297  
MB 33 PG 297  
MB 31 PG 17

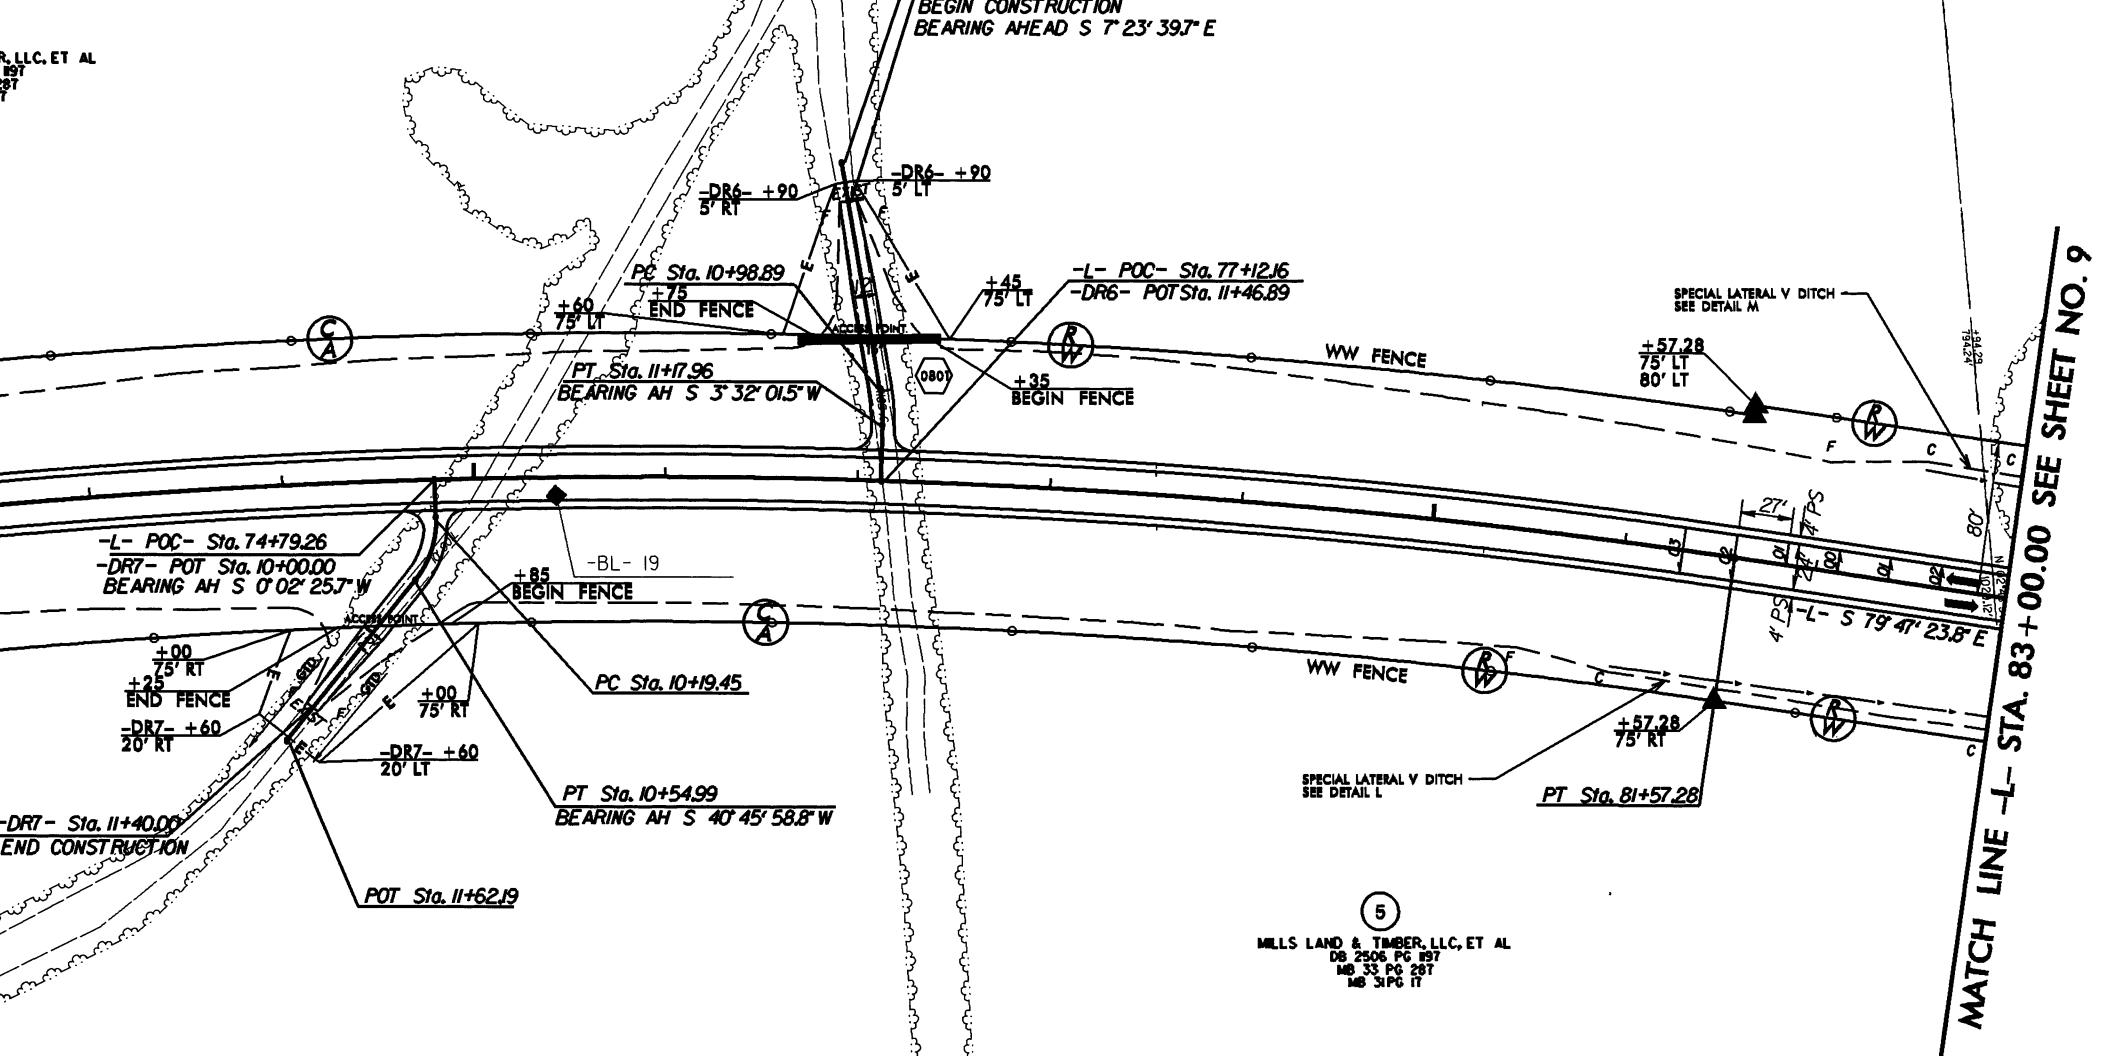


MATCH LINE -L- STA. 83+00.00 SEE SHEET NO.9

PROJECT REFERENCE NO.	SHEET NO.
R-3432	9
RW SHEET NO.	
ROADWAY DESIGN ENGINEER	HYDRAULICS ENGINEER
<b>PRELIMINARY PLANS</b> <small>FOR ENGINEERING AND CONSTRUCTION</small>	

NAD 83 NSRS 2007

-L-	-DRI-	-DR2-
PI Sta 97+39.71 Δ = 60° 46' 46" (LT) D = 3° 49' 11.0" L = 159.20' T = 879.68' R = 1500.00' SE = .04 RO = 108'	PI Sta 10+97.55 Δ = 71° 40' 18" (LT) D = 114° 35' 29.6" L = 62.55' T = 361.1' R = 50.00' SE = SEE PLANS	PI Sta 10+57.70 Δ = 70° 28' 49" (LT) D = 114° 35' 29.6" L = 61.51' T = 35.32' R = 50.00' SE = SEE PLANS

REVISIONS

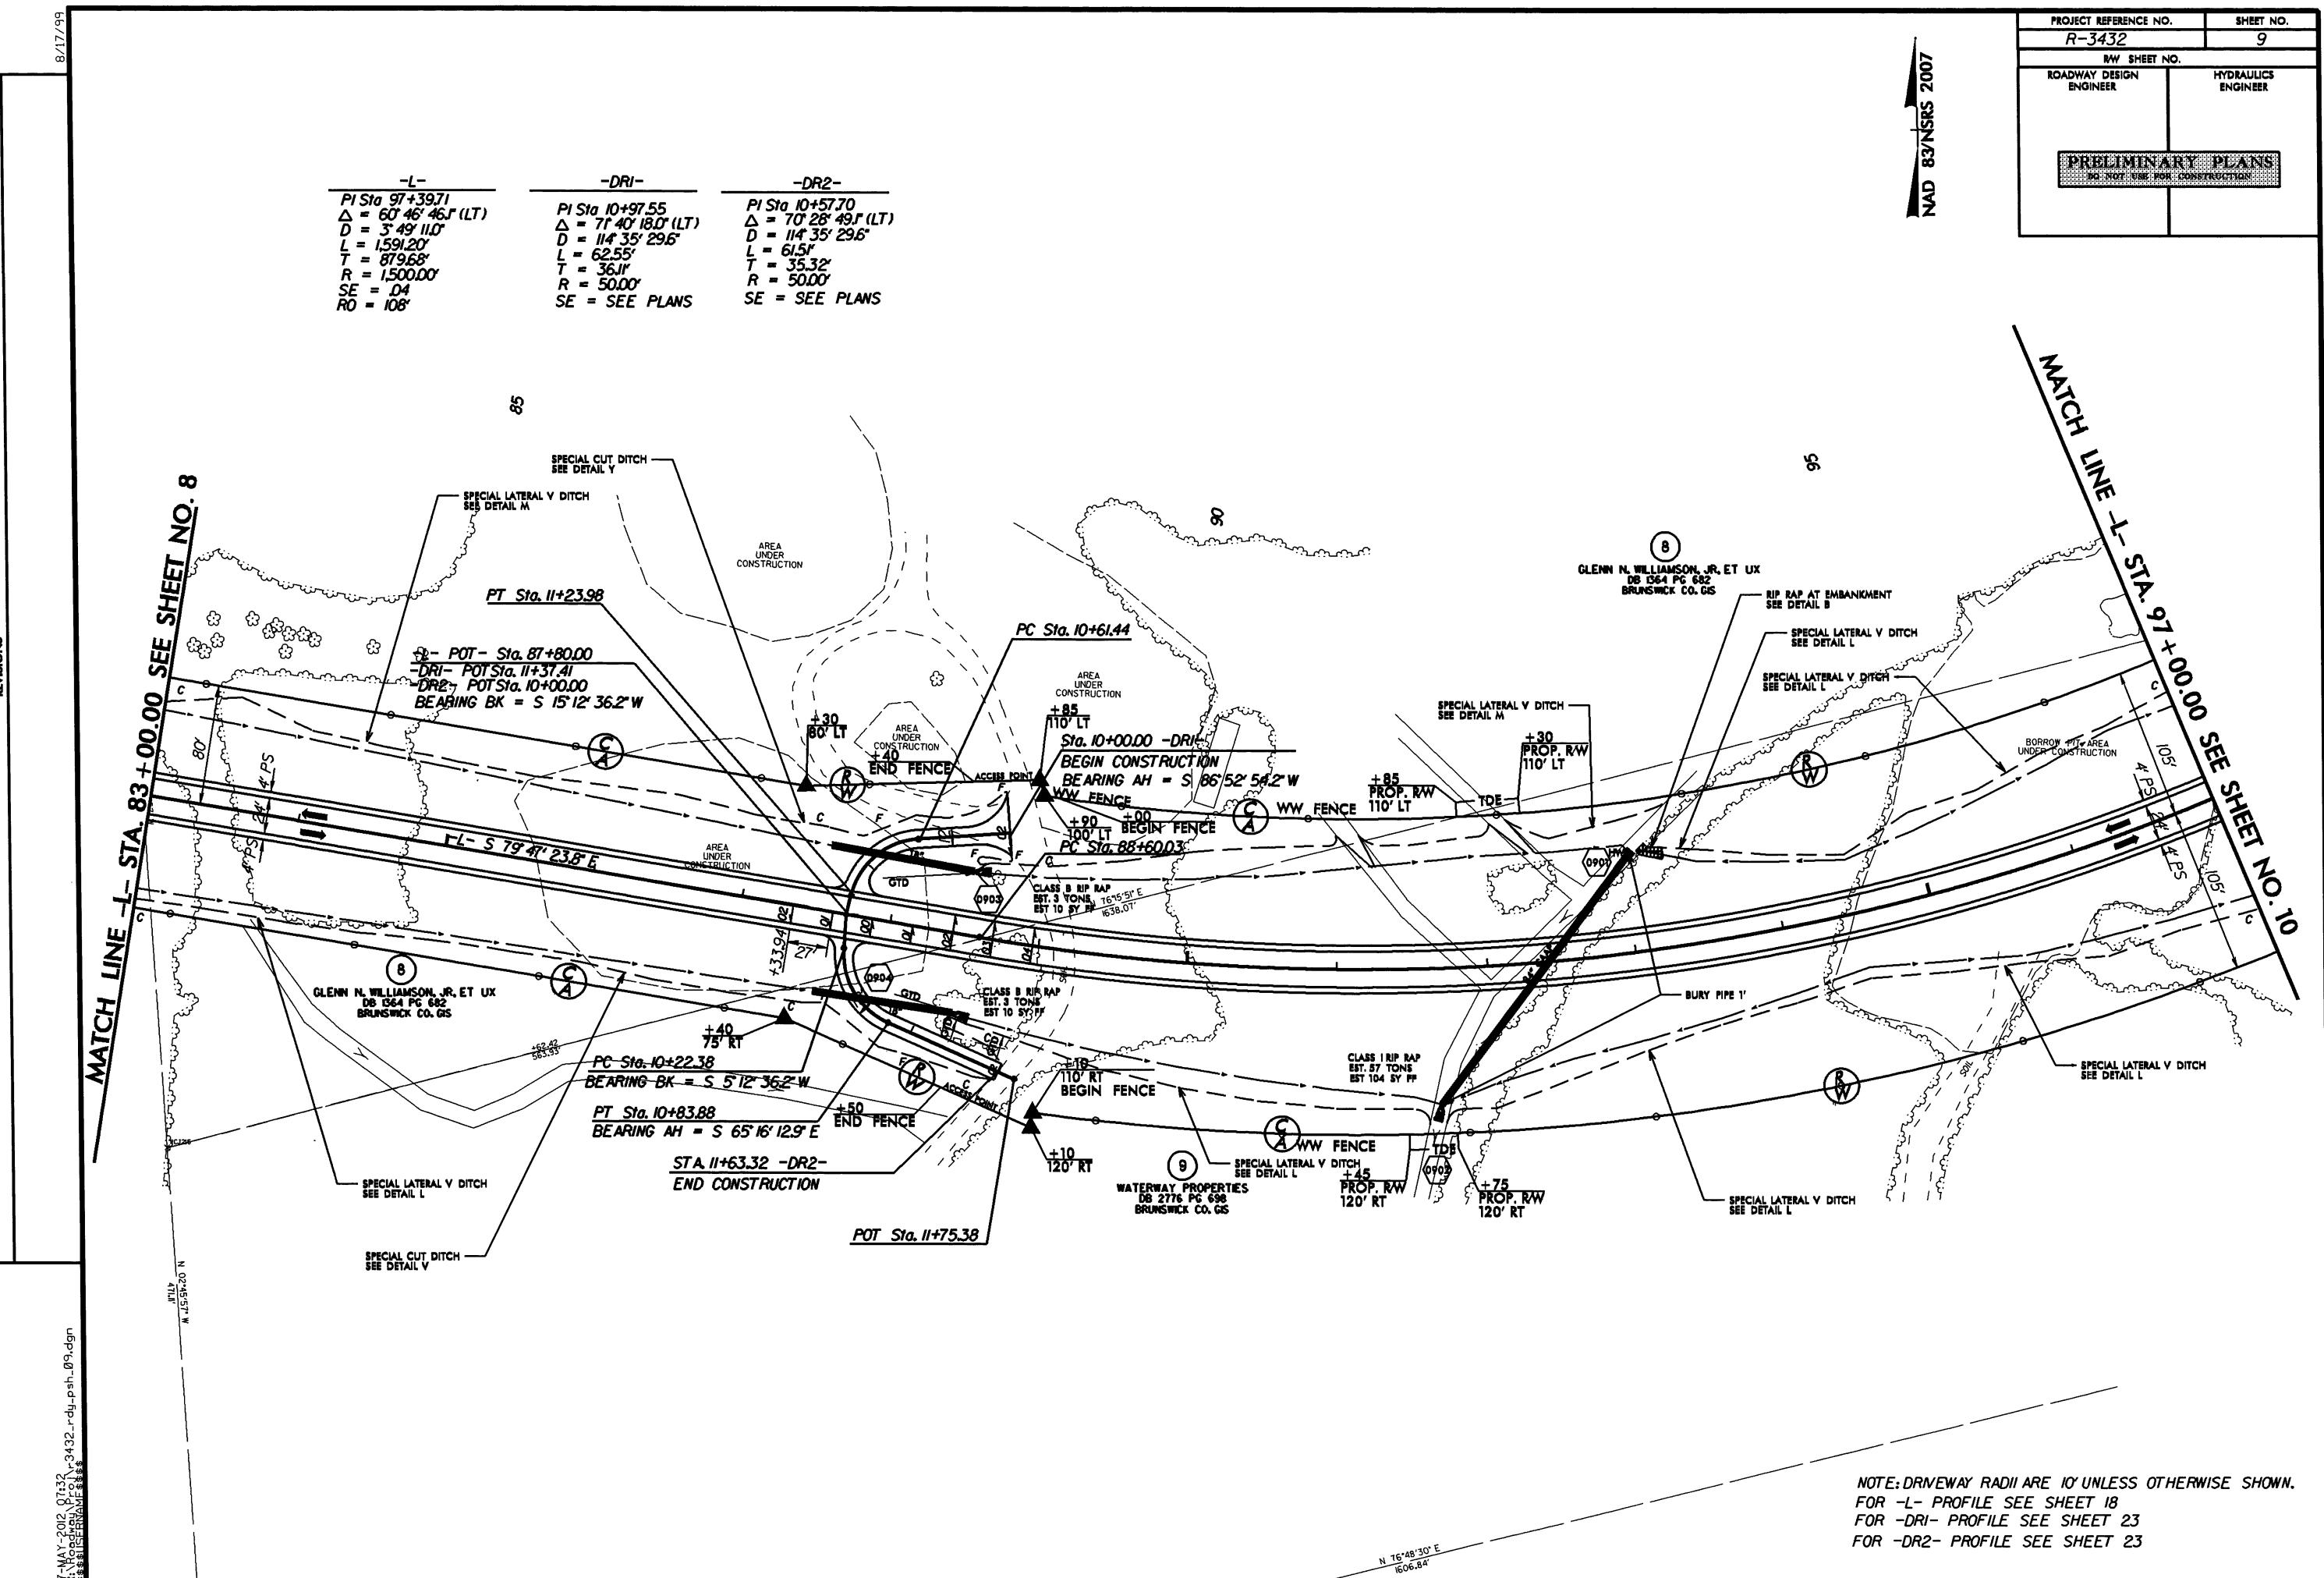

PROJECT REFERENCE NO.	SHEET NO.
R-3432	10
REV SHEET NO.	
ROADWAY DESIGN ENGINEER	HYDRAULICS ENGINEER

PRELIMINARY PLANS

(2007-100% CONSTRUCTION)

10

NAD 83 NSRS 2007


MATCH LINE -L- STA. 97+00.00 SEE SHEET NO. 9

REVISIONS

R:\May\2012\0732\r3432\rd\r3432-rdu-Psh-10.dwg

-L-

PI Sta. 97+39.71	PI Sta. 106+65.62
Δ = 60° 46' 46" (LT)	Δ = 16° 16' 03" (RT)
D = 3' 49" 11"	D = 3' 49" 11"
L = 1,591.20'	L = 425.89'
T = 879.68'	T = 24.39'
R = 1500.00'	R = 300.00'
SE = .04	SE = .04
RO = 108°	RO = 108°

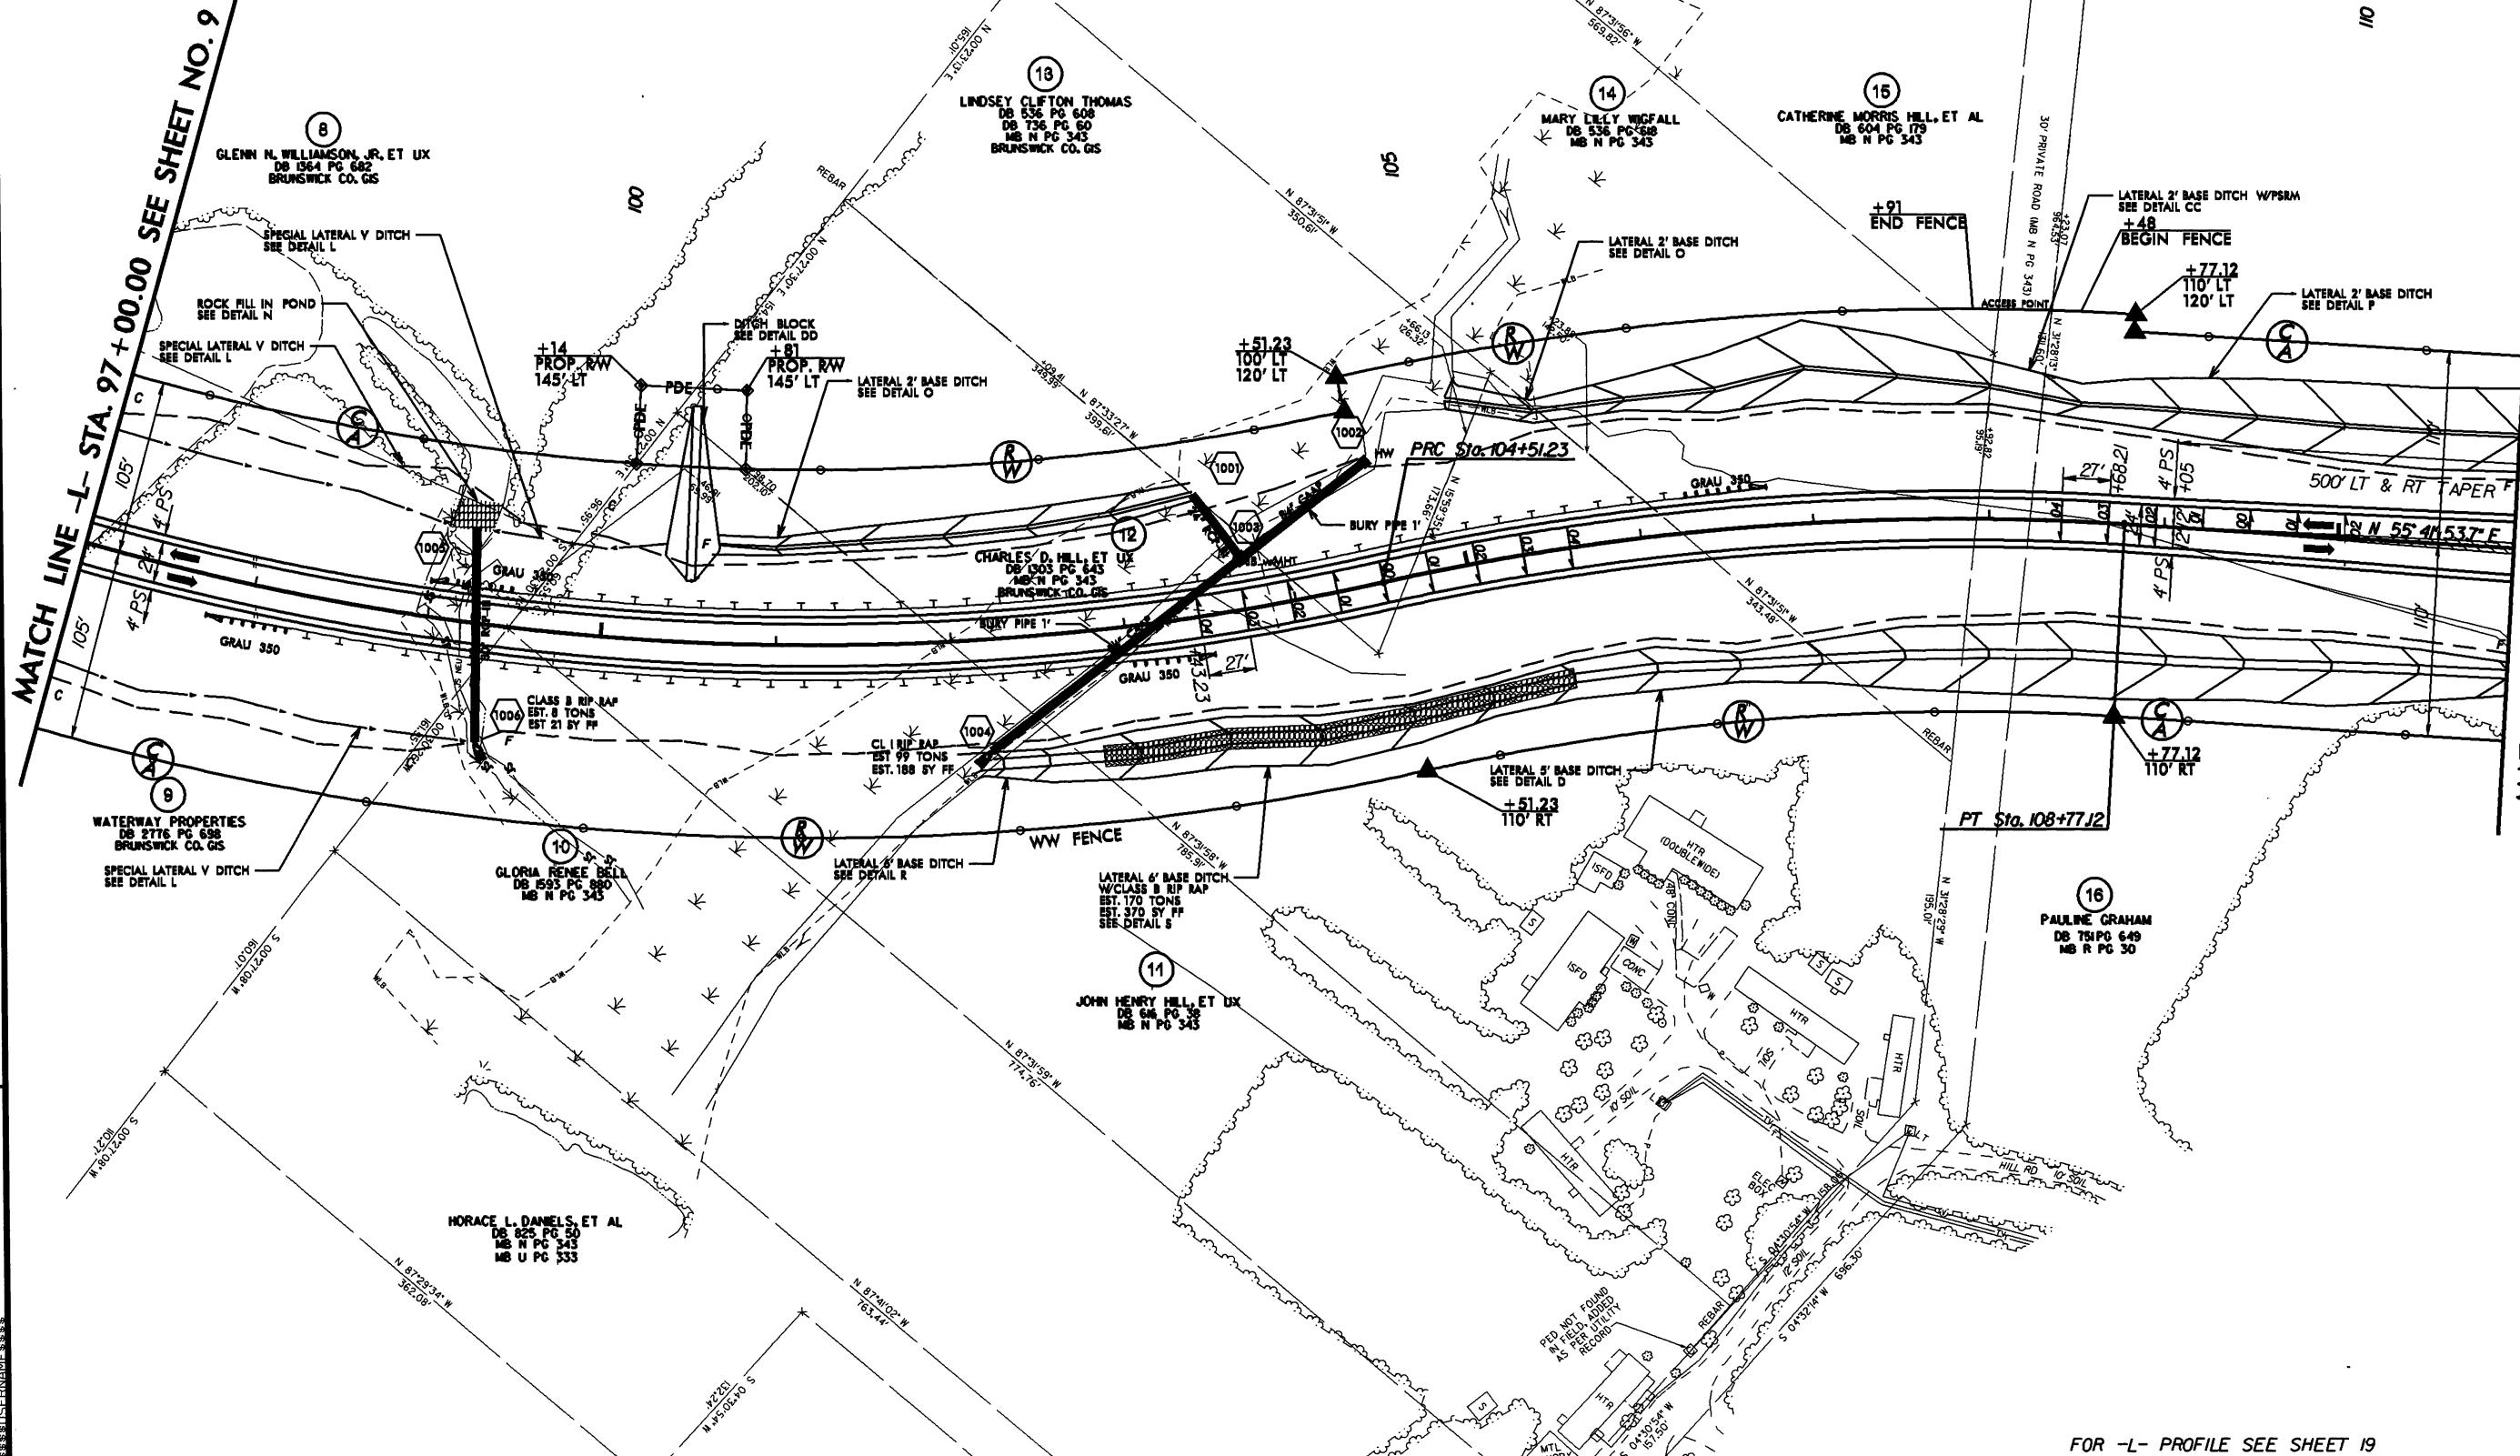

PI Sta 119°40.44  
 $\Delta$  = 39°34'10.4" (LT)  
 D = 3°49'11.0"  
 L = 1035.93'  
 T = 539.58'  
 R = 1500.00'  
 SE = .04  
 RO = 108'

**OLD GEORGETOWN RD. EXT.**

**SR 1154**

**HALE SWAMP RD.**

**-YR-**

Segment	ADT
Old Georgetown Rd. Ext.	5,796 10,036
SR 1154	7,312 12,592
Hale Swamp Rd.	320 1,836 1,120 3,676 2,156 4,796

SHEFFIELD SEAFOOD & GROCERY, INC.  
DB 1503 PG 859  
MB R PG 90

NAD 83/NSRS 2007

PROJECT REFERENCE NO.		SHEET NO.
<b>R-3432</b>		<b>11</b>
RW SHEET NO.		
<b>Roadway Design Engineer</b>		<b>Hydraulics Engineer</b>
<b>PRELIMINARY PLANS</b> <small>Sheet No. 11 of 11</small>		

**MATCH LINE - STA. 111 + 00.00 SEE SHEET NO. 10**

16  
PAULINE GRAHAM  
DB 751 PG 649  
MB R PG 30

This technical drawing illustrates a complex road interchange or bridge approach. The plan view shows multiple lanes of traffic flow, including a 500' LT & RT TAPER, N 55° 4' 53.7" F, 150' TAPER, 100' RT TURN LANE, 250' LT TURN LANE, and 500' LT & BT TAPER. Key features include lateral base ditches (LATERAL 2' BASE DITCH SEE DETAIL F, LATERAL 5' BASE DITCH SEE DETAIL D), a WW FENCE, CLASS B RIP RAP (EST. 2 TONS EST. 7 BY FF), and SPECIAL CUT DITCH (SEE DETAIL T). A BM26 survey point is marked with coordinates N 67683 E 17016 BL STATION 116+70 89 LEFT RR SPIKE 8' PINE. The plan also includes labels for MATCH LINE, END FENCE, ARCH POINT, EXISTING RR, EXISTING RW, and PUE. A scale bar indicates distances up to 100'.

19  
MICHAEL E.  
MR. 75 HPC

**PT Sta. 124+3679**

**+36.79**  
75' LT

**+64**  
**BEGIN FENCE**

**+04**  
**END FENCE**

**M26**  
N 67683 ELEVATION 80.72  
BL STATION 118+70 89 LEFT  
RR SPIKE 8' PINE

**ELEVATION 80.72**  
E 2177016

**EXISTING R/W**

**WW FENCE**

**PUE**

**SPECIAL CUT DITCH**  
SEE DETAIL V

**LISA E LITTLE**  
US 704 MC 1 PG 55 KTR

**20**

**N 17°11'08"**

**1'**  
**STA.**  
**LINE 1-**  
**17**

**C**  
**A**

**PUE**

**PUE**

**+25**  
70' RT

**-BL- 26**



BROW REV: REVISING PUE ON PARCEL 18 AND 26 THRU 32. 5/14/12 TFD

AY-2012, 07:32 31/12/2012 225 13 dan

REVISIONS

MATCH LINE -L- STA. 153 +00.00 SEE SHEET NO. 13



-L-

PI Sta 154+03.18	PI Sta 158+72.07	PI Sta 161+87.25
$\Delta = 20^{\circ} 06' 07''$ (LT)	$\Delta = 12^{\circ} 41' 11''$ (LT)	$\Delta = 56^{\circ} 34' 11''$ (RT)
D = 4° 48' 53.2"	D = 4° 48' 53.2"	D = 4° 48' 53.2"
L = 417.5'	L = 263.49'	L = 365.07'
T = 210.92'	T = 132.29'	T = 183.98'
R = 1,190.00'	R = 1,190.00'	R = 1,190.00'
SE = .04	SE = .04	SE = .04
RO = 100'	RO = 100'	RO = 76'

SEE PLANS  
RO - SEE PLANS

-Y6-

PI Sta 12+23.87	PI Sta 12+23.87
$\Delta = 17^{\circ} 34' 37.6''$ (RT)	$\Delta = 56^{\circ} 34' 11''$ (RT)
D = 15° 26' 37.0"	D = 4° 48' 53.2"
L = 366.30'	L = 365.07'
T = 199.64'	T = 183.98'
R = 371.00'	R = 1,190.00'
SE = .04	SE = .04
RO = 76'	RO = 100'

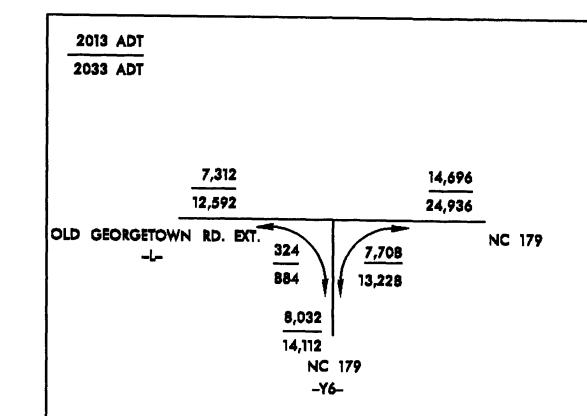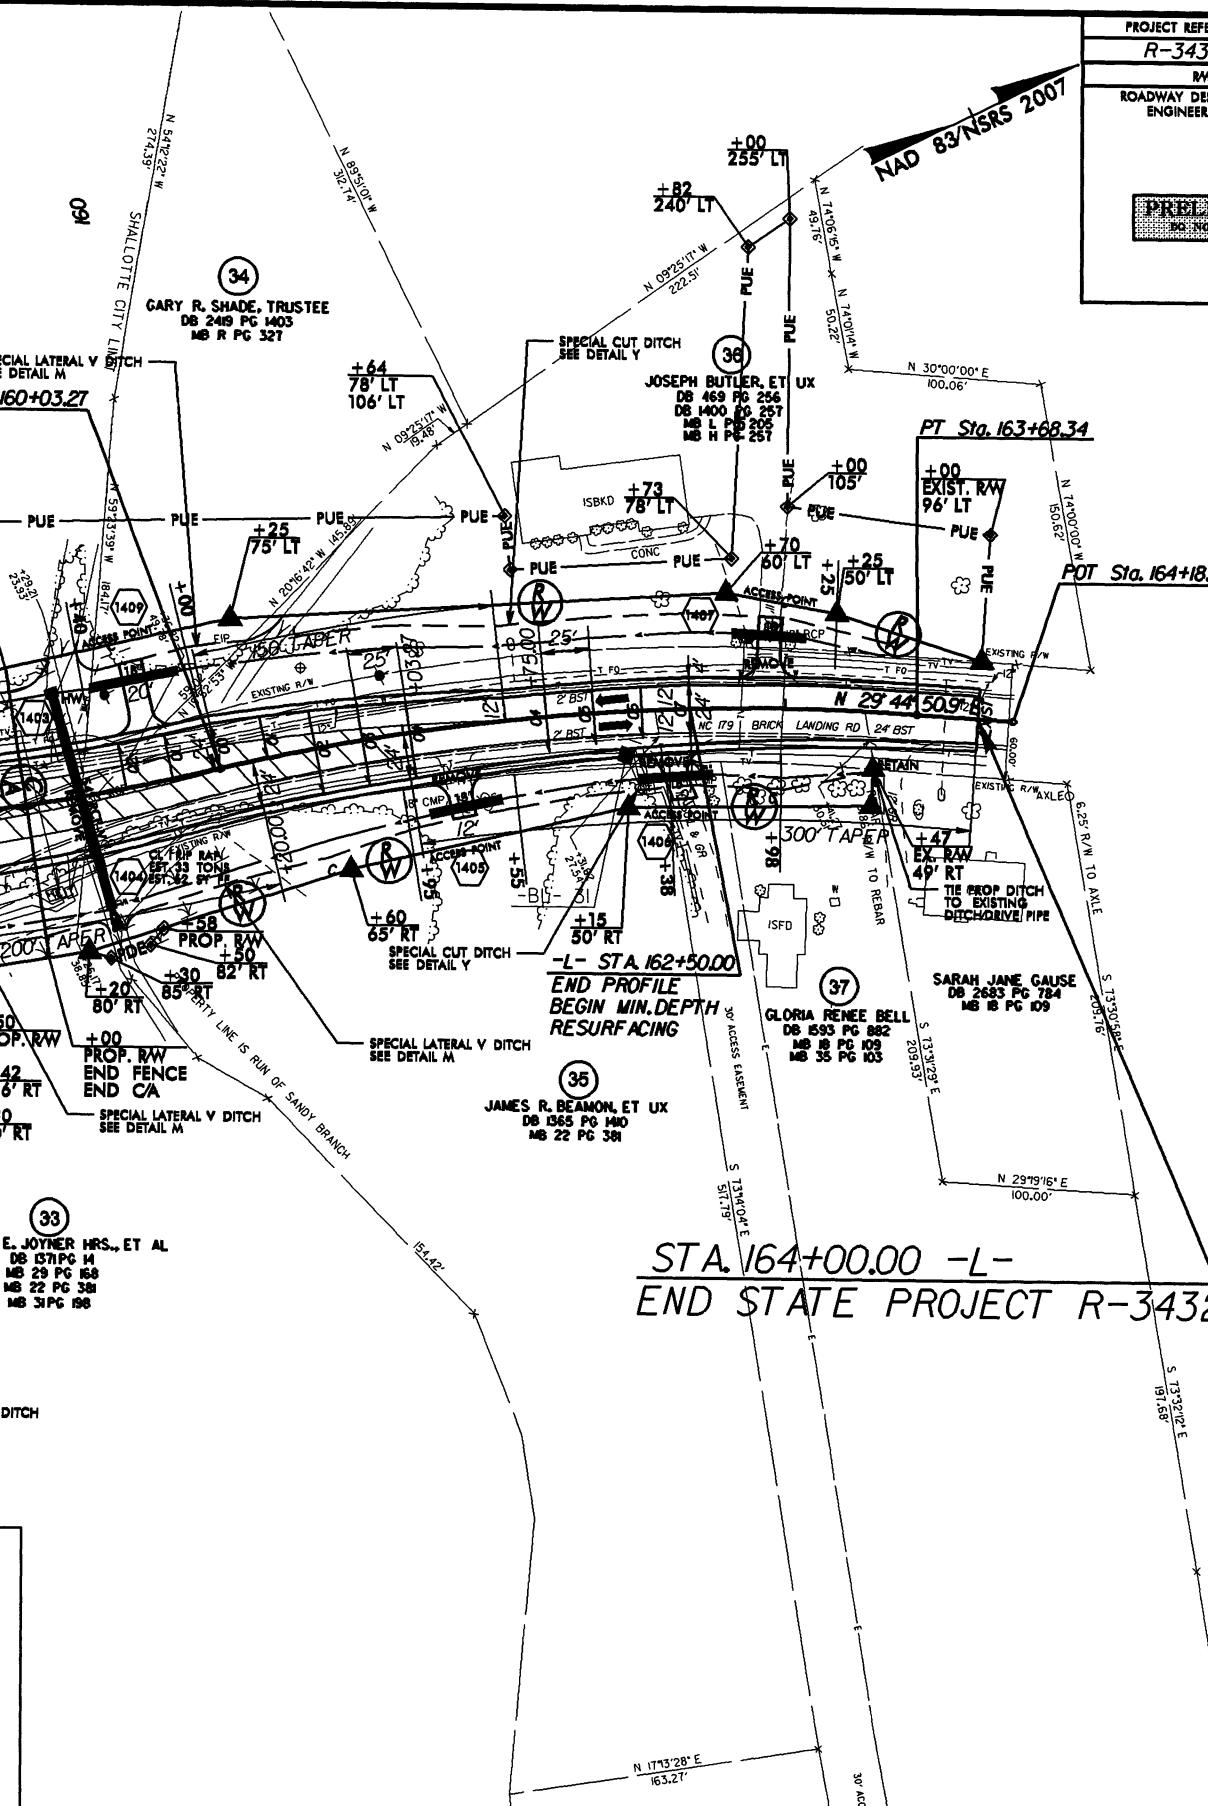

PROJECT REFERENCE NO.	SHEET NO.
R-3432	15
RW SHEET NO.	
ROADWAY DESIGN ENGINEER	HYDRAULICS ENGINEER
<b>PRELIMINARY PLANS</b> <small>DO NOT USE FOR CONSTRUCTION</small>	


NAD 83/NSRS 2007

## MATCH LINE -Y10- STA. 28+00 SEE SHEET NO. 4

-Y10-

PI Sta. 31+16.11  
 △ = 7' 5" 41" (LT)  
 D = 1' 47" 25.8"  
 L = 439.07'  
 T = 219.88'  
 R = 3,200.00'  
 SE = .03  
 RO = 8'

30

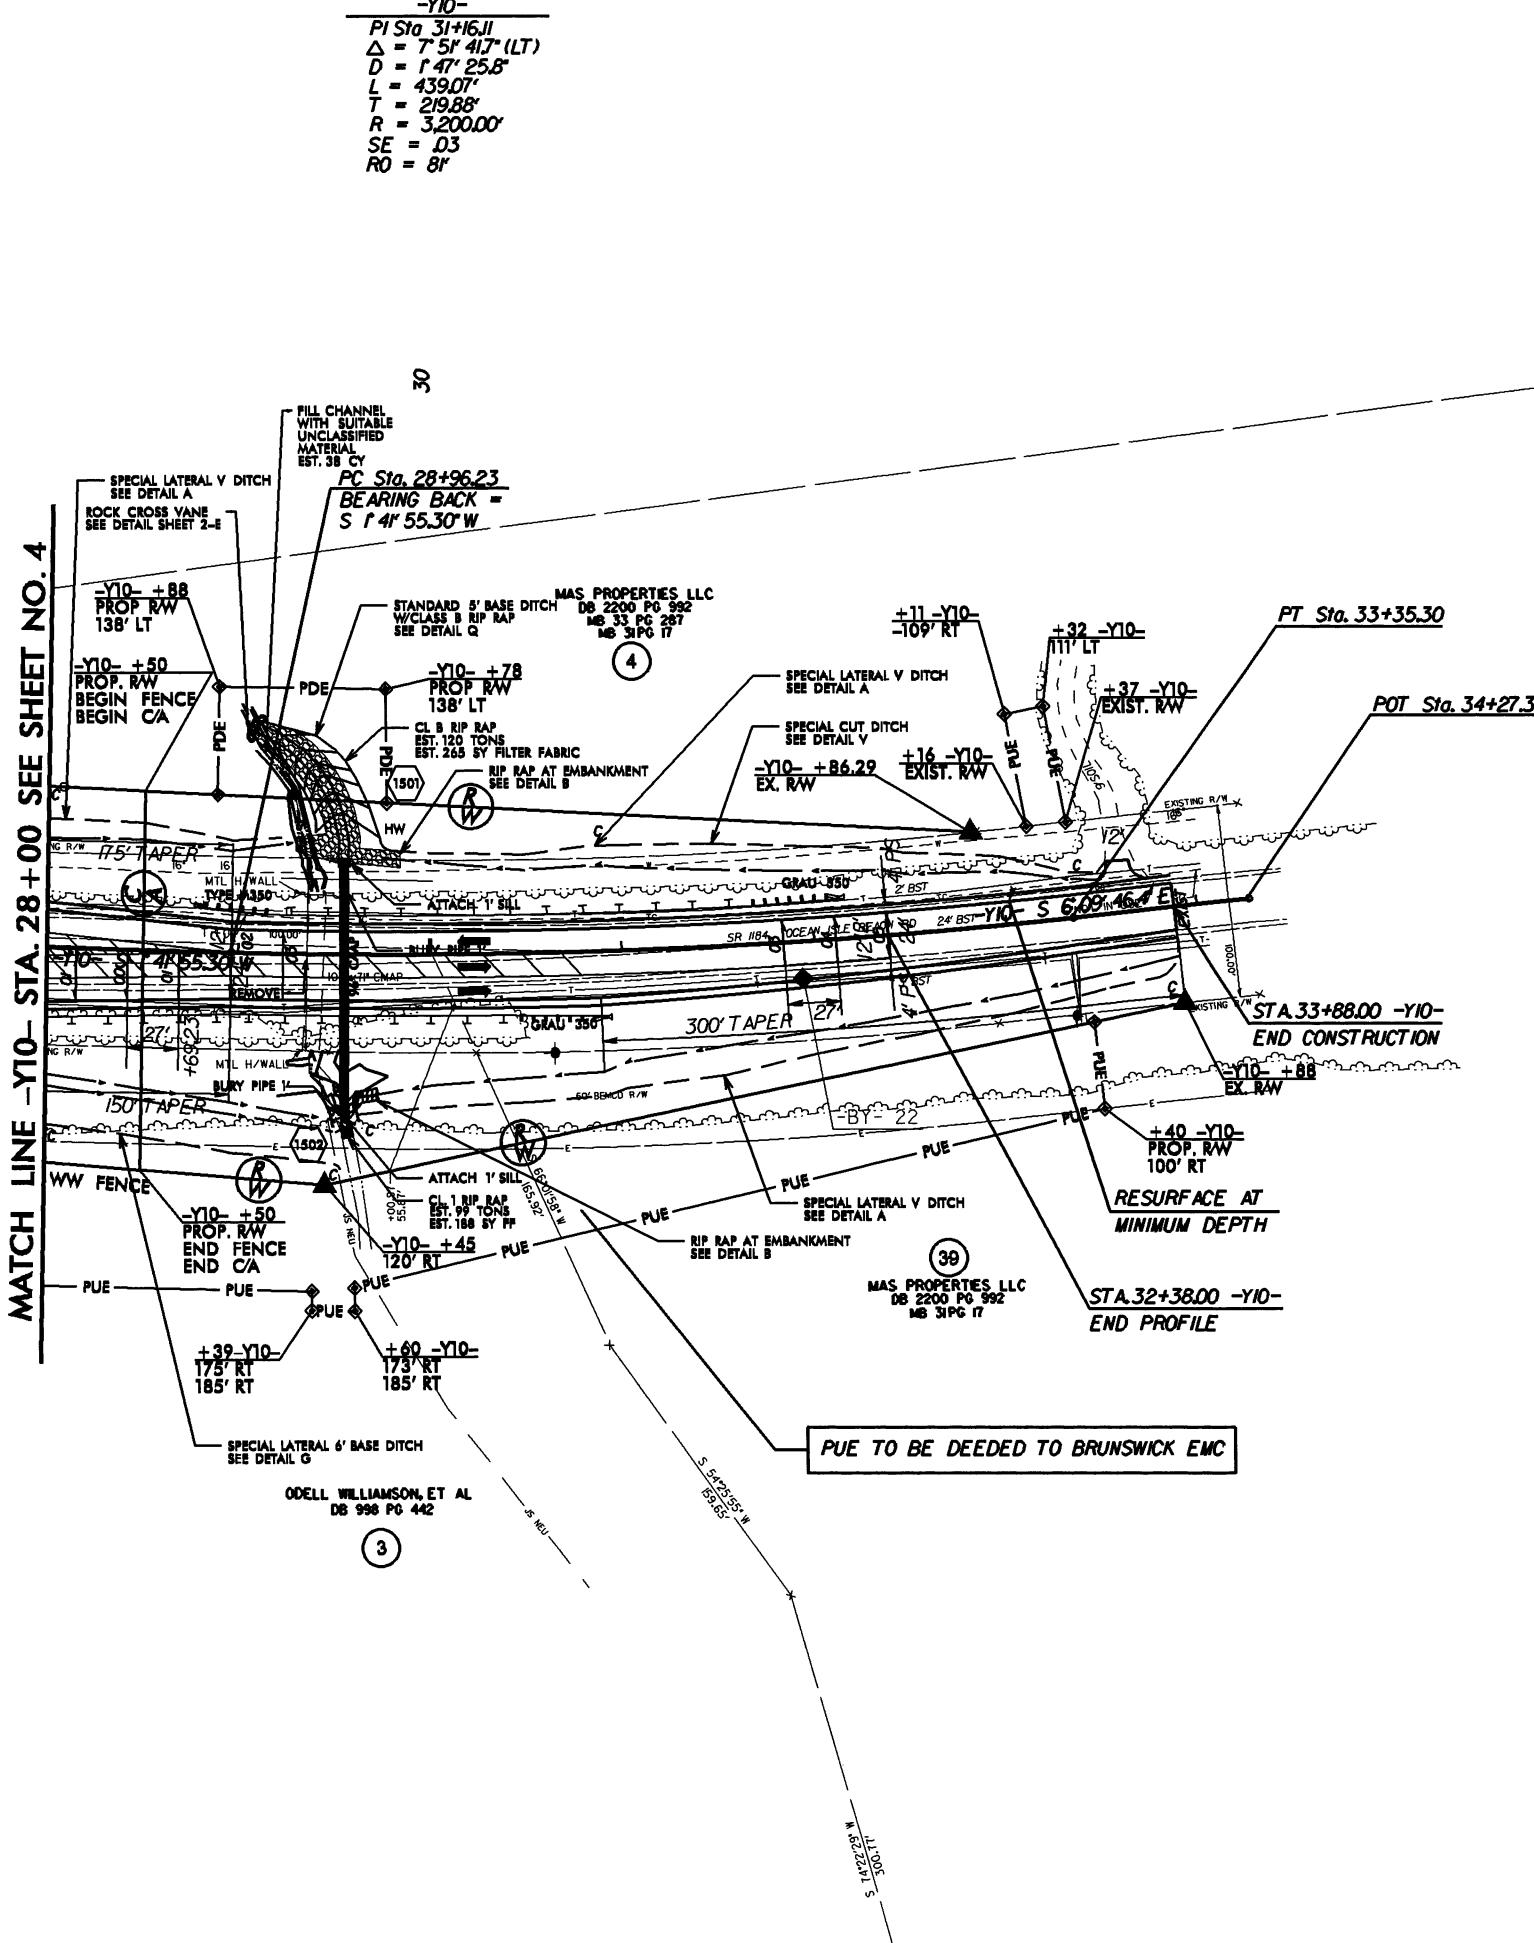


PROJECT REFERENCE NO.		SHEET NO.
R-3432		15A
RW SHEET NO.		
ROADWAY DESIGN ENGINEER	HYDRAULICS ENGINEER	
		PRELIMINARY PLANS <small>DO NOT USE FOR CONSTRUCTION</small>

8/17/99

15

NAD 83/NSRS 2007

POT Sta. 12+78.95

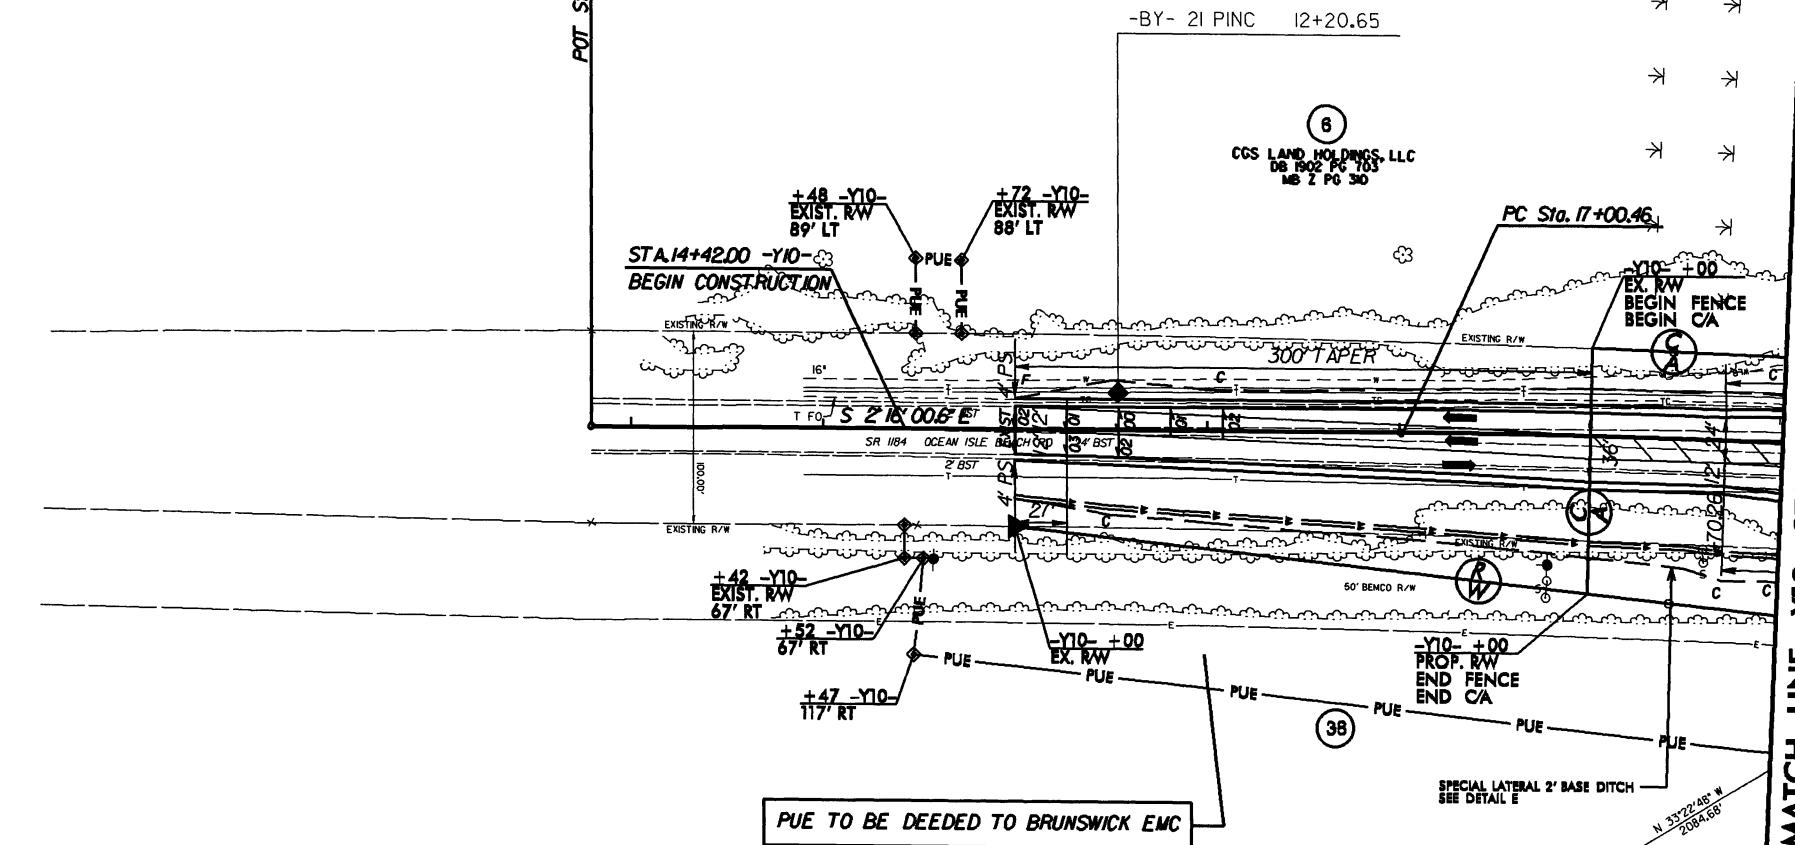

MATCH LINE -Y10- STA. 19+00 SEE SHEET NO. 4