



STATE OF NORTH CAROLINA
DEPARTMENT OF TRANSPORTATION

BEVERLY EAVES PERDUE
GOVERNOR

EUGENE A. CONTI, JR.
SECRETARY

July 30, 2012

US Army Corps of Engineers
Raleigh Regulatory Field Office
3331 Heritage Trade Dr., Suite 105
Wake Forest, NC 27587

Attention: Eric Alsmeyer
NCDOT Coordinator, Division 5

Subject: **Application for the Modification to the Section 404 Individual Permit and Section 401 Water Quality Certification** for US 501 from NC 49 in Roxboro to SR 1602 (Jesse Banks Road) in Person County, Division 5. Federal Aid Project No. STP-501(11), WBS Element No. 34406.2.3, TIP No. R-2241A.

Reference: Section 404 Individual Permit, issued June 6, 2012 USACE Action ID 2009-00439
Section 401 Individual Water Quality Certification, April 5, 2012, NCDENR-DWQ
Water Quality Certification Project No. 20120073

\$540.00 Debit WBS Element 34506.1.1

Dear Sir:

The North Carolina Department of Transportation (NCDOT) proposes to improve US 501 to a multilane facility from Roxboro to the Virginia State line. This project has 3 sections, A, B and C. Section A has independent utility from the others so it is being permitted separately. Sections B and C are post-year lets. Section A of this project (4.46 miles) will provide a small amount of widening along NC 49 then will take off on new location until it merges with Halifax Road (SR 1521) and then with US 501 to SR 1602 (Jesse Banks Road). The widening section of NC 49 will be a 5-lane curb and gutter. The new location segment and widening of Halifax Road and US 501 to SR 1602 will be 4-lane divided with a shoulder section.

This permit modification request is for revisions to the permit drawings and plan sheets and additional impacts to streams for items that were accidentally left off the drawings from previous meetings and a revision to Utility Site 1. Included with the permit modification is this cover letter, revised Stormwater management plan and revised permit drawings 3, 3a, 4, 5, 16, 17, 27, 28, 35, 36, 37, 38, 39, 40, 45, 46, 47, 48 of 48, revised Utility Site 1 drawings and revised plan sheets 4, 8, 15, 19, 20 and 22.

MAILING ADDRESS:
NC DEPARTMENT OF TRANSPORTATION
PROJECT DEVELOPMENT AND ENVIRONMENTAL ANALYSIS
NATURAL ENVIRONMENT SECTION
1598 MAIL SERVICE CENTER
RALEIGH NC 27699-1598

TELEPHONE: 919-707-6000
FAX: 919-212-5785
WEBSITE: WWW.NCDOT.ORG

LOCATION:
CENTURY CENTER BLDG. B.
1020 BIRCH RIDGE DR.
RALEIGH NC 27610

The revised design does not compromise NCDOT's compliance with the existing permit conditions. The revision has been evaluated for compliance with the avoidance/minimization criteria and is in compliance with all previous issues, including the following:

- Protected Species
- Aquatic Life passage
- FEMA compliance
- Cultural Resources.

Permit Drawing 3 of 48 (Plan Sheet 2-H)

- Detail 20 has been revised to reflect use of different size class of rip rap on the streambank based on the size of the pipe.
- Pre-formed scour holes at 25+80, 35+10 and 50+80 have been deleted from the project.
- An energy dissipator at 24+80 has been deleted from the project.
- Permanent Soil Reinforcement Matting added to the two other Energy Dissipators to help transition to natural ground.

New Permit Drawing 3a of 48(Plan Sheet 2H-2)

- Details 21-26 have been added to the project.
- New inlet channel details have been added that describe placement of different size classes of rip rap on the streambank based on the size of the pipe.
- New detail for construction of the low flow channel and flood plain sills has been added.
- Rip rap has been added to the benches of the multi-barrel detail

Site 1, Permit Drawings 4 and 5 of 48 (Plan Sheet 4)

- Rip rap has been depicted along the full limits of the streambank grading along the east bank at the culvert inlet.
- No changes to stream impacts have occurred.

Site 6, Permit Drawing 16 and 17 of 48 (Plan Sheet 8)

- Rip rap on both streambanks at the pipe outlet has been extend to the full limits of the flow line and back slope of Lateral 0.6 m base ditch lined with Class B rip rap. This has resulted in the following change to jurisdictional impacts:
 - increase of 7 linear feet of existing permanent channel impacts due to streambank stabilization and a decrease of 10 linear feet of existing temporary channel impacts. The stream impact summary sheet has been revised to reflect this change.
 - Total streambank stabilization impacts now total 23 feet and temporary impacts total 20 feet. This stream did not require any mitigation.

-A pre-formed scour hole located at 25+80 Lt has been deleted and replace with a rip rap pad. Note that there are no jurisdictional features located in this area.

Site 11, Permit Drawing 27 and 28 of 48 (Plan Sheet 15)

-Rip rap has been added on both streambanks at the pipe inlet to provide long-term stability. This is necessary due to the presence of a headwall installed at the pipe inlet. This has resulted in the following change to jurisdictional impacts:

- increase of 16 linear feet of existing permanent channel impacts due to streambank stabilization and a decrease of 17 linear feet of existing temporary channel impacts. The stream impact summary sheet has been revised to reflect this change.
- Total streambank stabilization impacts now total 52 feet and temporary impacts total 85 feet. This stream required mitigation.

Permit Drawing 35 and 36 of 48 (Plan Sheet 19)

The hydraulic design at this location has been slightly revised at this location.

- Revised the 200 PVC near Structure 1909 to tie to Junction Box.
- Shifted the outlet of the 200 PVC to the rip rap of the lateral base ditch near Structure 1903.
- Near Structure 1907, Class B rip rap checks were eliminated on natural ground. Also near Structure 1907, the rip rap on the banks of the lateral base ditch was changed to Class II.
- Near Structure 1910, the rip rap on the banks of the lateral base ditch was changed to Class II.
- Permanent soil reinforcement matting was added to the lateral base ditch on the right side.
- This has resulted in no changes to stream impacts.

Site 17, Permit Drawing 37 of 48 (Plan Sheet 20)

-Rip rap on both streambanks at the pipe inlet has been extended to go past the outlet of the adjacent 375 mm pipe structure. This will provide long-term stability of the streambank at this location. This has resulted in the following change of impacts:

- decrease of 2 linear feet of existing permanent channel impacts due to a recalculation of fill impacts, increase of 31 linear feet of existing permanent channel impacts due to streambank stabilization and a decrease of 39 linear feet of existing temporary channel impacts. The stream impact summary sheet has been revised to reflect this change.
- Total streambank stabilization impacts now total 67 feet and temporary impacts total 23 feet.

Site 18, Permit Drawing 39 of 48 (Plan Sheet 22)

-Class B rip rap depicted at tail end of the Special Lateral 0.6 m Base Ditch has been slightly extended to the edge of the flow line of the stream channel. Additionally, Class I rip rap pads have been added in the flow line of the channel at the outlet of the 750 mm and 900 mm pipe structures. The rip rap pads will be countersunk below the flow line of the channel to prevent formation of scour washes in the downstream channel. This has resulted in the following change of impacts:

- decrease of 10 linear feet of existing permanent channel impacts due to a recalculation of fill impacts, increase of 32 linear feet of existing permanent channel impacts due to streambank stabilization and a decrease of 22 linear feet of existing temporary channel impacts. The stream impact summary sheet has been revised to reflect this change.
- Total streambank stabilization impacts now total 42 feet and temporary impacts total 181 feet.

Utility Site 1, Permit Drawings 1 and 2 of 2 (Plan Sheet 5)

-Due to the phasing of the culvert at this site the gas main needs to be relocated for constructability issues. The gas main will be put between the water and sewer lines and all three will be constructed at the same time. The gas main will increase the temporary stream impacts at this site by 2 feet.

MITIGATION

With this modification there was a decrease of 12 feet of permanent fill to streams requiring mitigation, an increase of 86 feet of streambank stabilization and a decrease of 86 feet of temporary impacts (Table 1). Only streams at Sites 11, 17 and 18 required mitigation. The stream at Site 6 did not require mitigation. See attached revised Table 2 from the Permit Application.

Table 1. Changes in impacts and mitigation.

	Permanent Stream Fill (ft)	Streambank Stabilization (ft)	Temporary Stream Impacts (ft)	Permanent stream Impacts Requiring Mitigation¹
Original Permit Impacts	3,393	439	858	3,196
Permit Modification Impacts	3,381	525	772	3,184
Increase(+)/ Decrease(-)	-12	+86	-86	-12

¹Required mitigation from USACE


Required mitigation by NCDWQ is now 3,666 feet. Required mitigation for USACE is now 3,184 feet. The USACE mitigation (2:1) still exceeds NCDWQ's required mitigation. No additional mitigation is proposed.

REGULATORY APPROVALS

Application is hereby made for a modification to the Department of the Army Section 404 Individual Permit as required for the above-described activities for the proposed TIP project R-2241A. We are also hereby requesting a Modification to the Individual Section 401 Water Quality Certification from the Division of Water Quality. In compliance with Section 143-215.3D(e) of the NCAC, we will provide \$540 to act as payment for processing the Section 401 permit. We are providing five copies of this application to the North Carolina Department of Environment and Natural Resources, Division of Water Quality, for their review and approval.

A copy of this application will be posted on the NCDOT website at <http://www.ncdot.org/doh/preconstruct/pe/neu/Permit.html>. If you have any questions or need additional information, please call Rachelle Beaugard at 919-707-6105.

Sincerely,

for 

Gregory J. Thorpe, Ph.D., Manager
Project Development and Environmental Analysis Unit

Cc: NCDOT Standard Permit Application Distribution List

Revised Table 2. R-2241A Streams Impacted

Permit Site No.	Stream ID in EA ¹	JD Package ID	Stream Name	Intermittent/ Perennial	Permanent Impacts		Temporary Impacts	Impacts requiring mitigation ³
					Fill	SBS ²		
1	S-13	1A	Marlowe Creek	Perennial	Fill	138	26	138
					SBS ²	125		
Utility Site 1	S-13	1A	Marlowe Creek	Perennial	0		8	0
3	*	2A	UT to Marlowe Creek	Intermittent	Fill	23	0	0
4	S-14	3A	UT to Marlowe Creek	Perennial	Fill	112	39	112
					SBS	59		
6	*	4A	UT to Marlowe Creek	Intermittent	Fill	23	20	0
					SBS	23		
7A	S-16	4AA	UT to Marlowe Creek	Perennial	Fill	518	108	518
					SBS	82		
7B	S-16	4AB	UT to Marlowe Creek	Intermittent	Fill	59	0	0
8	*	8A	UT to Marlowe Creek	Perennial	Fill	194	36	194
					SBS	13		
9	*	9A	UT to Marlowe Creek	Perennial	Fill	279	33	279
					SBS	16		
10	S-29	10A, 11A	UT to Mitchell Creek	Both Intermittent	Fill	92	43	0
					SBS	20		
11	S-30	12A	UT to Mitchell Creek	Perennial	Fill	282	85	282
					SBS	52		
13	S-23	14A	UT to Mitchell Creek	Perennial	Fill	246	72	246
14	S-24	15A, 16A	UT to Mitchell Creek	Both Perennial	Fill	262	23	262
					SBS	13		
15	S-25	17A	Mitchell Creek	Perennial	Fill	653	75	653
					SBS	13		
17	*	2B	UT to Mitchell Creek	Perennial	Fill	146	23	146
					SBS	67		
18	*	3B, 4B	UT to Mill Creek	Both Perennial	Fill	354	181	354**
					SBS	42		
Total					Fill	3,381	772	3,184
					SBS	525		

*Not stated in EA **The 42 feet of mitigation for SBS required mitigation from DWQ but not counted here because total mitigation for the USACE exceeds DWQ mitigation

¹Location IDs are a best guess based on EA map

²Stream Bank Stabilization

³Mitigation required by USACE



General Project Information

Project No.:	R-2241A	Date:	10/11/2011
City/Town:	Roxboro	Designer:	SDG
County(ies):	Person County	Project Manager:	WHW
River Basin(s):	Roanoke	CAMA County?	no
Primary Receiving Water:	Marlowe Creek, Mitchell Creek, Mill Creek	TVA County?	no
NCDWQ Surface Water Classification for Primary Receiving Water	Marlowe Creek, Mitchell Creek, Mill Creek	NCDWQ Stream Index:	22-58-12-6, 22-58-12-6-3, 22-58-15-2
Primary:	Class C		
Supplemental:			
Other Stream Classification:		Marlowe Creek	Ecological/ Biological
303(d) Stream?	yes		Integrity Benthos
State Stormwater Permit Required?	no		
Could the Project Impact Threatened or Endangered Species?	no		
Description:			
Anadromous Fish Present?	no		
Description:			
Buffer Rules in Effect?	no	Buffer Rules:	

Existing Site

Description of Existing Project Area:	Rural Farmland, Rolling Hills
Average Daily Traffic (existing):	21,725
Existing Cross Section:	2-Lane Shoulder Section
Surrounding Land Use:	Farming, Agriculture
General Comments:	

Project Description

Description of Proposed Project:	New Location 4-Lane Divided Highway
Average Daily Traffic (proposed):	34,142
Proposed Cross-Section:	5-Lane Curb and Gutter, 4-Lane Divided Highway
Interchange Modification:	no
North Terminus:	Existing US 501
South Terminus:	Existing US 501/NC49 Intersection
Project Length (lin. miles/feet):	4.46 Miles
General Comments:	Added Impervious Area (ac.): 29 ac



Revised
6/15/12

Version 1.1

North Carolina Department of Transportation
Highway Stormwater Program
STORMWATER MANAGEMENT PLAN



Released: July 2010 (DRAFT)

Environmental Summary

Riparian Buffer and Jurisdictional Stream Impacts and Associated SCMs


Station	Stream Name	Stream Type	Jurisdictional Stream	Buffer?	Classification?	Proposed Structure	SCM Type	Checklist Complete?	DA (ac.)	Q ₂ (ft ³ /s)	Q ₁₀ (ft ³ /s)	WQV ^c (ft ³)
13+28 to 13+62 -L-	Marlowe Creek	Perennial		No	Class C	3 @ 3m x 3m RCBC to PSH	preformed scour hole	no	2	6.4	8.5	
19+21 to 19+23 -L- RT	UT to Marlowe Creek			No	Class C	Fill	no	no				
20+84 to 20+89 -L-	UT to Marlowe Creek	Perennial		No	Class C	2 @ 2.4m x 2.4m RCBC	swale	no	1.4	3	3.9	
24+98 to 25+10 -L- RT	UT to Marlowe Creek			No	Class C	900mm RCP	swale	no	1.9	5.3	6.9	
34+93 to 36+38 -L-	UT to Marlowe Creek	Perennial		No	Class C	2.7m x 1.8m RCBC to PSH	preformed scour hole	no	1.8	4.3	5.7	
37+33 to 37+55 -L-	UT to Marlowe Creek			No	Class C	1050mm RCP	swale	no	2.5	5.6	7.4	
40+05 to 40+70 -L-	UT to Marlowe Creek			No	Class C	1500mm RCP	swale	no	10.1	22	29	
11+55 to 11+82 -Y13- LT	UT to Mitchell Creek			No	Class C	900mm CSP	no	no				
50+41 to 51+25 -L-	UT to Mitchell Creek			No	Class C	1200mm RCP to PSH	preformed scour hole	no	1	2.1	2.8	
53+13 to 53+79 -L-	UT to Mitchell Creek			No	Class C	900mm RCP	swale	no	3.3	6.4	8.5	
57+12 to 57+55 -L-	UT to Mitchell Creek			No	Class C	1200mm RCP	swale	no	8.1	15.7	20.7	
63+41 to 66+32 -L-	Mitchell Creek			No	Class C	1350mm RCP 375mm to PSH	preformed scour hole	no	0.5	1.1	1.4	
64+72 to 64+99 -L- LT	UT to Mitchell Creek			No	Class C	Pond Removal	no	no				
67+35 to 69+11 -L-	UT to Mitchell Creek			No	Class C	1350mm RCP	swale	no	10.8	22	29	
76+03 to 76+90 -L-	UT to Mill Creek			No	Class C	750mm/900mm RCP	swale	no	6.4	12.9	17	
77+72 to 79+54 -L-	UT to Mill Creek			No	Class C	Fill	no	no				










General Comments:

Jurisdictional Wetlands

Station	Type of Impact	Minimization of Impact
15+12 to 15+59 -L-LT	Fill, Excavation and Mechanized Clearing in wetland	3:1 Fill Slopes
20+89 to 21+45 -L-	Fill and Mechanized Clearing in wetland	2:1 Fill Slopes
34+93 to 36+38 -L-	Fill in wetland	2:1 Fill Slopes
37+33 to 37+55 -L-	Fill, Excavation and Mechanized Clearing in wetland	2:1 Fill Slopes
50+41 to 51+25 -L-	Fill in wetland	2:1 Fill Slopes
51+47 to 51+91 -L-	Fill in wetland	2:1 Fill Slopes
53+13 to 53+79 -L-	Fill, Excavation and Mechanized Clearing in wetland	2:1 Fill Slopes
57+12 to 57+55 -L-	Fill in wetland	2:1 Fill Slopes
63+41 to 66+32 -L-	Fill and Mechanized Clearing in wetland	2:1 Fill Slopes
67+35 to 69+11 -L-	Fill, Excavation and Mechanized Clearing in wetland	3:1 Fill Slopes
78+00 to 79+08 -L-	Fill and Mechanized Clearing in wetland	3:1 Fill Slopes
General Comments:		

REVISIONS

	PROJECT REFERENCE NO. R-2241A	SHEET NO. 2H-2
	R/W SHEET NO.	
NOT TO SCALE	ROADWAY DESIGN ENGINEER	PAVEMENT DESIGN ENGINEER
	PRELIMINARY PLANS DO NOT USE FOR CONSTRUCTION	
CONST. REV.		
R/W REV.		

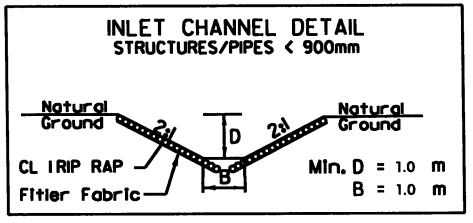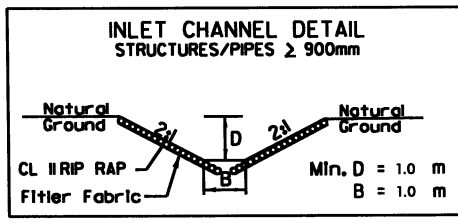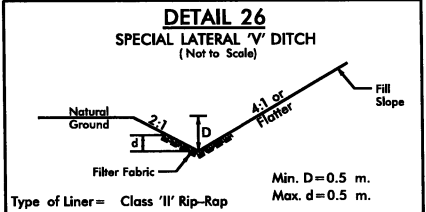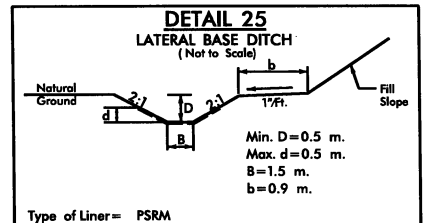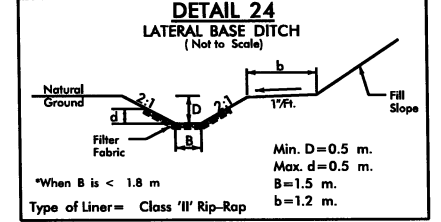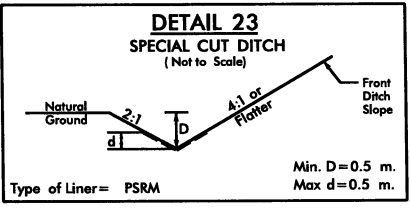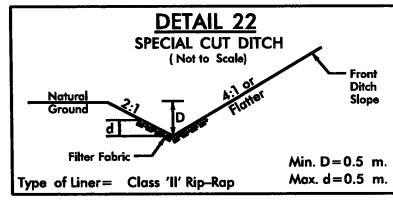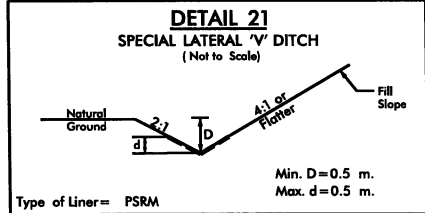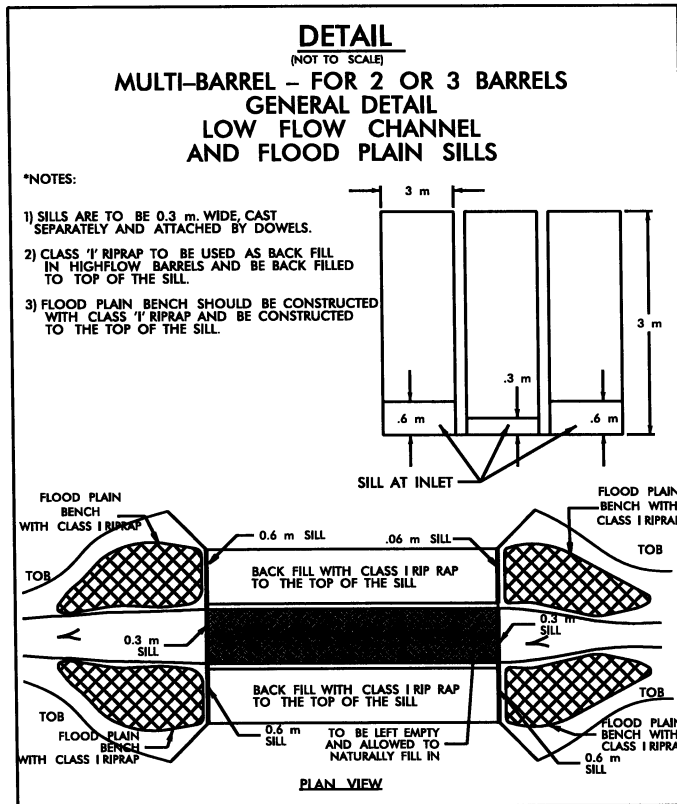

Revised 7/5/12
 Permit Drawing
 Sheet 39 of 48

CONSULTING ENGINEERS
 100 N. W. 10th St.
 CHARLOTTE, NORTH CAROLINA 28202

REVISIONS

METRIC

PROJECT REFERENCE NO. R-2241A SHEET NO. 2H

R/W SHEET NO.
























ROADWAY DESIGN ENGINEER PAVEMENT DESIGN ENGINEER

PRELIMINARY PLANS
DO NOT USE FOR CONSTRUCTION


NOT TO SCALE

CONST. REV.



R/W REV.

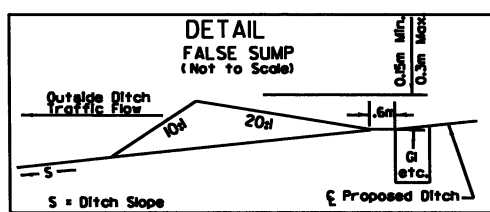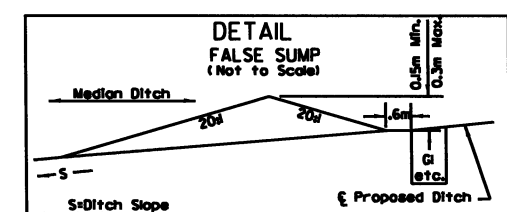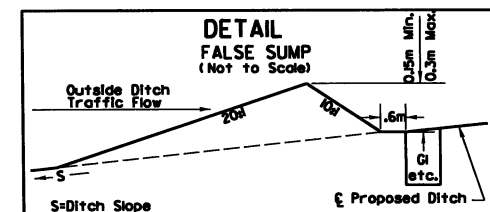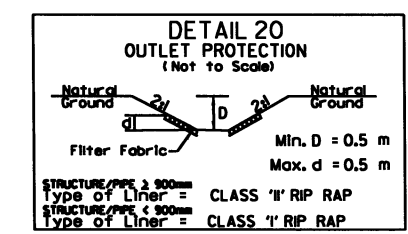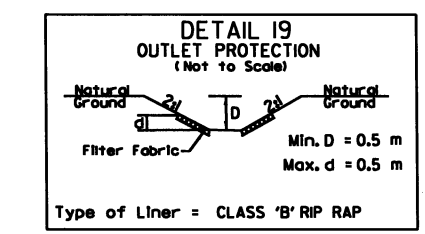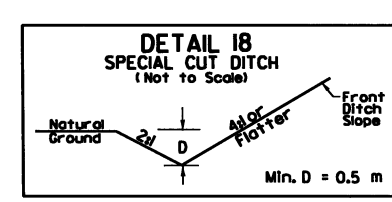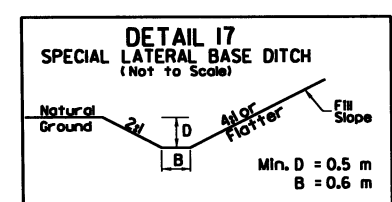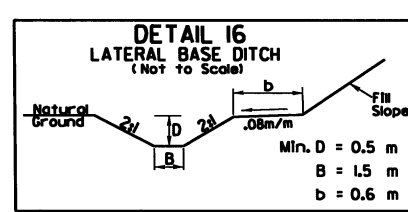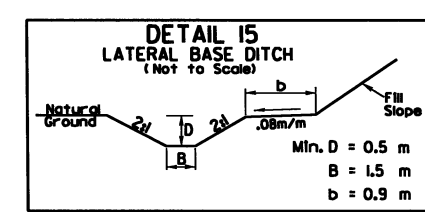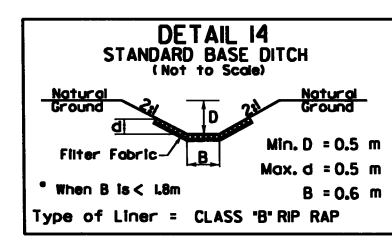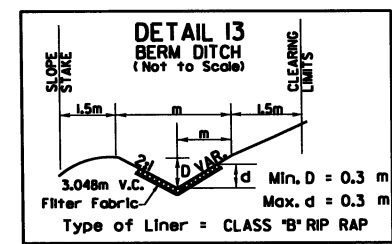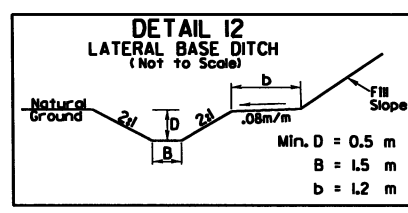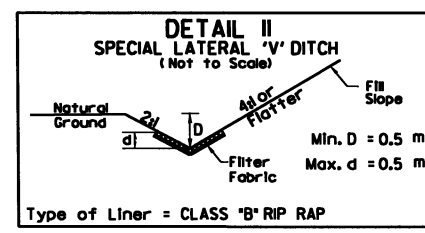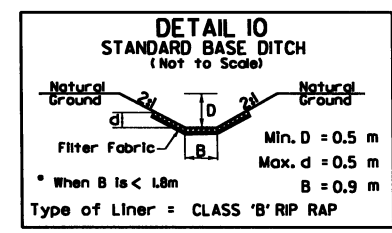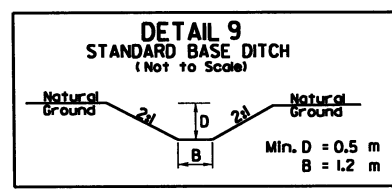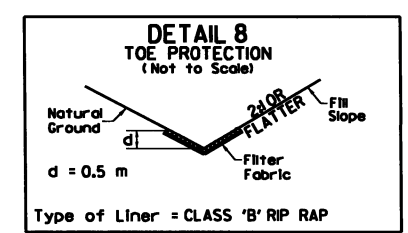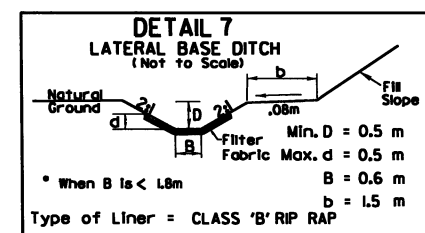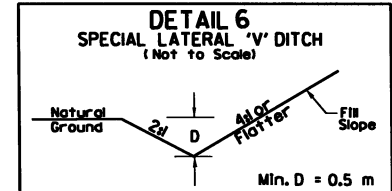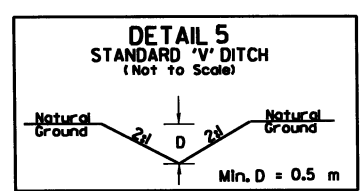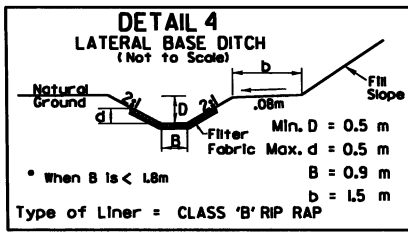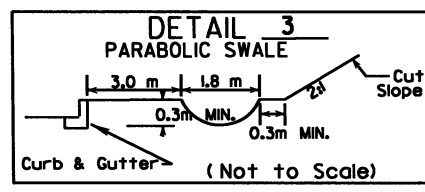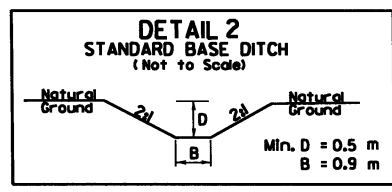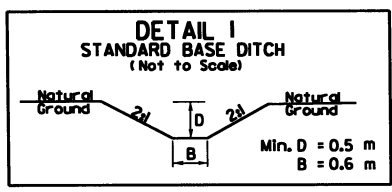

Revised 7/5/12
Permit Drawing
Sheet 3 of 48

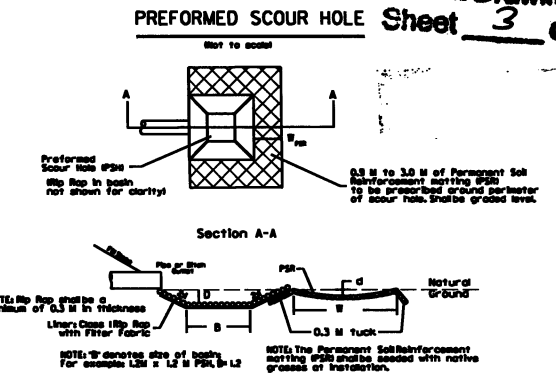


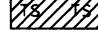
STATION	B (M)	D (M)	W _{PSR} (M)	d (M)	CLASS I RIP RAP (M TONS)	DDE (CU M)	FILTER FABRIC (SQ M)
13+80 -L-	1.4	.5	1.5	0.15	8.2	11.5	1.2
33+60 -L-	1.4	.5	1.5	0.15	8.2	11.5	1.2
36+60 -L-	1.4	.5	1.5	0.15	8.2	11.5	1.2
48+30 -L-	1.8	.5	1.5	0.15	11.5	15	1.7
50+26 -L-	1.4	.5	1.5	0.15	8.2	11.5	1.2
52+00 -L-	1.2	.5	1.5	0.15	6.5	10.0	1.0
66+60 -L-	1.2	.5	1.5	0.15	6.5	10.0	1.0

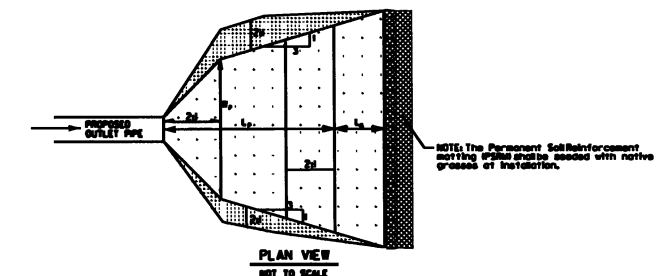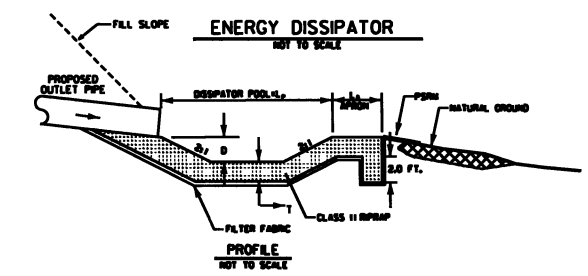

STATION	L _P (M)	W _P (M)	L _A (M)	T (M)	D (M)	CLASS I RIP RAP (M TONS)	DDE (CU M)	FILTER FABRIC (SQ M)
20+70 -L-	8.0	5.0	1.8	.6	1.0	110	86	75
39+80 -L-	7.0	4.3	2.0	.6	1.0	120	95	85

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 1000 West MacArthur St. Ste. 200
 Charlotte, NC 28208
 NC License Number F-0991

REVISIONS	
06-04-08	ESTABLISHED ACCESS POINT ON PARCEL 41 AND CHANGED NAME ON PARCEL 40
06-21-10	PARCEL 41 REVISED PARCEL NAME
08-28-10	PARCEL 41 REVISED PARCEL INFORMATION
02-01-11	PARCEL 37, ADDED SEPTIC LINE PARCEL 38, ADDED WELL PARCEL 39, ADDED SEPTIC LINE
08-02-11	COMBINED PARCELS 43A-43G INTO TRACTS (A-I) DENOTING EACH ACCORDINGLY
09-09-11	PARCEL 35, REVISED OWNER NAME

 DENOTES IMPACTS IN SURFACE WATER
 DENOTES TEMPORARY IMPACTS IN SURFACE WATER

METRIC




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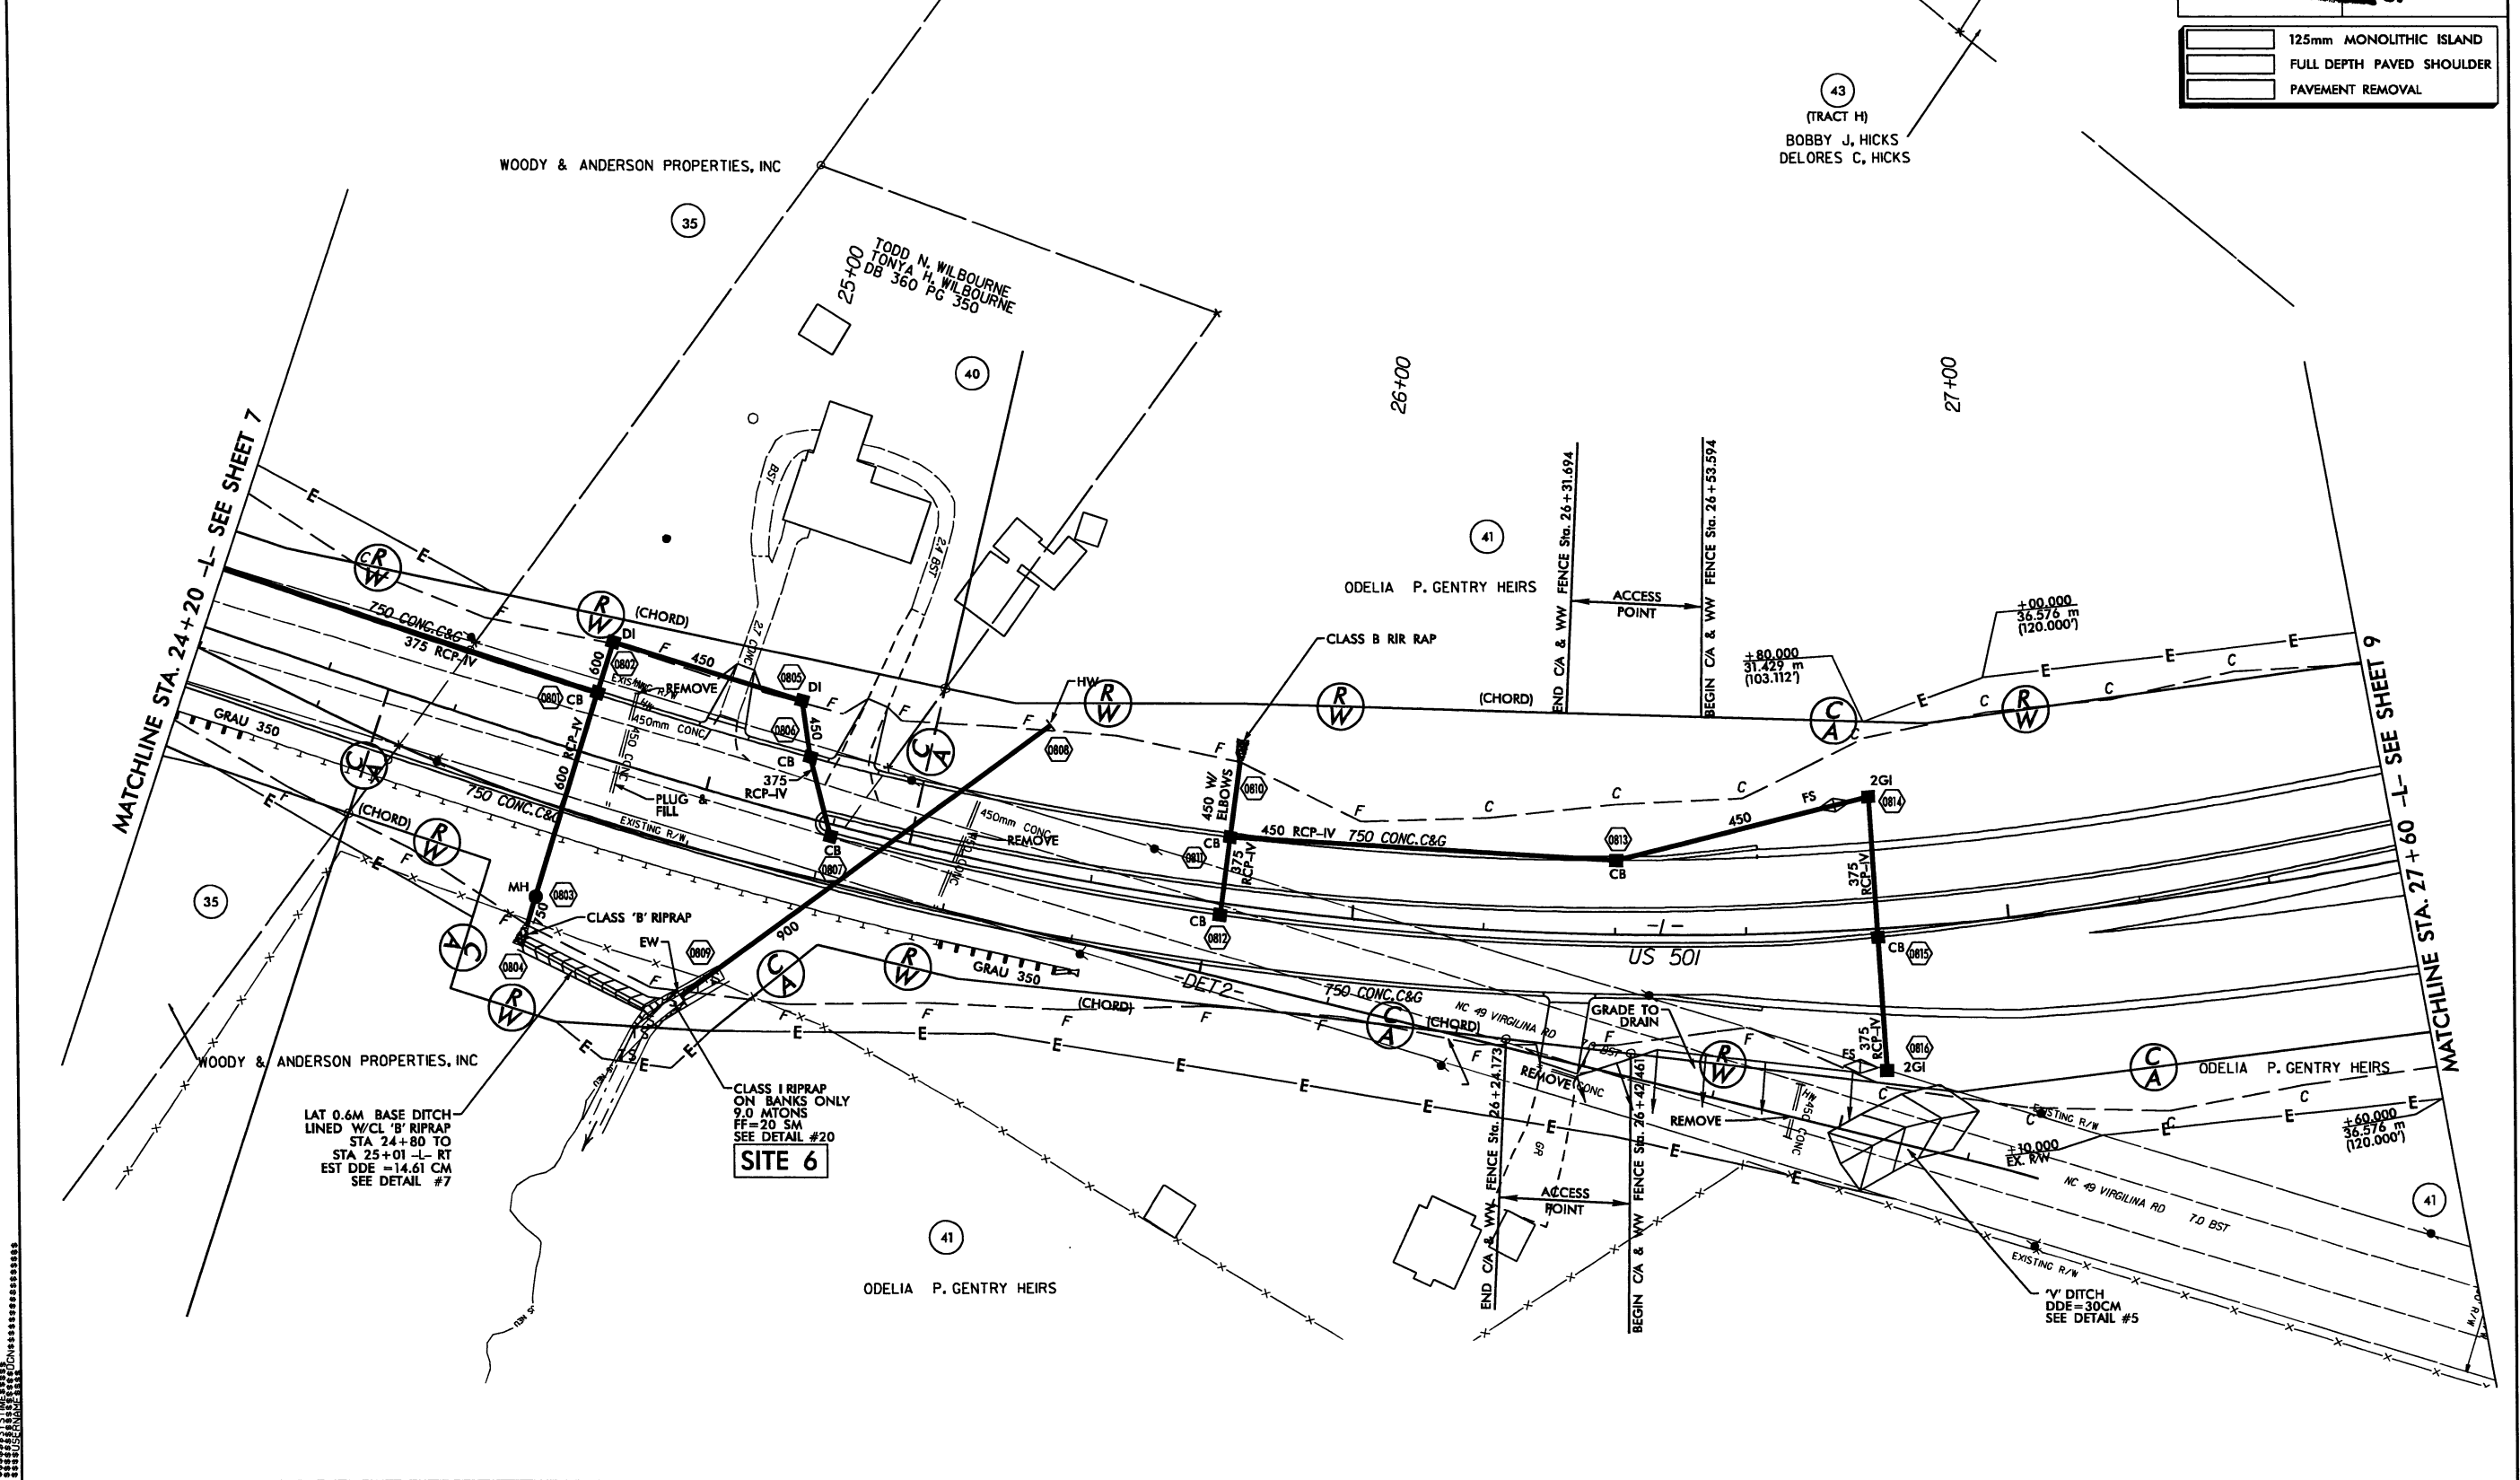
CONSTR. REV.
R/W REV.

PROJECT REFERENCE NO. R-2241A	SHEET NO. 8
R/W SHEET NO.	
ROADWAY DESIGN ENGINEER	HYDRAULICS ENGINEER

PRELIMINARY PLANS
DO NOT USE FOR CONSTRUCTION


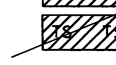
Revised 6/15/12
Permit Drawing
Sheet 16 of 48

	125mm MONOLITHIC ISLAND
	FULL DEPTH PAVED SHOULDER
	PAVEMENT REMOVAL

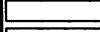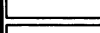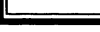


STV/Ralph Whithead Associates, Inc.
 1000 West Morehead St., Ste. 200
 Charlotte, NC 28208
 NC License Number F-5091




REVISIONS	
06-04-08	ESTABLISHED ACCESS POINT ON PARCEL 4 AND CHANGED NAME ON PARCEL 40
06-21-10	PARCEL 4H REVISED PARCEL NAME
08-28-10	PARCEL 4H REVISED PARCEL INFORMATION
02-01-11	PARCEL 37H ADDED SEPTIC LINE PARCEL 38H ADDED WELL PARCEL 39H ADDED SEPTIC LINE
06-02-11	COMBINED PARCELS 43A-43G INTO TRACTS (A-I), DENOTING EACH ACCORDINGLY
08-09-11	PARCEL 35: REVISED OWNER NAME


 DENOTES IMPACTS IN SURFACE WATER
 DENOTES TEMPORARY IMPACTS IN SURFACE WATER

METRIC

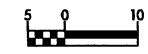

CONST. REV.
 R/W REV.

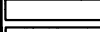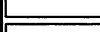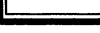PROJECT REFERENCE NO. R-2241A	SHEET NO. 8
R/W SHEET NO.	HYDRAULICS ENGINEER
ROADWAY DESIGN ENGINEER	
PRELIMINARY PLANS DO NOT USE FOR CONSTRUCTION	
Permit Drawing Sheet 17 of 48 Revised 6/15/12	
	125mm MONOLITHIC ISLAND
	FULL DEPTH PAVED SHOULDER
	PAVEMENT REMOVAL

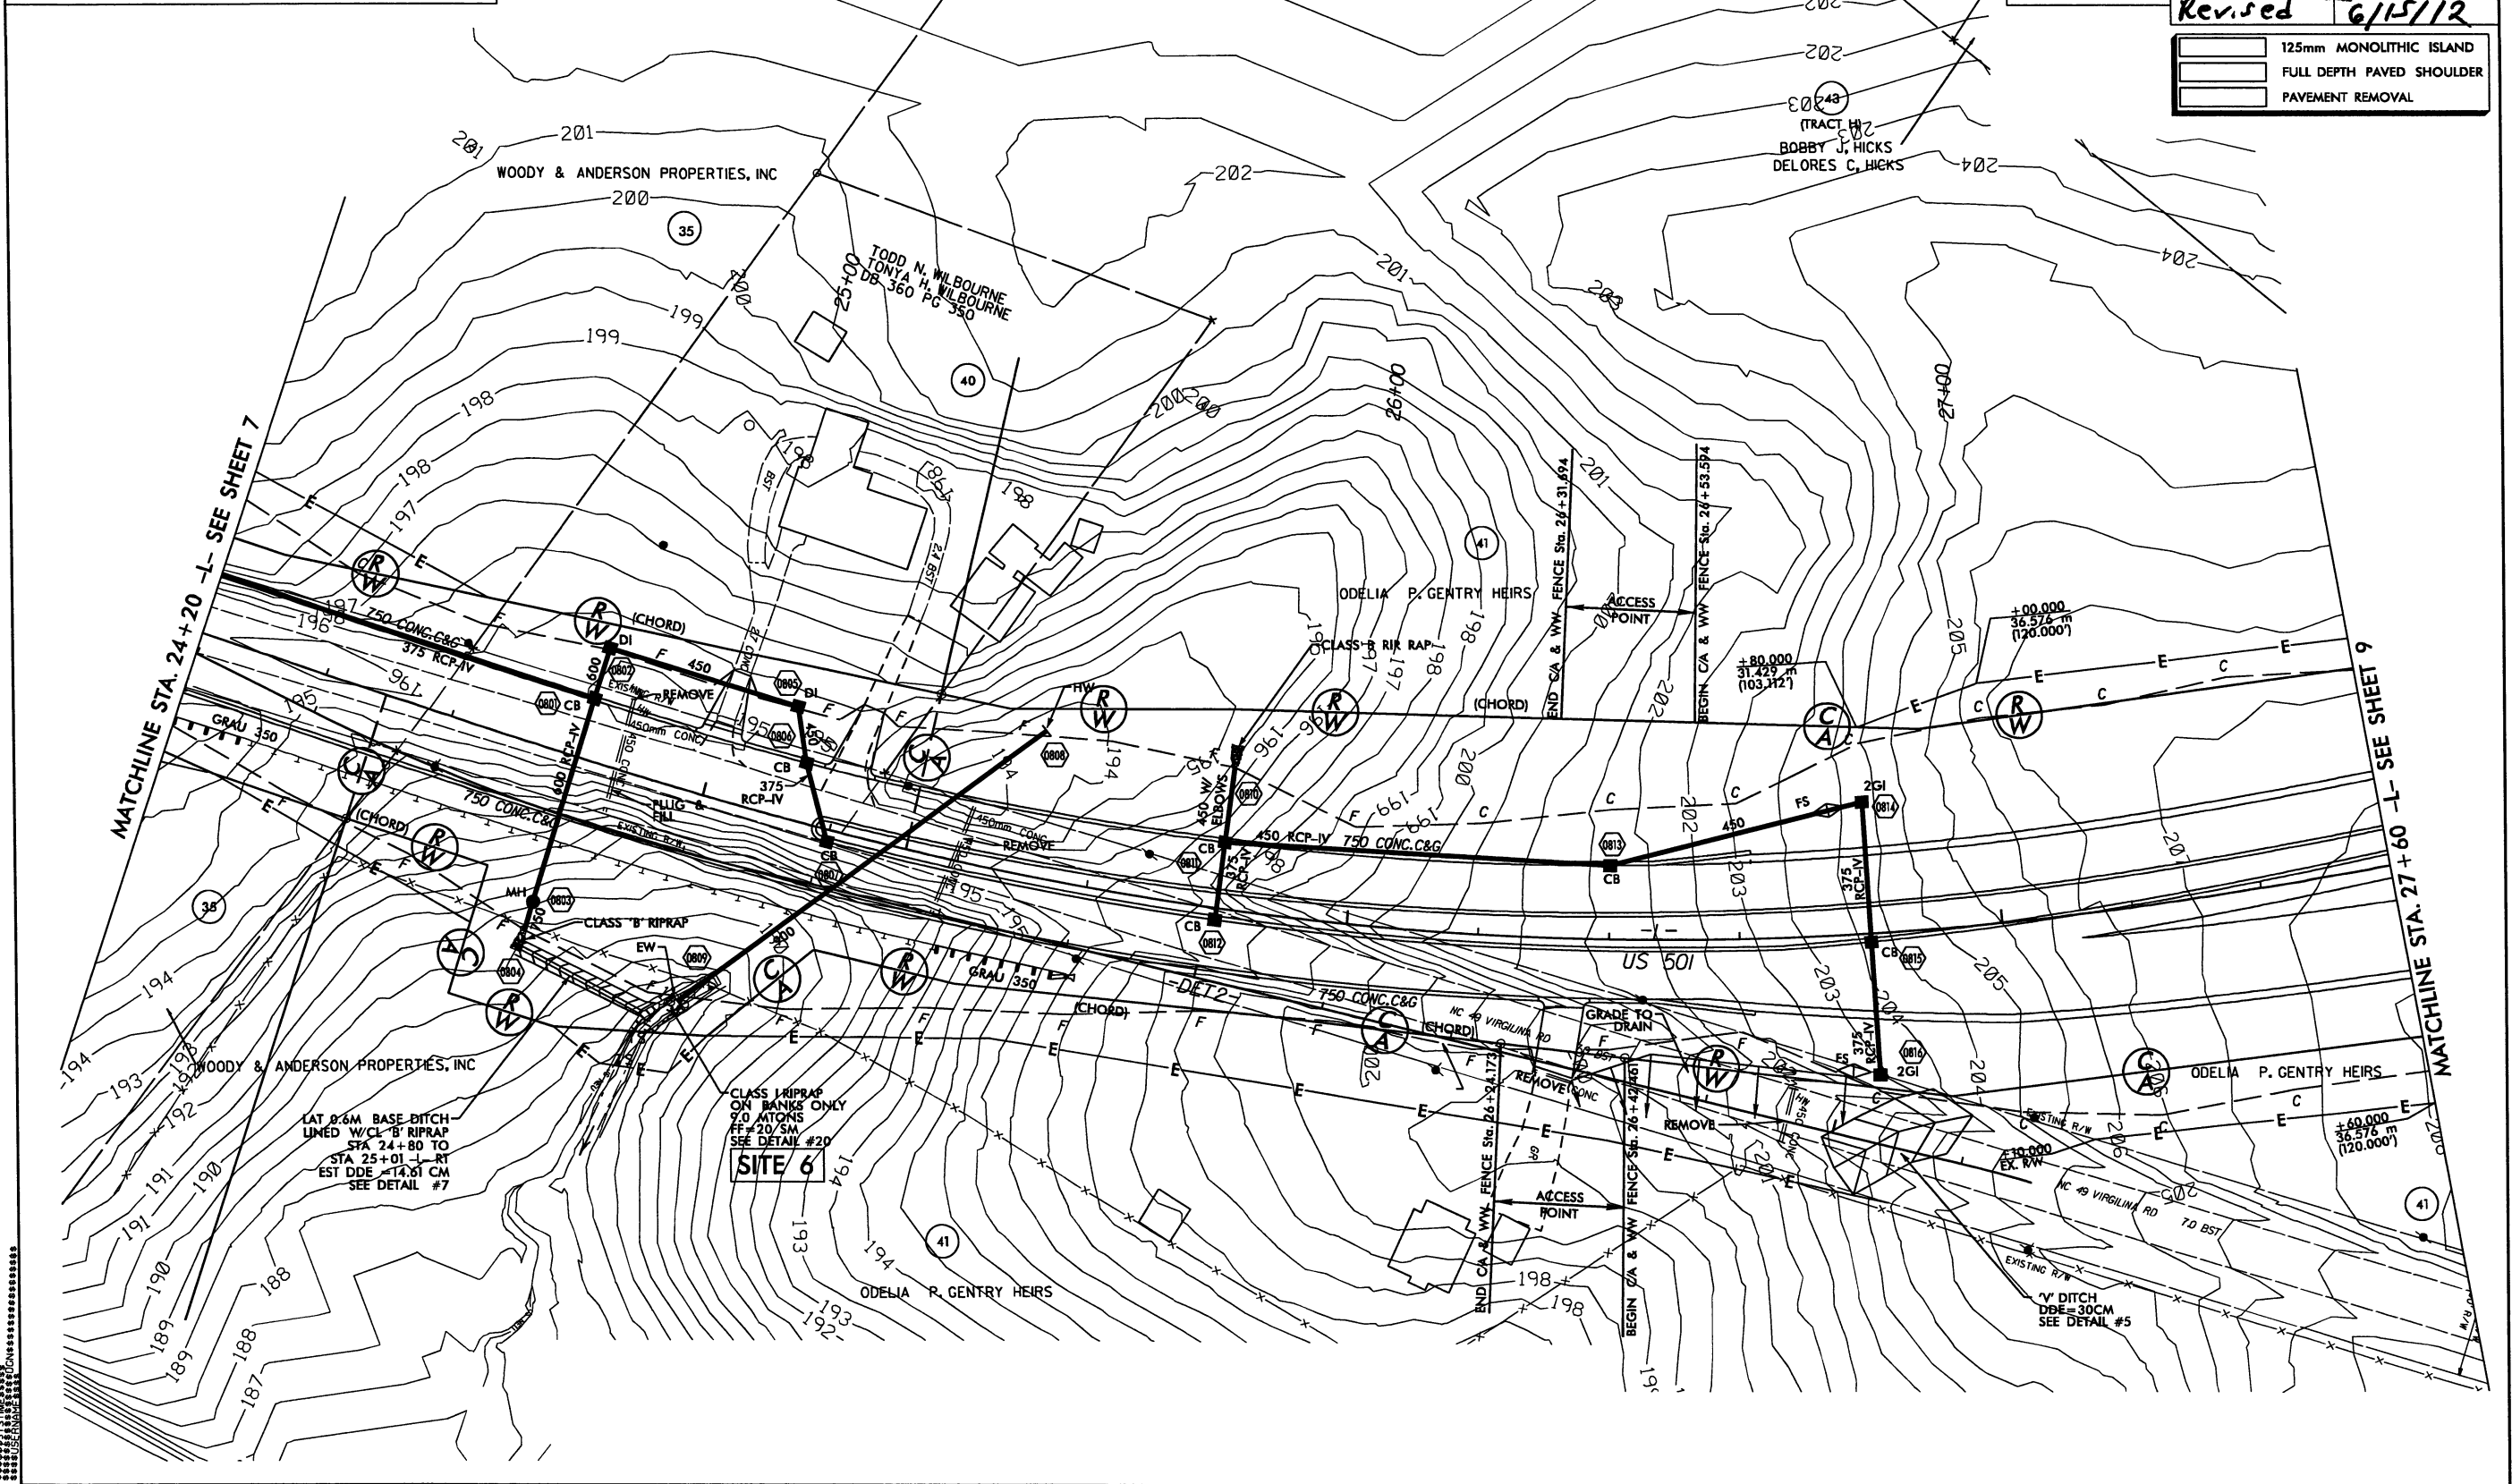

DATE PLOTTED: 06/15/12
 PLOTTER: HP DesignJet 5000PS
 PLOT SCALE: 1"=40'

STV/Ralph Whithead Associates, Inc.
 1000 West Market Street, Suite 200
 Charlotte, NC 28208
 NC License Number F-0991



REVISIONS	
06-04-08	NAME CHANGE ON PARCEL 79, AND ESTABLISHED ACCESS POINT ON PARCEL 77, 78
06-21-10	PARCELS 77, 78; REVISED PARCEL NAME
08-28-10	PARCEL 78; REVISED PARCEL INFORMATION
08-02-11	CHANGED PROPERTY OWNER INFORMATION ON PARCEL 79
08-03-11	PARCEL 76 & 78; REVISED OWNER NAME / PARCEL INFORMATION

METRIC

CONSTR. REV.
R/W REV.

PROJECT REFERENCE NO. R-2241A	SHEET NO. 15
R/W SHEET NO.	
ROADWAY DESIGN ENGINEER	HYDRAULICS ENGINEER
PRELIMINARY PLANS DO NOT USE FOR CONSTRUCTION Permit Drawing Sheet 27 of 48 Revised 6/15/12	
	125mm MONOLITHIC ISLAND
	FULL DEPTH PAVED SHOULDER
	PAVEMENT REMOVAL

- DENOTES FILL IN WETLAND
- DENOTES IMPACTS IN SURFACE WATER
- DENOTES TEMPORARY IMPACTS IN SURFACE WATER

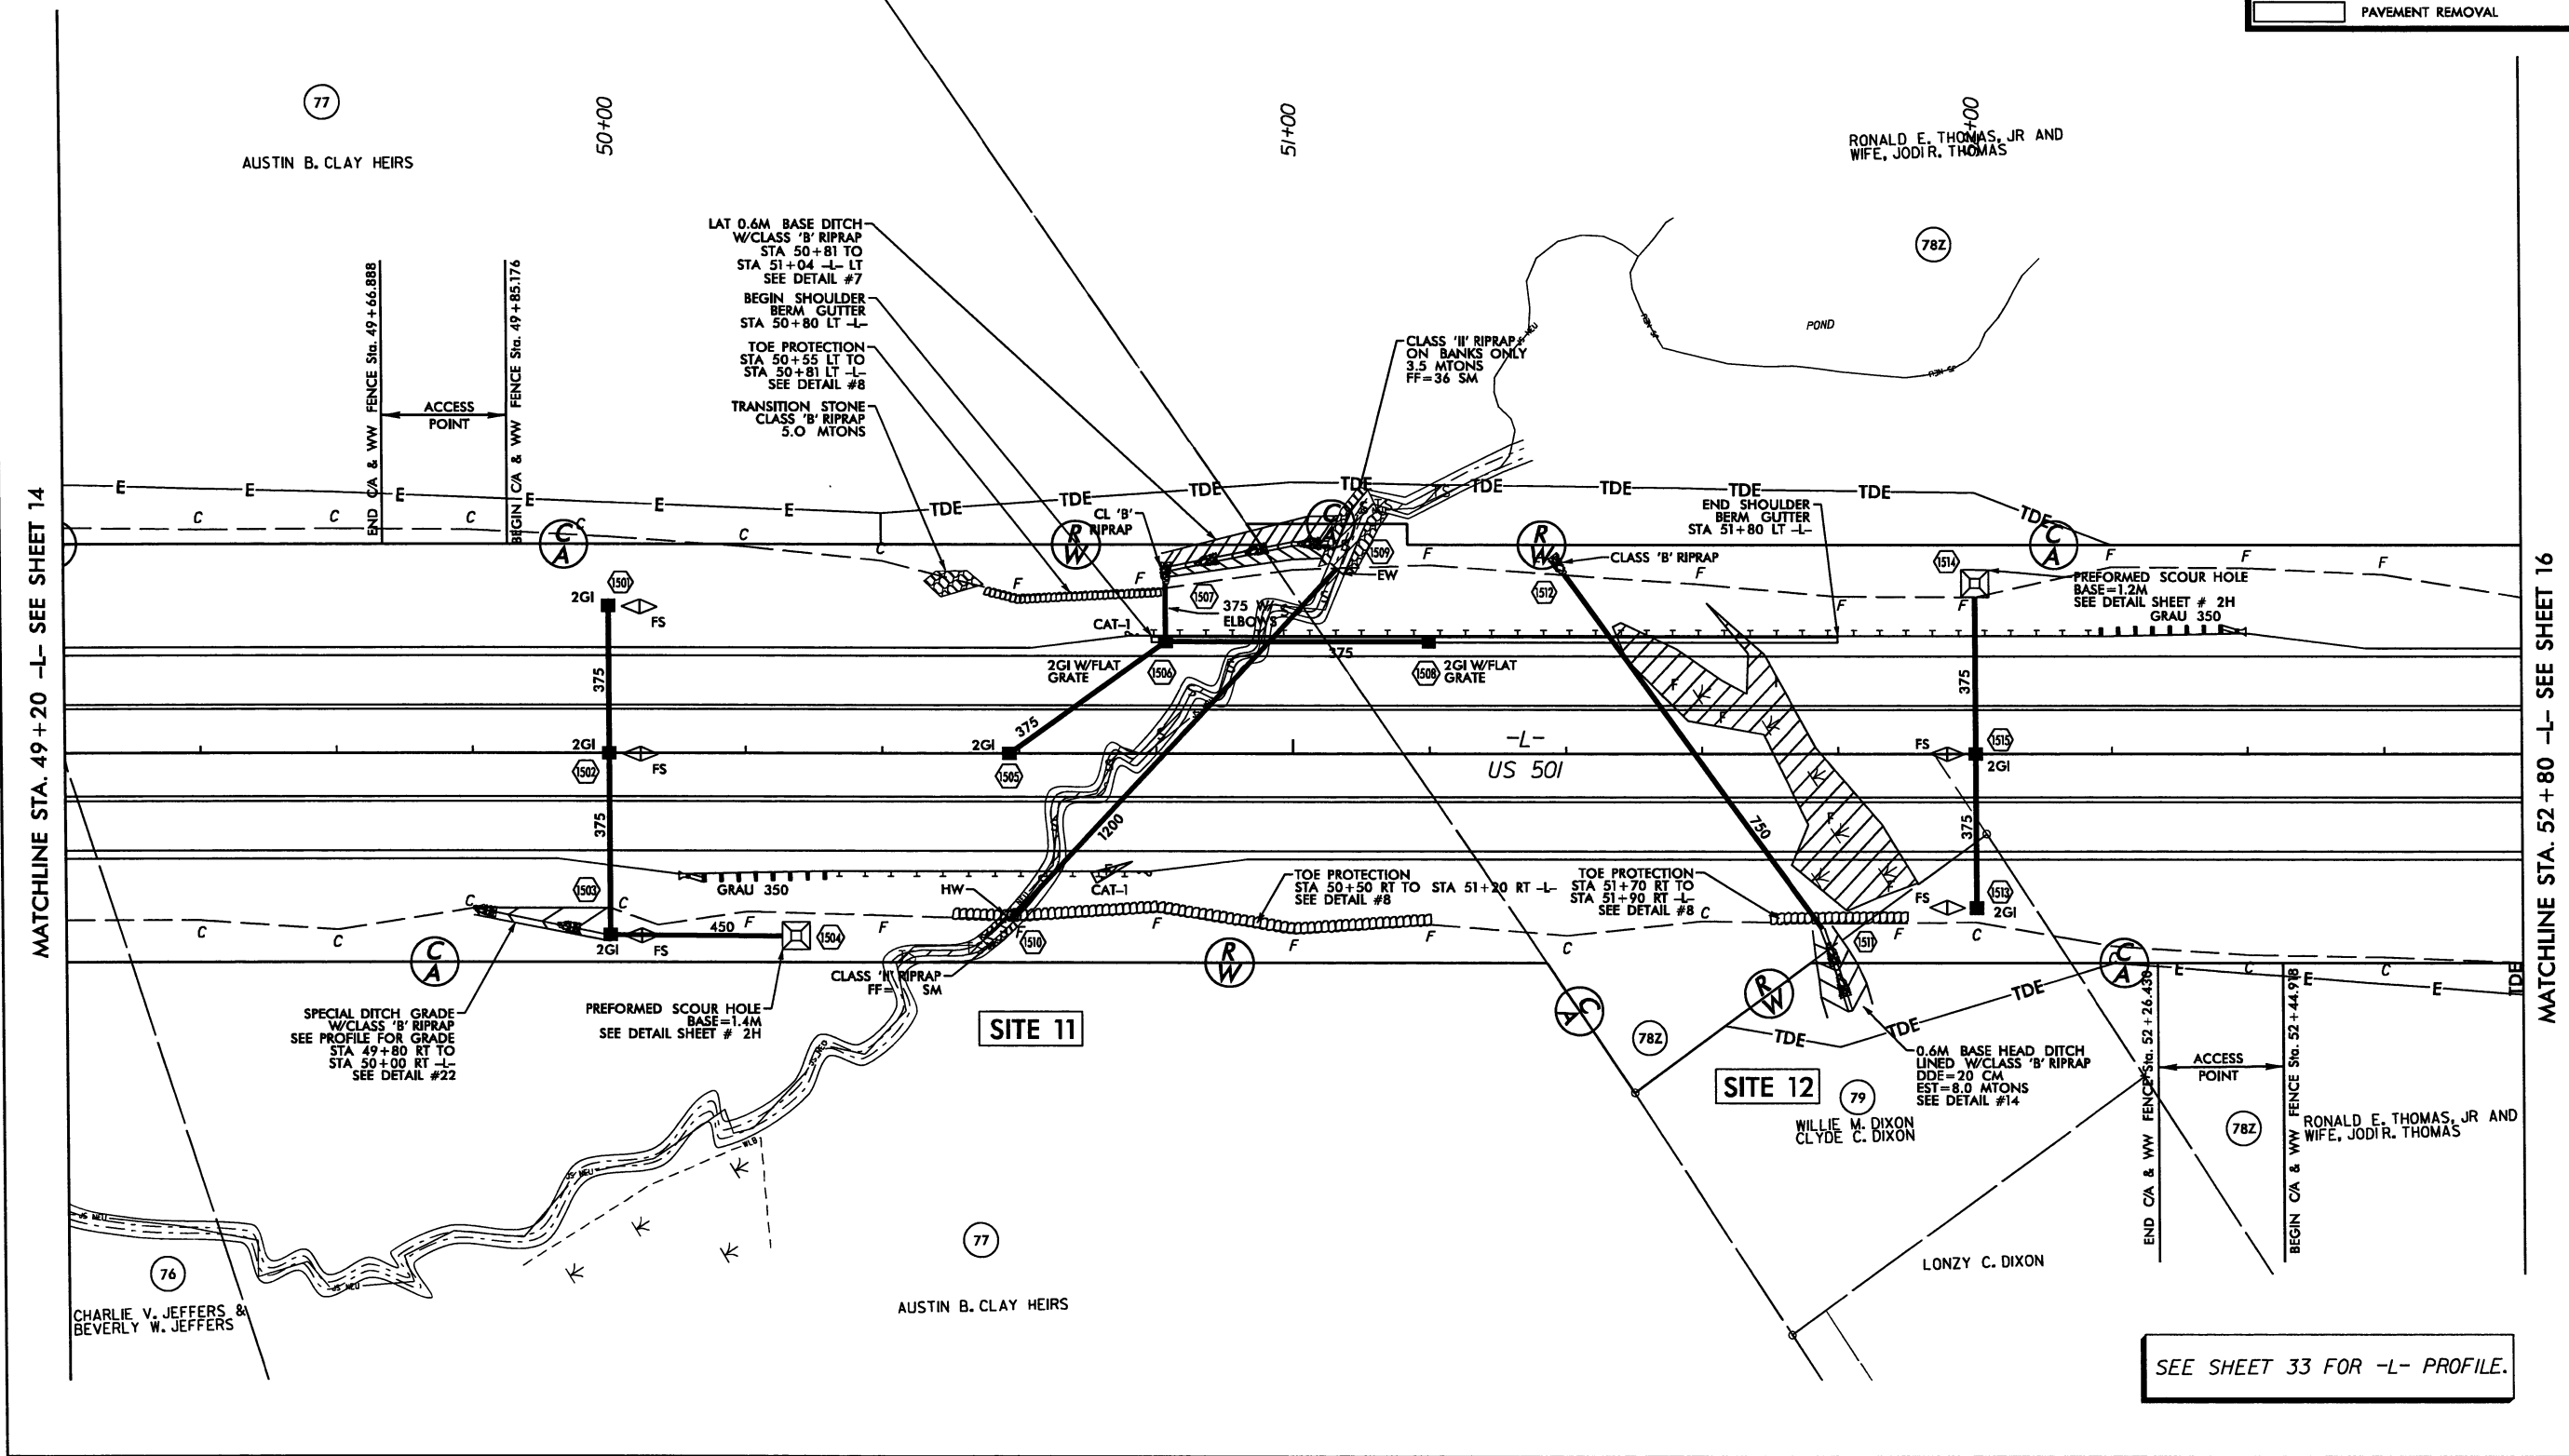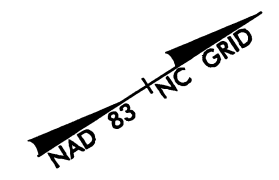




MATCHLINE STA. 49+20 -L- SEE SHEET 14

MATCHLINE STA. 52+80 -L- SEE SHEET 16




SEE SHEET 33 FOR -L- PROFILE.


STV / Ralph Whithead Associates, Inc.
 1000 West Morehead St., Ste 200
 Charlotte, NC 28203
 NC License Number F-0991

REVISIONS	
05-04-08	NAME CHANGE ON PARCEL 79 AND ESTABLISHED ACCESS POINT ON PARCEL 77,78
05-21-08	PARCELS 77,78, REVISED PARCEL NAME
08-28-08	PARCEL 78, REVISED PARCEL INFORMATION
08-02-11	CHANGED PROPERTY OWNER INFORMATION ON PARCEL 79
08-08-11	PARCEL 76 & 78, REVISED OWNER NAME / PARCEL INFORMATION

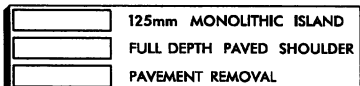  CONST. REV. R / W REV.	PROJECT REFERENCE NO. R-2241A	SHEET NO. 15
	ROADWAY DESIGN ENGINEER	HYDRAULICS ENGINEER
PRELIMINARY PLANS DO NOT USE FOR CONSTRUCTION		
		125mm MONOLITHIC ISLAND FULL DEPTH PAVED SHOULDER PAVEMENT REMOVAL

NAD 83 NC GRID

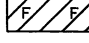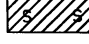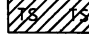-  DENOTES FILL IN WETLAND
-  DENOTES IMPACTS IN SURFACE WATER
-  DENOTES TEMPORARY IMPACTS IN SURFACE WATER

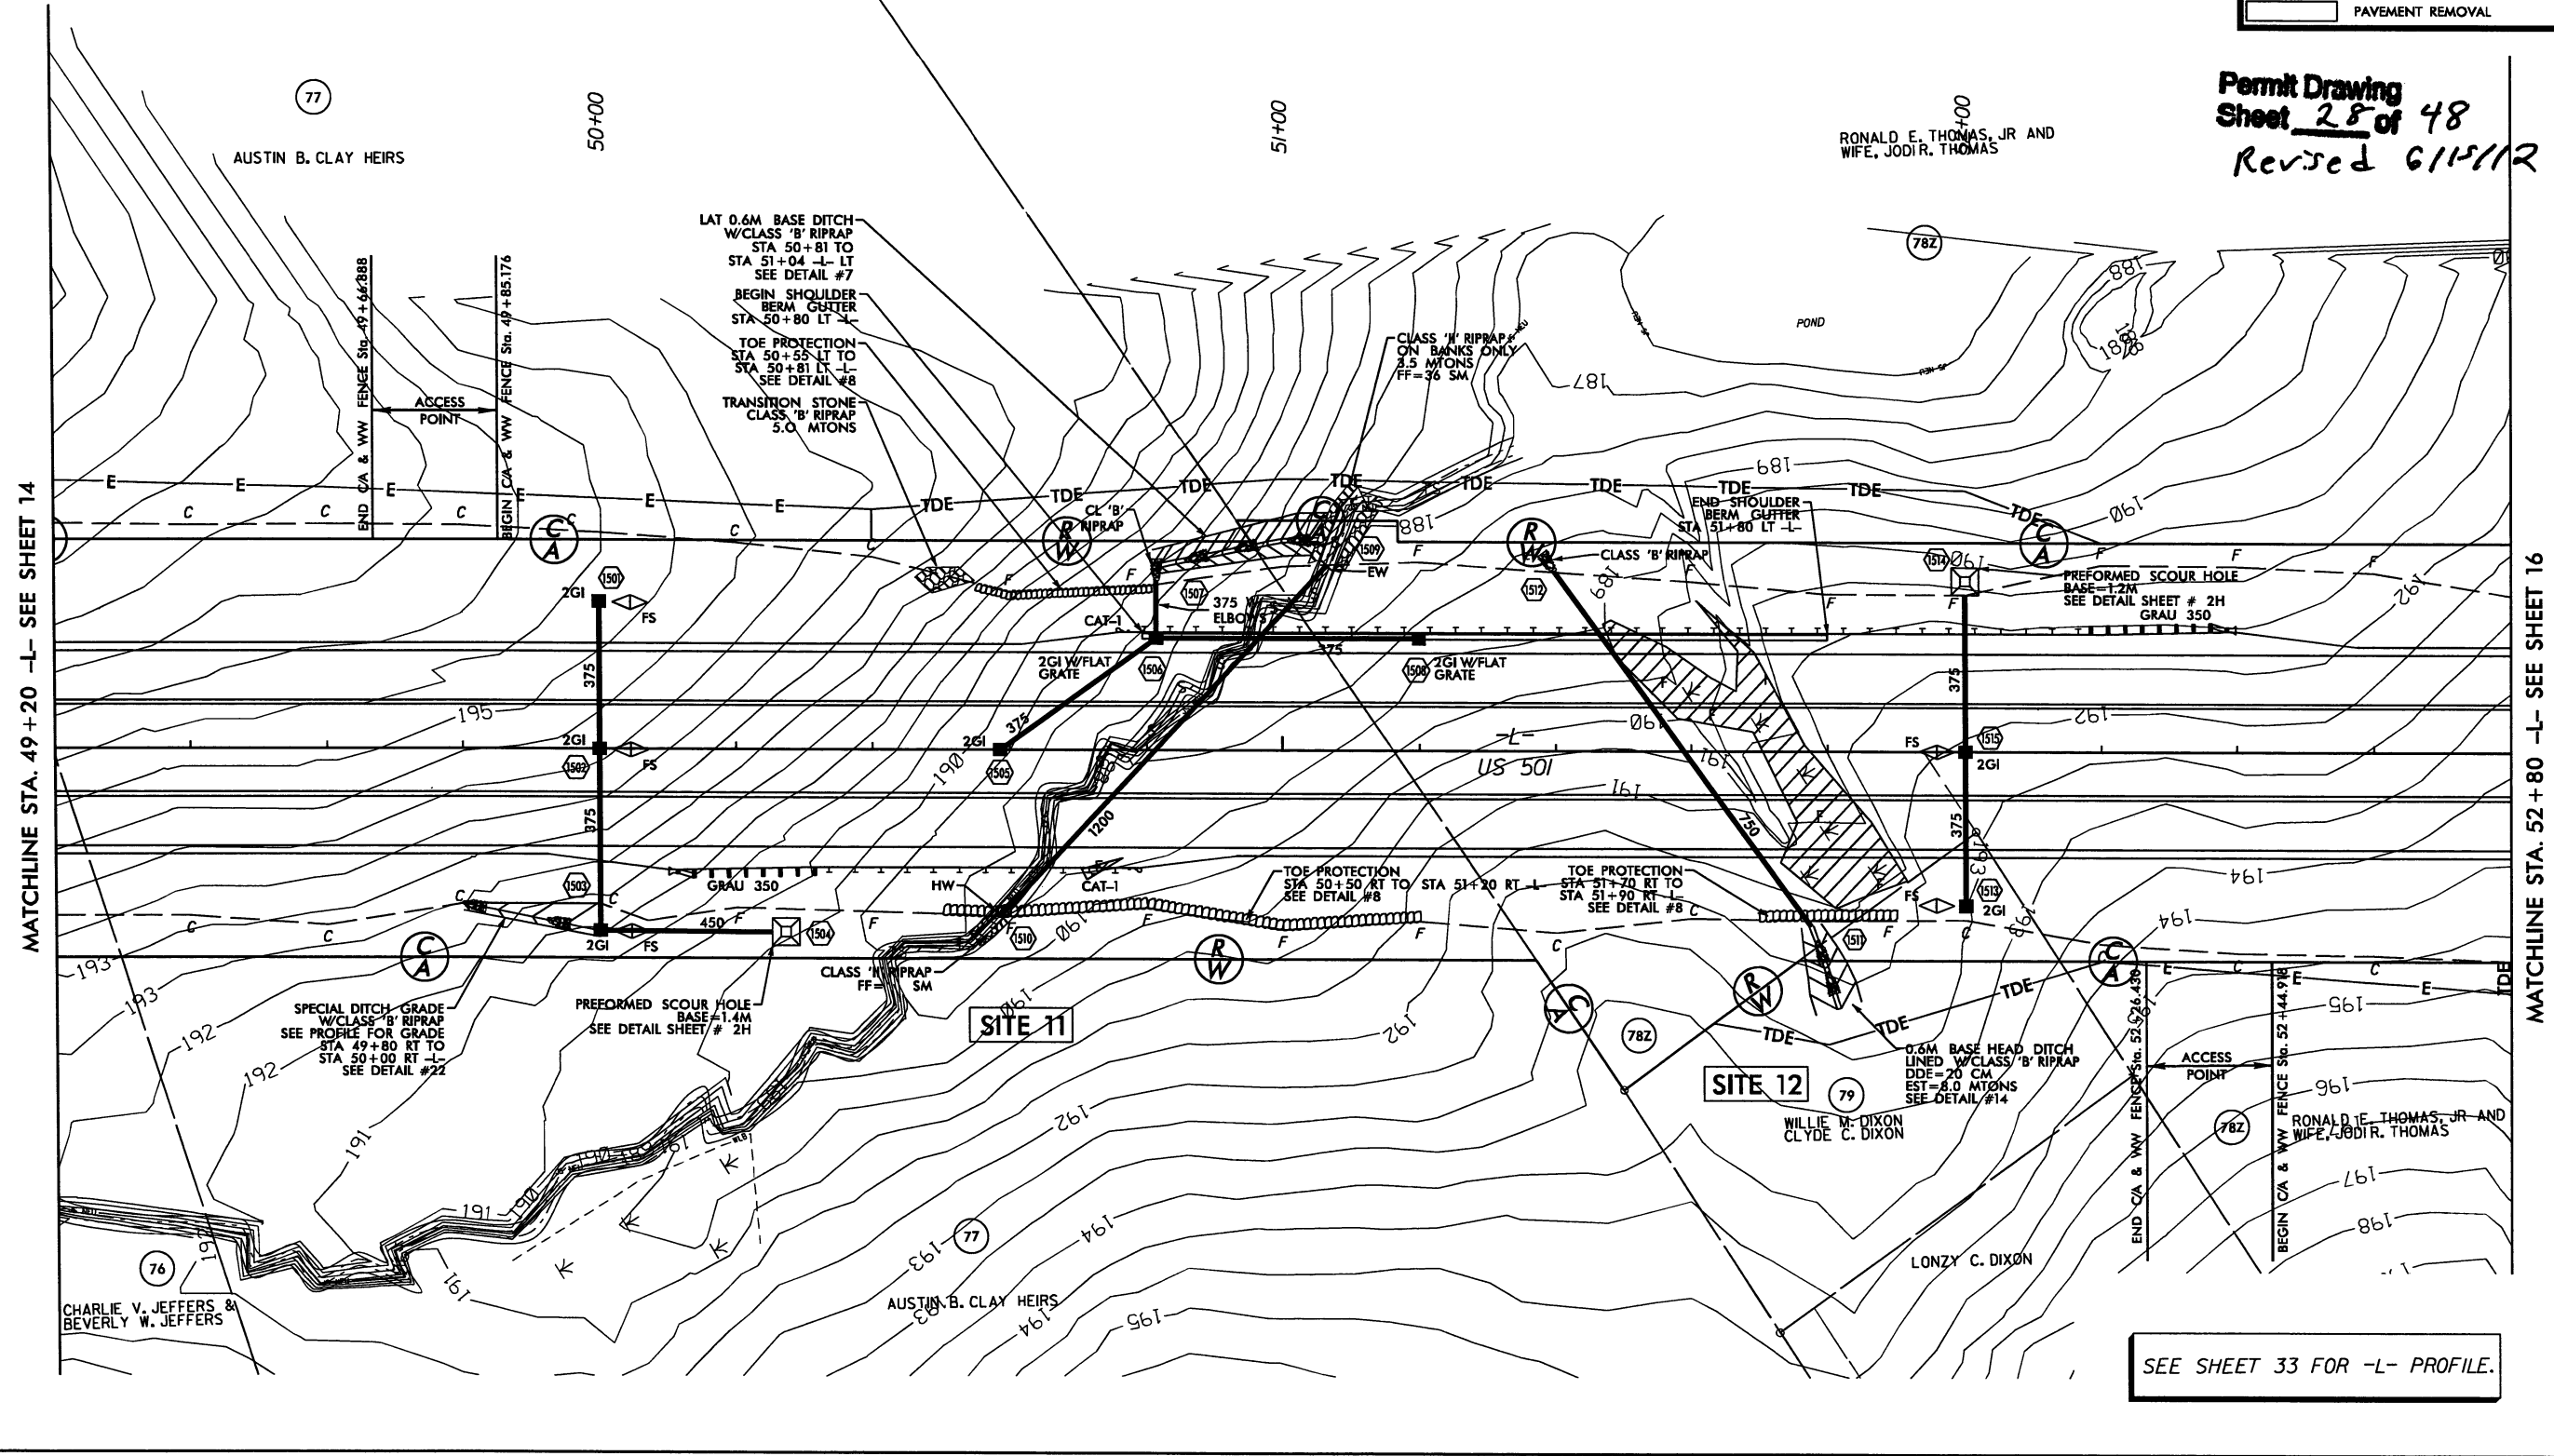

Permit Drawing
 Sheet 25 of 48
 Revised 6/15/12

SEE SHEET 33 FOR -L- PROFILE.

STV / Ralph Whithead Associates, Inc.
 1000 West Wendover St., Ste. 200
 Charlotte, NC 28208
 NC License Number F-0991

REVISIONS	
06-04-08	NEW PARCEL 87A AND PROPERTY LINE CHANGE ON PARCEL 87
06-21-08	PARCEL 88 LOCATED FENCE PARCEL 87A LOCATED SHED, GARAGE, MOBILE HOME, REVISED PARCEL NAME PARCEL 90 REVISED PARCEL NAME
08-02-11	COMBINED PARCEL 87A WITH PARCEL 87 CHANGED PROPERTY INFORMATION ON PARCEL 89
08-08-11	PARCEL 87: REVISED OWNER NAME
10-27-11	PARCEL 85, 86, 87Z AND 89Z: MODIFIED C/A, FENCE, AND TEMPORARY EASEMENTS


METRIX

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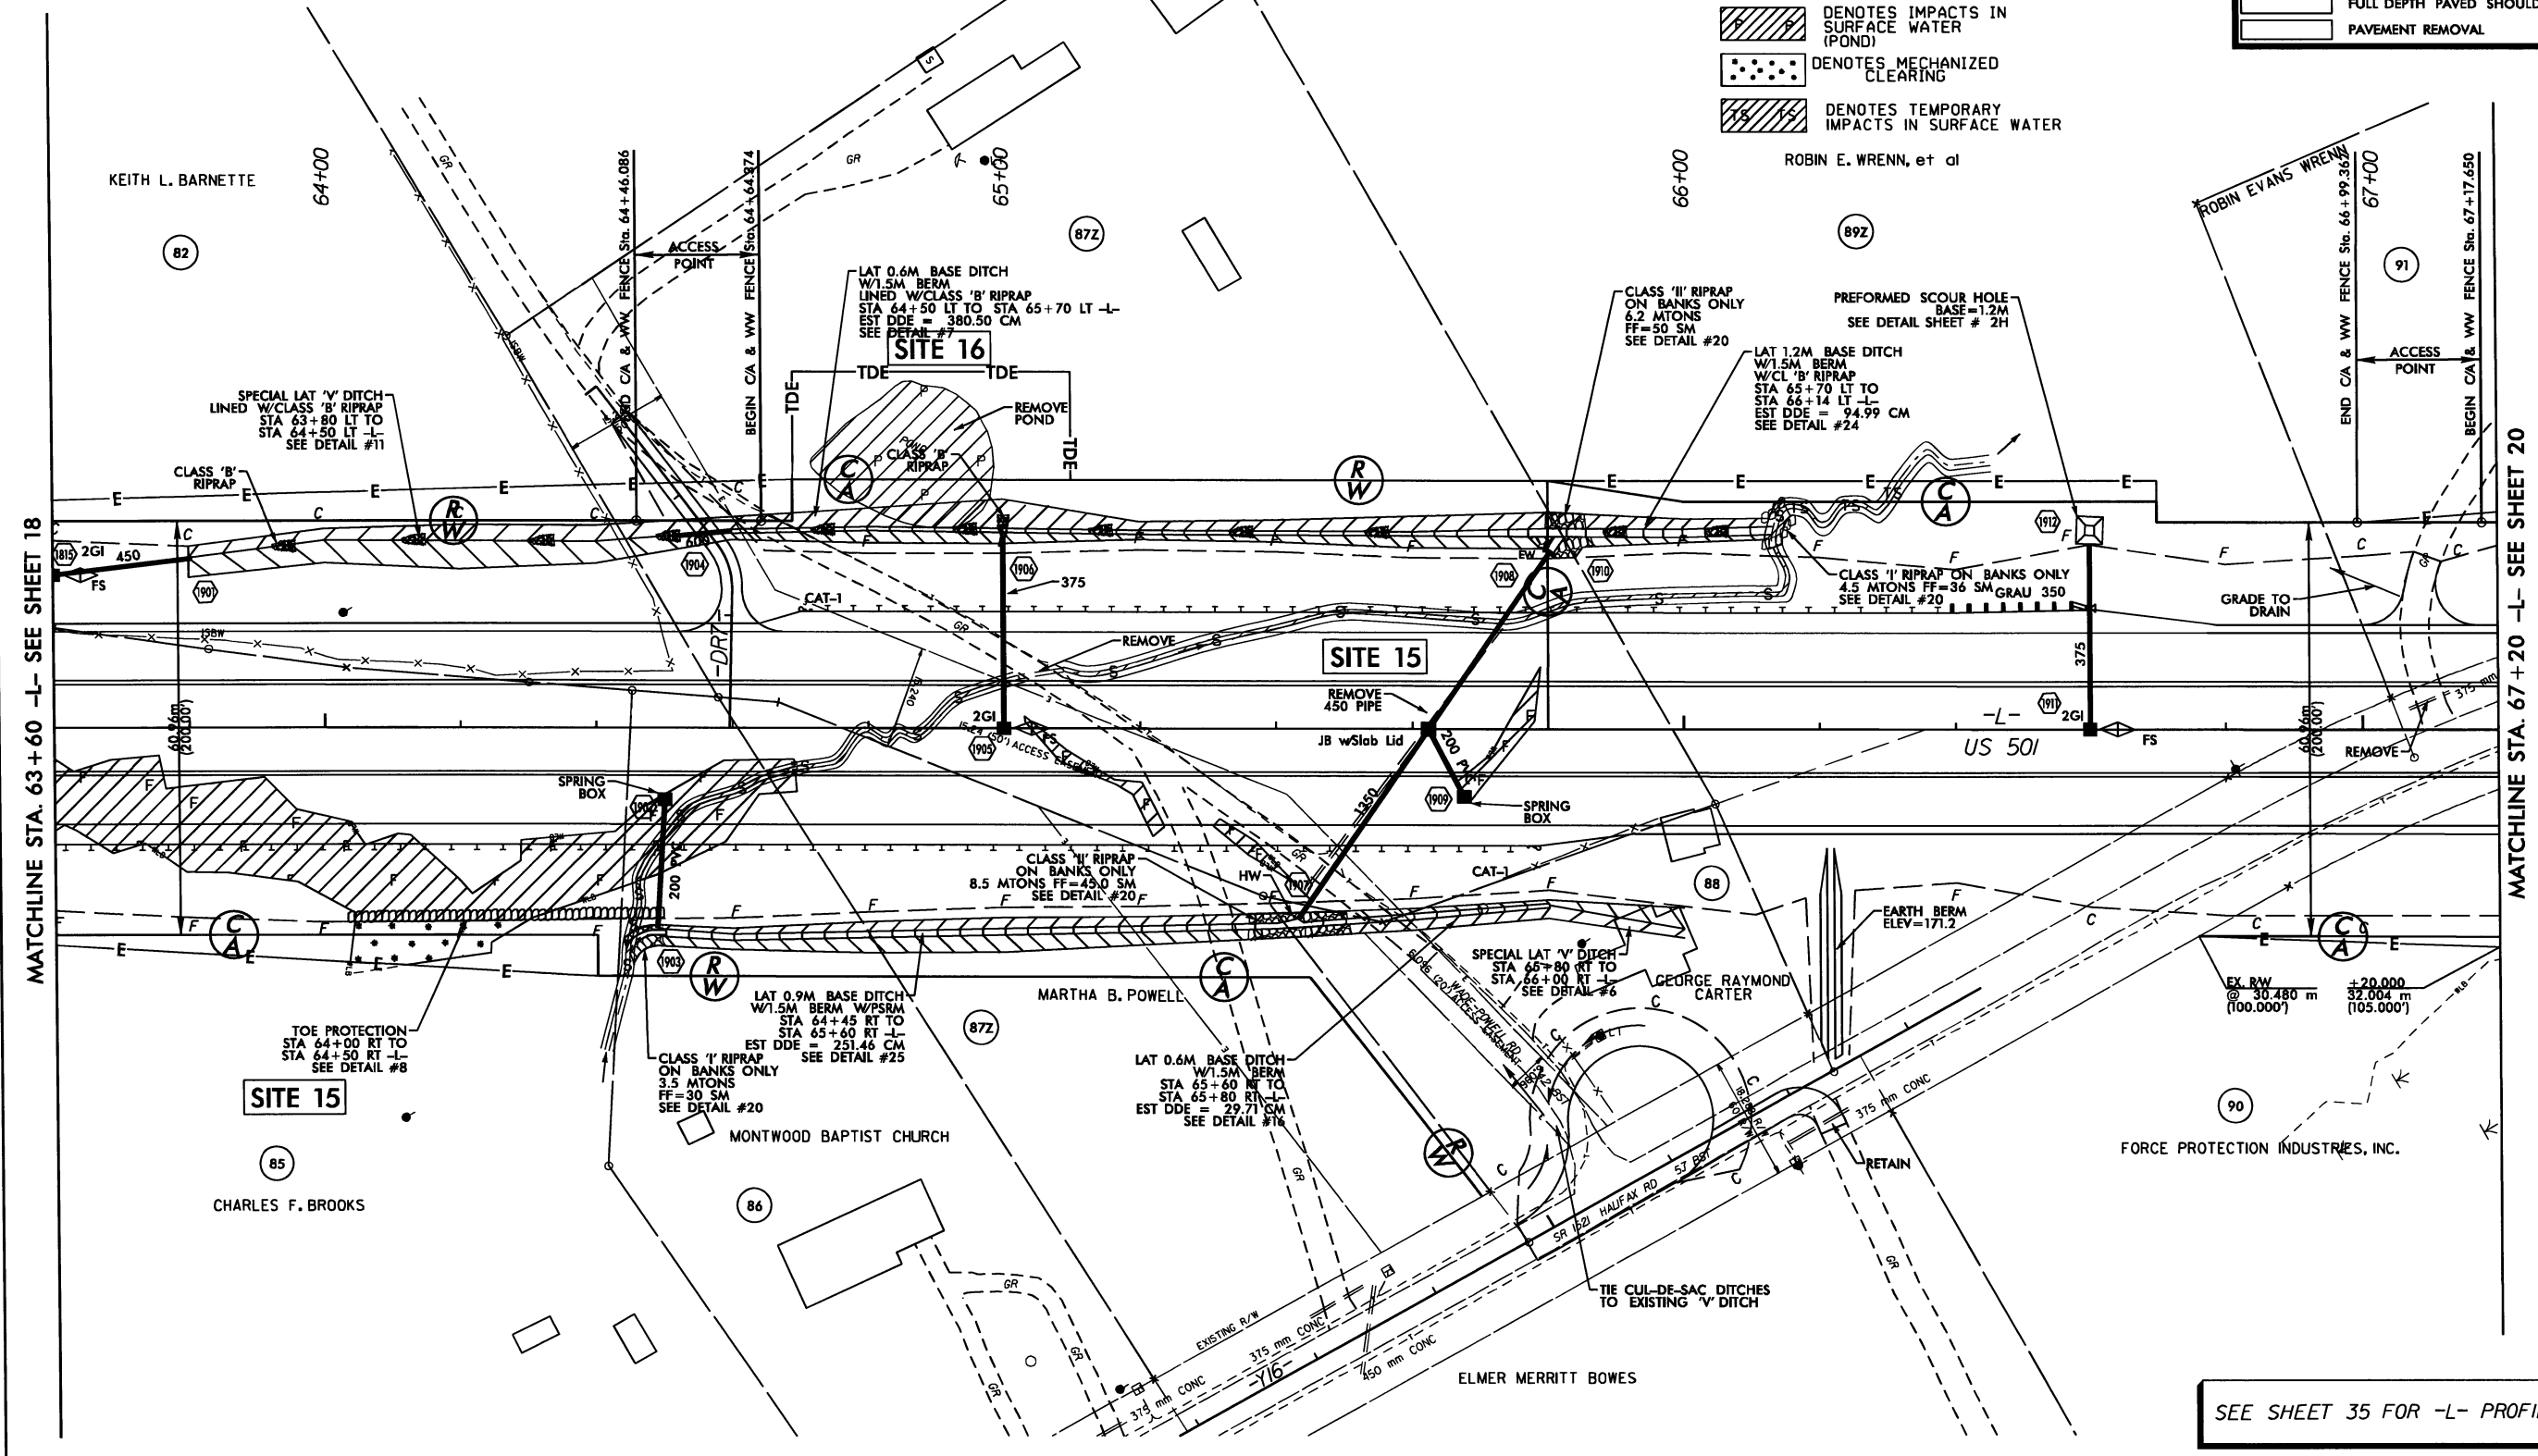
CONST. REV.

R/W REV.

PROJECT REFERENCE NO. R-2241A	SHEET NO. 19
R/W SHEET NO.	
ROADWAY DESIGN ENGINEER	HYDRAULICS ENGINEER
PRELIMINARY PLANS DO NOT USE FOR CONSTRUCTION <i>Revised 6/15/12</i> Permit Drawing Sheet 35 of 48	
	125mm MONOLITHIC ISLAND
	FULL DEPTH PAVED SHOULDER
	PAVEMENT REMOVAL

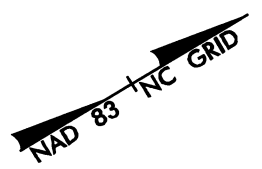

- DENOTES FILL IN WETLAND
- DENOTES IMPACTS IN SURFACE WATER
- DENOTES IMPACTS IN SURFACE WATER (POND)
- DENOTES MECHANIZED CLEARING
- DENOTES TEMPORARY IMPACTS IN SURFACE WATER



MATCHLINE STA. 63+60 -L- SEE SHEET 18

MATCHLINE STA. 67+20 -L- SEE SHEET 20

SEE SHEET 35 FOR -L- PROFILE.

STV/Ralph Whithead Associates, Inc.
 1000 W. Main Street, Suite 200
 Charlotte, NC 28202
 NC License Number F-1091

REVISIONS	
06-04-08	NEW PARCEL 87A AND PROPERTY LINE CHANGE ON PARCEL 87
06-22-08	PARCEL 82 LOCATED FENCE PARCEL 87A LOCATED SHED, GARAGE, MOBILE HOME, REVISED PARCEL NAME PARCEL 90 REVISED PARCEL NAME
08-02-11	COMBINED PARCEL 87A WITH PARCEL 87 CHANGED PROPERTY INFORMATION ON PARCEL 89
08-09-11	PARCEL 87: REVISED OWNER NAME
10-27-11	PARCEL 85, 86, 87Z AND 89Z, MODIFIED C/A FENCE, AND TEMPORARY EASEMENTS



METRIC

5 0 10

CONST. REV.

R/W REV.

PROJECT REFERENCE NO. R-2241A	SHEET NO. 19
R/W SHEET NO.	
ROADWAY DESIGN ENGINEER	HYDRAULICS ENGINEER
PRELIMINARY PLANS DO NOT USE FOR CONSTRUCTION	
Permit Drawing Sheet 36 of 48 Revised 6/15/12	
	125mm MONOLITHIC ISLAND
	FULL DEPTH PAVED SHOULDER
	PAVEMENT REMOVAL

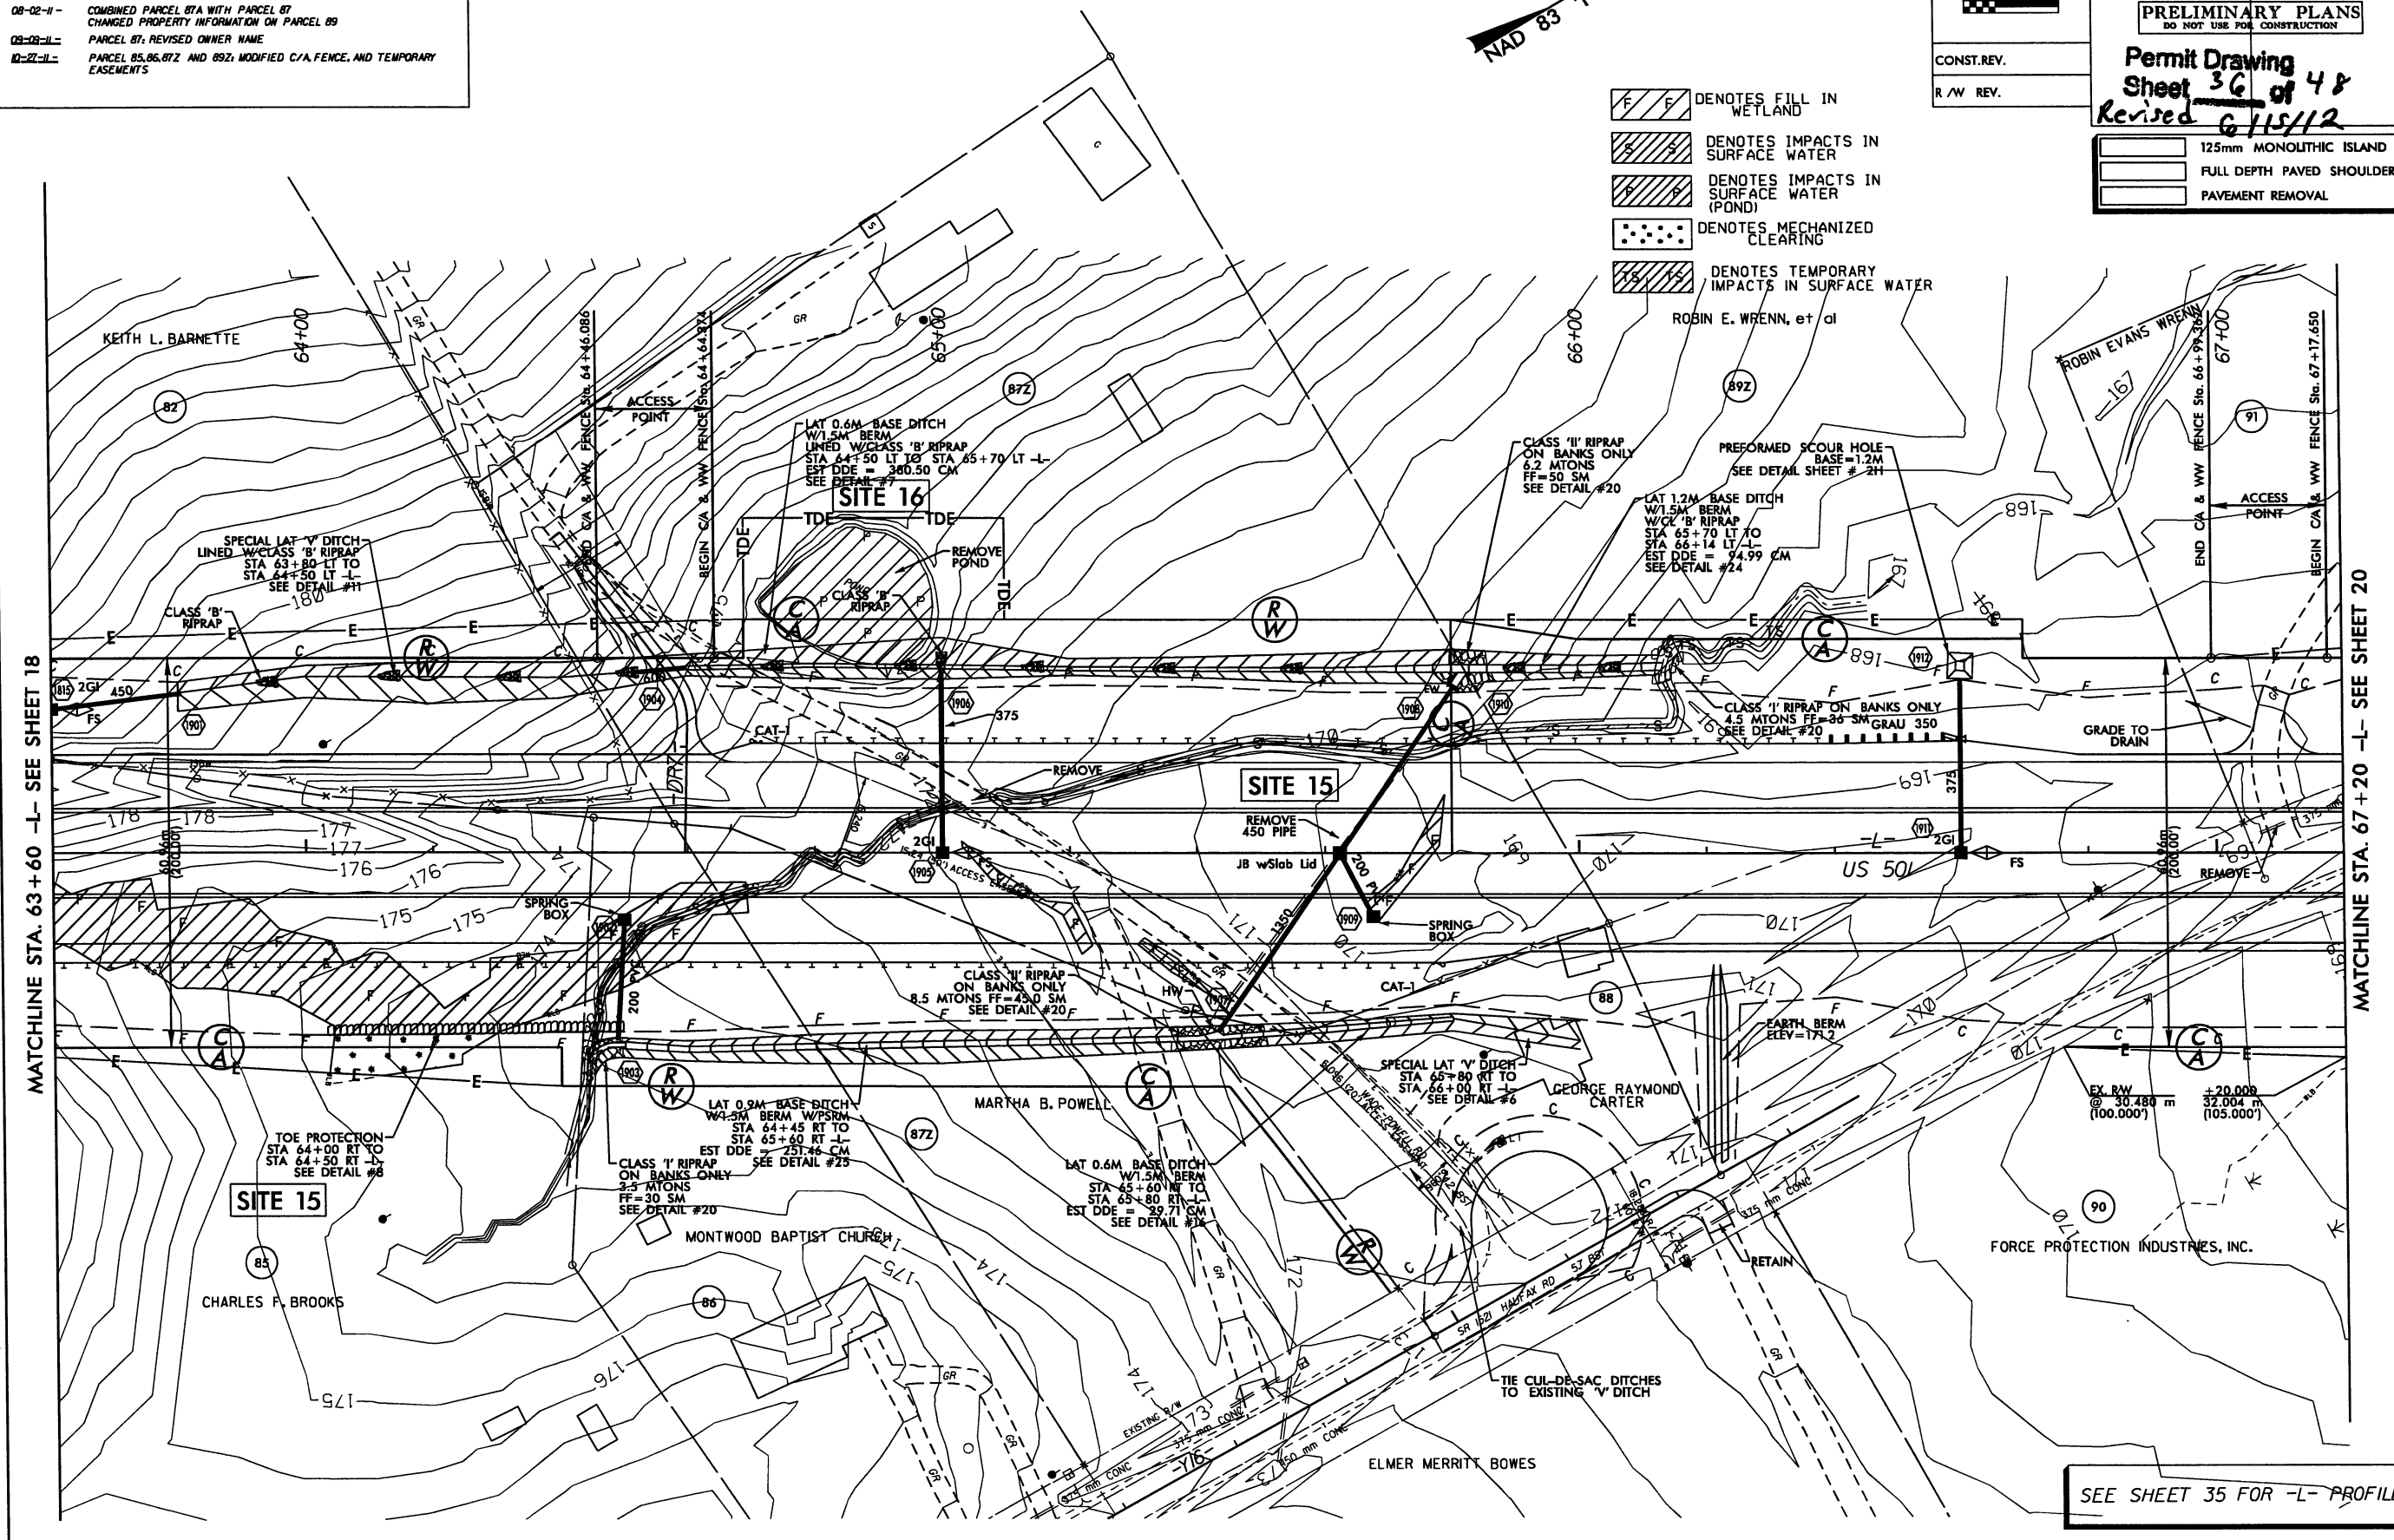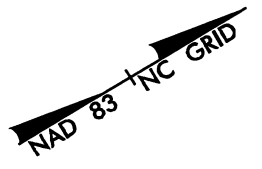

MATCHLINE STA. 63+60 -L- SEE SHEET 18

MATCHLINE STA. 67+20 -L- SEE SHEET 20

SEE SHEET 35 FOR -L- PROFILE.



STV / Ralph Whitehead Associates, Inc.
 1000 West Morehead Street, 200
 NC License Number F-0981

5 0 10

CONST. REV.
 R/W REV.

PROJECT REFERENCE NO. R-2241A	SHEET NO. 20
R /W SHEET NO.	
ROADWAY DESIGN ENGINEER	HYDRAULICS ENGINEER
PRELIMINARY PLANS DO NOT USE FOR CONSTRUCTION	

	125mm MONOLITHIC ISLAND
	FULL DEPTH PAVED SHOULDER
	PAVEMENT REMOVAL

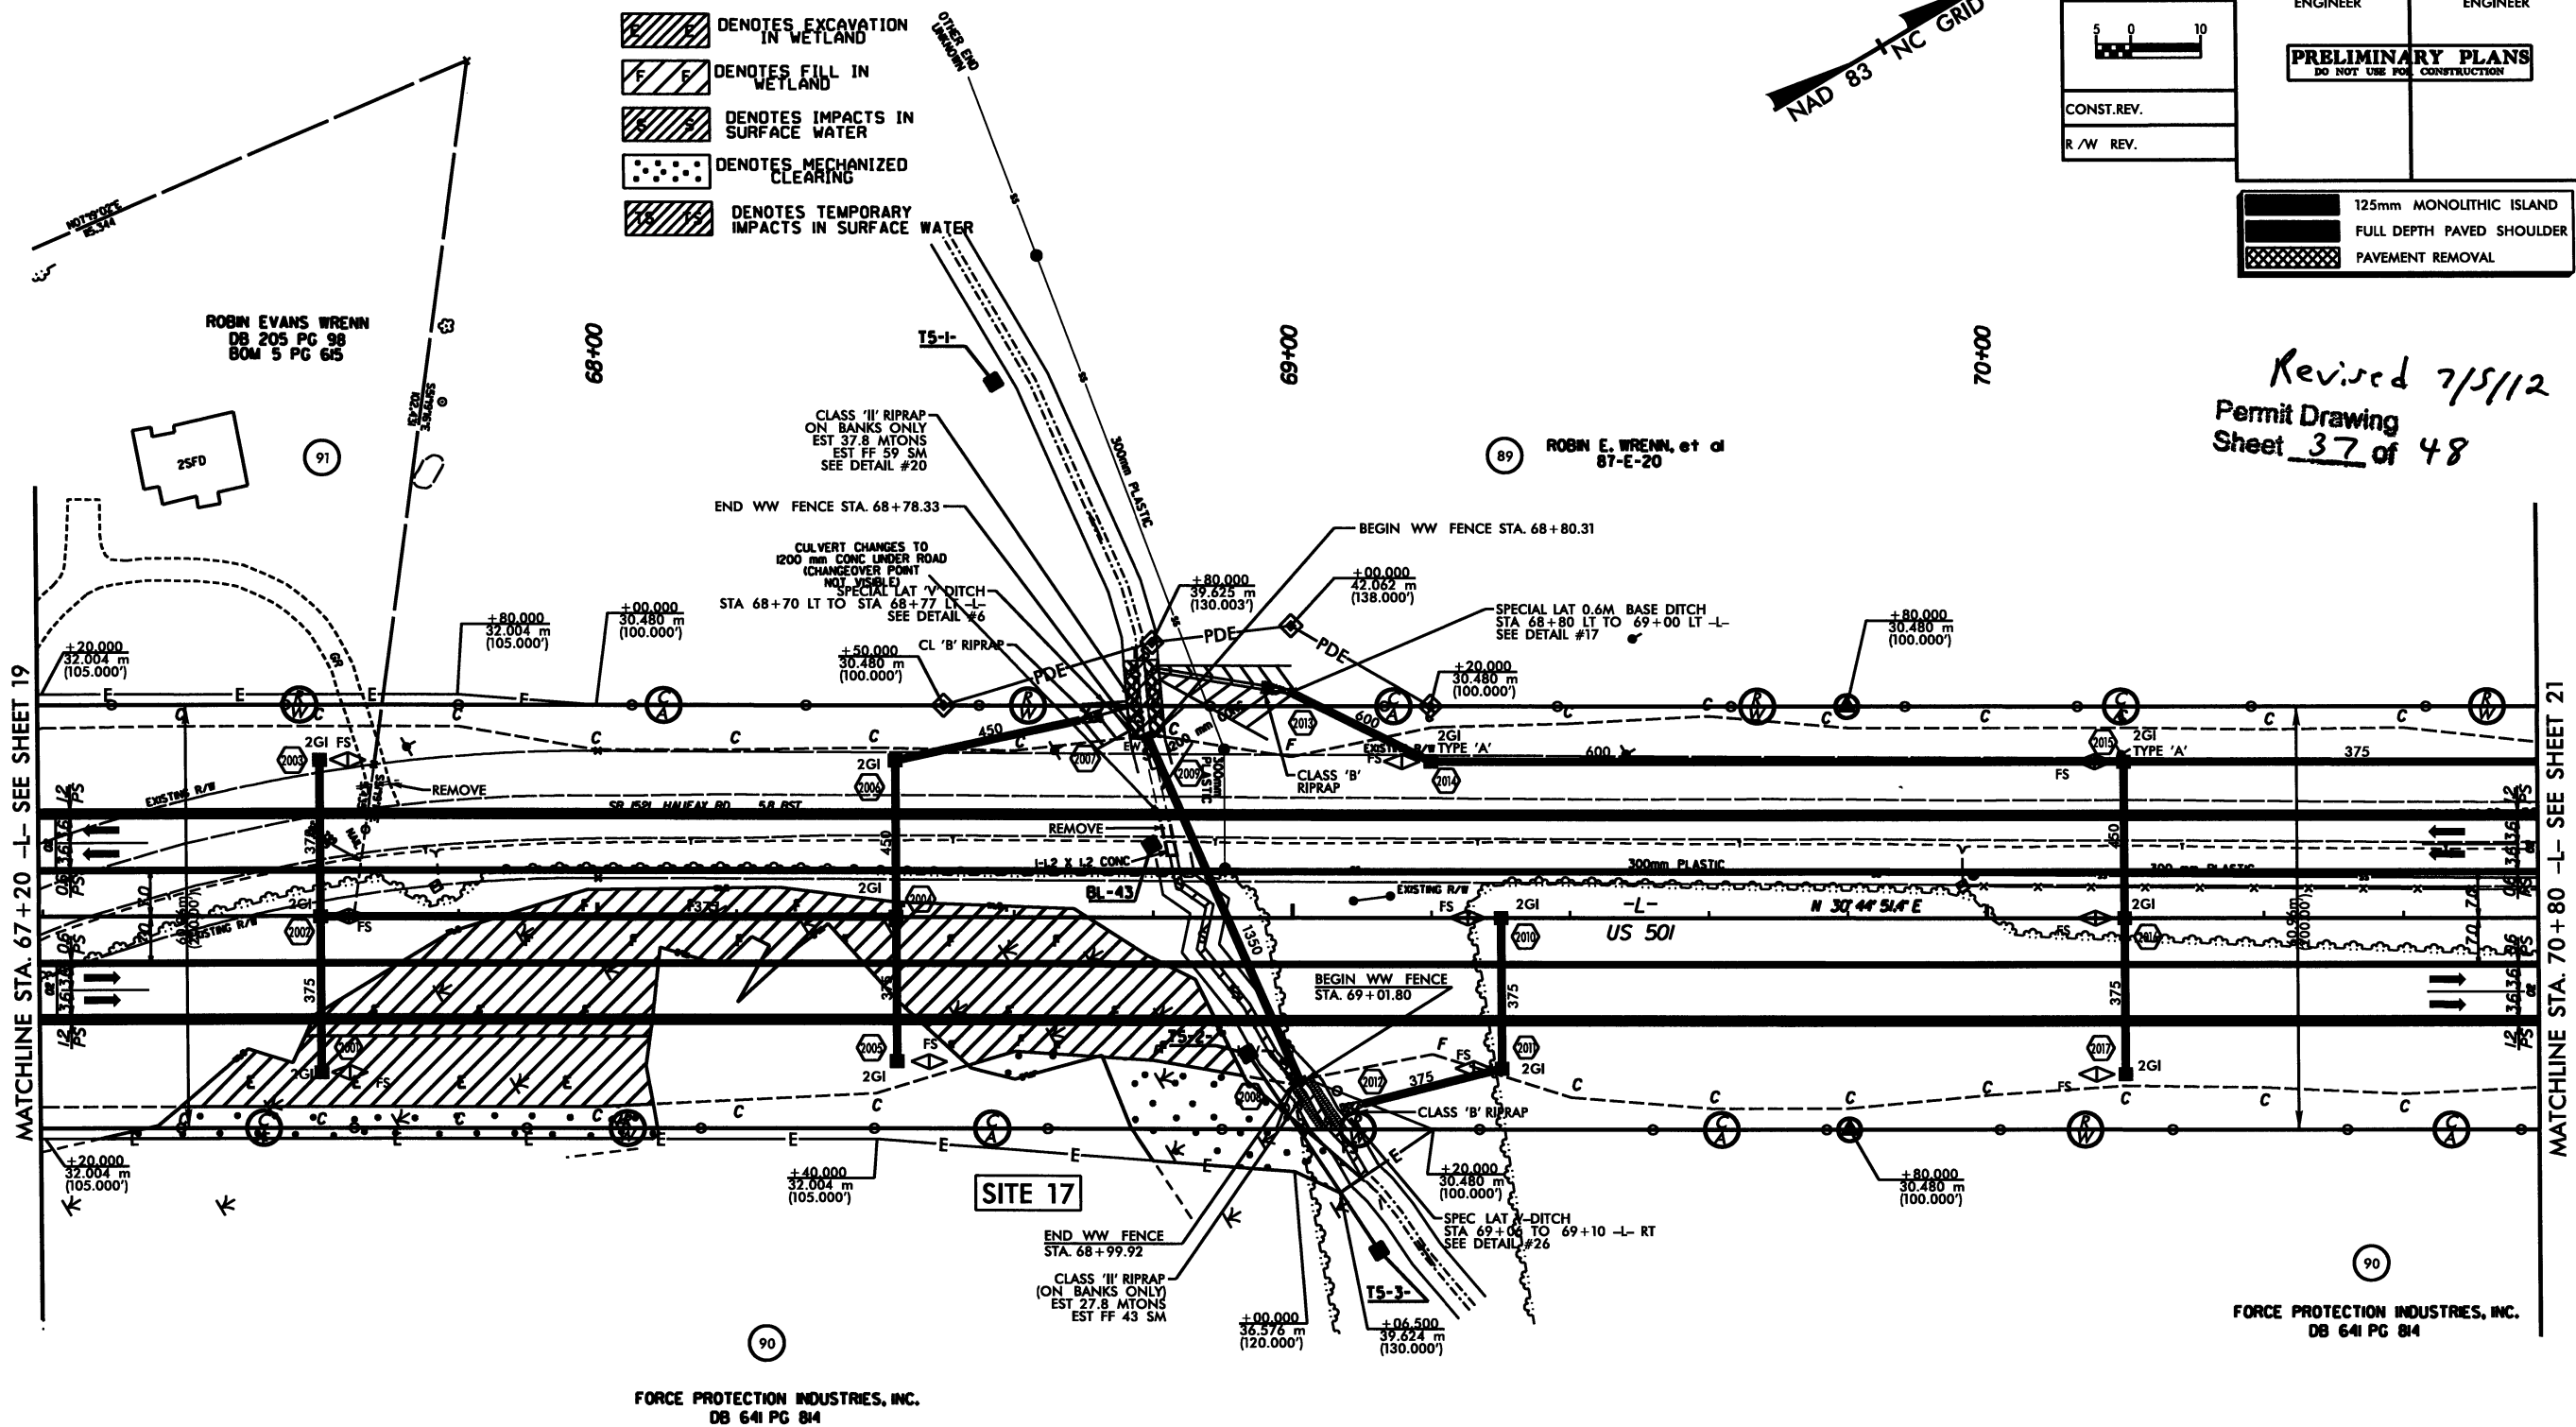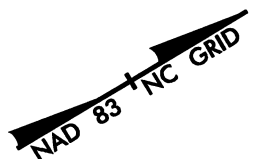

Revised 7/5/12
 Permit Drawing
 Sheet 37 of 48


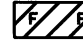



MATCHLINE STA. 67+20 -L- SEE SHEET 19


MATCHLINE STA. 70+80 -L- SEE SHEET 21

FORCE PROTECTION INDUSTRIES, INC.
 DB 641 PG 814




SEE SHEET 36 FOR -L- PROFILE

STV / Ralph Whitehead Associates, Inc.
 1000 West Morehead St., Ste. 200
 Charlotte, NC 28208
 NC License Number F-10891

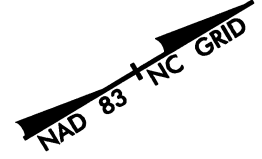-  DENOTES EXCAVATION IN WETLAND
-  DENOTES FILL IN WETLAND
-  DENOTES IMPACTS IN SURFACE WATER
-  DENOTES MECHANIZED CLEARING
-  DENOTES TEMPORARY IMPACTS IN SURFACE WATER

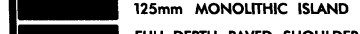


PROJECT REFERENCE NO. R-2241A		SHEET NO. 20	
R/W SHEET NO.			
ROADWAY DESIGN ENGINEER		HYDRAULICS ENGINEER	
PRELIMINARY PLANS DO NOT USE FOR CONSTRUCTION			
CONST. REV.			
R/W REV.			

	125mm MONOLITHIC ISLAND
	FULL DEPTH PAVED SHOULDER
	PAYEMENT REMOVAL

Revised 7/3/12
 Permit Drawing
 Sheet 38 of 48

MATCHLINE STA. 67+20 -L- SEE SHEET 19

MATCHLINE STA. 70+80 -L- SEE SHEET 21

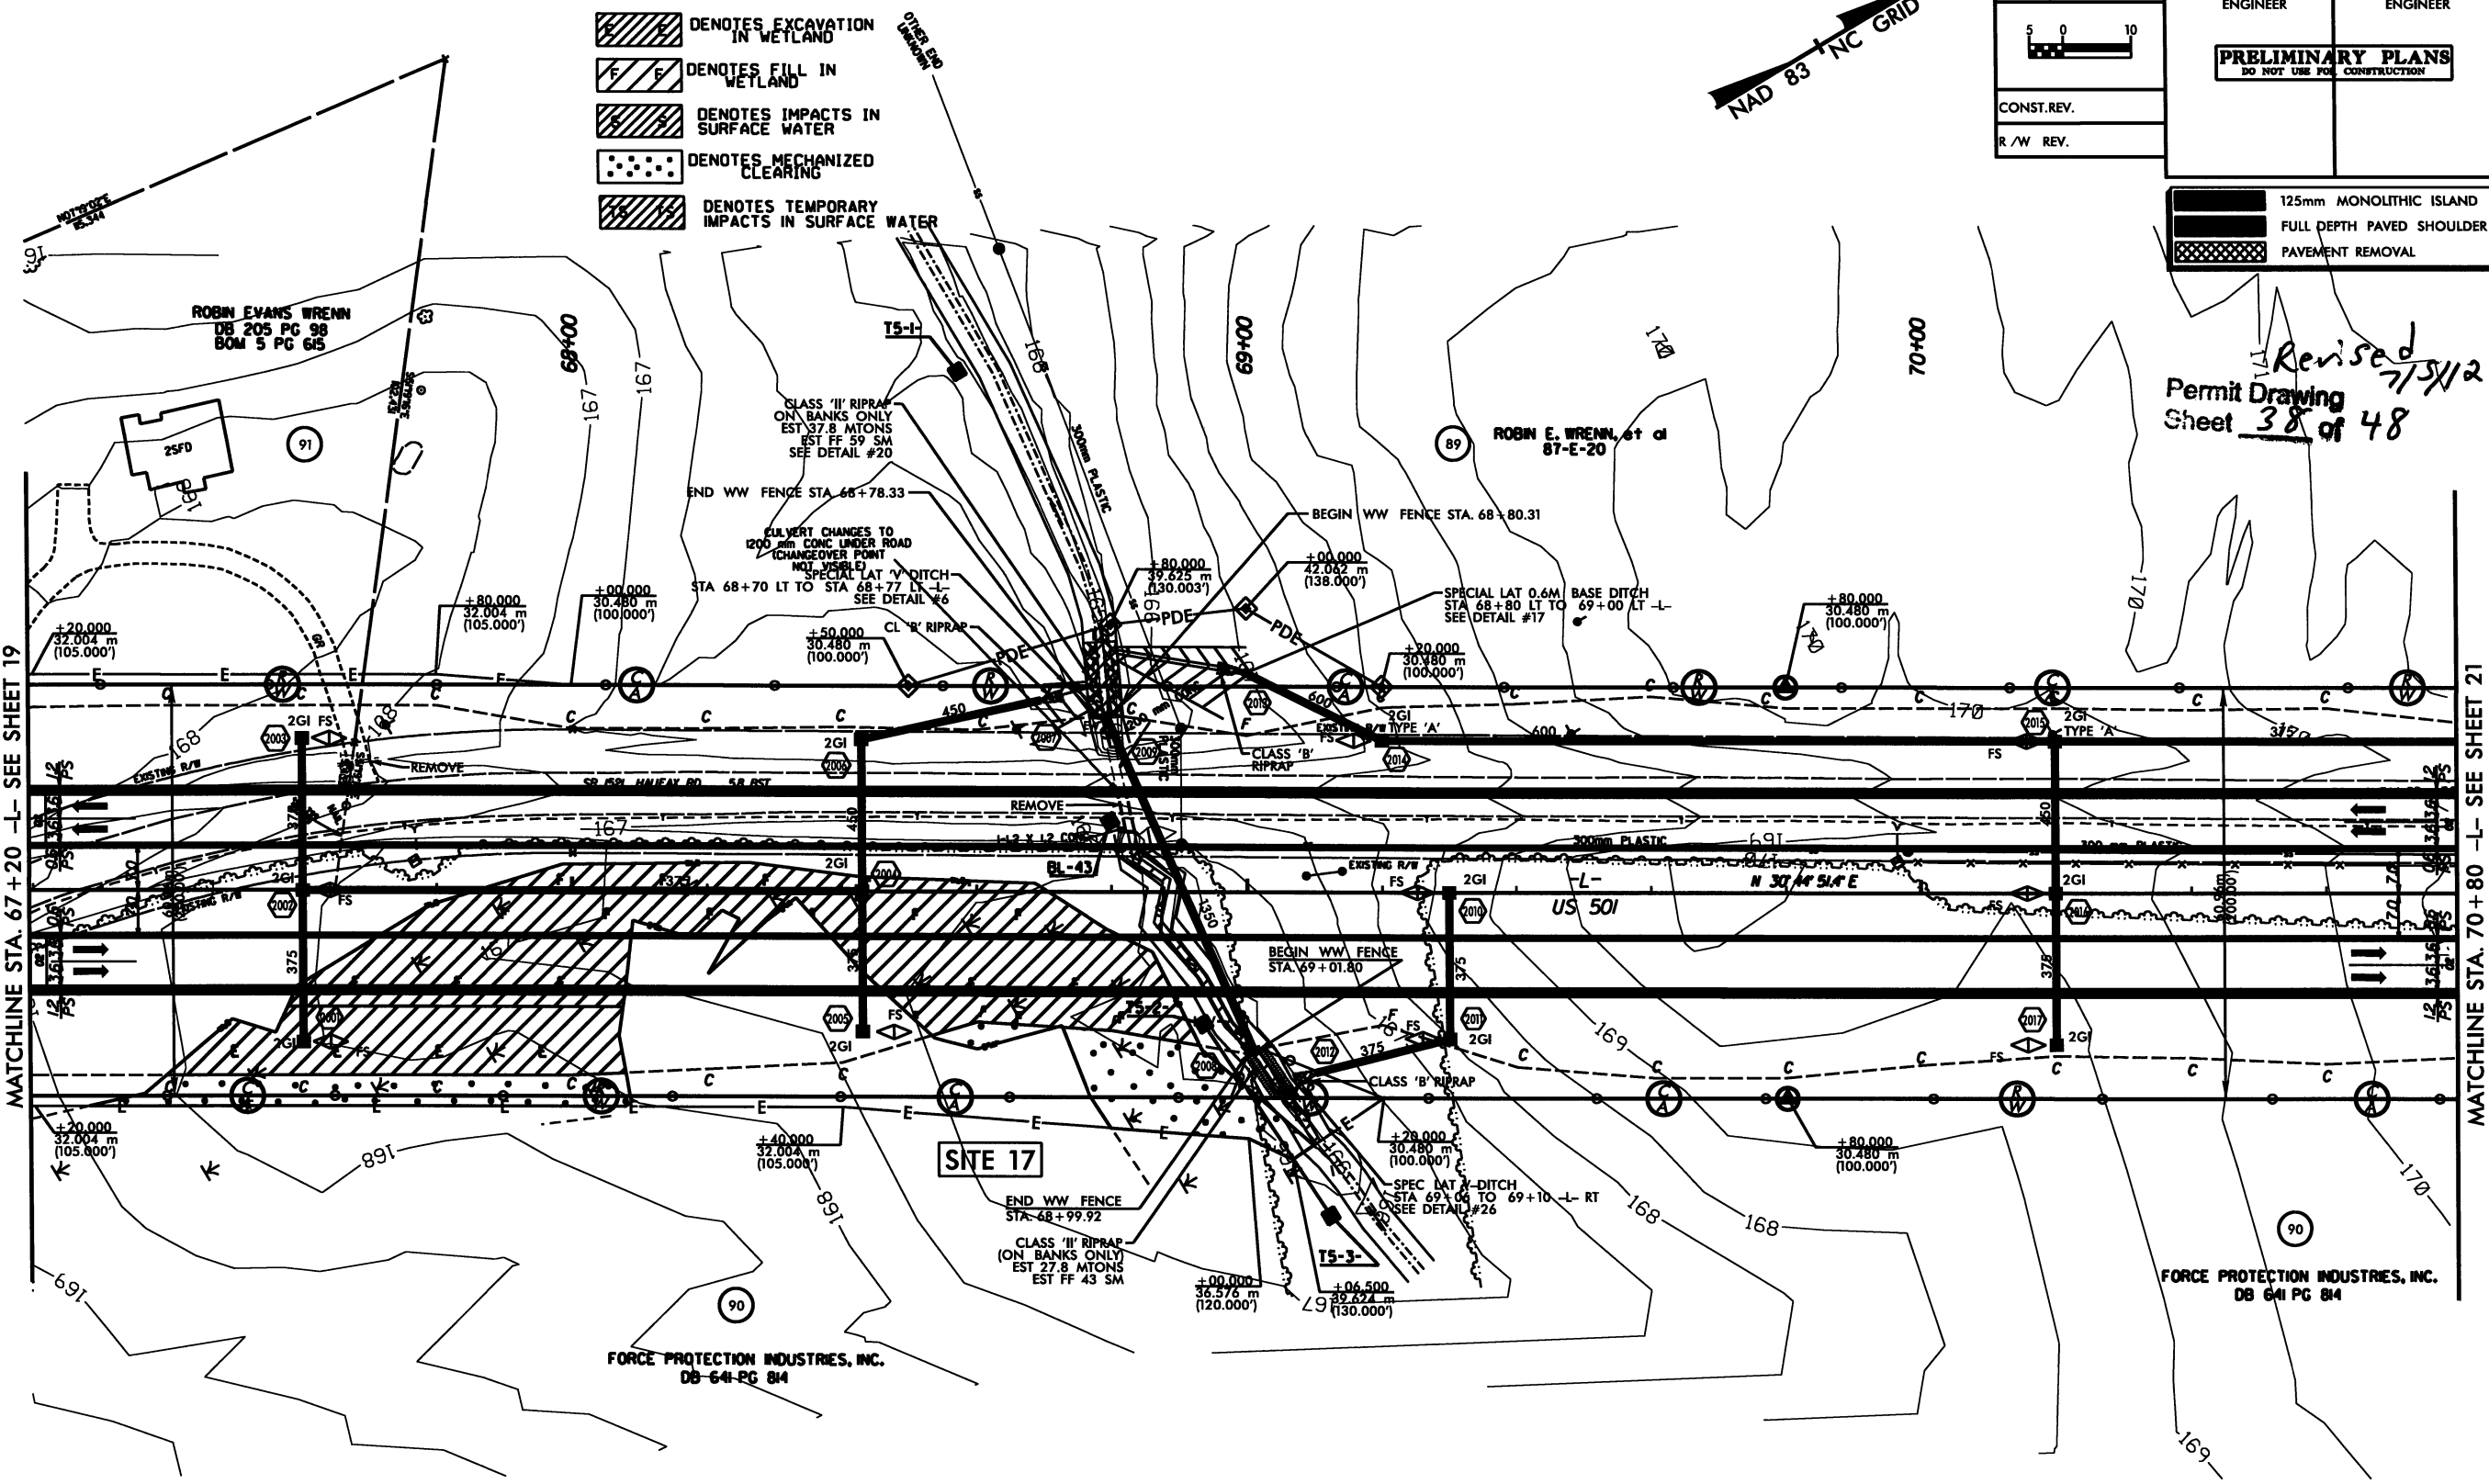

FORCE PROTECTION INDUSTRIES, INC.
 DB 641 PG 84

FORCE PROTECTION INDUSTRIES, INC.
 DB 641 PG 84

SEE SHEET 36 FOR -L- PROFILE

STV / Ralph Whitehead Associates, Inc.
 1000 West Morehead St., Ste. 200
 Charlotte, NC 28208
 NC License Number 1-0991

METRIC


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CONST. REV.
 R/W REV.

PROJECT REFERENCE NO. R-2241A	SHEET NO. 22
R/W SHEET NO.	
ROADWAY DESIGN ENGINEER	HYDRAULICS ENGINEER
PRELIMINARY PLANS DO NOT USE FOR CONSTRUCTION	

	125mm MONOLITHIC ISLAND
	FULL DEPTH PAVED SHOULDER
	PAVEMENT REMOVAL

Revised 7/5/12
 Permit Drawing
 Sheet 39 of 48

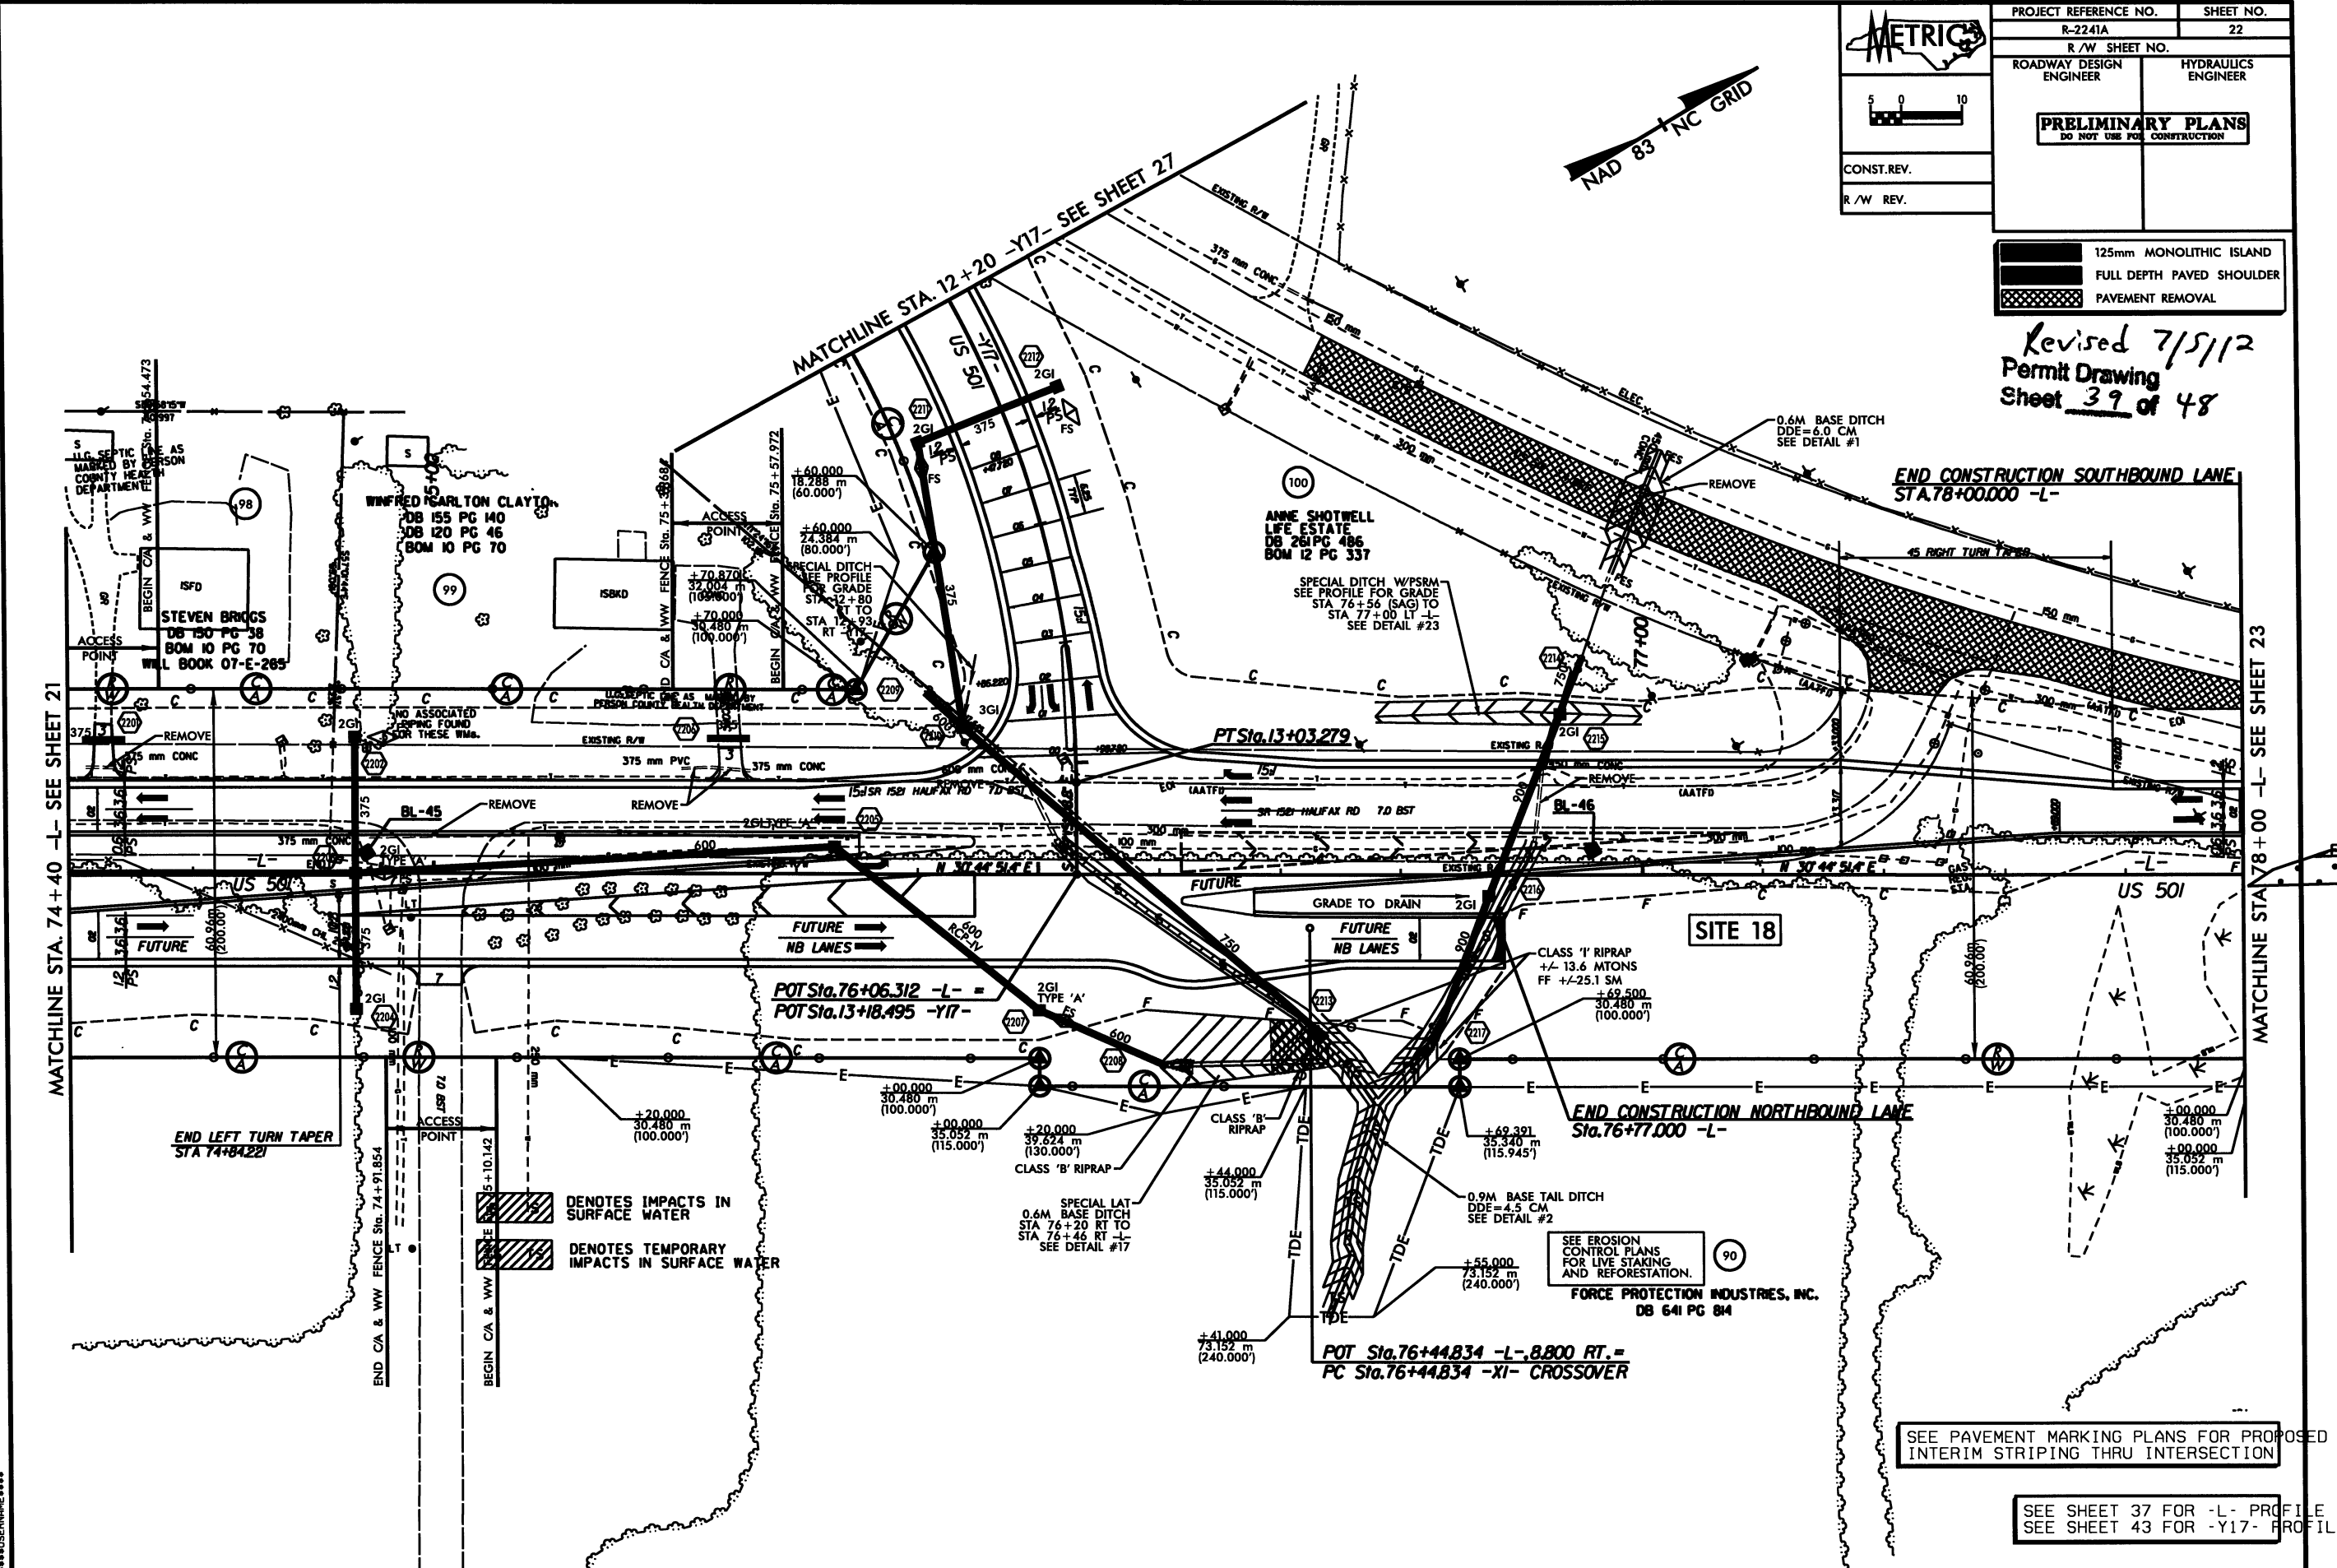

DENOTES IMPACTS IN SURFACE WATER
 DENOTES TEMPORARY IMPACTS IN SURFACE WATER

SEE EROSION CONTROL PLANS FOR LIVE STAKING AND REFORESTATION.

SEE PAVEMENT MARKING PLANS FOR PROPOSED INTERIM STRIPING THRU INTERSECTION

SEE SHEET 37 FOR -L- PROFILE
 SEE SHEET 43 FOR -Y17- PROFILE

STV/Ralph Whitehead Associates, Inc.
 1000 Wakeforest Road, Suite 200
 Cary, NC 27513
 NC License Number F-0891


METRIC

CONST. REV.
 R/W REV.

PROJECT REFERENCE NO. R-2241A	SHEET NO. 22
R/W SHEET NO.	
ROADWAY DESIGN ENGINEER	HYDRAULICS ENGINEER
PRELIMINARY PLANS DO NOT USE FOR CONSTRUCTION	

Revised 7/5/12
 Permit Drawing
 Sheet 40 of 48

	125mm MONOLITHIC ISLAND
	FULL DEPTH PAVED SHOULDER
	PAVEMENT REMOVAL

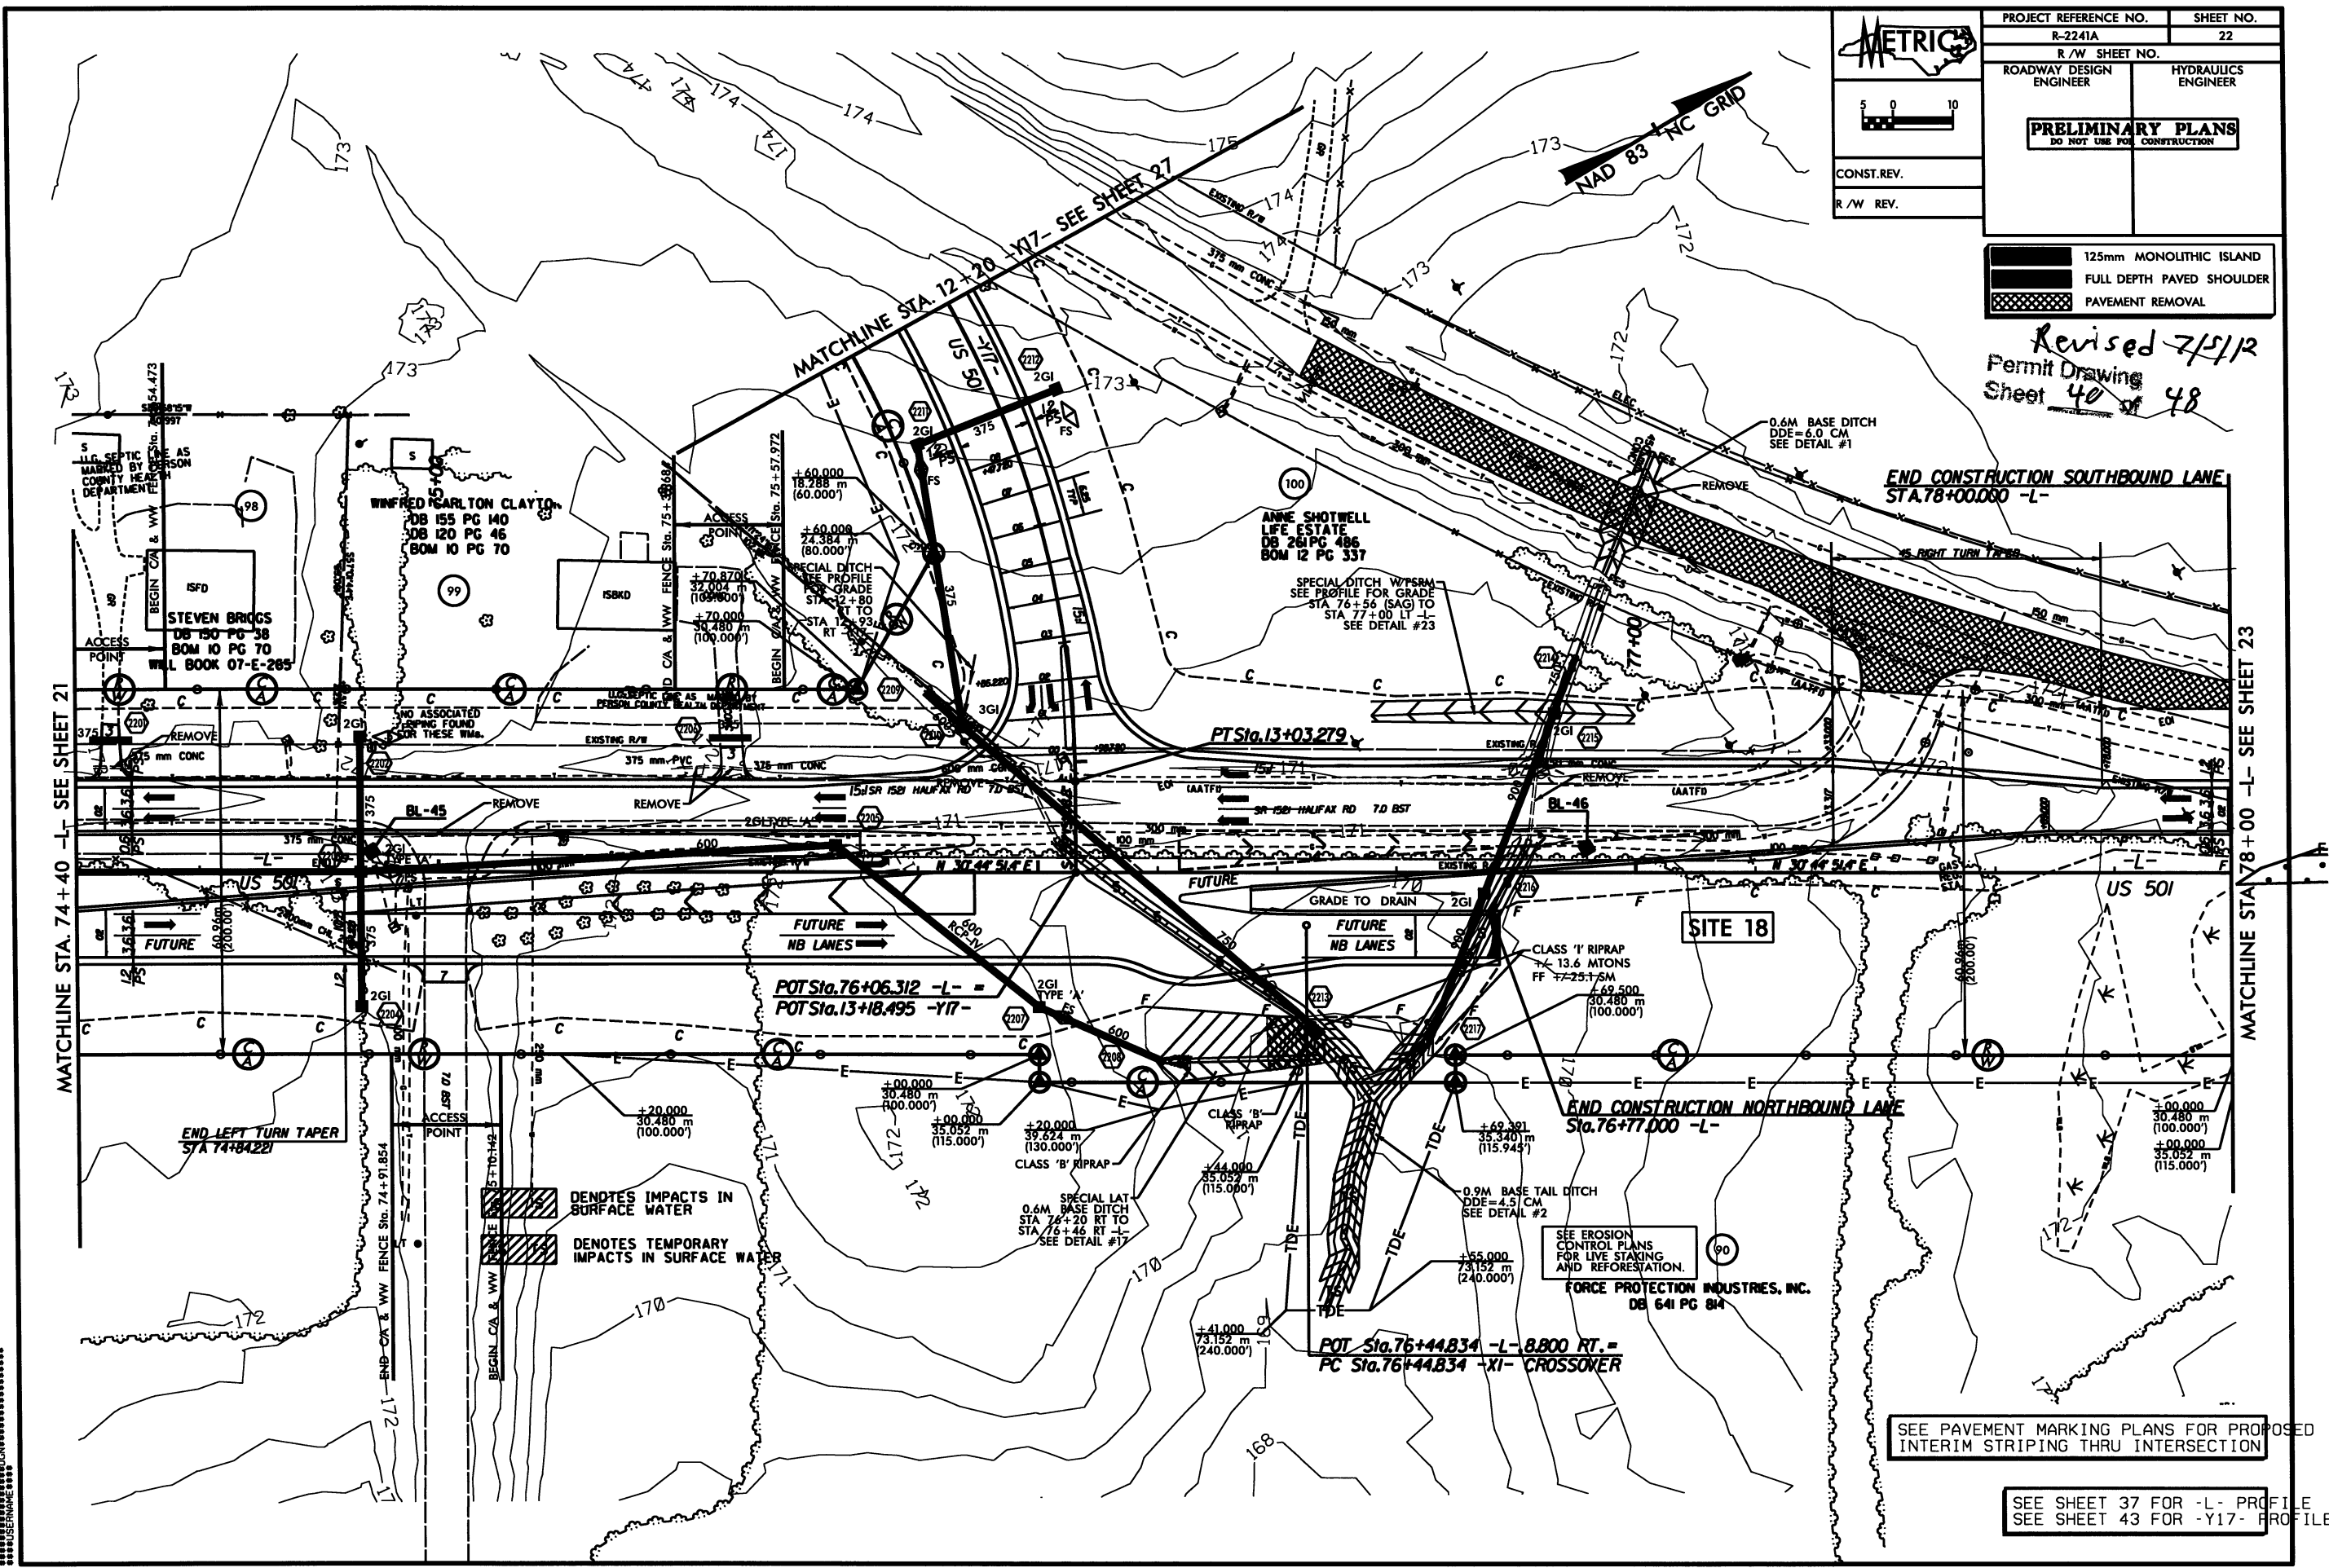

MATCHLINE STA. 74+40 -L- SEE SHEET 21

MATCHLINE STA 78+00 -L- SEE SHEET 23

DENOTES IMPACTS IN SURFACE WATER
 DENOTES TEMPORARY IMPACTS IN SURFACE WATER

SEE EROSION CONTROL PLANS FOR LIVE STAKING AND REFORESTATION.

SEE PAVEMENT MARKING PLANS FOR PROPOSED INTERIM STRIPING THRU INTERSECTION

SEE SHEET 37 FOR -L- PROFILE
 SEE SHEET 43 FOR -Y17- PROFILE

WETLAND PERMIT IMPACT SUMMARY

Site No.	Station (From/To)	Structure Size / Type	WETLAND IMPACTS					SURFACE WATER IMPACTS					
			Permanent Fill In Wetlands (ha)	Temp. Fill In Wetlands (ha)	Excavation in Wetlands (ha)	Mechanized Clearing in Wetlands (ha)	Hand Clearing in Wetlands (ha)	Permanent SW impacts (ha)	Temp. SW impacts (ha)	Existing Channel Impacts Permanent (m)	Existing Channel Impacts Temp. (m)	Natural Stream Design (m)	
1	13+28/13+62 -L-	3@3mx3m RCBC							0.012	0.002	42	8	
	Stream Bank Stabilization								0.013		38		
2	15+12/15+59 -L- LT	750mm CSP	0.045		0.004	0.025							
3 *	19+21/19+23 -L- RT	Fill							<0.001		7		
4	20+84/20+89 -L-	2@2.4mx2.4m RCBC							0.010	0.005	34	12	
	Stream Bank Stabilization								0.010		18		
5	20+89/21+45 -L-	Fill	0.089			0.023							
6 *	24+98/25+10 -L- RT	900mm RCP							0.001	0.001	7	6	
	Stream Bank Stabilization								0.002		7		
7A	34+93/36+38 -L-	2.7mx1.8m RCBC	0.051				0.002		0.012	0.003	158	33	
	Stream Bank Stabilization								0.007		25		
7B *	35+38/35+51 -L- LT	Fill							0.001		18		
8	37+33/37+55 -L-	1050mm RCP	0.008		0.002	0.012			0.004	0.001	59	11	
	Stream Bank Stabilization								0.001		4		
9	40+05/40+70 -L-	1500mm RCP							0.017	0.002	85	10	
	Stream Bank Stabilization								0.002		5		
10 *	11+55/11+82 -Y13- LT	900mm CSP							0.003	0.002	28	13	
	Stream Bank Stabilization								0.001		6		
11	50+41/51+25 -L-	1200mm RCP	0.001						0.008	0.004	86	26	
	Stream Bank Stabilization								0.003		16		
12	51+47/51+91 -L-	750mm RCP	0.047										
13	53+13/53+79 -L-	900mm RCP	0.070		0.001	0.027			0.005	0.001	75	22	
TOTALS:			0.311		0.007	0.089			0.112	0.021	718	141	

* Note: Stream Impacts are Non-Mitigatable.

NC DEPARTMENT OF TRANSPORTATION
DIVISION OF HIGHWAYS

PERSON COUNTY
WBS - 34406.1.1 (R-2241A)

Kov.
7/16/2012

SHEET 45 of 48

WETLAND PERMIT IMPACT SUMMARY												
Site No.	Station (From/To)	Structure Size / Type	WETLAND IMPACTS					SURFACE WATER IMPACTS				
			Permanent Fill In Wetlands (ha)	Temp. Fill In Wetlands (ha)	Excavation in Wetlands (ha)	Mechanized Clearing in Wetlands (ha)	Hand Clearing in Wetlands (ha)	Permanent SW impacts (ha)	Temp. SW impacts (ha)	Existing Channel Impacts Permanent (m)	Existing Channel Impacts Temp. (m)	Natural Stream Design (m)
14	57+12/57+55 -L-	1200mm RCP	0.036		0.002			0.007	0.001	80	7	
	Stream Bank Stabilization							0.002		4		
15	63+41/66+32 -L-	1350mm RCP	0.144			0.013		0.012	0.001	199	23	
	Stream Bank Stabilization							0.002		4		
16	64+72/64+99 -L- LT	Pond Removal						0.041				
17	67+35/69+11 -L-	1350 RCP	0.191		0.061	0.074		0.005	0.002	45	7	
	Stream Bank Stabilization							0.006		20		
18 *	76+03/76+90 -L-	750mm/900mm RCP						0.009	0.005	108	55	
	Stream Bank Stabilization							<0.001		13		
19	77+72/79+54 -L-	Fill	0.003			0.039						
TOTALS:			0.374		0.063	0.126		0.084	0.009	473	92	
TOTALS:			0.685		0.070	0.215		0.196	0.030	1191	233	

* Note: Stream Impacts are Non-Mitigatable.

NC DEPARTMENT OF TRANSPORTATION
 DIVISION OF HIGHWAYS
 PERSON COUNTY
 WBS - 34406.1.1 (R-2241A)
 SHEET 46 of 48 Rev. 7/16/2012

WETLAND PERMIT IMPACT SUMMARY

Site No.	Station (From/To)	Structure Size / Type	WETLAND IMPACTS					SURFACE WATER IMPACTS				
			Permanent Fill In Wetlands (ac)	Temp. Fill In Wetlands (ac)	Excavation in Wetlands (ac)	Mechanized Clearing in Wetlands (ac)	Hand Clearing in Wetlands (ac)	Permanent SW impacts (ac)	Temp. SW impacts (ac)	Existing Channel Impacts Permanent (ft)	Existing Channel Impacts Temp. (ft)	Natural Stream Design (ft)
1	13+28/13+62 -L-	3@3mx3m RCBC						0.03	<0.01	138	26	
	Stream Bank Stabilization							0.03		125		
2	15+12/15+59 -L- LT	750mm CSP	0.11		0.01	0.06						
3 *	19+21/19+23 -L- RT	Fill						<0.01		23		
4	20+84/20+89 -L-	2@2.4mx2.4m RCBC						0.02	0.01	112	39	
	Stream Bank Stabilization							0.02		59		
5	20+89/21+45 -L-	Fill	0.22			0.06						
6 *	24+98/25+10 -L- RT	900mm RCP						<0.01	<0.01	23	20	
	Stream Bank Stabilization							<0.01		23		
7A	34+93/36+38 -L-	2.7mx1.8m RCBC	0.13			<0.01		0.03	0.01	518	108	
	Stream Bank Stabilization							0.02		82		
7B *	35+38/35+51 -L- LT	Fill						<0.01		59		
8	37+33/37+55 -L-	1050mm RCP	0.02		<0.01	0.03		0.01	<0.01	194	36	
	Stream Bank Stabilization							<0.01		13		
9	40+05/40+70 -L-	1500mm RCP						0.04	<0.01	279	33	
	Stream Bank Stabilization							<0.01		16		
10 *	11+55/11+82 -Y13- LT	900mm CSP						0.01	<0.01	92	43	
	Stream Bank Stabilization							<0.01		20		
11	50+41/51+25 -L-	1200mm RCP	<0.01					0.02	0.01	282	85	
	Stream Bank Stabilization							0.01		52		
12	51+47/51+91 -L-	750mm RCP	0.12									
13	53+13/53+79 -L-	900mm RCP	0.17		<0.01	0.07		0.01	<0.01	246	72	
SUB TOTALS:			0.77		0.01	0.21		0.26	0.03	2356	463	

* Note: Stream Impacts are Non-Mitigatable.

NC DEPARTMENT OF TRANSPORTATION
DIVISION OF HIGHWAYS

PERSON COUNTY
WBS - 34406.1.1 (R-2241A)

SHEET **47 of 48** *Rev.*
7/16/2012

WETLAND PERMIT IMPACT SUMMARY

Site No.	Station (From/To)	Structure Size / Type	WETLAND IMPACTS							SURFACE WATER IMPACTS				Natural Stream Design (ft)	
			Permanent Fill In Wetlands (ac)	Temp. Fill In Wetlands (ac)	Excavation in Wetlands (ac)	Mechanized Clearing in Wetlands (ac)	Hand Clearing in Wetlands (ac)	Permanent SW Impacts (ac)	Temp. SW Impacts (ac)	Existing Channel Impacts (ft)	Existing Channel Impacts Permanent (ft)	Existing Channel Impacts Temp. (ft)			
14	57+12/57+55 -L-	1200mm RCP	0.09		<0.01						0.02	<0.01	262	23	
	Stream Bank Stabilization										<0.01		13		
15	63+41/66+32 -L-	1350mm RCP	0.36			0.03				0.03	<0.01		653	75	
	Stream Bank Stabilization										<0.01		13		
16	64+72/64+99 -L- LT	Pond Removal									0.10				
17	67+35/69+11 -L-	1350 RCP	0.47		0.15	0.18				0.01	<0.01		146	23	
	Stream Bank Stabilization									0.01			67		
18 *	76+03/76+90 -L-	750mm/900mm RCP									0.02	0.01	354	181	
	Stream Bank Stabilization										<0.01		42		
19	77+72/79+54 -L-	Fill	0.01			0.10									
SUB TOTALS:			0.92		0.15	0.31				0.20	0.01	1551	303		
TOTALS:			1.69		0.16	0.53			0.45	0.04	3906	765			

* Note: Stream Impacts are Non-Mitigatable.

NC DEPARTMENT OF TRANSPORTATION
DIVISION OF HIGHWAYS

PERSON COUNTY
WBS - 34406.1.1 (R-2241A)

48 of 48
Rev. 7/16/2012

UTILITY IMPACTS PERMIT IMPACT SUMMARY Revised 7/6/2012

Site No.	Station (From/To)	Structure Size / Type	WETLAND IMPACTS						SURFACE WATER IMPACTS						
			Permanent Fill In Wetlands (ac)	Temp. Fill In Wetlands (ac)	Excavation in Wetlands (ac)	Mechanized Clearing in Wetlands (ac)	Hand Clearing in Wetlands (ac)	Permanent SW impacts (ac)	Temp. SW impacts (ac)	Existing Channel Impacts Permanent (ft)	Existing Channel Impacts Temp. (ft)	Natural Stream Design (ft)			
1	13+50/13+67	10" SEWER											3,000		
1	13+50/13+67	8" WATER											3,000		
1	13+50/13+67	4" GAS MAIN											2,000		
TOTALS:			0.00	0.00	0.00	0.00									

NC DEPARTMENT OF TRANSPORTATION
 DIVISION OF HIGHWAYS
 PERSON COUNTY
 WBS - 34406.1.1 (R-2241A)
 SHEET **1 of 2** *Rev.*
 7/6/2012

ATN Revised 3/31/05

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 1000 West Morehead St., Ste. 200
 Charlotte, NC 28208
 NC License Number F-0991

METRIC


CONST. REV.
 R/W REV.

PROJECT REFERENCE NO. R-2241A	SHEET NO. 5
R/W SHEET NO.	
ROADWAY DESIGN ENGINEER	HYDRAULICS ENGINEER
PRELIMINARY PLANS DO NOT USE FOR CONSTRUCTION	

UTILITY IMPACTS SITE 1

Revised
 7/6/12
 Utility Permit Drawing
 Sheet 2 of 2

	125mm MONOLITHIC ISLAND
	FULL DEPTH PAVED SHOULDER
	PAVEMENT REMOVAL

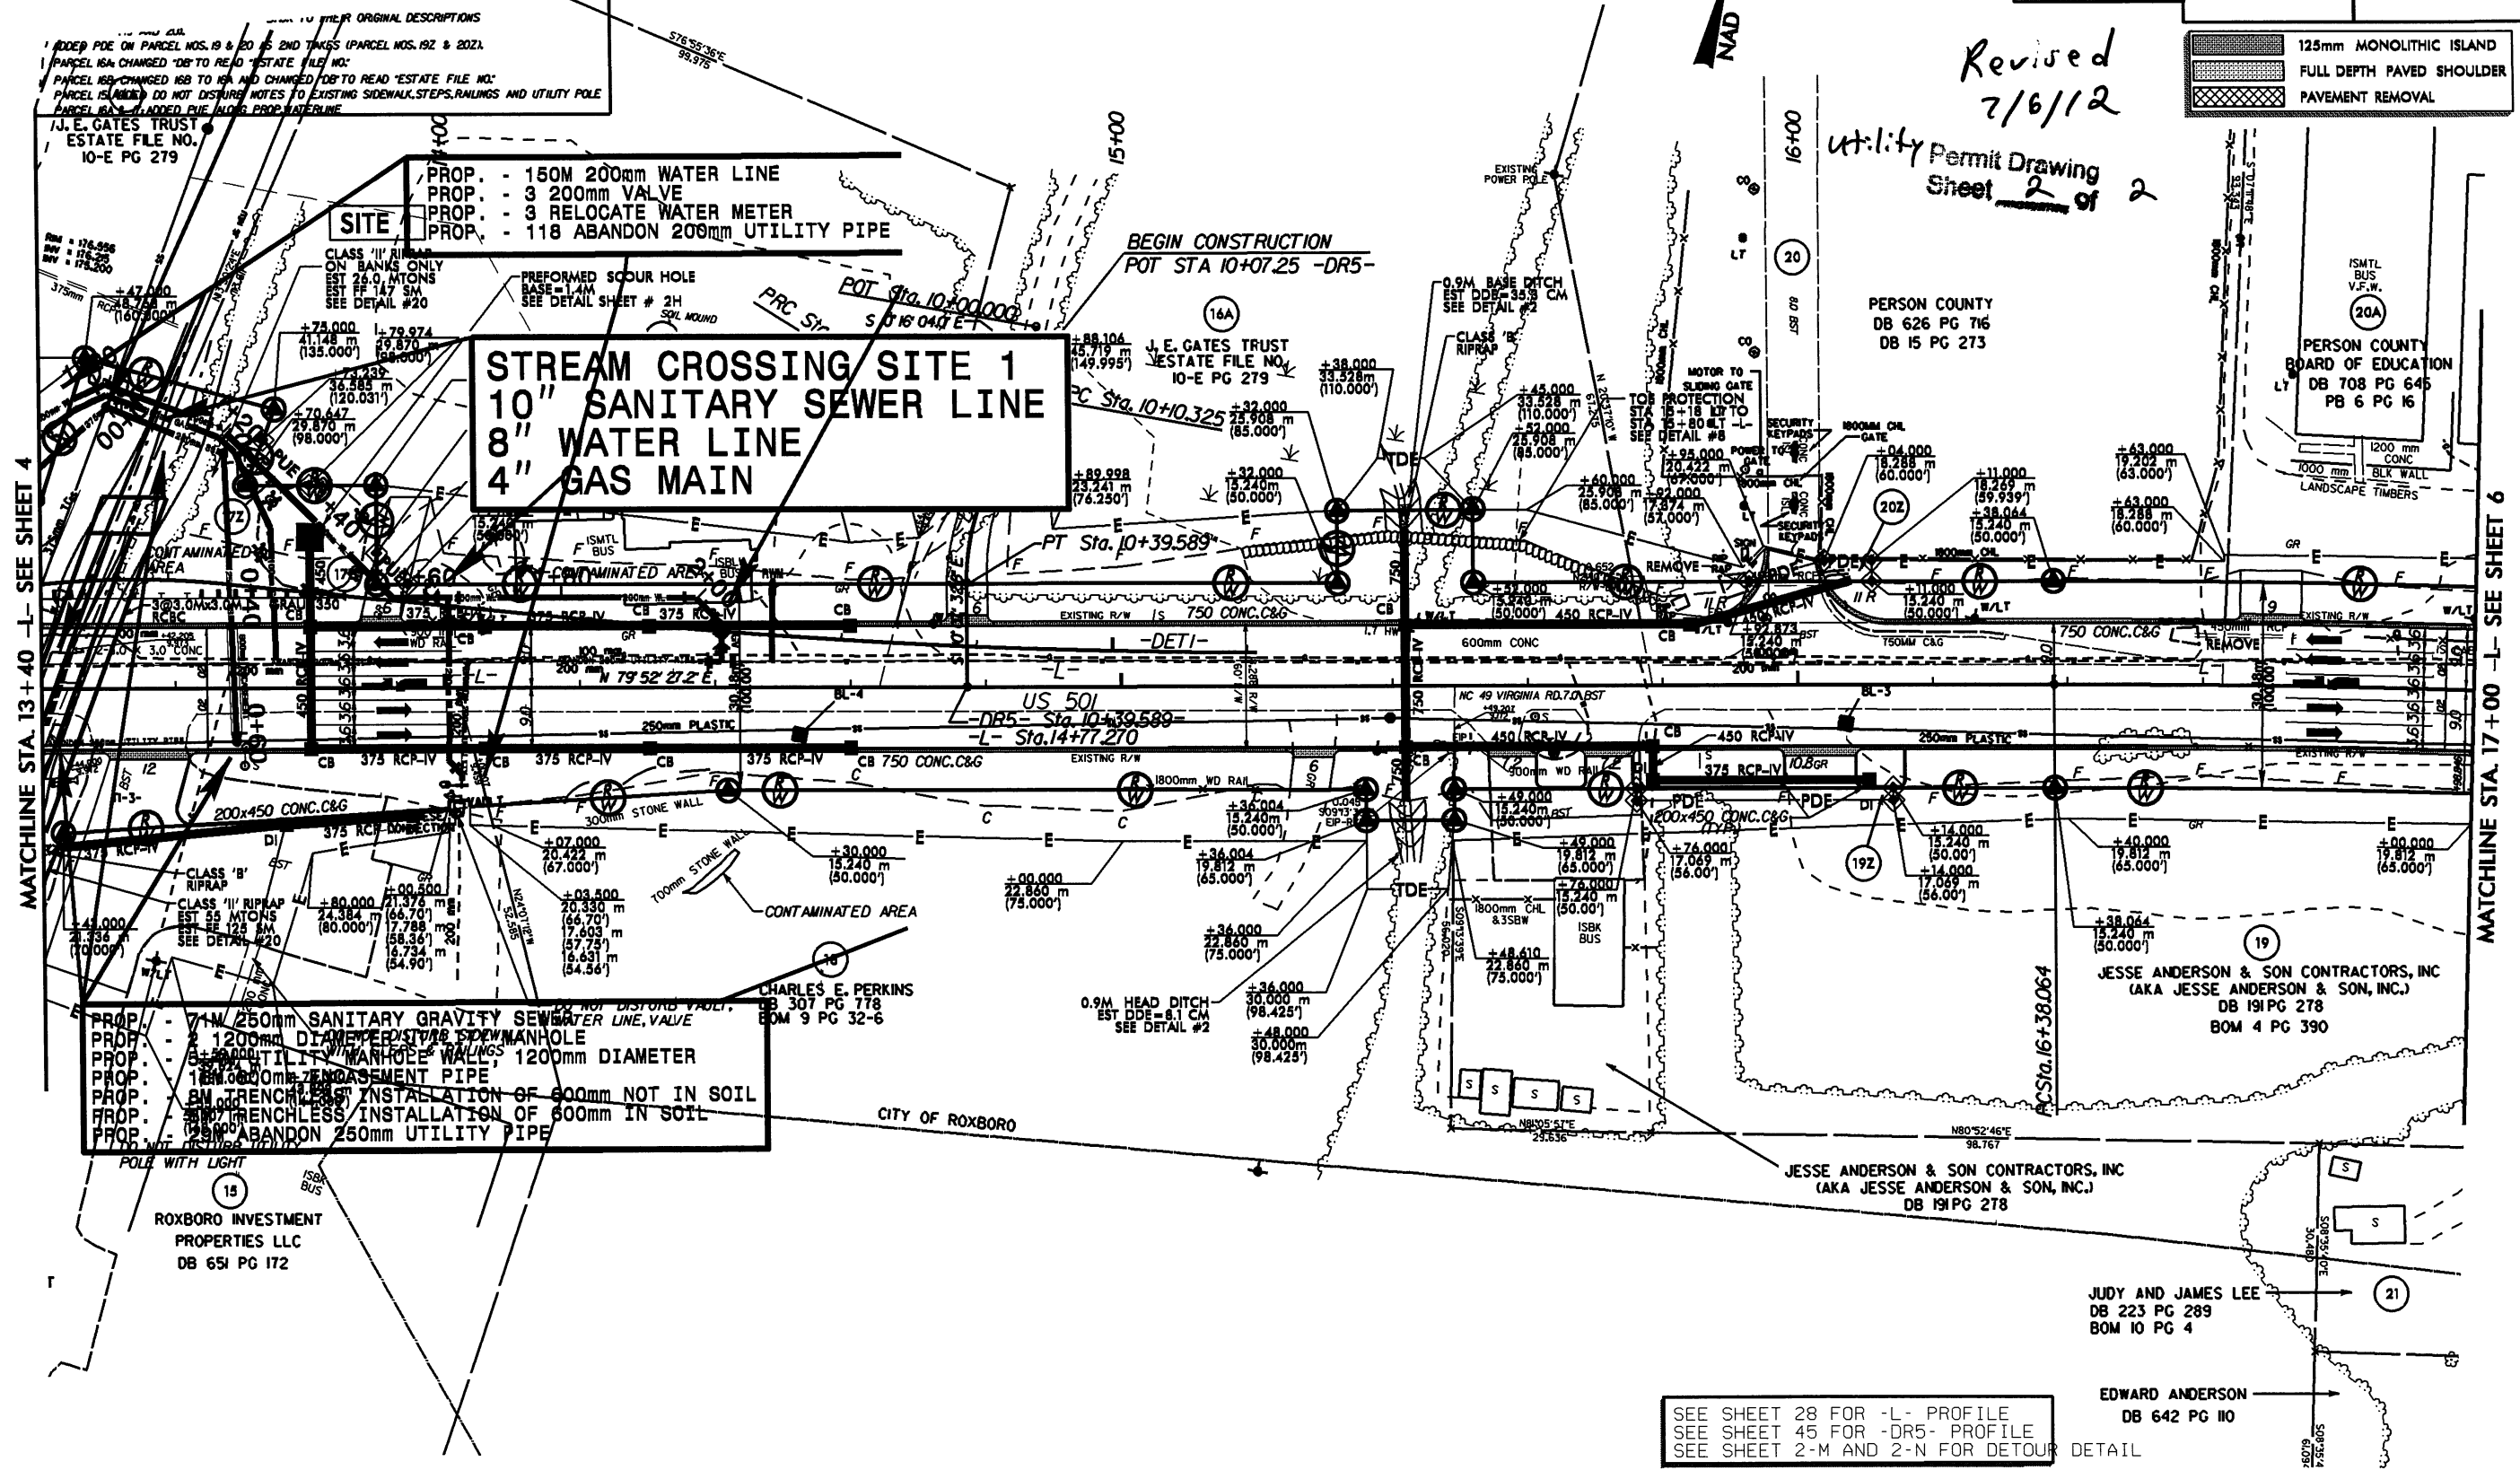

MATCHLINE STA. 13+40 -L- SEE SHEET 4

MATCHLINE STA. 17+00 -L- SEE SHEET 6

REVISED 7/6/2012 ADD GAS MAIN

06-JUL-2012 13:28
 P:\Utilities\Projects\2241A\UTL\SITE_1\PERMIT.dgn
 Author: RALPH WHITHEAD

SEE SHEET 28 FOR -L- PROFILE
 SEE SHEET 45 FOR -DR5- PROFILE
 SEE SHEET 2-M AND 2-N FOR DETOUR DETAIL

EDWARD ANDERSON
 DB 642 PG 10

JUDY AND JAMES LEE
 DB 223 PG 289
 BOM 10 PG 4

JESSE ANDERSON & SON CONTRACTORS, INC
 (AKA JESSE ANDERSON & SON, INC.)
 DB 191 PG 278

JESSE ANDERSON & SON CONTRACTORS, INC
 (AKA JESSE ANDERSON & SON, INC.)
 DB 191 PG 278
 BOM 4 PG 390

CHARLES E. PERKINS
 DB 307 PG 778
 BOM 9 PG 32-6

ROXBORO INVESTMENT
 PROPERTIES LLC
 DB 651 PG 172



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 1000 West Main Street, Suite 200
 Charlotte, NC 28208
 NC License Number T-1091

REVISIONS

08-02-11	PARCEL 16 PROPERTY LINE MODIFIED & REMOVED SHED, ADDED UNDERGROUND DRAIN LINE & MANHOLES
08-16-11	PARCEL 15A ADDED NEW PARCEL BETWEEN 16 & 17 REVISED OWNER NAME ON PARCELS 4, 9, 11, 16
08-16-11	PARCEL 10 REVISED DRIVEWAY CONNECTION & MODIFIED PROPOSED CHAIN LINK FENCE
08-16-11	PARCEL 12, 10, 8M DRIVEWAY SHIFTED TO WEST SIDE OF PROPERTY
09-09-11	PARCELS 8 & 8A COMBINED, REVISED OWNER NAME
10-07-11	REVISED PARCEL BOUNDARIES FOR PARCEL 16 AND 16A
10-07-11	ADDED SUBSURFACE DRAINAGE FOR PARCEL 16 AND 16A
11-07-11	PARCEL 16: ADDED POE FOR DRAINAGE STRUCTURE
11-07-11	PARCEL 7: ADDED R/W AND MODIFIED TEMPORARY EASEMENTS
01-03-12	PARCEL 12: REVISED DRIVEWAY GRADE (10%) FOR TRUCK ACCESS
01-12-12	PARCEL 16A CHANGED "DB" TO READ "ESTATE FILE NO."
03-08-12	PARCEL 16A: ADDED FUE ALONG PROP. WATERLINE
06-29-12	PARCEL 22: REVISED DRIVEWAY PROFILE AND MODIFIED TEMPORARY EASEMENT

US 501 -Y1- & -Y2- TRAFFIC VOLUMES


10,300	7,300	1,000	10,200
14,200	9,500	1,800	11,500
15,300	17,500	1,400	1,600
US 501	NC 49	US 501	NC 49
2011	ADT	5,000	7,400
2035	ADT	7,400	5,000

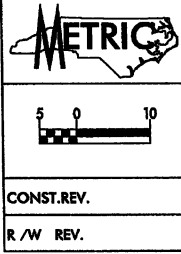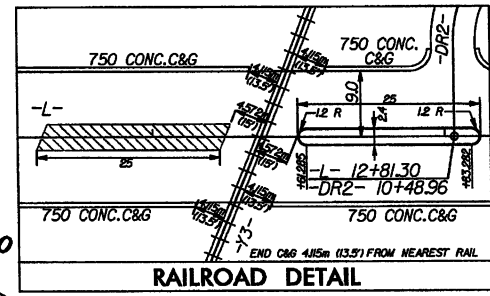

PROJECT REFERENCE NO. R-2241A
 SHEET NO. 4
 ROADWAY DESIGN ENGINEER
 HYDRAULICS ENGINEER
PRELIMINARY PLANS
 DO NOT USE FOR CONSTRUCTION
 Revised
 7/5/12

125mm MONOLITHIC ISLAND
 FULL DEPTH PAVED SHOULDER
 PAVEMENT REMOVAL
 REVISED SIGNAL

06-29-10 - PARCEL 1 AND CLAIM REMOVED PARCEL NUMBER
 06-29-10 - PARCELS 6, 9, 10, 11, 999, 1000

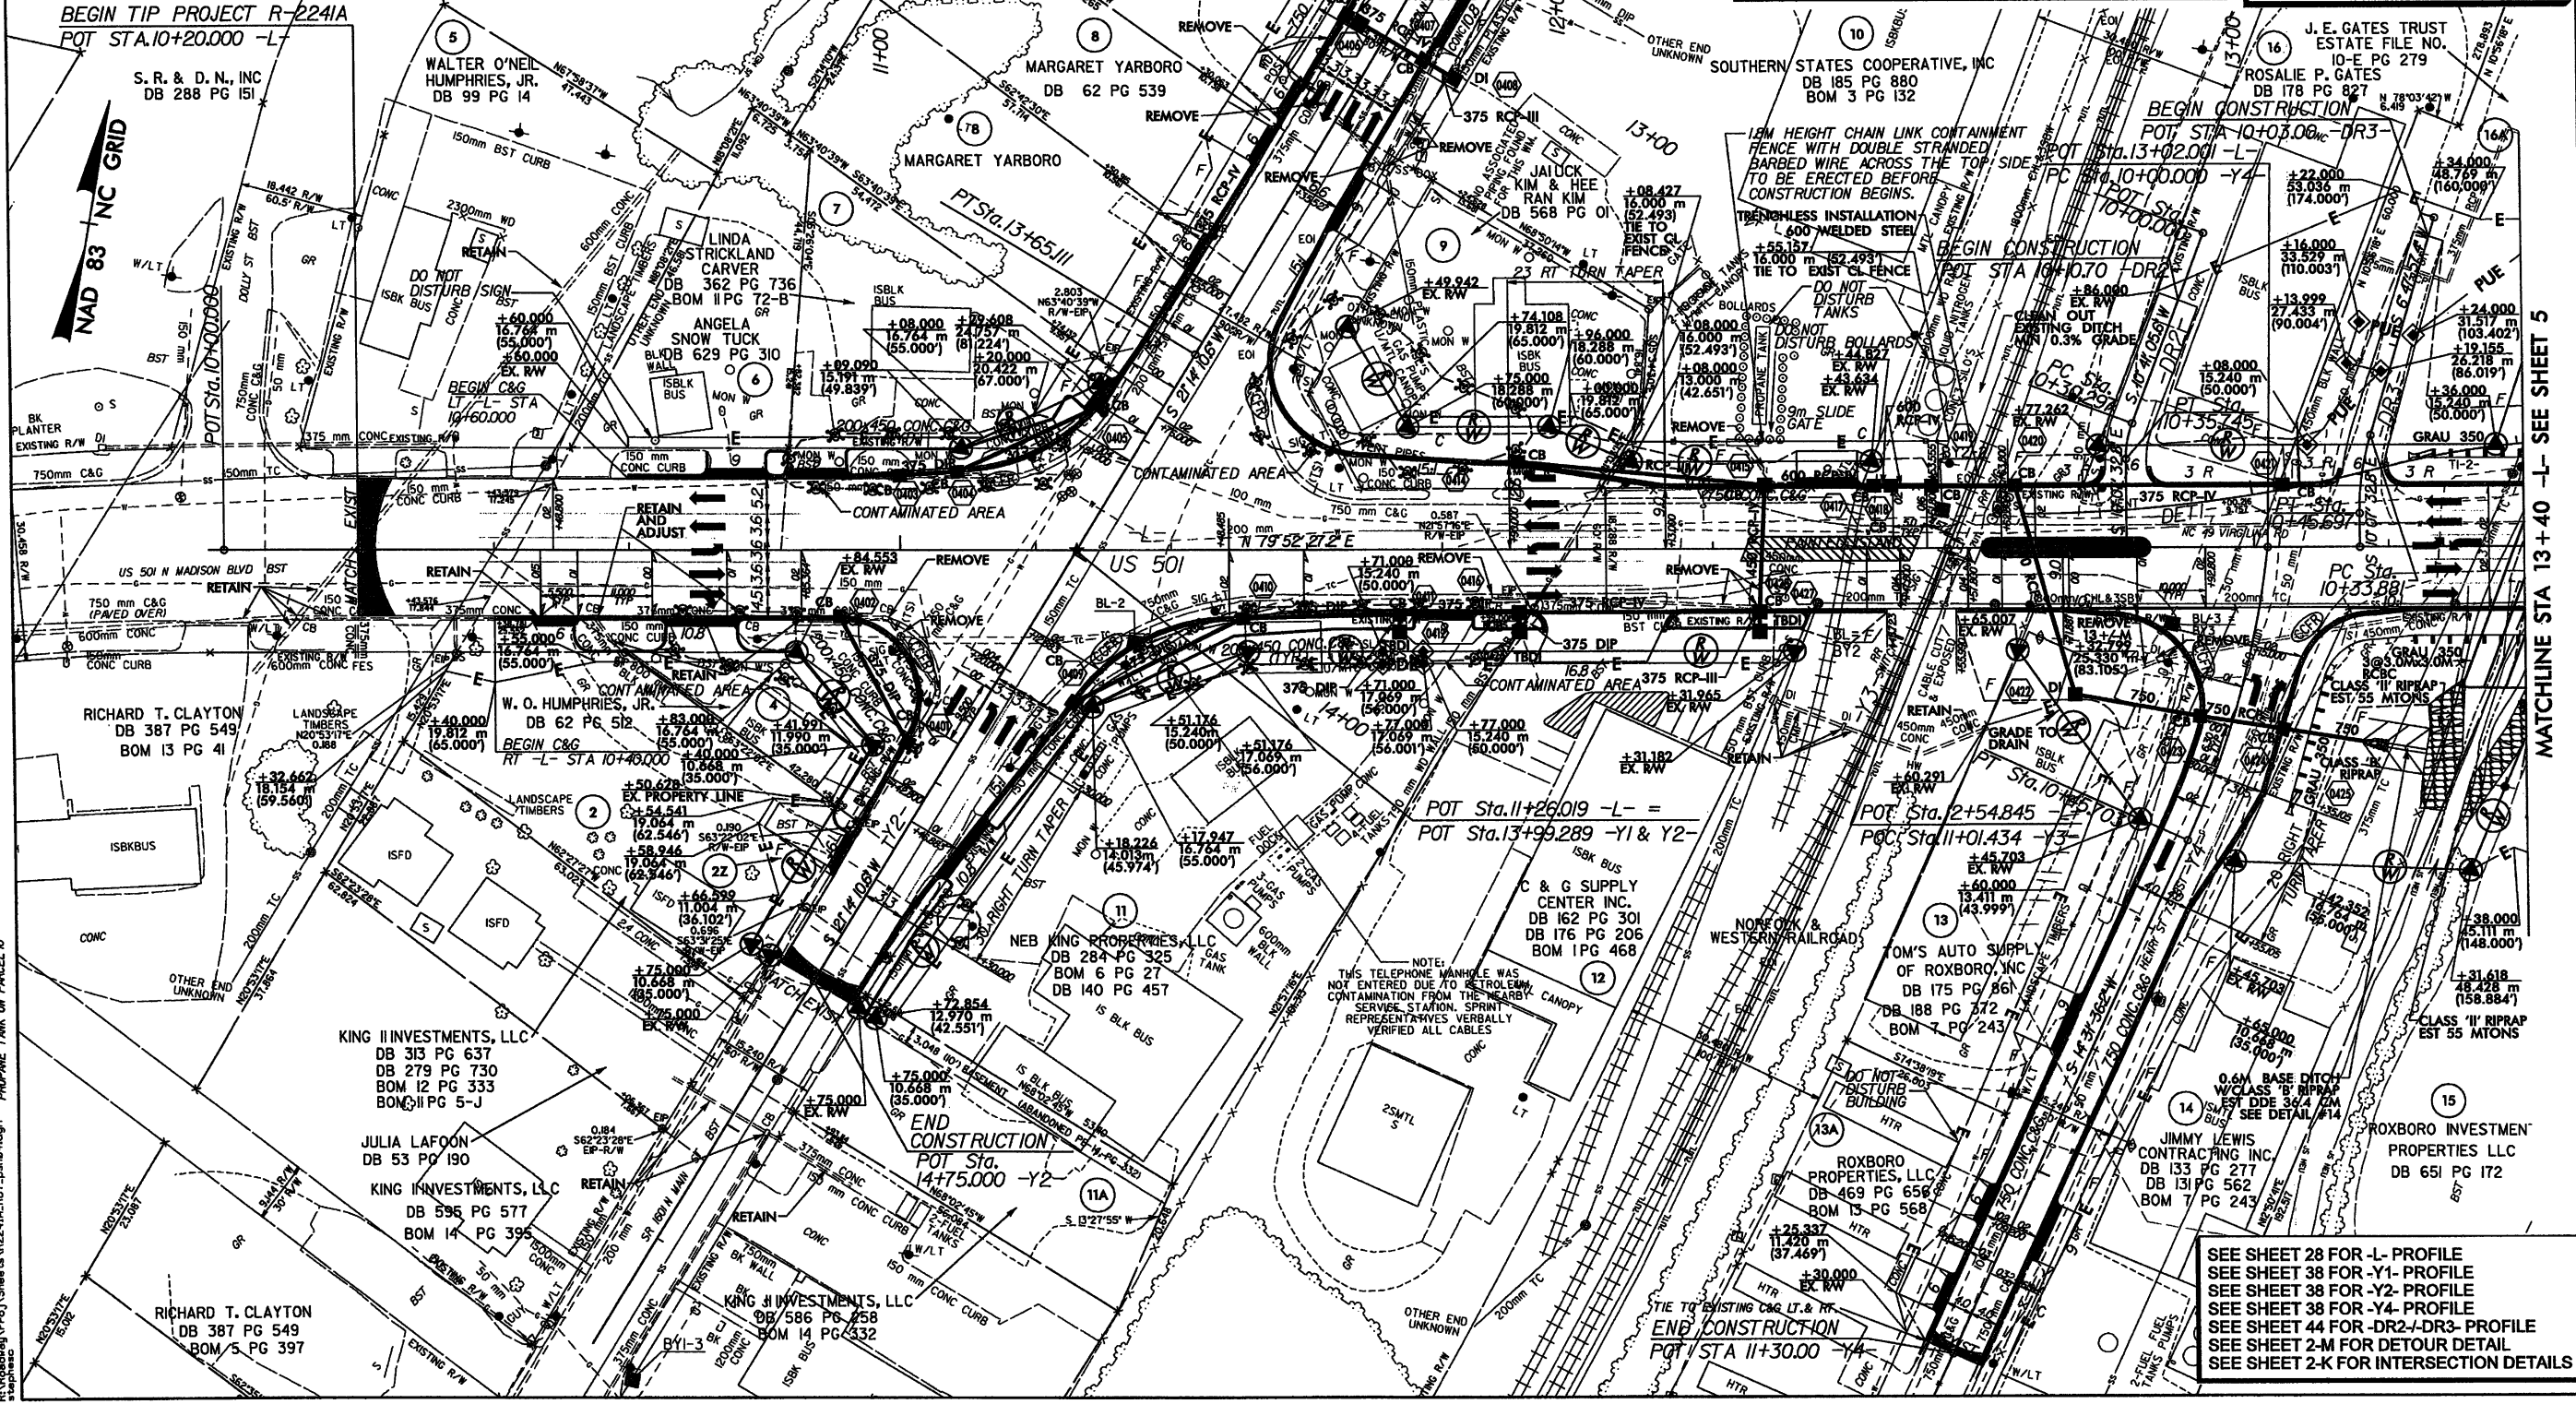

SEE SHEET 28 FOR -L- PROFILE
 SEE SHEET 38 FOR -Y1- PROFILE
 SEE SHEET 38 FOR -Y2- PROFILE
 SEE SHEET 38 FOR -Y4- PROFILE
 SEE SHEET 44 FOR -DR2-DR3- PROFILE
 SEE SHEET 2-K FOR DETOUR DETAIL
 SEE SHEET 2-M FOR INTERSECTION DETAILS

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 1000 West Morehead St., Ste. 200
 Charlotte, NC 28203
 NC License Number F-0991


METRIC

CONST. REV.
 R/W REV.

PROJECT REFERENCE NO. R-2241A	SHEET NO. 8
R/W SHEET NO.	
ROADWAY DESIGN ENGINEER	HYDRAULICS ENGINEER
PRELIMINARY PLANS DO NOT USE FOR CONSTRUCTION	

	125mm MONOLITHIC ISLAND
	FULL DEPTH PAVED SHOULDER
	PAVEMENT REMOVAL

Revised
7/5/12

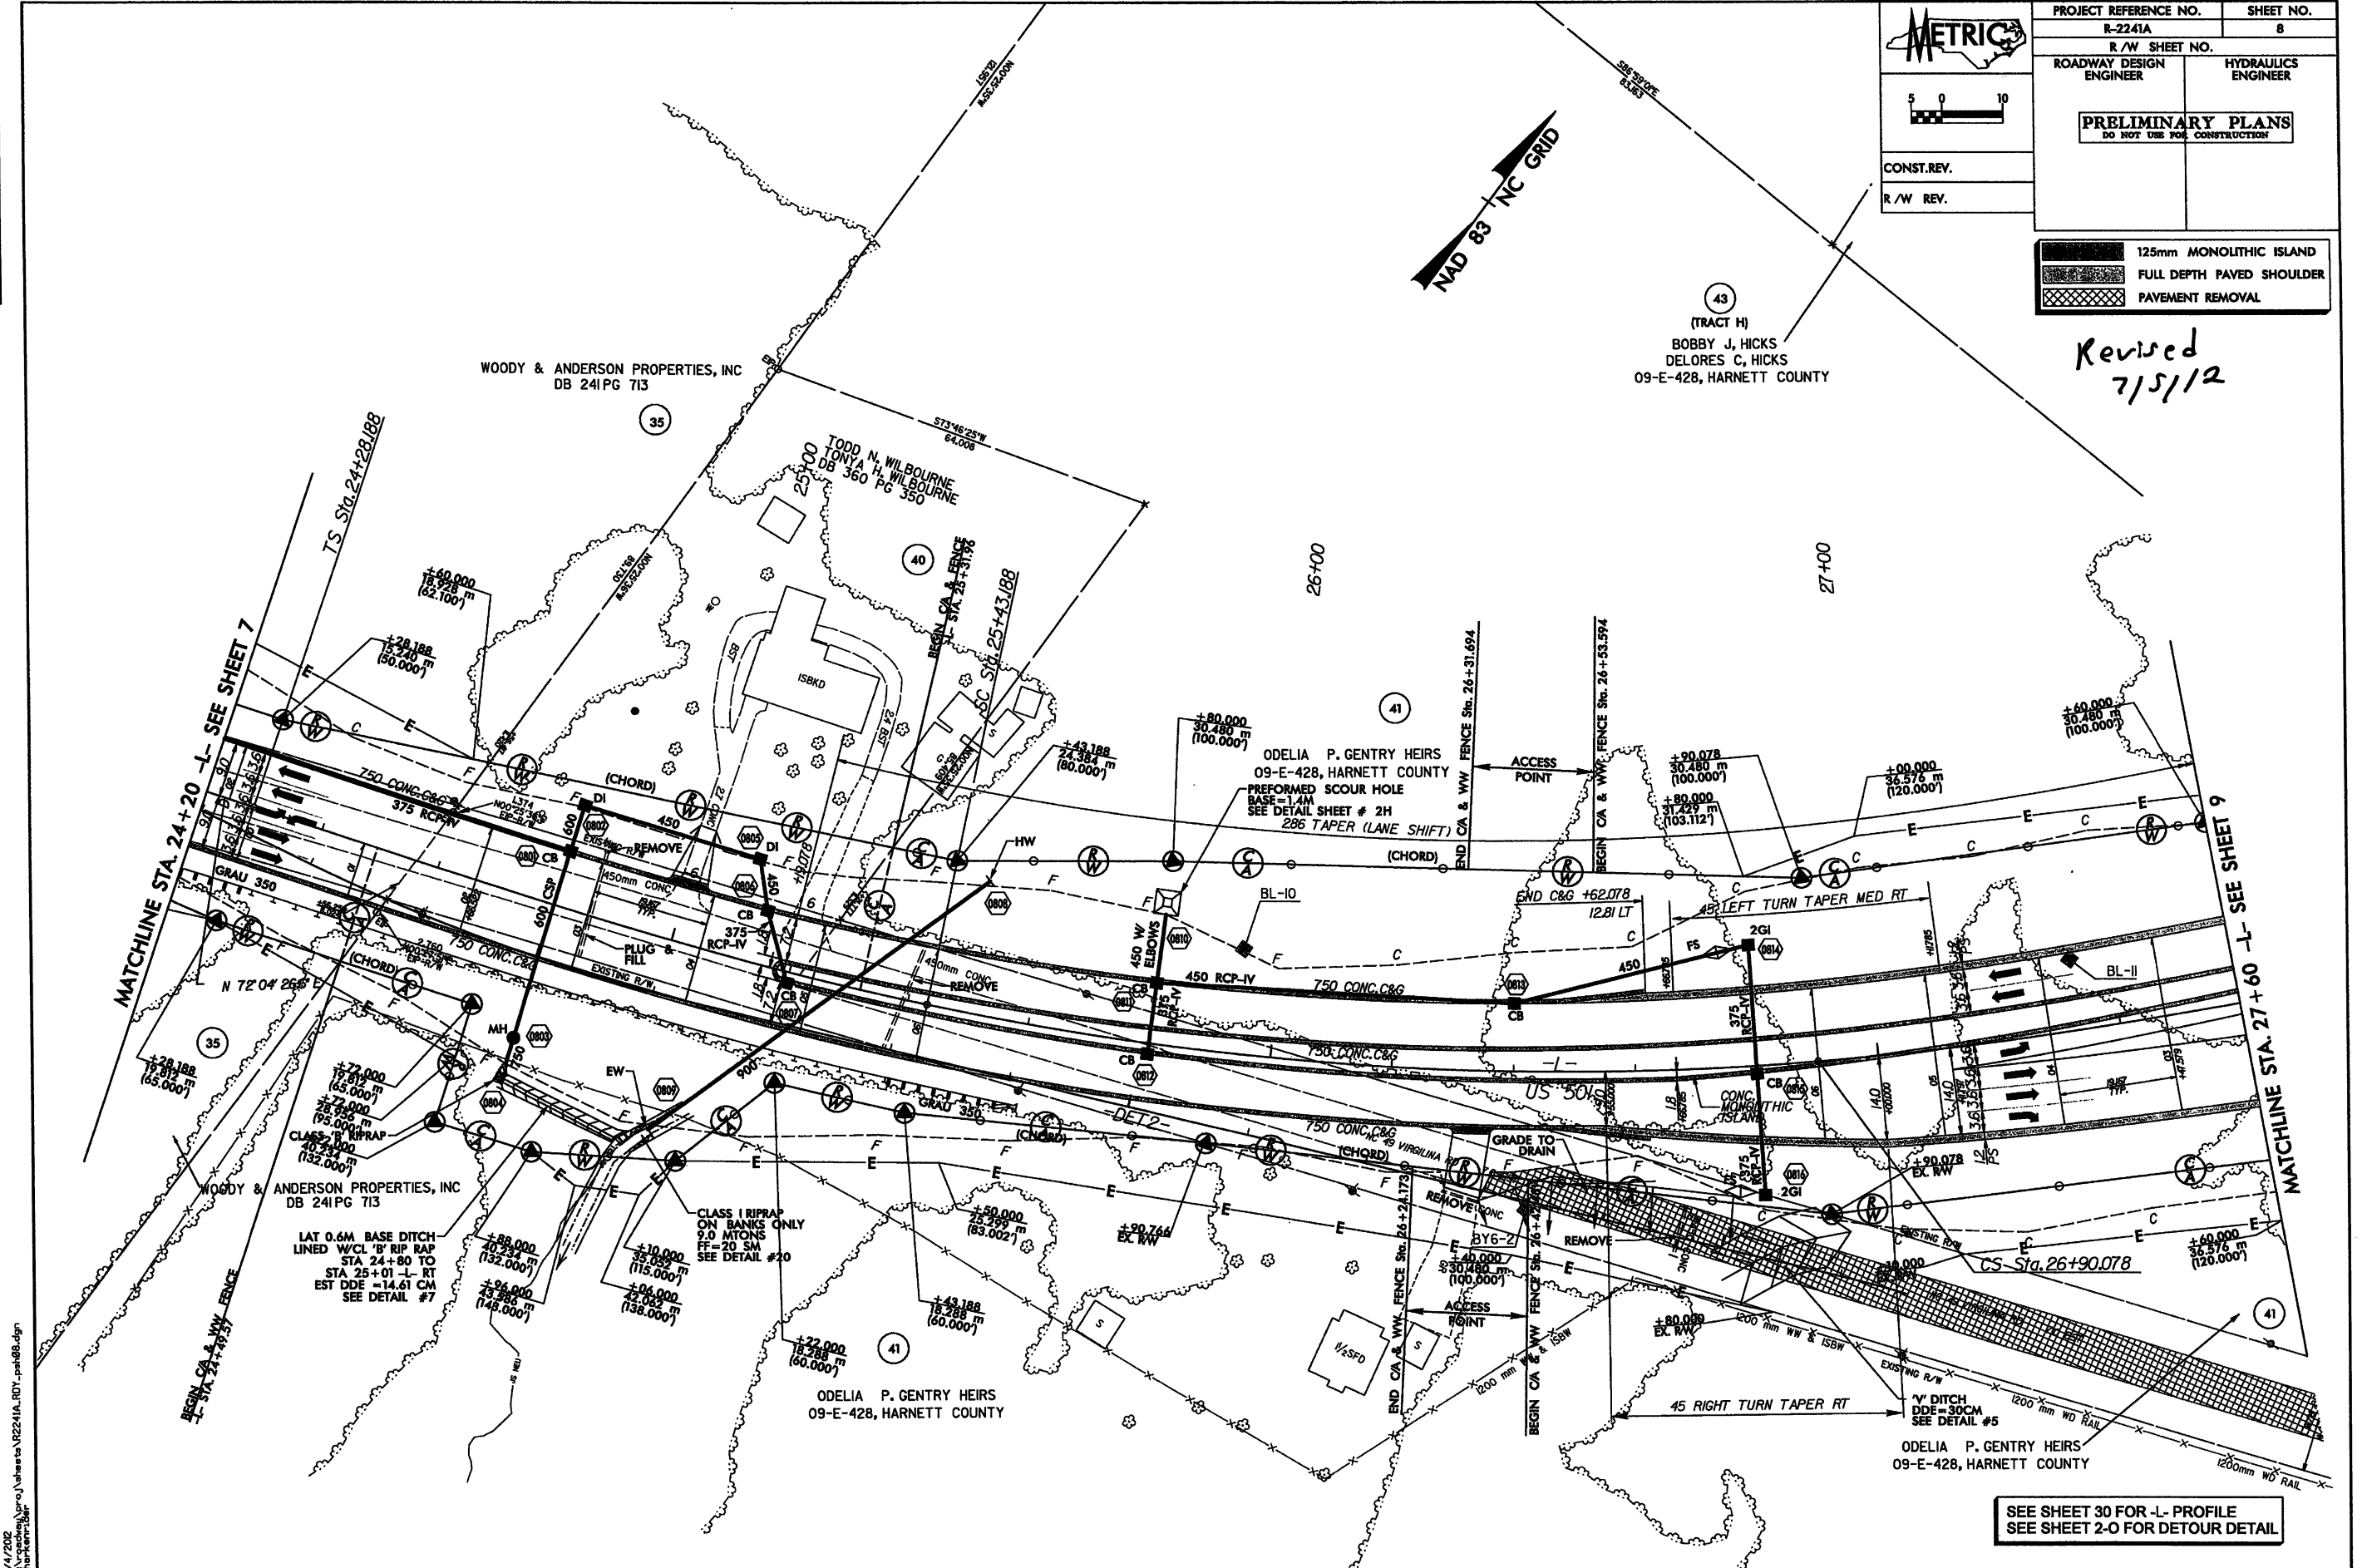

4/4/2002
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 StanHammer

SEE SHEET 30 FOR -L- PROFILE
 SEE SHEET 2-0 FOR DETOUR DETAIL

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 1000 Whitehall Rd., Suite 200
 Charlotte, NC 28208
 NC License Number F-0991


METRIC

CONST. REV.
 R/W REV.

PROJECT REFERENCE NO. R-2241A	SHEET NO. 15
R/W SHEET NO.	
ROADWAY DESIGN ENGINEER	HYDRAULICS ENGINEER
PRELIMINARY PLANS DO NOT USE FOR CONSTRUCTION	

	125mm MONOLITHIC ISLAND
	FULL DEPTH PAVED SHOULDER
	PAVEMENT REMOVAL

Revised
7/5/12

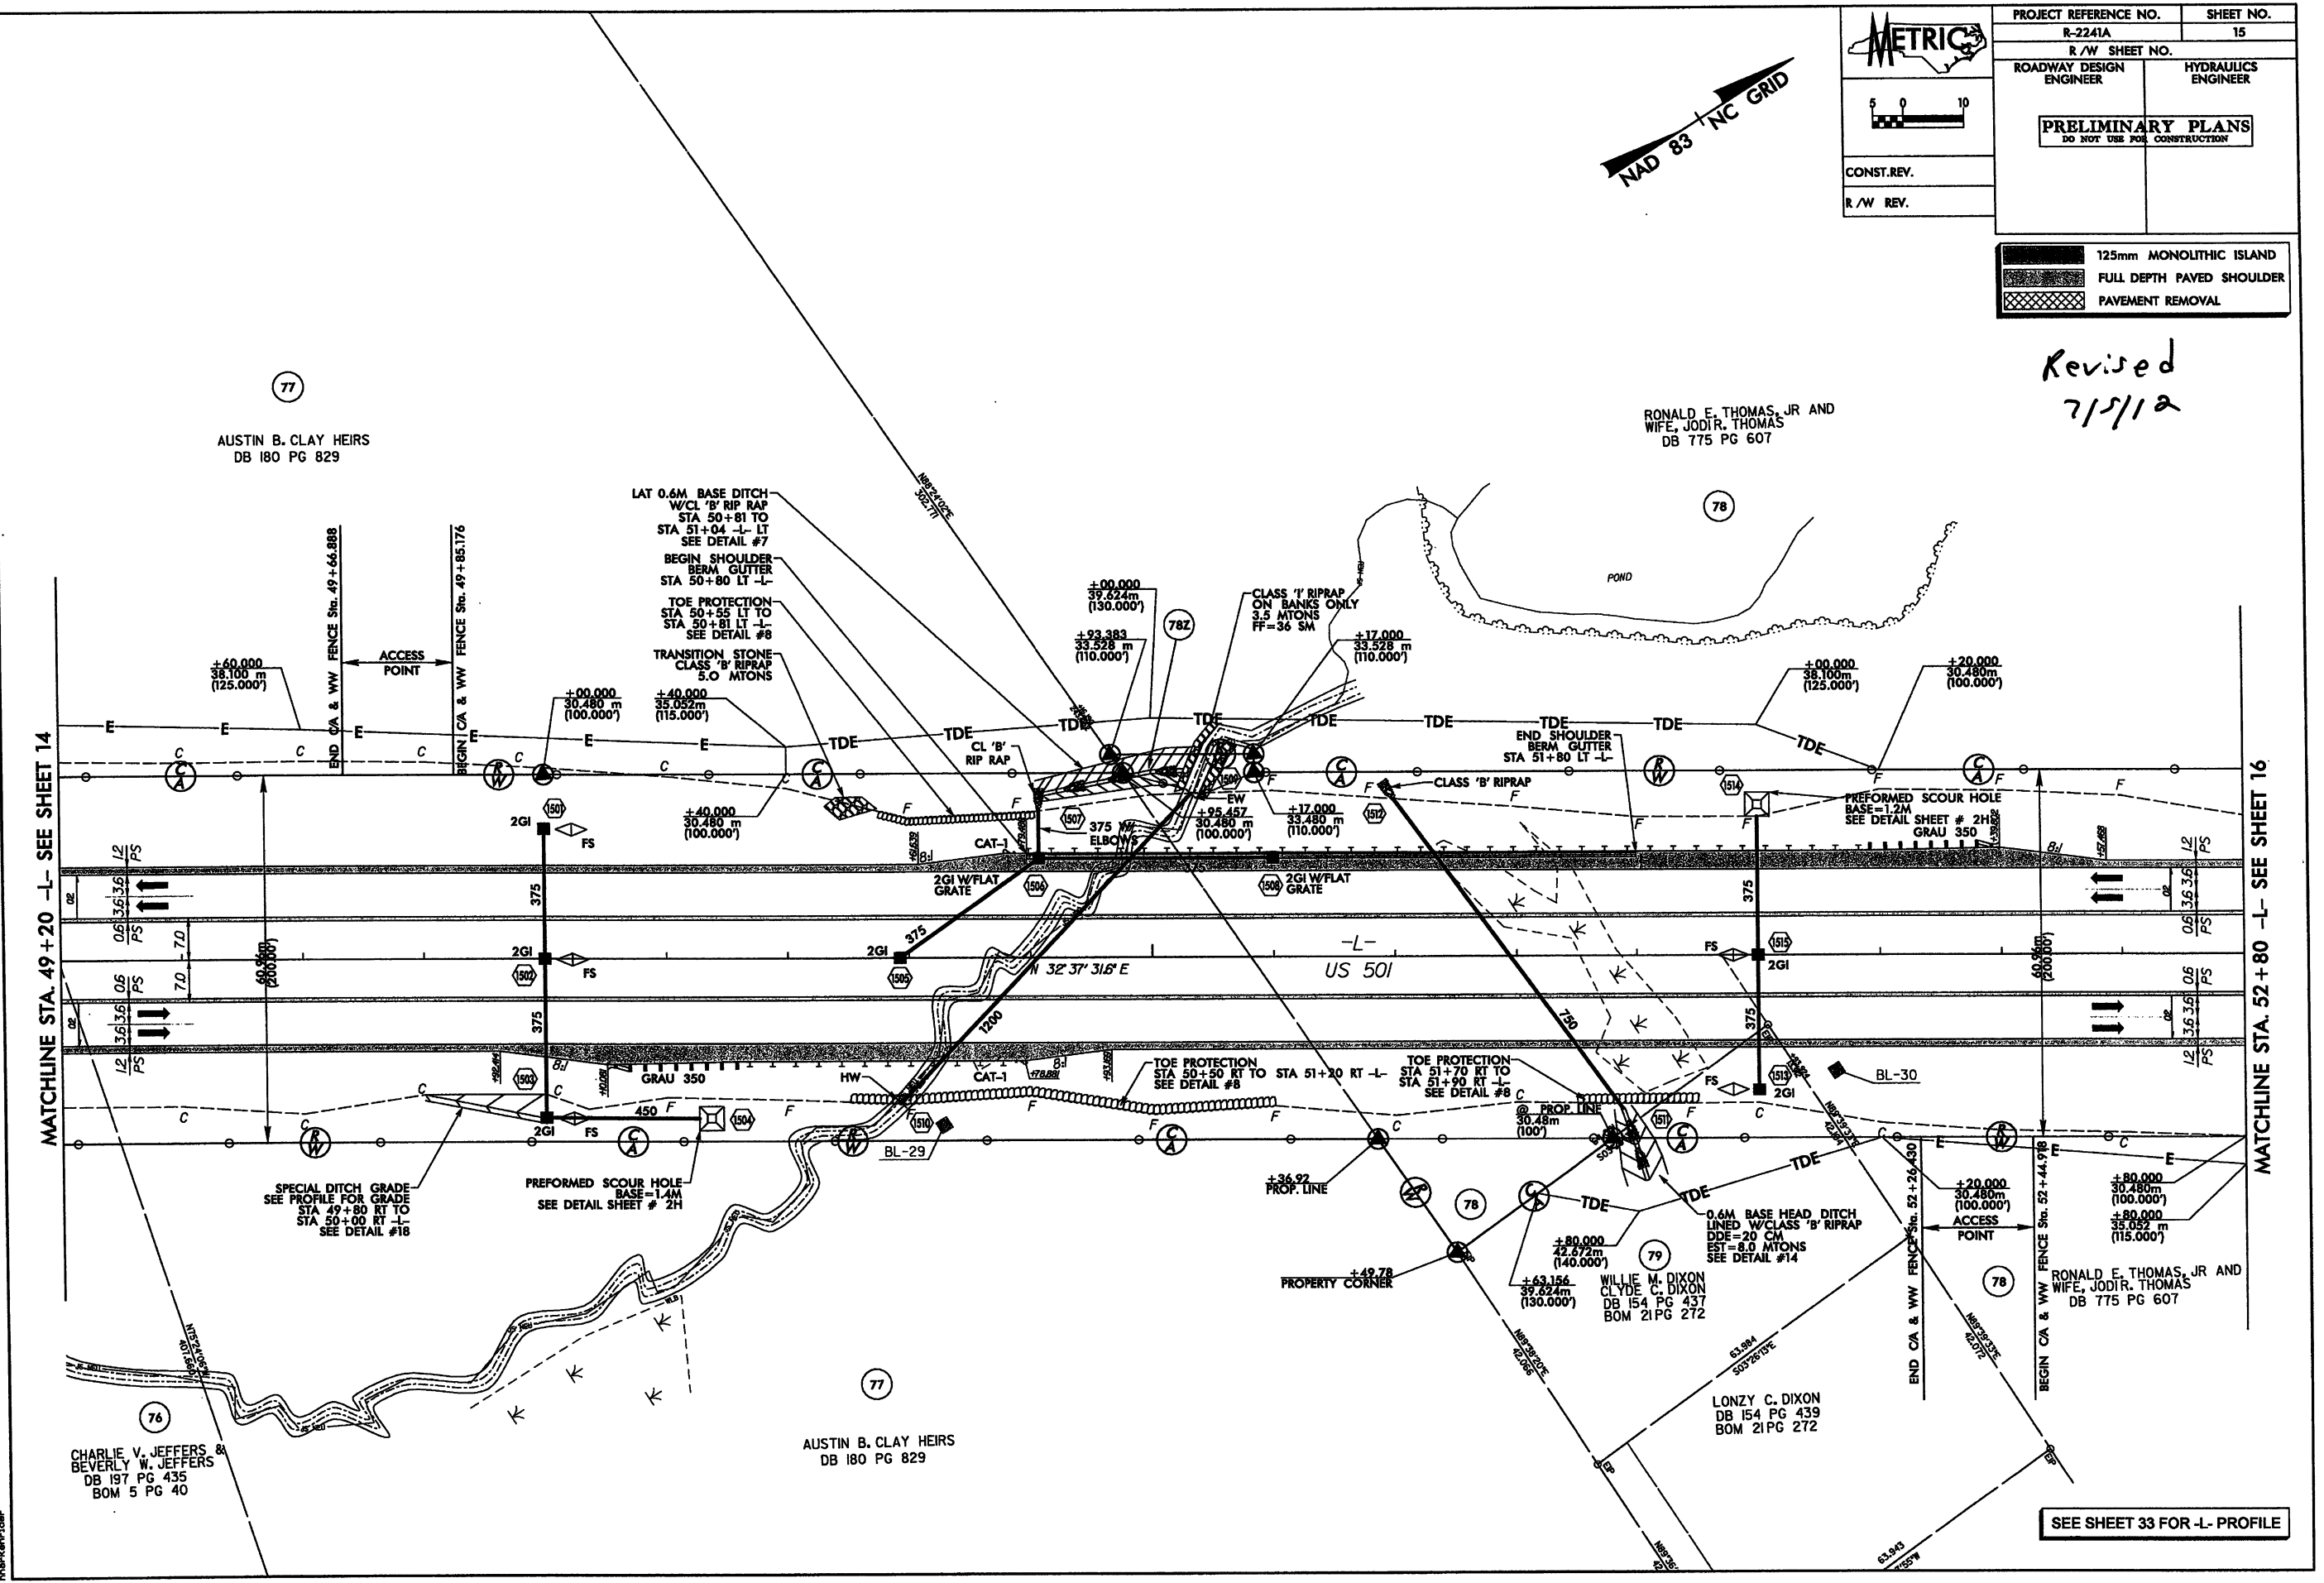

4/4/2012
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SEE SHEET 33 FOR -L- PROFILE

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 1000 Westwood Blvd., Suite 200
 Charlotte, NC 28208
 NC License Number F-0981

REVISIONS	
06-04-08	NEW PARCEL 87A AND PROPERTY LINE CHANGE ON PARCEL 87
06-21-10	PARCEL 82 LOCATED FENCE PARCEL 87A LOCATED SHED, GARAGE, MOBILE HOME, REVISED PARCEL NAME PARCEL 90, REVISED PARCEL NAME
08-02-11	COMBINED PARCEL 87A WITH PARCEL 87 CHANGED PROPERTY INFORMATION ON PARCEL 89
08-09-11	PARCEL 87, REVISED OWNER NAME
11-28-11	CHANGED PARCEL NUMBER FROM 87 TO 87Z
11-28-11	CHANGED PARCEL NUMBER FROM 89 TO 89Z
11-28-11	PARCEL 85, 86, 87Z AND 89Z; MODIFIED C/A, FENCE, AND TEMPORARY EASEMENTS
01-03-12	CONVERTED PARCEL NOS. 87Z AND 89Z BACK TO THEIR ORIGINAL DESCRIPTIONS (PARCEL NOS. 87 AND 89).
01-03-12	MODIFIED ROW C/A, FENCE AND TEMPORARY EASEMENTS ON PARCEL NOS. 85, 86, AND 87 AND 89 AS 2ND TAKES (PARCEL NOS. 87Z AND 89Z).
06-29-12	PARCEL 87Y; MODIFIED TEMPORARY EASEMENT

METRIC


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CONST. REV.


R/W REV.

PROJECT REFERENCE NO. R-2241A	SHEET NO. 19
R/W SHEET NO.	
ROADWAY DESIGN ENGINEER	HYDRAULICS ENGINEER
PRELIMINARY PLANS DO NOT USE FOR CONSTRUCTION	

	125mm MONOLITHIC ISLAND
	FULL DEPTH PAVED SHOULDER
	PAVEMENT REMOVAL

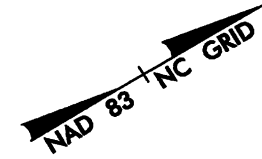

Revised
7/5/12

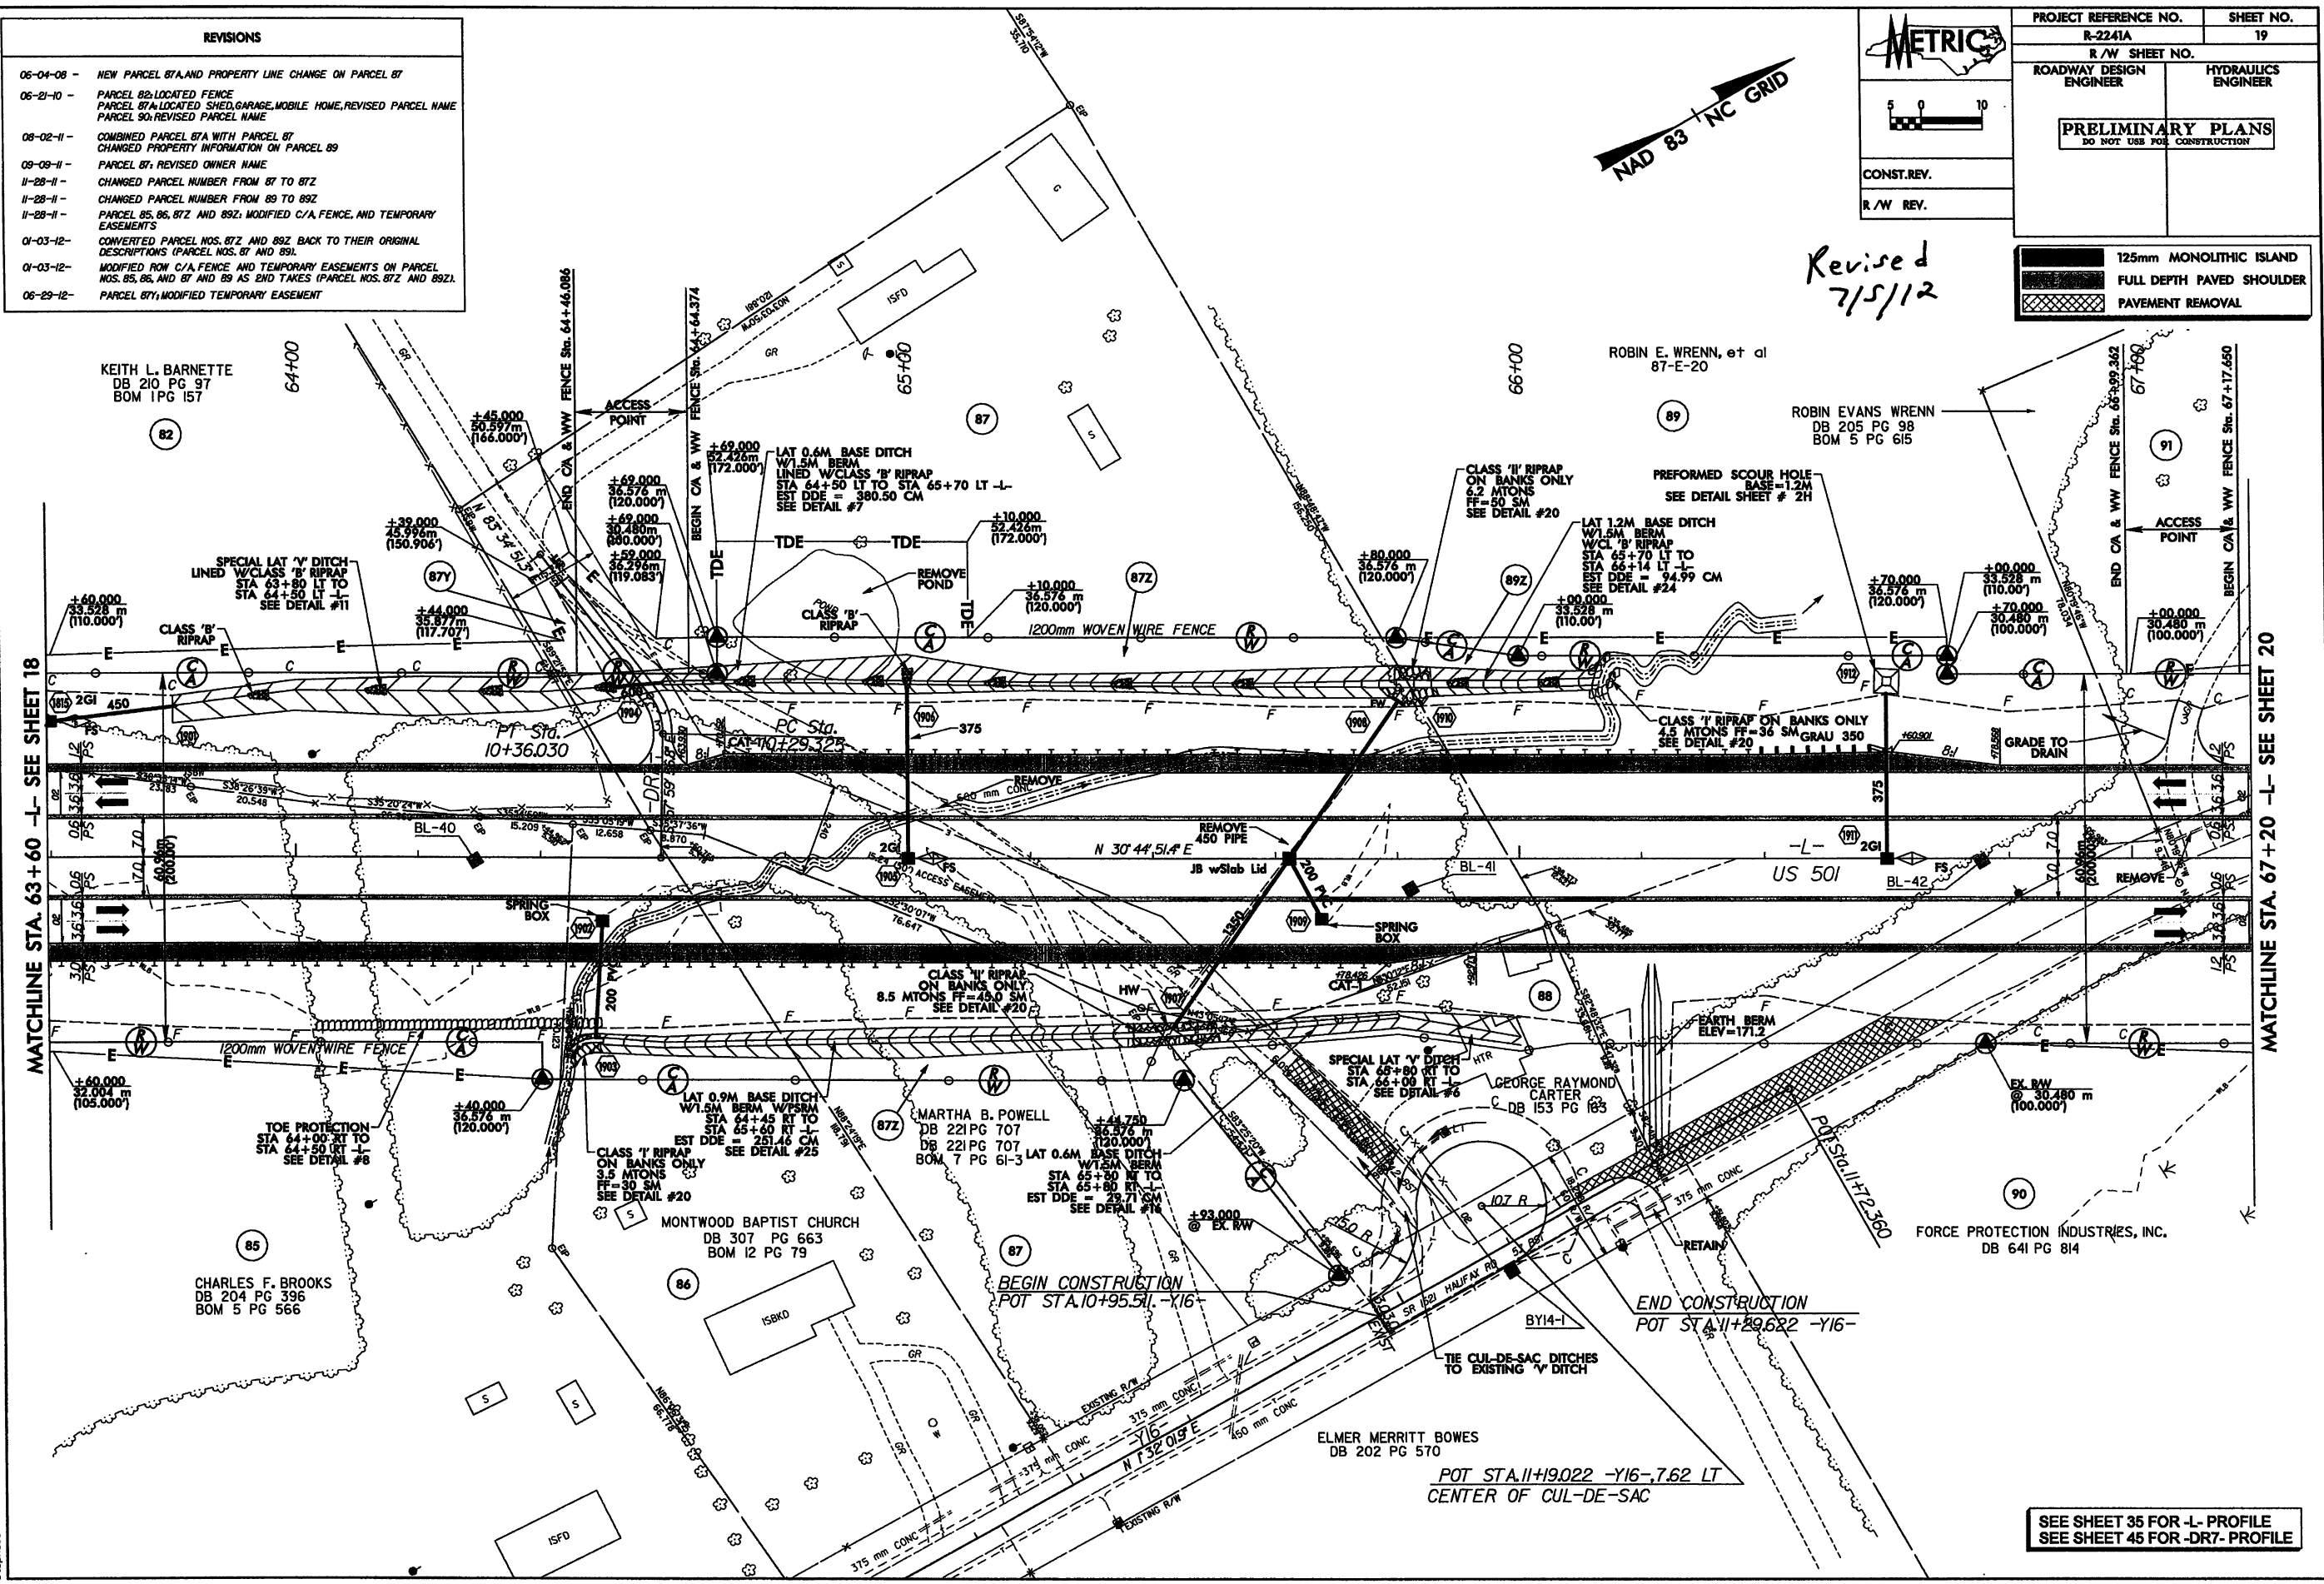

6/27/2012
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SEE SHEET 35 FOR -L- PROFILE
 SEE SHEET 45 FOR -DR7- PROFILE

STV / Ralph Whithead Associates, Inc.
 1000 West Morehead Street, Suite 200
 Charlotte, NC License Number E-9981

METRIC


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CONST. REV.
 R/W REV.

PROJECT REFERENCE NO. R-2241A	SHEET NO. 20
R/W SHEET NO.	
ROADWAY DESIGN ENGINEER	HYDRAULICS ENGINEER
PRELIMINARY PLANS DO NOT USE FOR CONSTRUCTION	

125mm MONOLITHIC ISLAND
FULL DEPTH PAVED SHOULDER
PAVEMENT REMOVAL

Revised
7/5/12

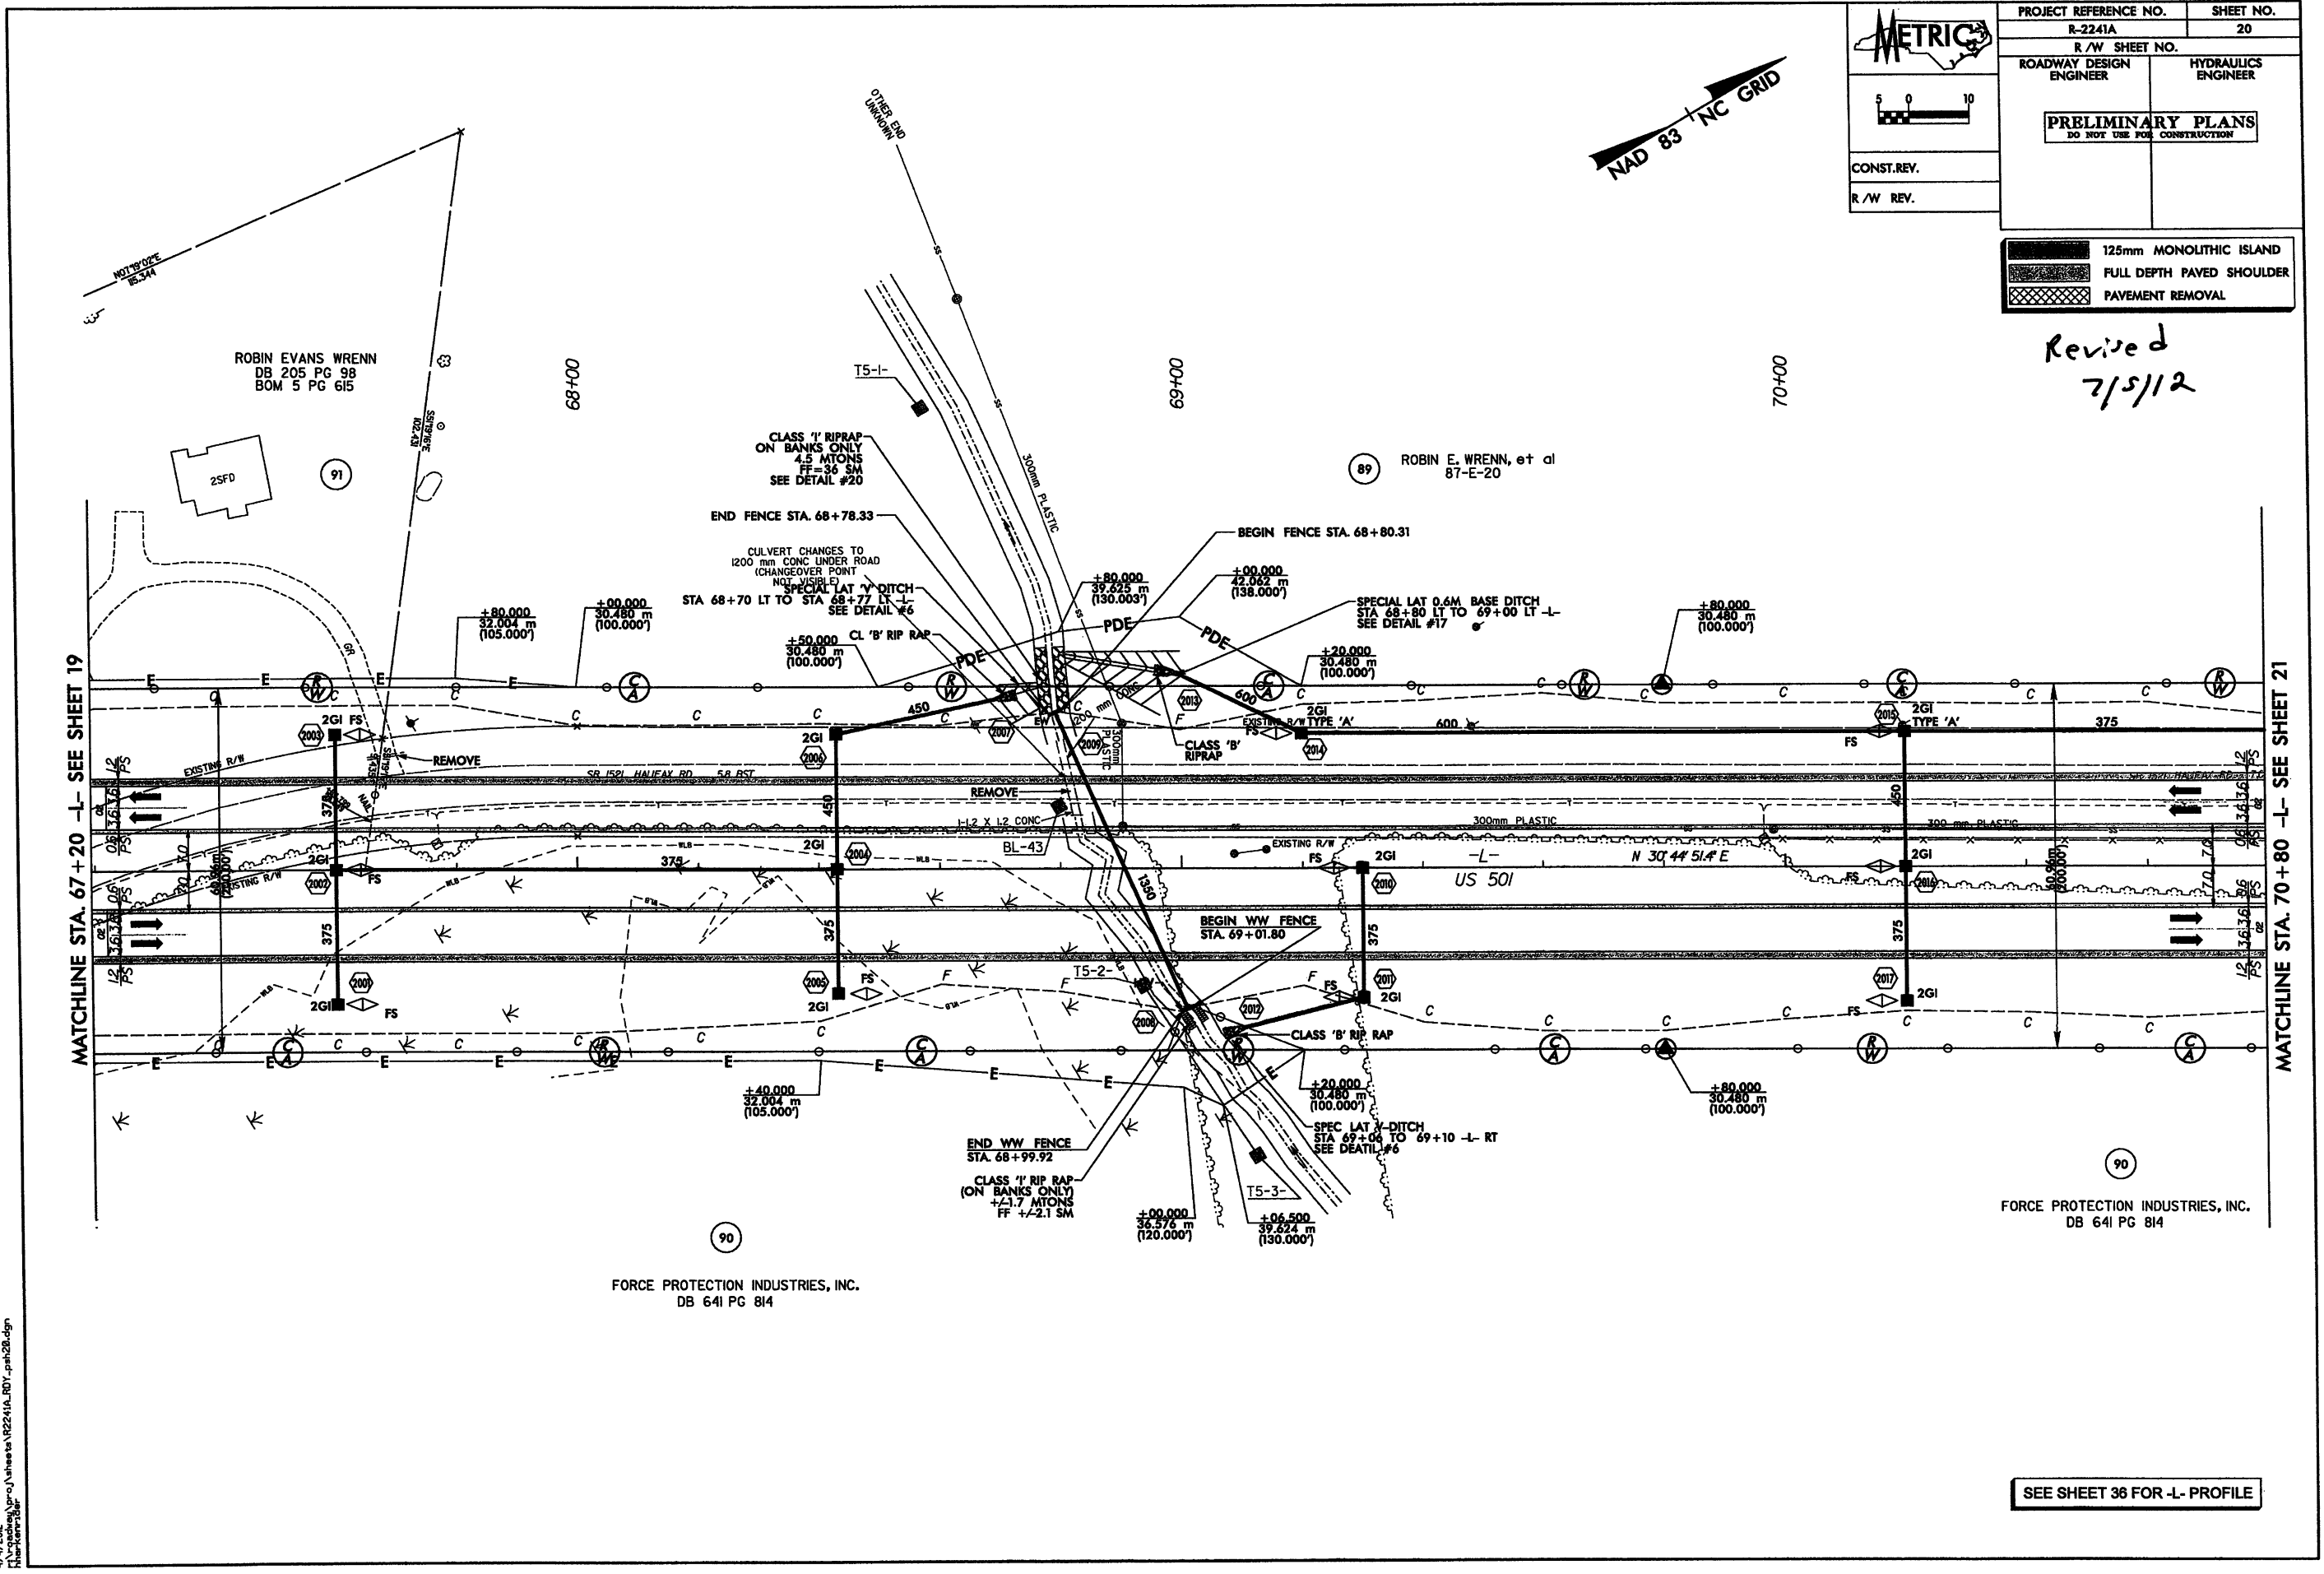

FORCE PROTECTION INDUSTRIES, INC.
 DB 641 PG 814

FORCE PROTECTION INDUSTRIES, INC.
 DB 641 PG 814

SEE SHEET 36 FOR -L- PROFILE

4/1/2012
 C:\projects\shasta\R2241A\RDY_pah20.dgn
 CharKerr

STV/Ralph Whitehead Associates, Inc.
 1000 West Hargett Street, Suite 200
 Raleigh, NC 27601
 NC License Number F-0991


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CONST. REV.
 R/W REV.

PROJECT REFERENCE NO. R-2241A	SHEET NO. 22
R/W SHEET NO.	HYDRAULICS ENGINEER
ROADWAY DESIGN ENGINEER	CONSTRUCTION ENGINEER
PRELIMINARY PLANS DO NOT USE FOR CONSTRUCTION	

	125mm MONOLITHIC ISLAND
	FULL DEPTH PAVED SHOULDER
	PAVEMENT REMOVAL

Revised
7/5/12

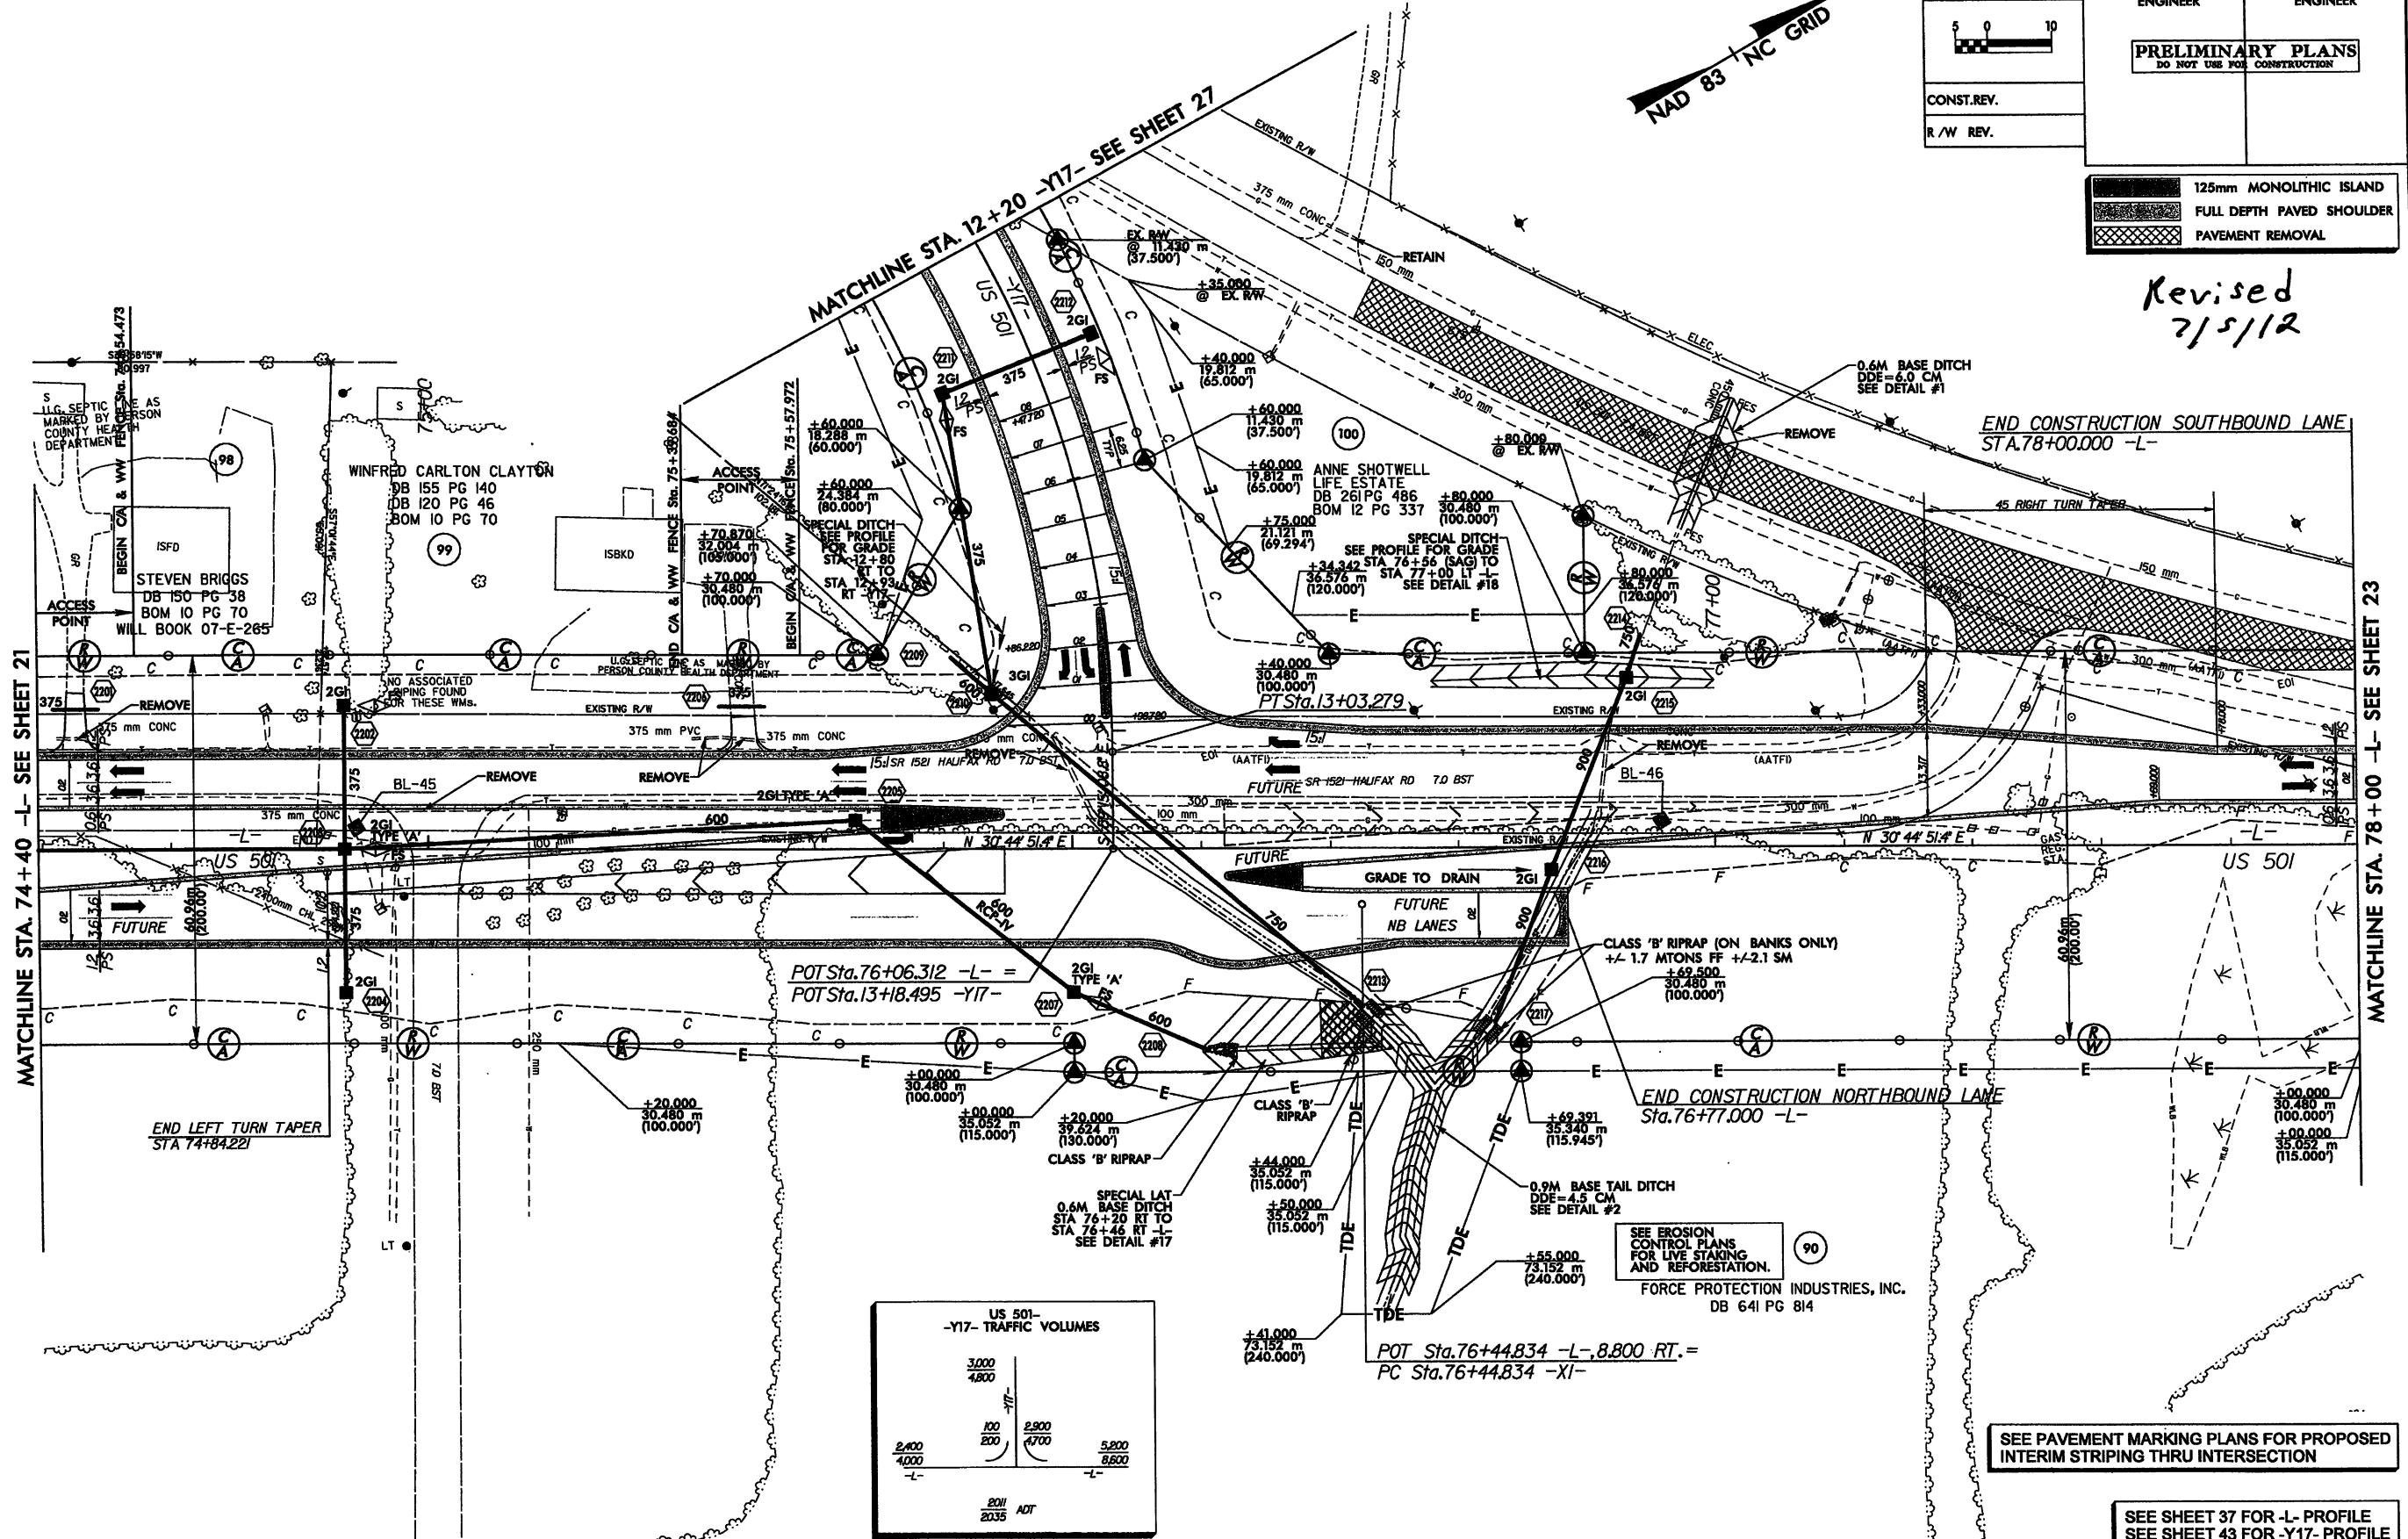

4/15/2012
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SEE PAVEMENT MARKING PLANS FOR PROPOSED INTERIM STRIPING THRU INTERSECTION

SEE SHEET 37 FOR -L- PROFILE
 SEE SHEET 43 FOR -Y17- PROFILE