

STATE OF NORTH CAROLINA
DIVISION OF HIGHWAYS

CALDWELL COUNTY

T.I.P. NO. SHEET NO.

UC-1


U-4700CC


UTILITY CONSTRUCTION PLANS

LOCATION: US 321 (HICKORY BLVD.) AT SR 1108 (MISSION RD.)


AND SR 1109 (LOWER CEDAR VALLEY RD.)

TYPE OF WORK: WATER & SEWER LINE RELOCATION

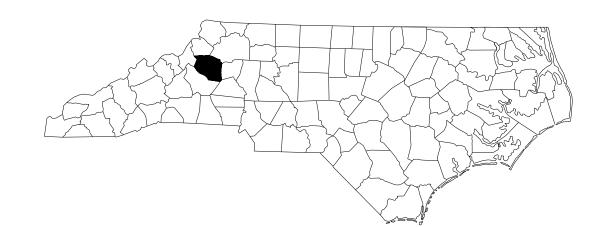

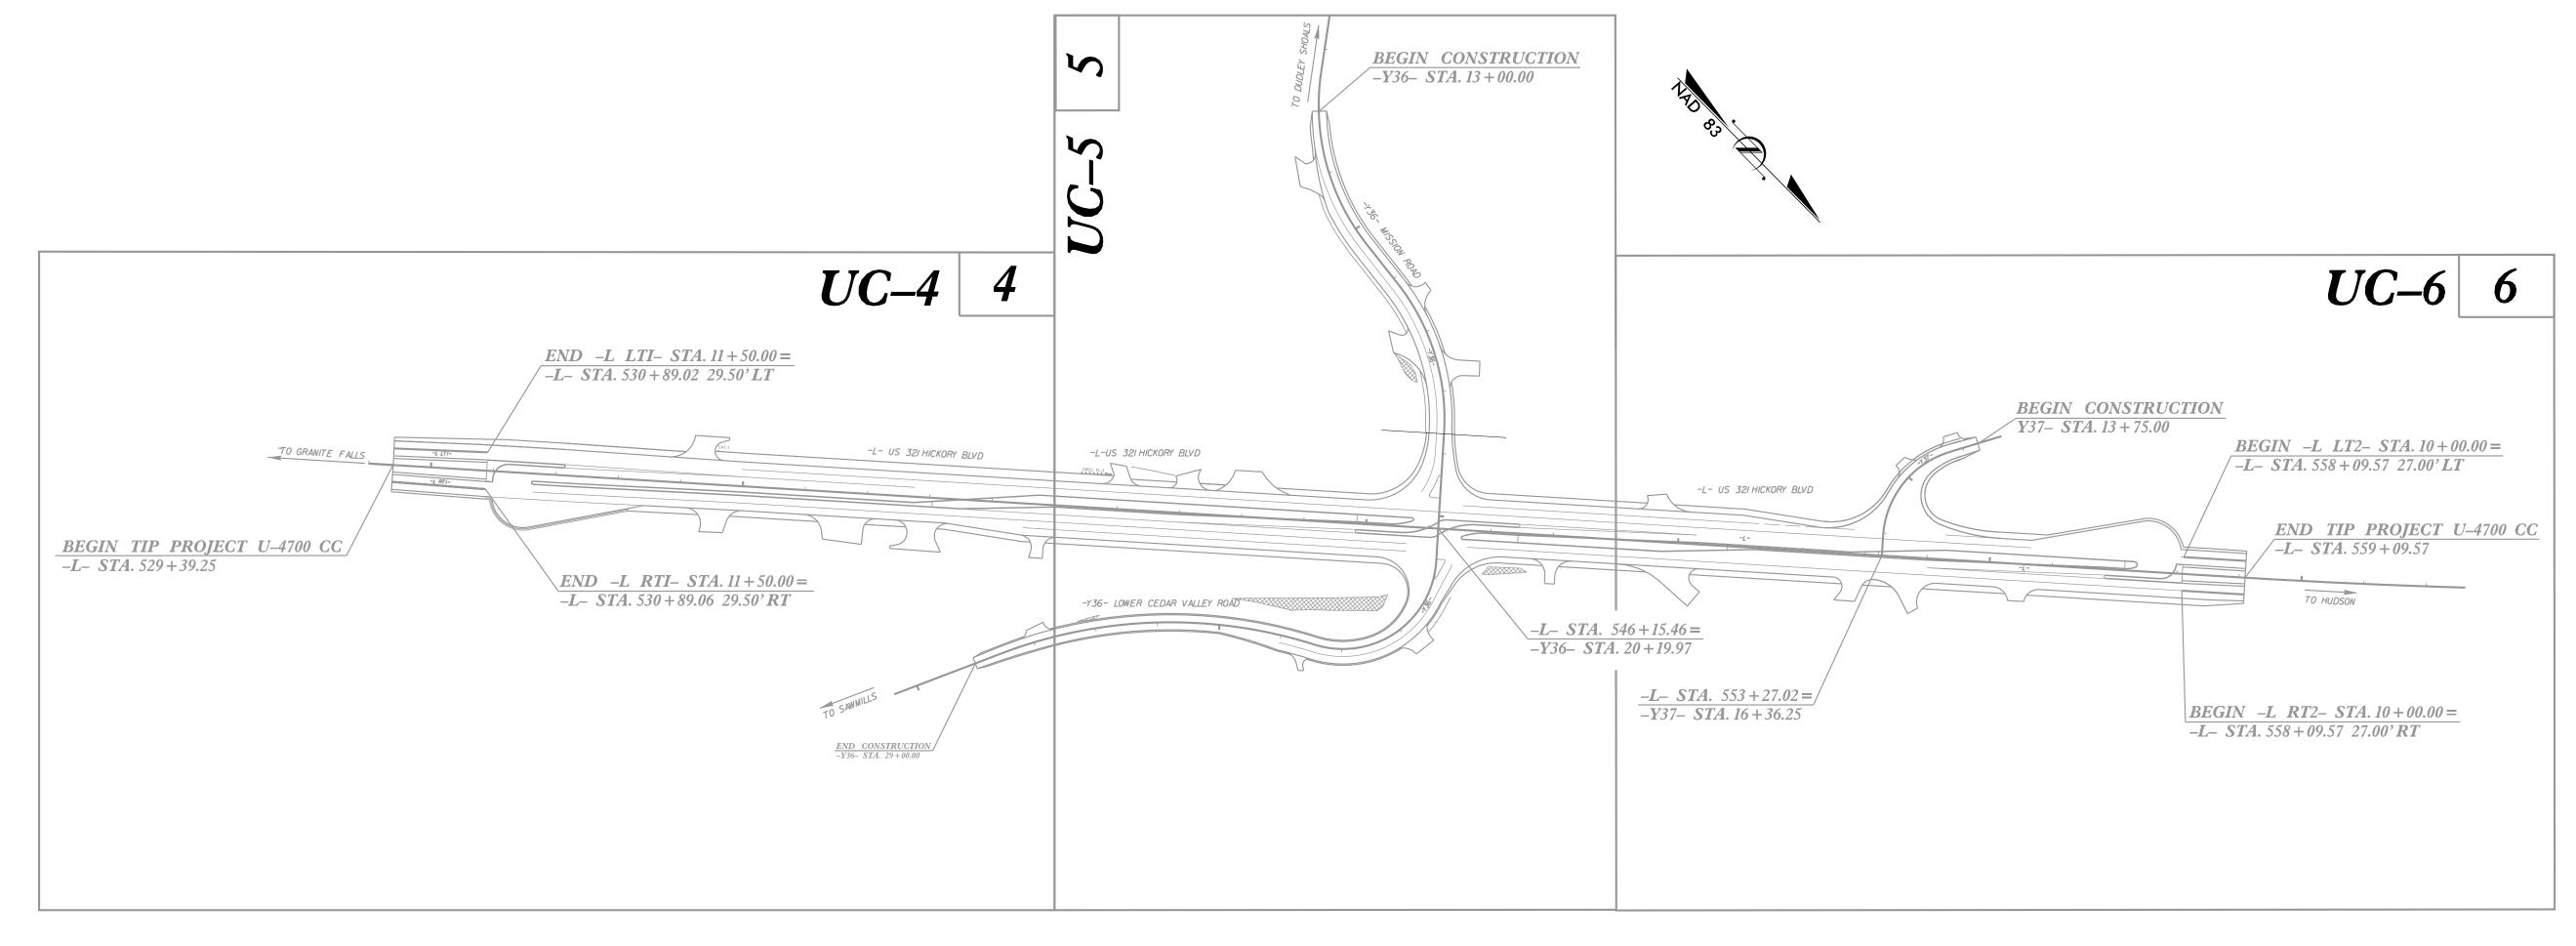

DOCUMENT NOT CONSIDERED FINAL UNTIL ALL SIGNATURES ARE COMPLETED

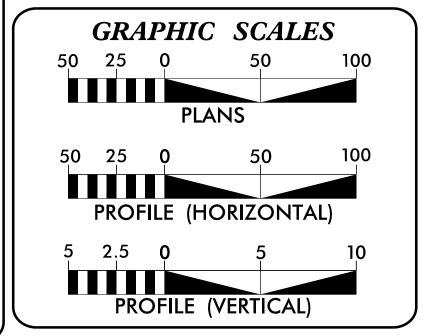

SHEET NO. INDEX OF SHEETS DESCRIPTION

UC-1

UC-2

UC-3 - UC-3A

UC-4 - UC-6B

UC-3B - UC-3G


<u>DESCRIPTION</u>
ITLE SHEET

TITLE SHEET
UTILITY SYMBOLOGY
NOTES
DETAILS


NOTES
DETAILS
UTILITY PLAN & PROFILE

PUBLIC UTILITY OWNERS ON PROJECT

(1) WATER & SEWER – TOWN OF SAWMILLS
(2) SEWER – CITY OF LENOIR
(3) WATER – CALDWELL COUNTY

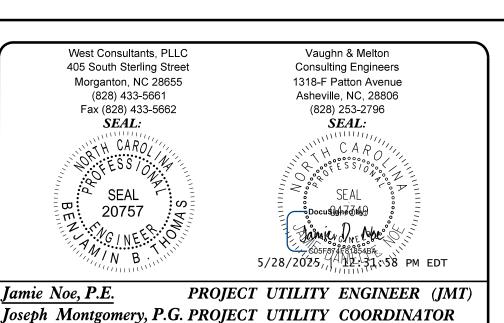

Benjie Thomas, P.E. PROJECT UTILITY ENGINEER (WEST)

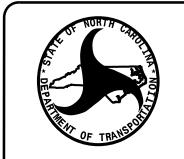

DIVISION OF HIGHWAYS
UTILITIES UNIT
1555 MAIL SERVICES CENTER
RALEIGH NC 27699-1555
PHONE (919) 707-6690
FAX (919) 250-4151

Ramie Shaw
Brandon Greer

PROJECT MANAGER

DIVISION UTILITY ENGINEER

U-4700CC

UC-2

STATE OF NORTH CAROLINA DIVISION OF HIGHWAYS

UTILITIES PLAN SHEET SYMBOLS

PROPOSED WATER SYMBOLS

Water Line (Sized as Shown) 11½ Degree Bend 22½ Degree Bend 45 Degree Bend 90 Degree Bend Plug Cross Reducer Gate Valve Butterfly Valve Tapping Valve Line Stop Line Stop with Bypass Blow Off Fire Hydrant Relocate Fire Hydrant Remove Fire Hydrant Water Meter Relocate Water Meter REM WM Remove Water Meter Water Pump Station · PS(W) RPZ Backflow Preventer DCV Backflow Preventer Relocate RPZ Backflow Preventer Relocate DCV Backflow Preventer

PROPOSED SEWER SYMBOLS

Gravity Sewer Line (Sized as Shown)
Force Main Sewer Line (Sized as Shown)
Manhole (Sized per Note)
Sewer Pump Station PS(SS)

PROPOSED MISCELLANOUS UTILITIES SYMBOLS

Power Pole ····································	Thrust Block
elephone Pole	Air Release Valve
oint Use Pole	Utility Vault
Telephone Pedestal TEL PED	Concrete Pier
Itility Line by Others Type as Shown)	Steel Pier
renchless Installation	Plan Note
incasement by Open Cut	Pay Item Note
ncasement	PAY ITEM

EXISTING UTILITIES SYMBOLS

Power Pole •	*Underground Power Line
Telephone Pole	*Underground Telephone Cable
Joint Use Pole	*Underground Telephone Conduit
Utility Pole •	*Underground Fiber Optics Telephone Cable ———— 1 F0
Utility Pole with Base	*Underground TV Cable
H-Frame Pole •••	*Underground Fiber Optics TV Cable
Power Transmission Line Tower 🖂	*Underground Gas Pipeline
Water Manhole	Aboveground Gas Pipeline
Power Manhole	*Underground Water Line
Telephone Manhole	Aboveground Water Line
Sanitary Sewer Manhole	*Underground Gravity Sanitary Sewer Liness
Hand Hole for Cable	Aboveground Gravity Sanitary Sewer Line A/G Sanitary Sewer
Power Transformer	*Underground SS Forced Main Line
Telephone Pedestal	Underground Unknown Utility Line
CATV Pedestal	SUE Test Hole
Gas Valve	Water Meter
Gas Meter	Water Valve ····································
Located Miscellaneous Utility Object ······· ⊙	Fire Hydrant
Abandoned According to Utility Records AATUR	Sanitary Sewer Cleanout
End of Information E.O.I.	
	*For Evisting Utilities

*For Existing Utilities Utility Line Drawn from Record (Type as Shown)

Designated Utility Line (Type as Shown)

UTILITY CONSTRUCTION



405 South Sterling Street
Morganton, NC 28655
(828) 433-5661
Fax (828) 433-5662
NC License No. P-0210
www.west-consultants.com

UC-3ESIGNED BY: JTC Benjami Benjami Benjaming Thoma DRAWN BY: JTC Thomas Toyle 2025,05-22 22:47 CHECKED BY: BBT APPROVED BY: 20757 REVISED: NORTH CAROLINA DEPARTMENT OF TRANSPORTATION UTILITIES ENGINEERING SEC. PHONE: (919)707–6690 FAX: (919)250–4151 UTILITY CONSTRUCTION PLANS ONLY

SHEET NO.

TOWN OF SAWMILLS

UTILITY CONSTRUCTION

DOCUMENT NOT CONSIDERED FINAL UNLESS ALL SIGNATURES COMPLETED

PROJECT REFERENCE NO.

GENERAL NOTES:

1. THE PROPOSED UTILITY CONSTRUCTION SHALL MEET THE APPLICABLE REQUIREMENTS OF THE NC DEPARTMENT OF TRANSPORTATION'S "STANDARD SPECIFICATIONS FOR ROADS AND STRUCTURES" DATED JANUARY 2024.

2. THE EXISTING UTILITIES BELONG TO THE TOWN OF SAWMILLS. CONTACT: STEVE COONSE 828-396-7903 4096 US HWY 321-A SAWMILLS, NC 28630

3. ALL WATER LINES TO BE INSTALLED WITHIN COMPLIANCE OF THE RULES AND REGULATIONS OF THE NORTH CAROLINA DEPARTMENT OF ENVIRONMENTAL QUALITY, DIVISION OF WATER RESOURCES, PUBLIC WATER SUPPLY SECTION. ALL SEWER LINES TO BE INSTALLED WITHIN COMPLIANCE OF THE RULES AND REGULATIONS OF THE NORTH CAROLINA DEPARTMENT OF ENVIRONMENTAL QUALITY, DIVISION OF WATER RESOURCES, WATER QUALITY SECTION. PERFORM ALL WORK IN ACCORDANCE WITH THE APPLICABLE PLUMBING CODES.

4. THE UTILITY OWNER OWNS THE EXISTING UTILITY FACILITIES AND WILL OWN THE NEW UTILITY FACILITIES AFTER ACCEPTANCE BY THE DEPARTMENT. THE DEPARTMENT OWNS THE CONSTRUCTION CONTRACT AND HAS ADMINISTRATIVE AUTHORITY. COMMUNICATIONS AND DECISIONS BETWEEN THE CONTRACTOR AND UTILITY OWNER ARE NOT BINDING UPON THE DEPARTMENT OR THIS CONTRACT UNLESS AUTHORIZED BY THE ENGINEER. AGREEMENTS BETWEEN THE UTILITY OWNER AND CONTRACTOR FOR THE WORK THAT IS NOT PART OF THIS CONTRACT OR IS SECONDARY TO THIS CONTRACT ARE ALLOWED, BUT ARE NOT BINDING UPON THE DEPARTMENT.

5. PROVIDE ACCESS FOR THE DEPARTMENT PERSONNEL AND THE OWNER'S REPRESENTATIVES TO ALL PHASES OF CONSTRUCTION. NOTIFY DEPARTMENT PERSONNEL AND THE UTILITY OWNER TWO WEEKS PRIOR TO COMMENCEMENT OF ANY WORK AND ONE WEEK PRIOR TO SERVICE INTERRUPTION. KEEP UTILITY OWNERS' REPRESENTATIVES INFORMED OF WORK PROGRESS AND PROVIDE OPPORTUNITY FOR INSPECTION OF CONSTRUCTION AND TESTING.

6. THE PLANS DEPICT THE BEST AVAILABLE INFORMATION FOR THE LOCATION, SIZE, AND TYPE OF MATERIAL FOR ALL EXISTING UTILITIES. MAKE INVESTIGATIONS FOR DETERMINING THE EXACT LOCATION, SIZE, AND TYPE MATERIAL OF THE EXISTING FACILITIES AS NECESSARY FOR THE CONSTRUCTION OF THE PROPOSED UTILITIES AND FOR AVOIDING DAMAGE TO EXISTING FACILITIES. REPAIR ANY DAMAGE INCURRED TO EXISTING FACILITIES TO THE ORIGINAL OR BETTER CONDITION AT NO ADDITIONAL COST TO THE DEPARTMENT.

7. MAKE FINAL CONNECTIONS OF THE NEW WORK TO THE EXISTING SYSTEM WHERE INDICATED ON THE PLANS, AS REQUIRED TO FIT THE ACTUAL CONDITIONS, OR AS DIRECTED.

8. MAKE CONNECTIONS BETWEEN EXISTING AND PROPOSED UTILITIES AT TIMES MOST CONVENIENT TO THE PUBLIC, WITHOUT ENDANGERING THE UTILITY SERVICE, AND IN ACCORDANCE WITH THE UTILITY OWNER'S REQUIREMENTS. MAKE CONNECTIONS ON WEEKENDS, AT NIGHT, AND ON HOLIDAYS IF NECESSARY.

9. ALL UTILITY MATERIALS SHALL BE APPROVED PRIOR TO DELIVERY TO THE PROJECT. SEE 1500-7, "SUBMITTALS AND RECORDS" IN SECTION 1500 OF THE STANDARD SPECIFICATIONS.

LIST OF STANDARD DRAWINGS

1515.01 WATER METER

1520.01 SEWER CLEAN OUT

1525.06 PRECAST CONCRETE SANITARY SEWER MANHOLE WITH CAST-IN-PLACE BOTTOM

1631.01 MATTING INSTALLATION

PROJECT SPECIFIC NOTES

1. PROPOSED 8" WATER LINE SHALL BE AWWA C-900 DR-18. THREE FEET OF COVER SHALL BE MAINTAINED AT ALL TIMES.

2. ALL WATER LINE FITTINGS SHALL USE JOINT RESTRAINT GLANDS AND CONCRETE THRUST BLOCKING.

3. AFTER THE NEW WATER LINE IS CERTIFIED, ALL WATER SERVICES SHALL BE RECONNECTED. IF EXISTING WATER METERS NEED TO BE RELOCATED THEY SHALL BE CONNECTED TO THE NEW WATER LINE WITH NEW ** TYPE K COPPER SERVICE LINES.

4. ALL WATER AND SEWER LINES SHALL BE INSTALLED WITH TRACER WIRE. WATER LINES SHALL HAVE A BURIED METALLIC WARNING TAPE 12" ABOVE THE TOP OF THE WATER LINE.

5. THE CONTRACTOR IS RESPONSIBLE FOR OBTAINING AND PAYING FOR ALL TESTING THAT MAY BE REQUIRED.

6. WHEN REMOVED SOIL IS REQUIRED TO BE PLACED ON ASPHALT OR CONCRETE SURFACES, THE CONTRACTOR SHALL PROTECT THESE SURFACES WITH A LAYER OF SAND OR ROCK DUST AT NO ADDITIONAL COST TO THE DEPARTMENT.

7. THE CONTRACTOR SHALL MAINTAIN AN "AS BUILT" SET OF DRAWINGS. THE DRAWINGS SHALL BE RED LINE MARKED TO REFLECT DEVIATIONS FROM THE ORIGINAL DESIGN, INCLUDING ALL CHANGES IN PIPELINE AND STRUCTURE LOCATIONS AND ELEVATIONS. SUCH RED LINE MARKS SHALL BE BASED ON MEASUREMENTS USING A TAPE AND TRANSIT, OR BETTER. A LICENSED SURVEYOR IS NOT REQUIRED TO PERFORM THIS TASK EXCEPT FOR NEW GRAVITY SEWER MAINS. FOR NEW GRAVITY MAINS, CONTRACTOR SHALL PROVIDE AS-BUILT PLAN AND PROFILE DRAWINGS PRODUCED BY AN NC REGISTERED PROFESSIONAL SURVEYOR. THESE DRAWINGS SHALL SHOW ACTUAL MANHOLE LOCATIONS, NEW ELEVATIONS, INVERT IN AND OUT ELEVATIONS, AND THE CALCULATED SLOPE BETWEEN MANHOLES. IT IS NOT RECESSARY TO SURVEY GROUND SURFACE ELEVATIONS BETWEEN MANHOLES, UNLESS IN THE OPINION OF THE ENGINEER THE SURFACE ELEVATIONS ARE SIGNIFICANTLY ALTERED FROM THE DESIGN ELEVATIONS.

8. CONTRACTOR TO VERIFY ANY SERVICE CONNECTIONS ON EXISTING SEWER LINE TO BE ABANDONED AND TO RECONNECT TO NEW SEWER.

BYPASS PUMPING NOTES:

DURING CONSTRUCTION, ALL SEWER MAINS SHALL REMAIN IN OPERATION. IF A SECTION NEEDS TO BE TEMPORARILY TAKEN OUT OF SERVICE AND WHERE BYPASS PUMPING IS METHOD OF DIVERTING WASTEWATER, THE FOLLOWING SHALL APPLY:

- BYPASS PUMP SHALL BE TWO TIMES THE NORMAL PEAK HOUR FLOW RATE
- THERE SHALL BE A BACKUP PUMP
- BYPASS PUMPING SHALL BE MONITORED AT ALL TIMES
- IF BYPASS PUMPING IS REQUIRED OVERNIGHT, FLOAT CONTROL WITH AUTOMATIC REMOTE ALARMS FOR HIGH WATER AND PUMP FAILURE TO NOTIFY CONTRACTOR IS REQUIRED.
- CONTRACTOR SHALL ASSUME RESPONSIBILITY DURING BYPASS PUMPING FOR ALL FINES, PENALTIES, CLEAN UP COSTS, AND OTHER RELATED COSTS RESULTING FROM OVERFLOW DUE TO BYPASS PUMP FAILURE, OR OTHER BYPASS PUMPING RELATED ISSUE.

V:\Asheville\transportation\31535-15 U4700CC\Utility Design\UC Sheets\U4700CC_utl_UC_3A.dgn

UTILITY CONSTRUCTION

CALDWELL COUNTY

U-4700CC

DESIGNED BY: MRD

DRAWN BY: ND

CHECKED BY: JDN

APPROVED BY: JDN

REVISED:

NORTH CAROLINA
DEPARTMENT OF
TRANSPORTATION

UTILITIES ENGINEERING SEC.
PHONE: (919)707-6690
FAX: (919)250-4151

DOCUMENT NOT CONSIDERED FINAL
UNTIL ALL SIGNATURES ARE COMPLETED

UTILITY CONSTRUCTION

GENERAL NOTES:

- 1. THE PROPOSED UTILITY CONSTRUCTION SHALL MEET THE APPLICABLE REQUIREMENTS OF THE NC DEPARTMENT OF TRANSPORTATION'S "STANDARD SPECIFICATIONS FOR ROADS AND STRUCTURES" DATED JANUARY 2024.
- 2. THE EXISTING WATER UTILITIES INCLUDED IN CONTRACT BELONG TO CALDWELL COUNTY. PLEASE CONTACT MR. BARRY CALLOWAY, 1385 FAIRVIEW DR. SW, LENOIR, NC 28645, (828) 757-6865, bcalloway@caldwellcountync.org. THE **EXISTING SEWER UTILITIES INCLUDED IN** CONTRACT BELONG TO CITY OF LENOIR. PLEASE CONTACT MR. JEFF CHURCH, 510B GREER CIRCLE SW, LENOIR, NC, 28645, (828)-757-4459, jeff.church@ci.lenoir.nc.us THE EXISTING WATER AND SEWER UTILITIES INCLUDED IN CONTRACT BELONG TO TOWN OF SAWMILLS. PLEASE CONTACT MR. STEVE COONSE, 4096 US HIGHWAY 321-A, SAWMILLS. NC 28630. (828) 396-7903
- 3. ALL WATER LINES TO BE INSTALLED WITHIN COMPLIANCE OF THE RULES AND REGULATIONS OF THE NORTH CAROLINA DEPARTMENT OF ENVIRONMENTAL QUALITY, DIVISION OF WATER RESOURCES, PUBLIC WATER SUPPLY SECTION. ALL SEWER LINES TO BE INSTALLED WITHIN COMPLIANCE OF THE RULES AND REGULATIONS OF THE NORTH CAROLINA DEPARTMENT OF ENVIRONMENTAL QUALITY, DIVISION OF WATER RESOURCES, WATER QUALITY SECTION. PERFORM ALL WORK IN ACCORDANCE WITH THE APPLICABLE PLUMBING CODES.
- 4. THE UTILITY OWNER OWNS THE EXISTING UTILITY FACILITIES AND WILL OWN THE NEW UTILITY FACILITIES AFTER ACCEPTANCE BY THE DEPARTMENT. THE DEPARTMENT OWNS THE CONSTRUCTION CONTRACT AND HAS ADMINISTRATIVE AUTHORITY. COMMUNICATIONS AND DECISIONS BETWEEN THE CONTRACTOR AND UTILITY OWNER ARE NOT BINDING UPON THE DEPARTMENT OR THIS CONTRACT UNLESS AUTHORIZED BY THE ENGINEER. AGREEMENTS BETWEEN THE UTILITY OWNER AND CONTRACTOR FOR THE WORK THAT IS NOT PART OF THIS CONTRACT OR IS SECONDARY TO THIS CONTRACT ARE ALLOWED, BUT ARE NOT BINDING UPON THE DEPARTMENT.

- 5. MAKE FINAL CONNECTIONS OF THE NEW WORK TO THE EXISTING SYSTEM WHERE INDICATED ON THE PLANS, AS REQUIRED TO FIT THE ACTUAL CONDITIONS, OR AS DIRECTED.
- 6. THE PLANS DEPICT THE BEST AVAILABLE INFORMATION FOR THE LOCATION, SIZE, AND TYPE OF MATERIAL FOR ALL EXISTING UTILITIES. MAKE INVESTIGATIONS FOR DETERMINING THE EXACT LOCATION, SIZE AND TYPE MATERIAL OF THE EXISTING FACILITIES AS NECESSARY FOR THE CONSTRUCTION OF THE PROPOSED UTILITIES AND FOR AVOIDING DAMAGE TO EXISTING FACILITIES. REPAIR ANY DAMAGE INCURRED TO EXISTING FACILITIES TO THE ORIGINAL OR BETTER CONDITION AT NO ADDITIONAL COST TO THE DEPARTMENT.
- 7. PROVIDE ACCESS FOR THE DEPARTMENT PERSONNEL AND THE OWNER'S REPRESENTATIVES TO ALL PHASES OF CONSTRUCTION. NOTIFY DEPARTMENT PERSONNEL AND THE UTILITY OWNER TWO WEEKS PRIOR TO COMMENCEMENT OF ANY WORK AND ONE WEEK PRIOR TO SERVICE INTERRUPTION. KEEP UTILITY OWNERS' REPRESENTATIVES INFORMED OF WORK PROGRESS AND PROVIDE OPPORTUNITY FOR INSPECTION OF CONSTRUCTION AND TESTING.
- 8. MAKE CONNECTIONS BETWEEN EXISTING AND PROPOSED UTILITIES AT TIMES MOST CONVENIENT TO THE PUBLIC, WITHOUT ENDANGERING THE UTILITY SERVICE, AND IN ACCORDANCE WITH THE UTILITY OWNER'S REQUIREMENTS. MAKE CONNECTIONS ON WEEKENDS, AT NIGHT, AND ON HOLIDAYS IF NECESSARY.
- 9. ALL UTILITY MATERIALS SHALL BE APPROVED PRIOR TO DELIVERY TO THE PROJECT. SEE 1500-7, "SUBMITTALS AND RECORDS" IN SECTION 1500 OF THE STANDARD SPECIFICATIONS.

PROJECT SPECIFIC NOTES:


1. ALL FITTINGS SHALL BE DUCTILE IRON MECHANICAL JOINT USING GRIP RINGS. NO GLUE OR PUSH-ON FITTINGS ARE ALLOWED. THRUST BLOCKING IS REQUIRED.

- 2. IF HDPE PIPE IS INSTALLED BY DIRECTIONAL DRILL, IT SHALL BE FILLED WITH WATER AND NOT BE CONNECTED TO ANY OTHER PIPE OR FITTING FOR ONE WEEK FROM THE TIME OF INSTALLATION.
- 3. NEW WATER LINES MUST BE PRESSURE TESTED AT 200 PSI OR 1.5 TIMES AVERAGE STATIC PRESSURE IN PROJECT AREA, WHICHEVER IS MORE FOR 2 HOURS. TEST TO BE OBSERVED BY CALDWELL COUNTY WATER AND SEWER REPRESENTATIVE.
- 4. SERVICE INTERRUPTIONS SHALL BE SCHEDULED WITH CALDWELL COUNTY AND/OR CITY OF LENOIR AND SHALL BE COMPLETED DURING OFF-PEAK HOURS. AFTER 9 PM AND BE COMPLETED BY 4 AM, UNLESS AUTHORIZED BY CALDWELL COUNTY AND/OR CITY OF LENOIR. INTERRUPTION SHALL NOT EXCEED 8 HOURS. THE CONTRACTOR SHALL BE RESPONSIBLE FOR PROVIDING TEMPORARY POTABLE WATER SUPPLIES TO ANY CUSTOMER UPON REQUEST BY THE COUNTY AND/OR WHEN DURATION OF THE WATER SERVICE LOSS OR DISRUPTION EXCEEDS 4 HOURS.
- 5. ALL NCDEQ-DWR-PWS AND LOCAL TESTING MUST BE COMPLETED AND APPROVED PRIOR TO CONNECTING THE NEW CONSTRUCTION TO THE EXISTING WATER LINES.
- 6. THE PROFESSIONAL ENGINEER (PE) SHALL OBTAIN AND PROVIDE THE NCDEQ "AUTHORIZATION TO CONSTRUCT" PERMIT TO THE UTILITY CONTRACTOR BEFORE THE CONSTRUCTION OF THE WATER LINE SHALL BEGIN. THE UTILITY CONTRACTOR MUST POST A COPY OF THE NCDEQ "AUTHORIZATION TO CONSTRUCT" PERMIT ISSUED BY THE NORTH CAROLINA DEPARTMENT OF ENVIRONMENTAL QUALITY ON SITE PRIOR TO THE START OF CONSTRUCTION. THE PERMIT MUST BE MAINTAINED ON SITE THROUGHOUT THE ENTIRE CONSTRUCTION PROCESS OF THE PROPOSED WATER LINES THAT WILL SERVE THIS PROJECT.
- 7. CONTRACTOR'S ATTENTION IS DIRECTED TO SECTIONS 102, 107 AND 1550 OF THE STANDARD SPECIFICATIONS CONCERNING TRENCHLESS INSTALLATION. IT IS THE CONTRACTOR'S RESPONSIBILITY TO HAVE BORE DESIGNED AND SEALED BY A LICENSED NORTH CAROLINA PROFESSIONAL ENGINEER. NO DAMAGE SHALL BE ALLOWED TO RIVER, WETLANDS OR BUFFER ZONES.

- 8. HDPE PRESSURE PIPE FOR POTABLE WATER SHALL MEET THE REQUIREMENTS OF NSF 61.
- 9. ANY NECESSARY CONNECTIONS FOR TESTING AND FILLING THE INSTALLED WATER MAIN WILL BE REQUIRED AND CONSIDERED INCIDENTAL TO THE WATER MAIN.
- 10. ALL MANHOLES SHOWN TO BE ADJUSTED ON THE PLANS ARE TO BE INSPECTED AND ENSURED THAT THE MANHOLE IS STRUCTURALLY SOUND. IN ANY CASE WHERE THEY ARE DEEMED UNSOUND, THE CONTRACTOR SHALL REACH OUT TO THE OWNER AND ENGINEER FOR GUIDANCE ON NEXT STEPS FORWARD.
- 11. THE CONTRACTOR IS RESPONSIBLE FOR WORKING WITH UTILITY OWNERS TO CONFIRM WHO OWNS THE EXISTING FACILITIES AND ENSURE THE CORRECT OWNER IS INSPECTING THE WORK.
- 12. ASBESTOS CEMENT PIPE SHALL BE REMOVED BY AN APPROVED CONTRACTOR. ASBESTOS CEMENT PIPE REMOVAL SHALL BE IN ACCORDANCE WITH LOCAL, STATE AND FEDERAL RULES, REGULATIONS AND PROCEDURES. THE CONTRACTOR SHALL CONTACT HEALTH HAZARDS CONTROL UNIT ADMINISTERING THE NORTH CAROLINA ASBESTOS HAZARD MANAGEMENT PROGRAM FOR REFERENCE. ANY PERMITS NECESSARY FOR REMOVAL AND/ OR DISPOSAL OF ASBESTOS CEMENT PIPE ARE TO BE ACQUIRED BY THE CONTRACTOR WITH NO ADDITIONAL EXPENSE TO THE UTILITY OWNER OR THE DEPARTMENT.



PROJECT TYPICAL DETAILS

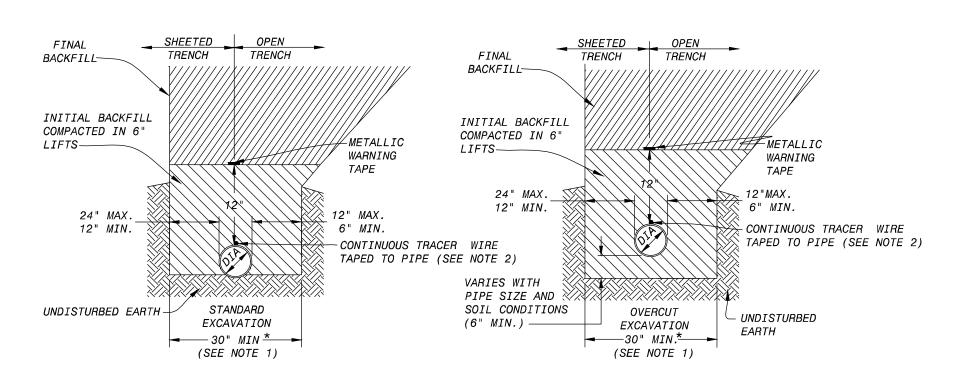



NOTES:


1. 30" MINIMUM TRENCH WIDTH SHALL BE MAINTAINED EVEN IN ARES OF ROCK EXCAVATION, UNLESS OTHERWISE DIRECTED BY THE THE ENGINEER. WIDTHS GREATER THAN 30" WILL NOT QUALIFY FOR PAYMENT UNLESS APPROVED BY THE ENGINEER.


2. TRACER WIRE TO BE UL LISTED, COPPER, COATED SUITABLE FOR BURIAL AND AT LEAST 12 GAUGE.


TYPICAL WATER LINE TRENCHING DETAILS

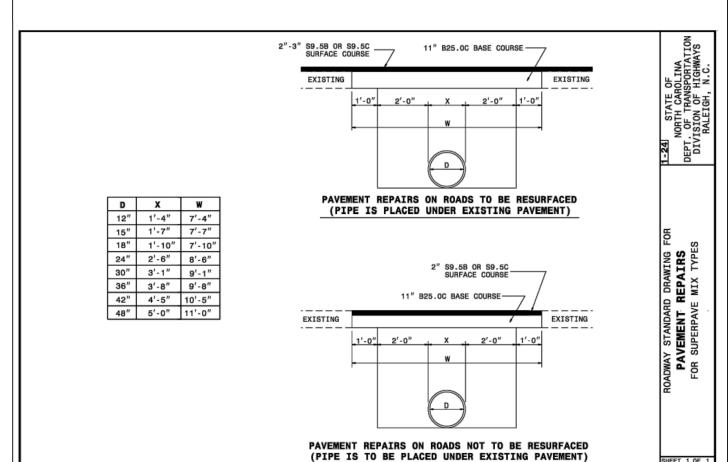

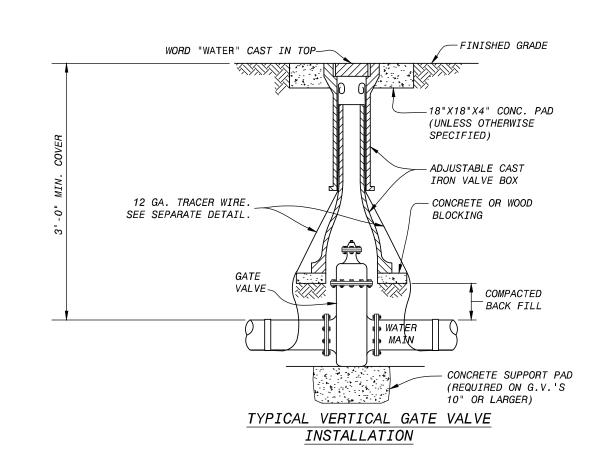

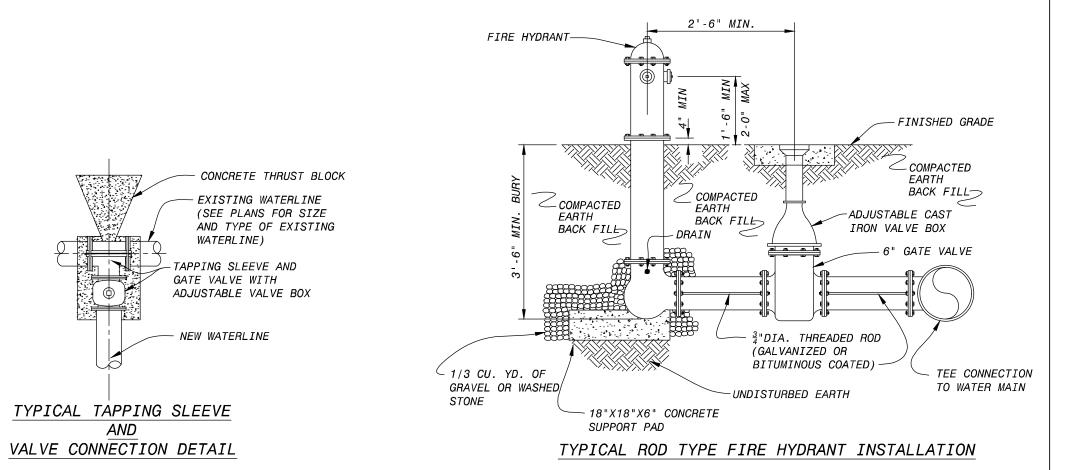

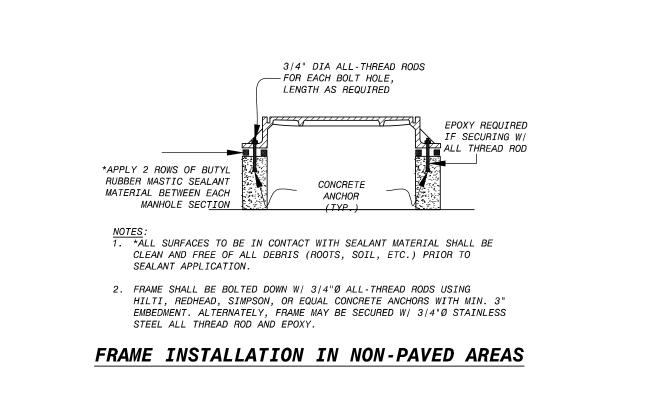

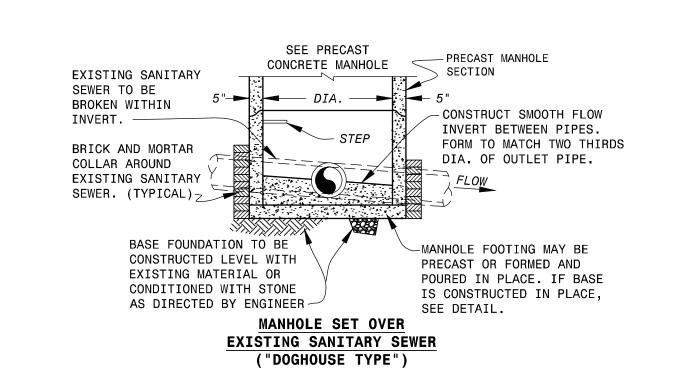



Morganton, NC 28655
(828) 433-5661
Fax (828) 433-5662
NC License No. P-0210
www.west-consultants.com

DESIGNED BY: JTC

DRAWN BY: JTC

CHECKED BY: BBT

APPROVED BY:

REVISED:

NORTH CAROLINA
DEPARTMENT OF
TRANSPORTATION

UTILITIES ENGINEERING SEC.
PHONE: (919)707-6690
FAX: (919)250-4151

Benjamin Philith Magned by Benjamin Philith Magned


SHEET NO.


TOWN OF SAWMILLS

ITILITY CONSTRUCTO

DOCUMENT NOT CONSIDERED FINAL UNLESS ALL SIGNATURES COMPLETED

PROJECT REFERENCE NO.

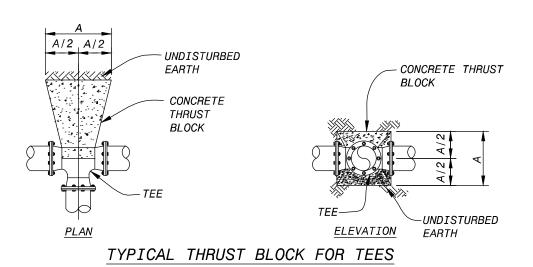

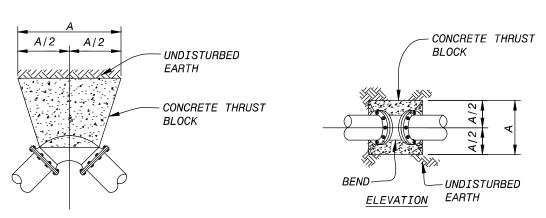


<i>TYPICAL</i>	THRUST	BLOCK	FOR	BENDS
-				


_							
	SIZE	11 ¹ / ₄ ° BEND	22½° BEND	45° BEND	90° BEND	TEE	PLUG
	2-6	12	12	12	16	16	14
	8	12	12	16	22	22	18
	10	12	14	20	28	28	22
	12	12	18	24	32	32	28
	14	14	20	28	38	38	32
	16	16	22	32	42	42	36
	18	18	26	36	48	48	40
	20	20	28	40	52	52	44
	24	24	34	46	64	64	54
	30	30	42	58	78	78	66
	36	36	50	70	94	94	80
	42	40	58	80	108	108	92
	48	46	66	90	124	124	104

NOTE: CARE SHALL BE TAKEN WHEN PLACING THRUST BLOCKS TO KEEP THE FITTING BOLTS FREE OF CONCRETE.

THRUST BLOCKS DIMENSION "A"


(DIMENSION "A" IN INCHES)

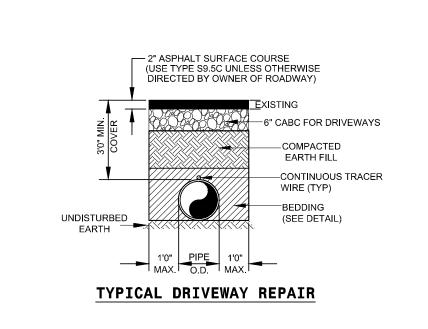


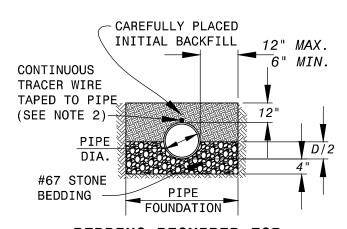


BEDDING REQUIRED FOR:


1. SDR 35 PVC PIPE (ALL DEPTHS)
2. TRACER WIRE TO BE ZIP TIED OR TAPED WITH PVC TAPE TO PVC PIPE.
TRACER WIRE TO BE UL LISTED, COPPER, SUITABLE FOR BURIAL, COATED AND AT LEAST 12 GAUGE.

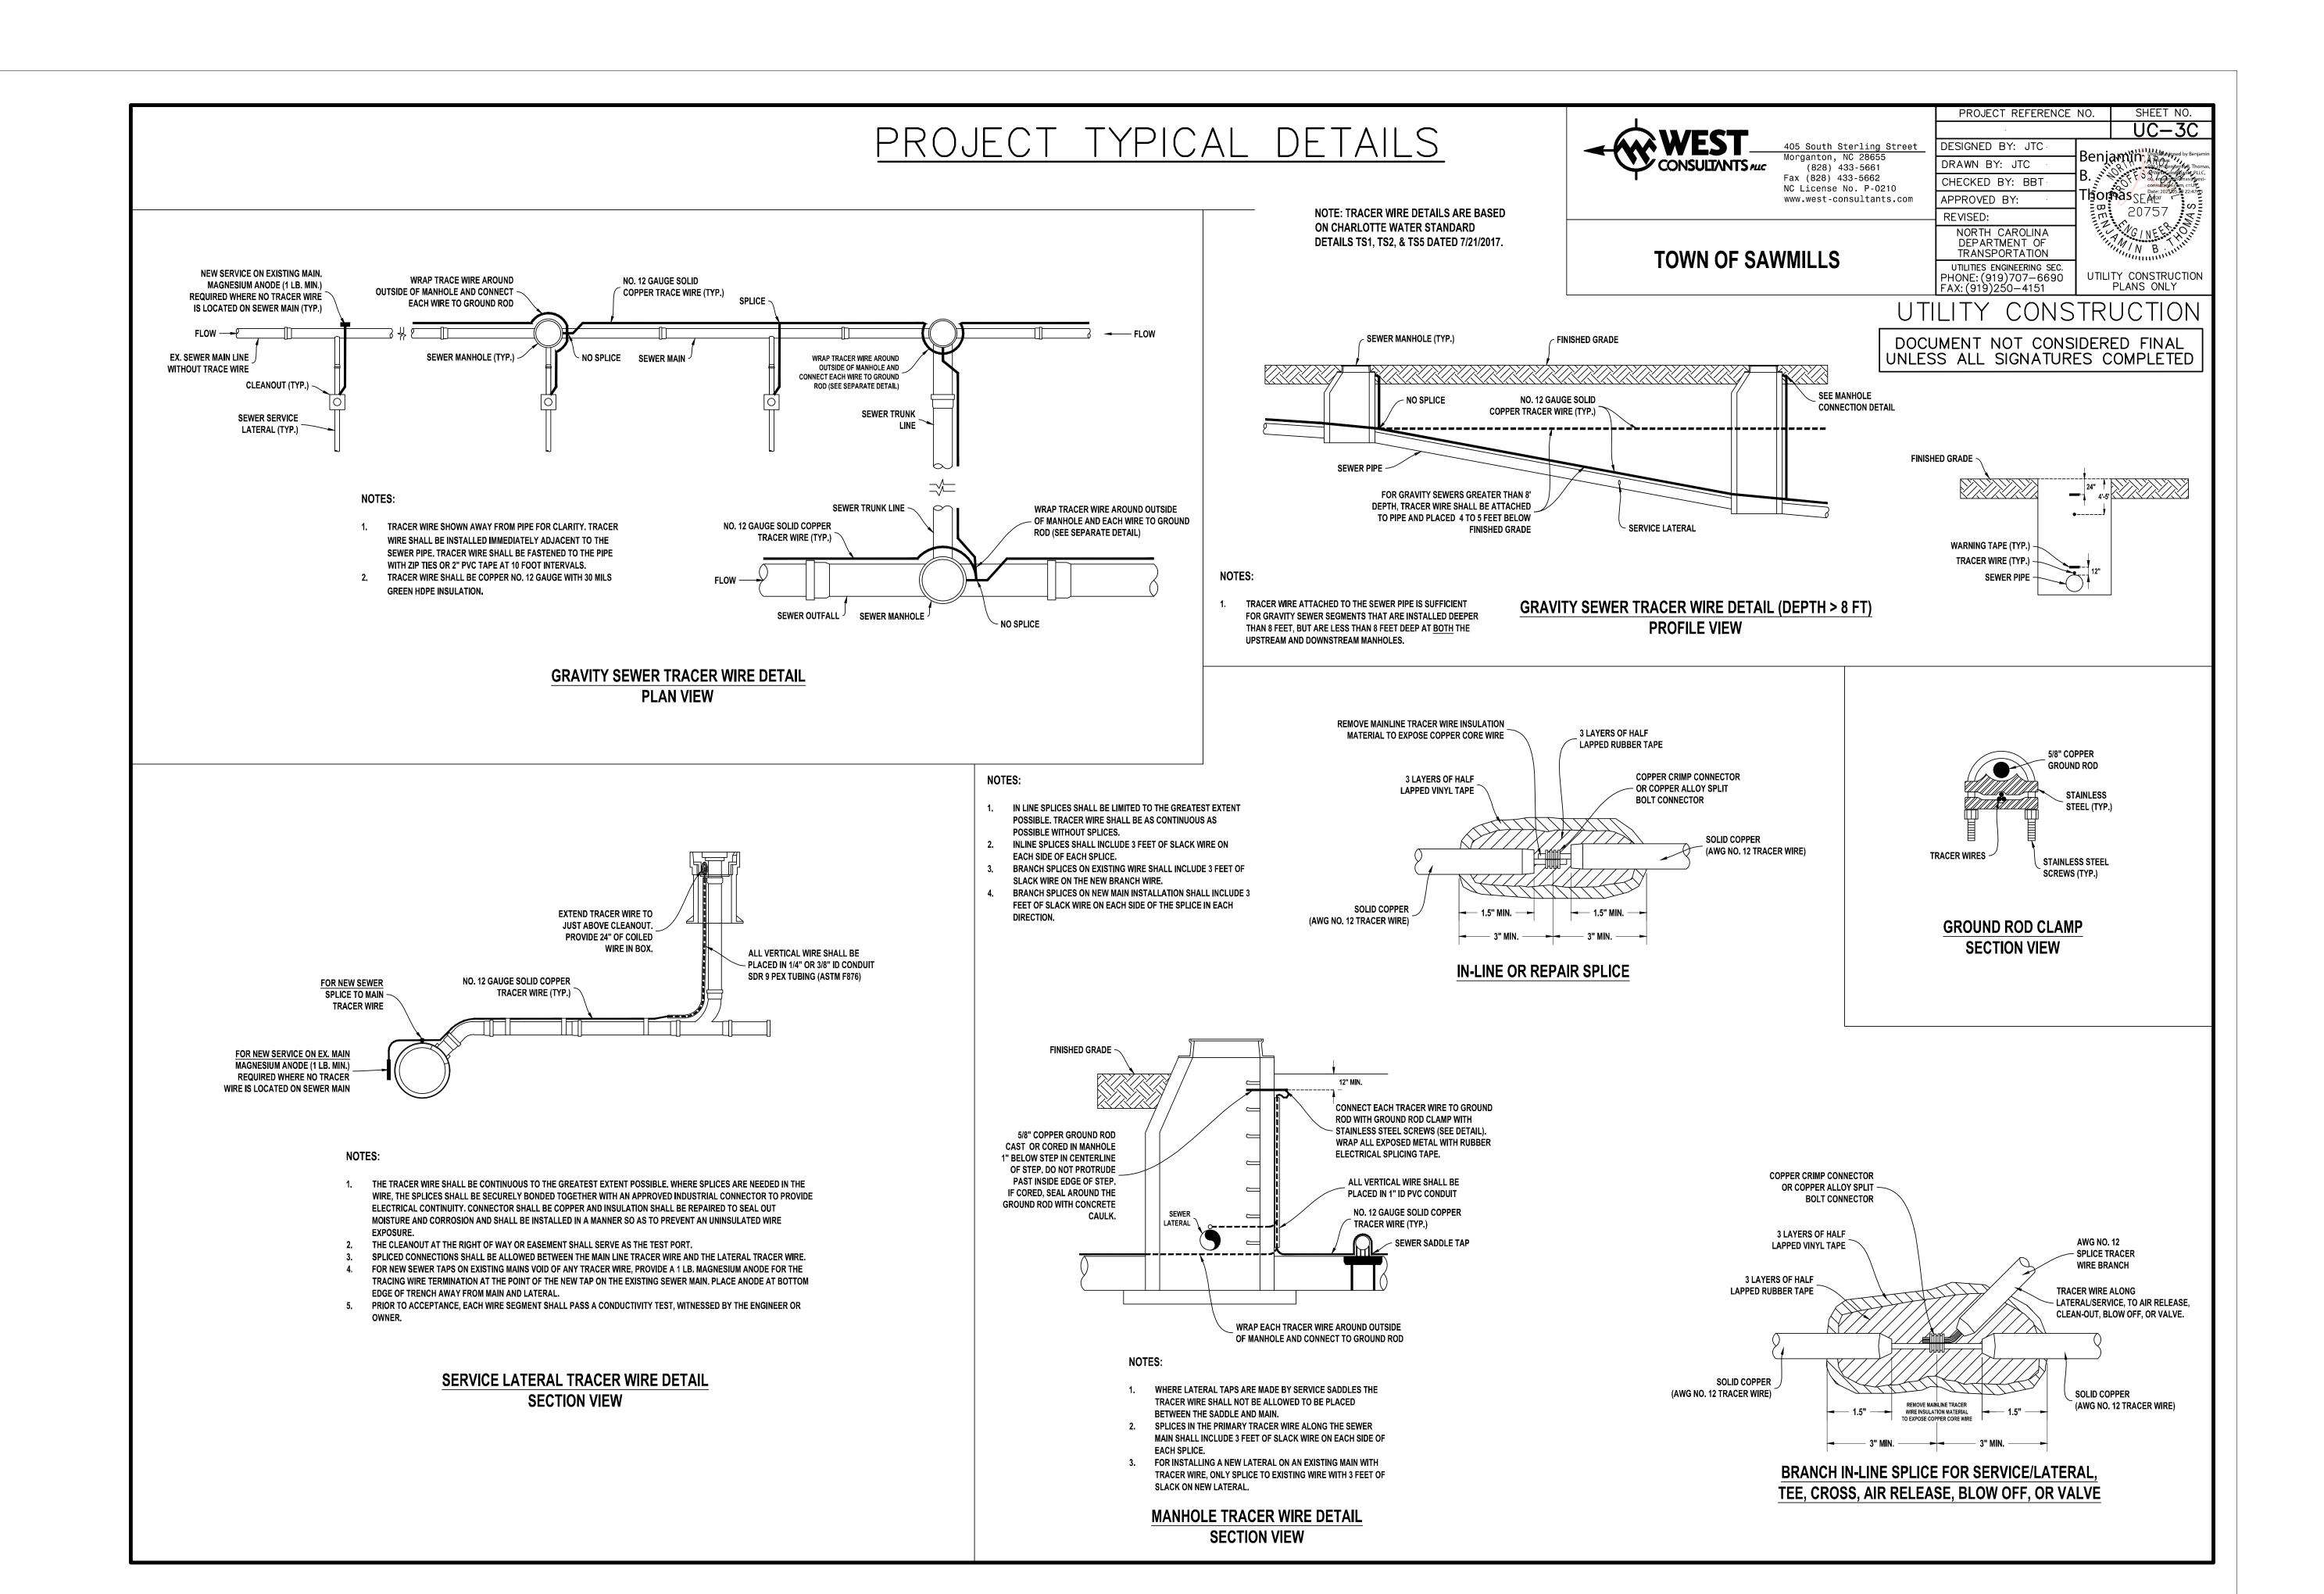

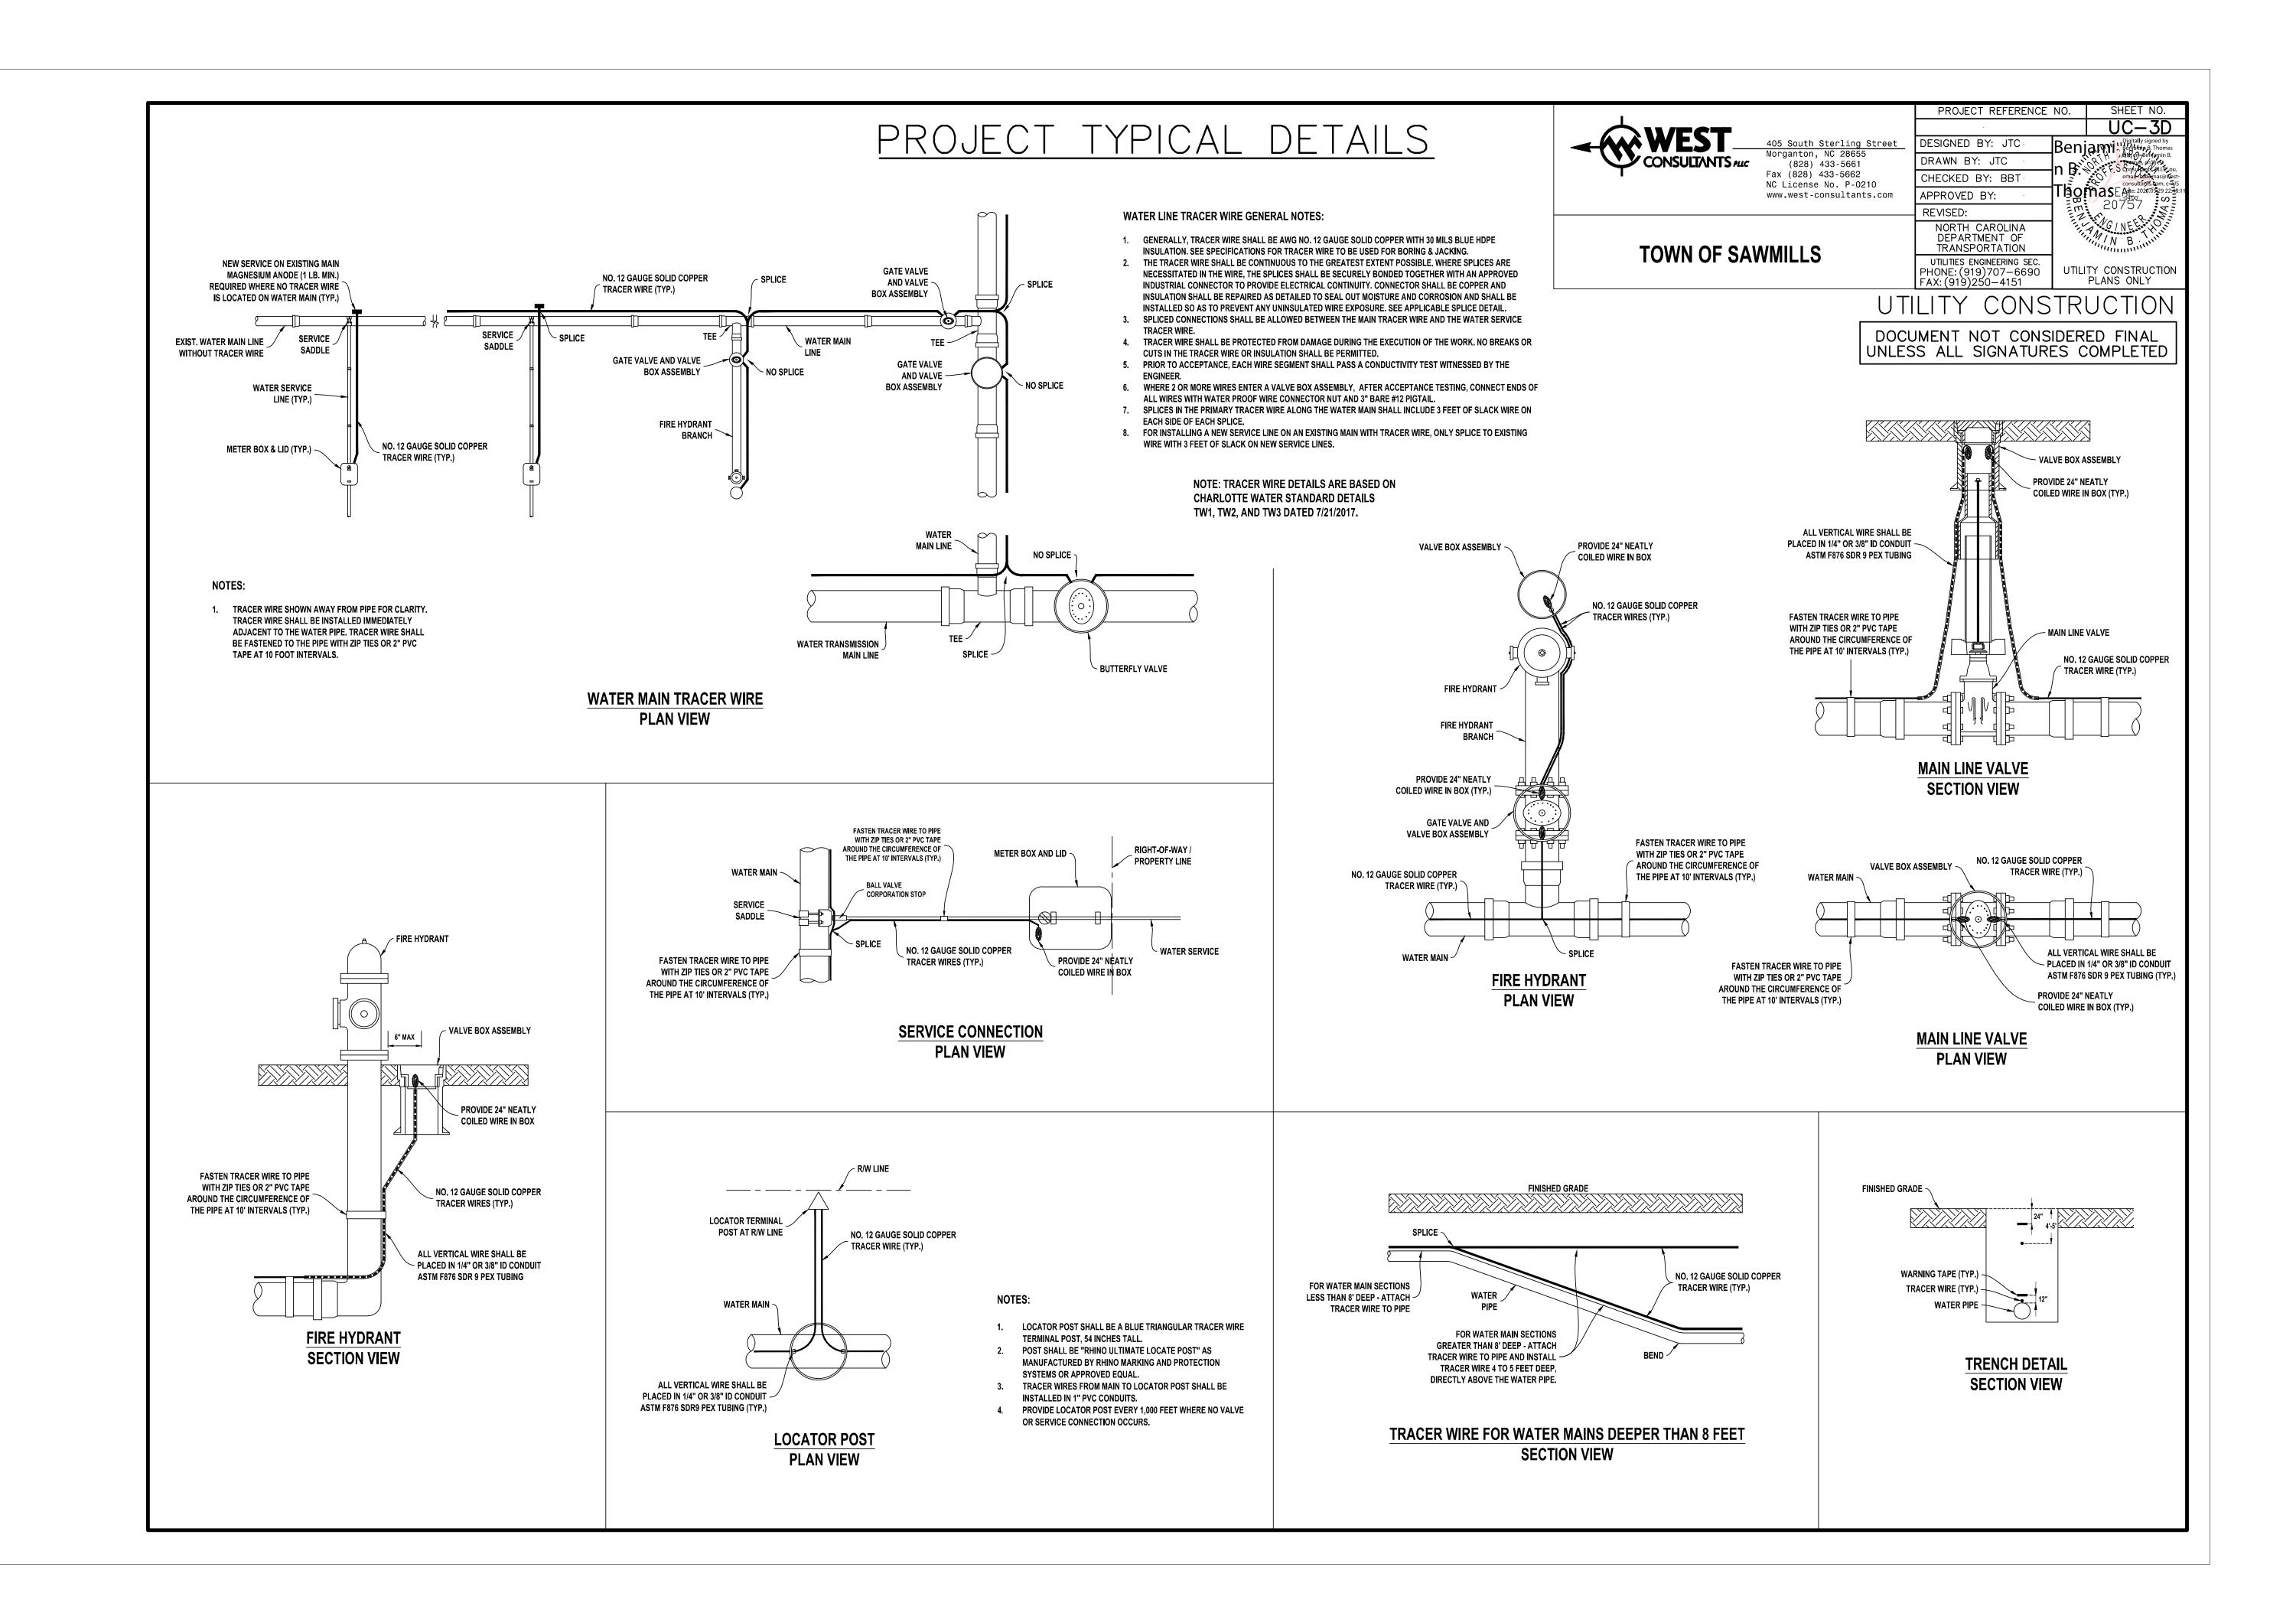

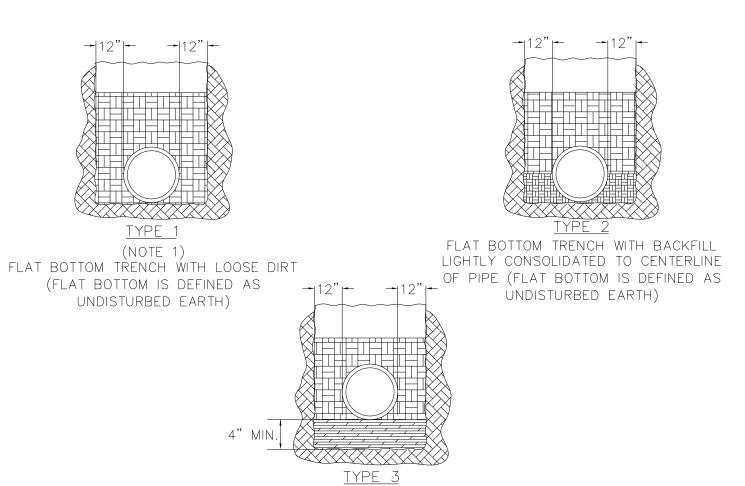

PIPE BEDDED IN 4" MINIMUM LOOSE SOIL WITH BACKFILL LIGHTLY CONSOLIDATED TO TOP OF PIPE (LOOSE SOIL IS DEFINED AS NATIVE SOIL EXCAVATED FROM THE TRENCH, FREE OF ROCK, ORGANIC MATERIAL, FOREIGN MATERIALS AND FROZEN EARTH.)

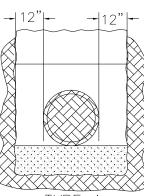

TYPE 4

PIPE BEDDED IN SAND, GRAVEL, OR


CRUSHED STONE TO A DEPTH OF 1/8

PIPE DIAMETER, 4" MINIMUM WITH

BACKFILL COMPACTED TO TOP OF PIPE.

(APPROXIMATELY 80 PERCENT STANDARD

PROCTOR, AASHTO T-99)

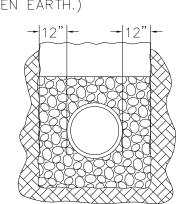


PIPE BEDDED TO IT'S CENTERLINE IN COMPACTED GRANULAR MATERIAL, 4" MINIMUM UNDER PIPE. COMPACTED GRANULAR OR SELECT MATERIAL TO TOP OF PIPE (APPROXIMATELY 90 PERCENT STANDARD PROCTOR, AASTO T-99) (SELECT MATERIAL IS DEFINED AS NATIVE SOIL EXCAVATED FROM THE TRENCH, FREE OF ROCKS, ORGANIC MATERIAL, FOREIGN MATERIALS AND FROZEN EARTH)

NOTE

- 1. FOR NORMAL PIPE SIZES 14 INCH AND LARGER, CONSIDERATION SHOULD BE GIVEN TO THE USE OF LAYING CONDITIONS OTHER THAN TYPE 1.
- 2. CONSIDERATION OF THE PIPE-ZONE EMBEDMENT CONDITIONS INCLUDED IN THIS FIGURE MAY BE INFLUENCED BY FACTORS OTHER THAN PIPE STRENGTH. FOR ADDITIONAL INFORMATION ON PIPE BEDDING AND BACKFILL, SEE ANSI/AWWA C600.


WATER MAIN EMBEDMENT DETAILS

NOT TO SCALE

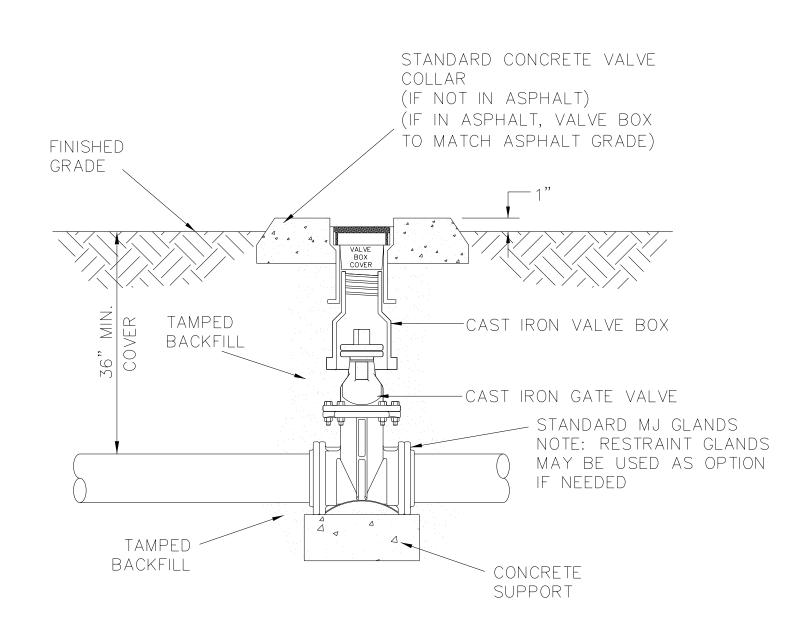

INLINE VALVE DETAIL

NOT TO SCALE

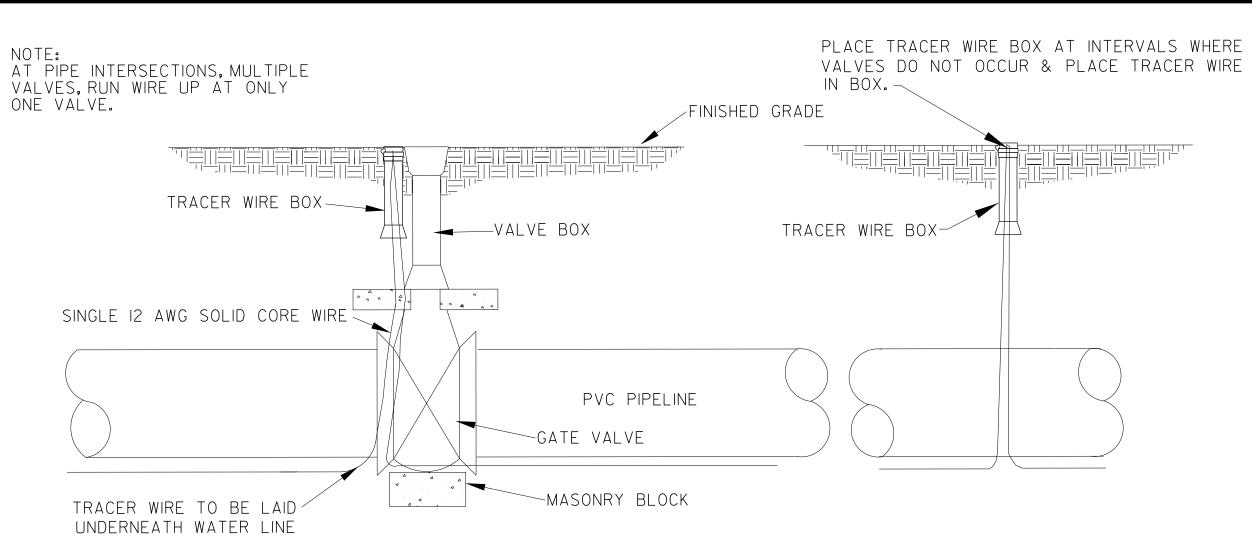

NOTES:


APPROVED METHOD FOR

- I. PLACE TRACER WIRE IN TRACER WIRE BOX AS SHOWN.
- 2. NO UNDERGROUND SPLICING WILL BE ALLOWED. DO NOT SPLICE WIRE WHEN BEGINNING A NEW SPOOL. INSTEAD INSTALL A TRACER WIRE BOX AND ATTACH EACH WIRE TO THE BOX.

TYPICAL TRACER WIRE INSTALLATION DETAIL

NOT TO SCALE




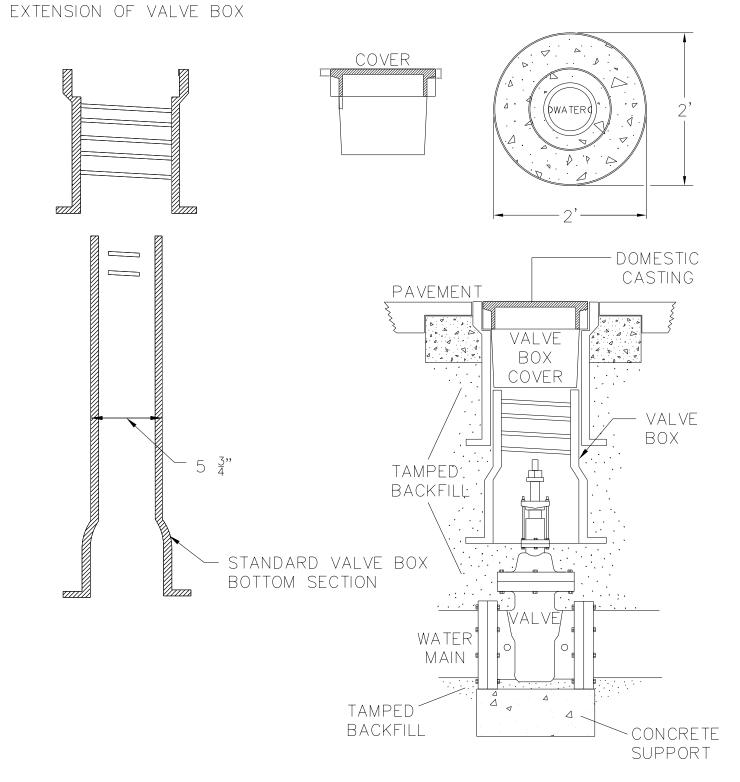


NOTE: VALVE BOX SHALL BE PER OWNER'S SPECIFICATIONS.

VALVE BOX INSTALLATION

NOT TO SCALE

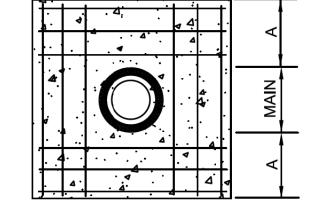

REINFORCING

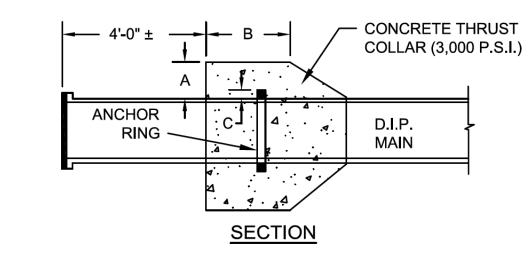

PROJECT REFERENCE NO.

DESIGNED BY: MRD

APPROVED BY: JDN

NORTH CAROLINA DEPARTMENT OF TRANSPORTATION

UTILITIES ENGINEERING SEC

DRAWN BY:

REVISED:

CHECKED BY:

CALDWELL COUNTY

U-4700CC

ND

PHONE: (919)707-6690 UTILITY CONSTRUCTION FAX: (919)250-4151 PLANS ONLY


DOCUMENT NOT CONSIDERED FINAL UNTIL ALL SIGNATURES ARE COMPLETED

UTILITY CONSTRUCTION

SHEET NO.

047349

8/2025 ('/1⁄20:311:58 PM ED

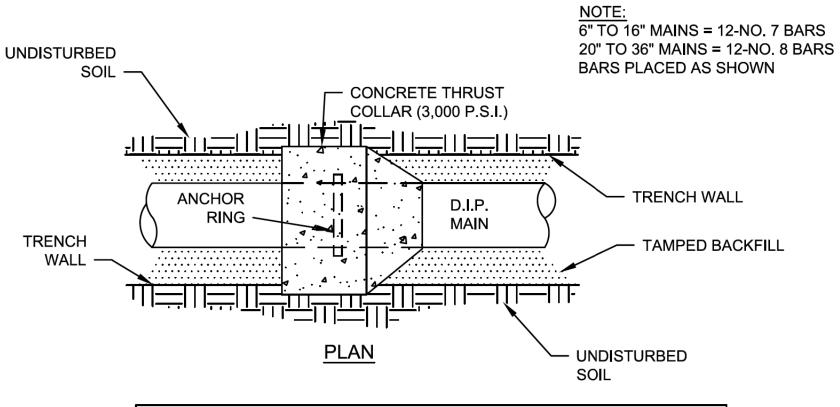

		SCHEDULE		
PIPE DIAMETER	CONCRETE T	HRUST COLLAR	ANCHOR COLLAR	RINGS REQUIRED
	Α	В	С	
6",8",12"	1'-0"	1'-0"	2"	ONE
16"	1'-4"	1'-0"	2"	ONE
20"	1'-4"	1-0"	3"	ONE
24"	1'-4"	1'-0"	3"	TWO
30"	1'-4"	1'-2"	4"	TWO
36"	1'-4"	1'-4"	4"	TWO

THRUST COLLAR INSTALLATION

NOT TO SCALE



	TEST PRESSURE = 150 PSI					
PIPE SIZE	TYPE FITTING	DIMEN	ISIONS (F1	n	VOLUME CONCRETE	
		"L"	"H"	"T"	CU. YD.	
	11 1/4*					
<4	22 1/2*	1.00	1.00	1.50	0.06	
INCHES	45°	1.00	1.00	1.50	0.06	
	90.	1.00	1.00	2.50	0.09	
	TEE	1.00	1.00	2.00	0.07	
	11 1/4*	1.00	1.00	2.50	0.09	
4	22 1/2°	1.00	1.00	2.50	0.09	
INCHES	45°	1.00	1.00	2.50	0.09	
	90.	1.50	1.50	2.50	0.15	
	TEE	1.50	1.50	2.00	0.12	
	11 1/4*	1.50	1.50	2.50	0.15	
6	22 1/2*	1.50	1.50	2.50	0.15	
INCHES	45°	1.50	1.50	2.50	0.15	
	90°	2.00	2.00	3.00	0.28	
	TEE	2.00	2.00	2.50	0.23	
	11 1/4*	2.00	2.00	2.50	0.23	
8	22 1/2*	2.00	2.00	2.50	0.23	
INCHES	45°	2.00	2.00	2.75	0.25	
	90.	3.00	2.00	3.00	0.39	
	TEE	3.00	2.00	2.50	0.32	
	11 1/4*	2.00	2.00	3.00	0.28	
12	22 1/2*	2.00	2.00	3.00	0.28	
INCHES	45°	3.00	2.50	3.00	0.47	
	90,	4.50	3.00	3.50	0.94	
	TEE	4.50	3.00	3.00	0.81	
	11 1/4*	2.00	2.00	3.00	0.28	
16	22 1/2*	3.00	2.00	3.00	0.39	
INCHES	45°	4.00	3.00	3.50	0.84	
	90.	6.50	3.50	3.50	1.54	
	TEE	6.50	3.50	3.00	1.32	

TEST PRESSURE = 200 PSI					
PIPE SIZE	TYPE FITTING	DIMEN	VOLUME CONCRETE		
0.22		"L"	"H"	"T"	CU. YD.
	11 1/4*	1.00	1.00	1.00	0.04
<4	22 1/2*	1.00	1.00	1.50	0.06
INCHES	45°	1.00	1.00	1.50	0.06
	90.	1.50	1.50	2.50	0.15
	TEE	1.50	1.50	2.00	0.12
	11 1/4*	1.00	1.00	2.50	0.09
4	22 1/2*	1.00	1.00	2.50	0.09
INCHES	45*	1.50	1.50	2.50	0.15
	90.	1.50	1.50	2.50	0.15
	TEE	1.50	1.50	2.00	0.12
	11 1/4°	1.50	1.50	2.50	0.15
6 Inches	22 1/2*	1.50	1.50	2.50	0.15
	45°	1.50	1.50	2.50	0.15
	90.	2.50	2.00	3.00	0.33
	TEE	2.50	2.00	2.50	0.28
	11 1/4°	2.00	2.00	2.50	0.23
8	22 1/2*	2.00	2.00	2.50	0.23
INCHES	45*	2.00	2.00	2.75	0.23
	90.	4.00	2.00	3.00	0.50
	TEE	4.00	2.00	2.50	0.42
	11 1/4	2.00	2.00	3.00	0.28
12	22 1/2*	3.00	2.00	3.00	0.39
INCHES	45°	4.00	2.50	3.00	0.61
	80.	5.50	3.00	3.50	1.13
	TEE	5.50	3.00	3.00	0.97
	11 1/4°	2.00	2.00	3.00	0.28
16	22 1/2°	4.00	2.00	3.00	0.50
INCHES	45°	5.50	3.00	3.50	1.13
	80.	7.50	4.00	3.50	2.01
	TEE	7.50	4.00	3.00	1.72


CHART NOTES:

1. IF BLOCKING EXCAVATION IS IN LIGHTLY COMPACTED FILL AREAS, OR IN AREAS WHERE BOULDERS OR STUMPS HAVE BEEN REMOVED, BLOCKING SIZE MUST BE RE-SIZED FOR

THE SPECIFIC LOCATION/CIRCUMSTANCE BY A NC LICENSED PROFESSIONAL ENGINEER.

- 2. BLOCKING SIZES SHOWN IN THESE TABLES ASSUME THE FOLLOWING:
- a. BLOCKING IS CONSTRUCTED IN RESIDUAL SOILS AS SHOWN IN DETAIL
- b. SOIL BEARING PRESSURE = 2000 PSF
- c. VELOCITY OF FLOW = 15 FPS
- 3. THIS DETAIL NOT APPLICABLE TO REDUCING BENDS.
- 4. NEITHER THE WEIGHT OF THE CONCRETE BLOCKING NOR FRICTION BETWEEN CONCRETE BLOCKING AND SOIL WAS ADDED INTO BLOCKING SIZES COMPUTATION. THEREFORE, BLOCKING SIZE IS CONSERVATIVE.

THRUST BLOCKING TABLE

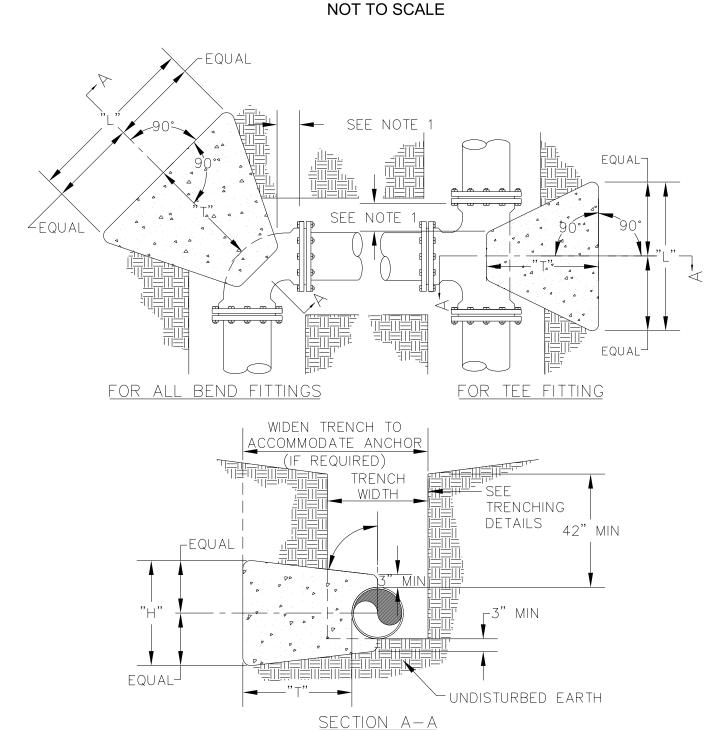



NOTEC

UNDISTURBED EARTH.

- 1. CONCRETE BLOCKING IS TO BE FORMED TO ENSURE ACCESSIBILITY TO FITTINGS AND POURED AGAINST
- 2. ALL FITTINGS SHALL BE WRAPPED IN POLYETHYLENE TO PREVENT CONCRETE FROM CONTACTING
- FITTINGS, BOLTS OR ENDS OF MECHANICAL JOINT BENDS.
- 3. CONCRETE TO BE MINIMUM 3,000 PSI @ 28 DAYS. 4. WHEN SACKRETE IS TO BE USED, IT SHALL BE PROPERLY MIXED PER MANUFACTURER SPECIFICATIONS.
- 4. WHEN SACKRETE IS TO BE USED, IT SHALL BE PROPERLY M 5. FOR REQUIRED DIMENSIONS, SEE THRUST BLOCKING TABLE.

THRUST BLOCKING NOT TO SCALE

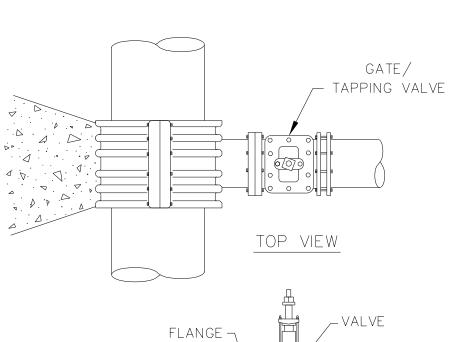


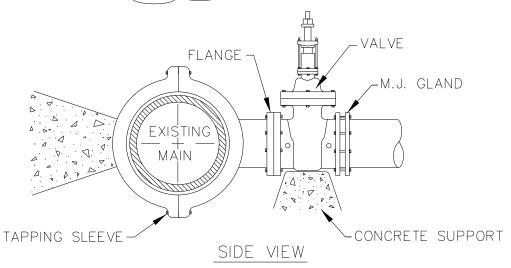

- NOTEO
- CONCRETE SHALL NOT CONTACT GLANDS, BOLTS OR ENDS OF MECHANICAL BOLTS, OR ENDS OF MECHANICAL JOINT FITTINGS. TAPPING SLEEVE AND BOTTOM OF VALVE SHALL BE WRAPPED IN POLYETHYLENE.
- 2. SEE STANDARD THRUST BLOCK TABLE FOR AREA OF CONCRETE REQUIRED.
 3. TAPPING SLEEVE SHALL BE TESTED IN ACCORDANCE WITH OWNER
- 4. TAPS ON SDR26 PIPE SHALL REQUIRE LONG SS TAPPING SLEEVES.

4" AND LARGER TAPPING SLEEVE AND VALVE ASSEMBLY

NOT TO SCALE

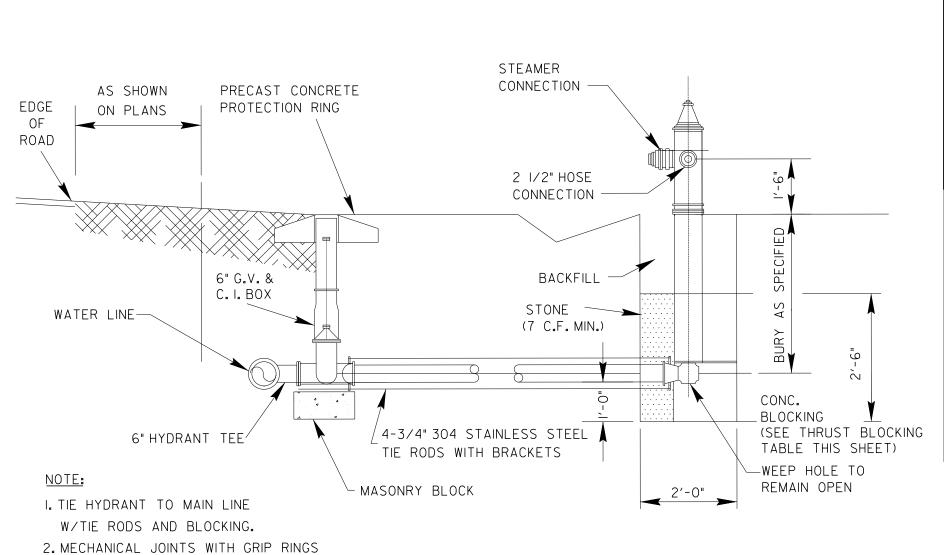


TYPICAL FIRE HYDRANT INSTALLATION DETAIL

NOT TO SCALE

CALDWELL COUNTY

PROJECT REFI	700CC		UC-3F
DESIGNED BY:	MRD		CAROUNDESSION SEAL
DRAWN BY:	ND		CARO
CHECKED BY:	JDN	30	COSE E 22/0%
APPROVED BY:	JDN		SEAL E
REVISED:		- 0 F. ()	ocusigned by 47349
NORTH CAROL DEPARTMENT TRANSPORTAT	OF	/28/202	05F574F91854BA 5/1/12:31:58 PM EDT
UTILITIES ENGINEER PHONE: (919)70 FAX: (919)250-4	7-6690	UTILI	TY CONSTRUCTION PLANS ONLY

UTILITY CONSTRUCTION

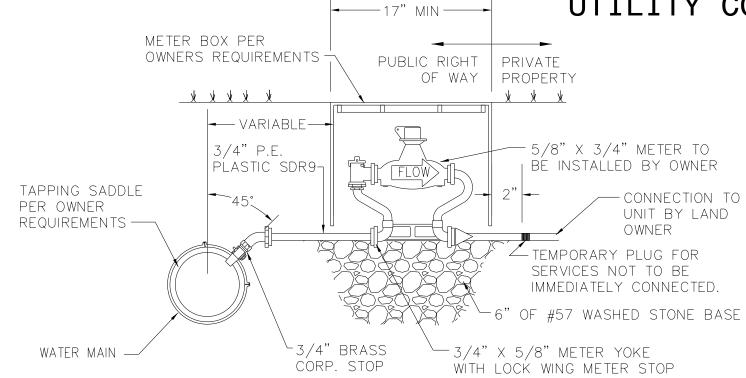


NOTES:

1. WATER METER TO BE INSTALLED IN NON-TRAFFIC AREAS

2. METER BOX TO BE SUPPORTED ON BRICK OR BLOCK

3/4" TO 1" SERVICE CONNECTION AND METER

NOT TO SCALE

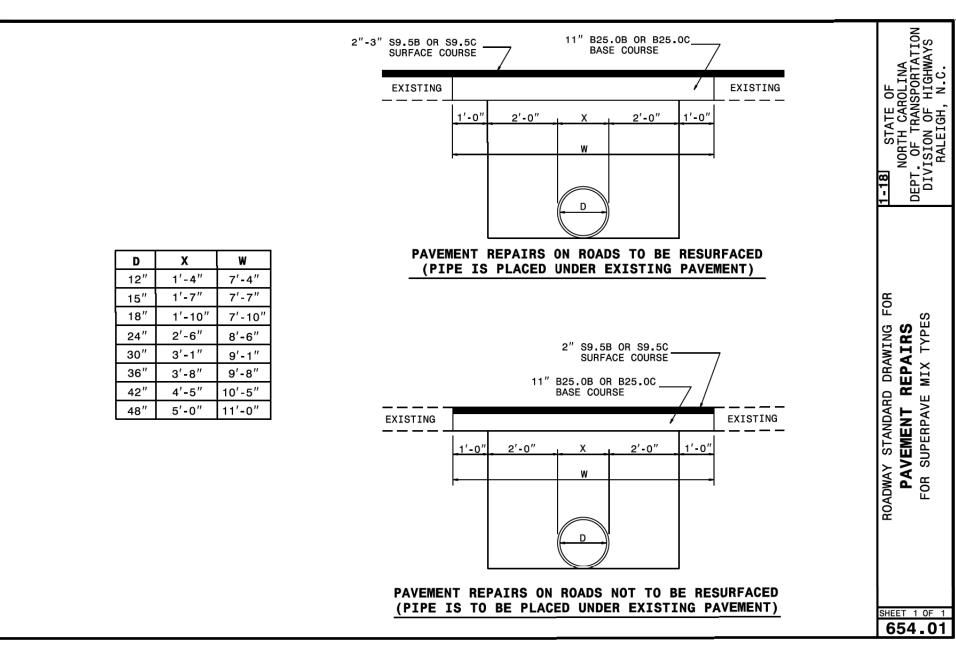

NOTES:

- 1. THE PAVEMENT SHALL BE DEFINED BY A STRAIGHT EDGE, PREFERABLY A MACHINED SAW CUT.
- 2. THE TRENCH SUBGRADE MATERIAL SHALL BE BACKFILLED WITH DRY SOIL OR ABC STONE TO THE BOTTOM OF THE PROPOSED SUBGRADE. THE BACKFILL SHALL BE PLACED AND COMPACTED IN ACCORDANCE WITH THE PROJECT SPECIFICATIONS.
- 3. WITHIN ROADS MAINTAINED BY NCDOT, THE TRENCH SHALL BE BACKFILLED AND
- COMPACTED IN ACCORDANCE WITH NCDOT STANDARDS.

 4. THE ENTIRE THICKNESS/VERTICAL EDGE OF THE CUT SHALL BE TACKED.
- 5. THE SAME DEPTH OF PAVEMENT MATERIAL WHICH EXISTS SHALL BE REINSTALLED, BUT IN NO CASE SHALL THE ASPHALT BE LESS THAN 2" THICK.
- 6. THE ASPHALT PAVEMENT MATERIAL SHALL BE INSTALLED AND COMPACTED THOROUGHLY TO ACHIEVE A SMOOTH LEVEL PATCH.

STANDARD PAVEMENT



NOT TO SCALE

CUT AND PATCH DETAILS

CALDWELL COUNTY

DESIGNED BY: MRD

DRAWN BY: ND

CHECKED BY: JDN

APPROVED BY: JDN

REVISED:

NORTH CAROLINA
DEPARTMENT OF
TRANSPORTATION 5/28/2025 / 12; 31; 58 PM EDT


UTILITIES ENGINEERING SEC.
PHONE: (919)707-6690
FAX: (919)250-4151

DOCUMENT NOT CONSIDERED FINAL
UNTIL ALL SIGNATURES ARE COMPLETED

PROJECT REFERENCE NO.

SHEET NO.

UTILITY CONSTRUCTION

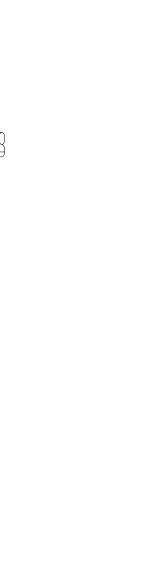

SUBGRADE

<u>DIP PIPE</u> ALL TRENCH TYPES ADAPTER COULPING

GRAVITY

SEWER LINE

SEE NOTE -

GRAVITY SEWER EMBEDMENT DETAIL NOT TO SCALE

SUBGRADE

<u>PVC_PIPE</u> ALL_TRENCH_TYPES

-CLEAN, WASHED -NO.57 STONE



- INLINE WYE INSTALL IN ACCORDANCE

WITH MANUF. RECOMMENDATION. MIN.

4" #57 STONE BEDDING UNDER WYE

NOTE:

1. REFER TO SPECIFICATIONS FOR BEDDING, BACKFILLING AND COMPACTION REQUIREMENTS.

BEND

INSTALL CAST IRON BOX OVER -

PLUG LINE 4" BELOW GRADE —

-10' FROM EDGE OF

R/W. WHICHEVER IS

PAVEMENT OR TO

CLOSER

STUB OUT 1' PAST SEWER
TEE AND INSTALL TEST CAP

— SCH 40 PVC DMV SEWER

SERVICE PIPE AT 1% MIN.

CLEANOUT WITH "CO" ON LID

MINIMUM A/G WEIGHT FRAME 262 LBS. 1" LETTERING RECESSED FLUSH ---COVER 170 LBS. TOTAL 432 LBS. T A 3 -1" DIA. HOLES AT 120° TYPICAL LIFTING DEVICE GASKET IN VERTICAL FACE OF COVER RING MUST BE ANCHORED (SEE NOTE 1) - 5/8" Ø STAINLESS TYPICAL LIFTING DEVICE STEEL ROD - TOP OF COVER <u>SECTION A</u> ALL MANHOLE FRAMES SHALL BE DOMESTICALLY CAST. FRAME SHALL BE A MINIMUM WEIGHT OF 182 LBS.

1. ALL MANHOLE FRAMES SHALL BE DOMESTICALLY CAST.
2. FRAME SHALL BE A MINIMUM WEIGHT OF 182 LBS.
3. COVER SHALL WEIGH A MIN. OF 120 LBS.
4. MANHOLES WITHIN PAVED SURFACES SHALL BE
CONSTRUCTED IN ACCORDANCE WITH DETAIL.
5. CONSEAL SHALL BE USED BETWEEN RING AND CONE.

MANHOLE FRAME AND WATERTIGHT COVER

NOT TO SCALE

¬M.H. RING AND COVER FOR H-20 LOADING CONCRETE COLLAR TO -GROUND SURFACE GROUT AROUND RING FINISHED GRADE, -TOP OF PAVEMENT SEE NOTE #1 -BUTYL MASTIC ROPE GRADE RINGS 8" MAX.— - ECCENTRIC CONE BUTYL MASTIC ROPE SEALANT, (TYP.) POLYOLEFIN BACKED EXTERIOR JOINT WRAP TO SEAL EXTERIOR DEPTH OF JOINTS INSTALL. 4' - 0" 8" TO 12" 0' TO 15' 5' - 0" 15" TO 30" 15' TO 30' 6' - 0" 36" & GREATER 30' & GREATER MONOLITHIC -BASE -GROU**T** CHANNEL INV. ELEV. SEE NOTE #2 8" MIN. #57 STONE S AGGREGATE BASE COMPACTED SUBGRADE

1. THE DISTANCE FROM THE TOP OF M.H. RING AND COVER MAY VERY WIDELY. SEE GRADING PLAN, AND/OR MANHOLE SCHEDULE.

2. INVERT ELEV. SHOWN ON THE PLANS OR MANHOLE SCHEDULE ARE AT THE INLET AND OUTLET OF MANHOLE UNLESS OTHERWISE NOTED.

3. CARRIER PIPE TO MANHOLE CONNECTIONS SHALL BE RUBBER SLEEVE WITH DUAL S.S. BANDS.


4. ALL MANHOLES ARE TO BE EXTENDED BASE.
5. ALL INTERIOR JOINTS AND LIFTING POINTS SHALL BE SEALED WITH GROUT.
6. MANHOLES SHALL NOT HAVE STEPS.


7.MANHOLES SHALL NOT HAVE STEPS.


7.MANHOLES SHALL BE CONSTRUCTED IN ACCORDANCE WITH SECTION 1525 (UTILITY MANHOLES) OF THE STANDARD SPECIFICATIONS.


STANDARD PRECAST SANITARY SEWER MANHOLE (ECCENTRIC)


NOT TO SCALE

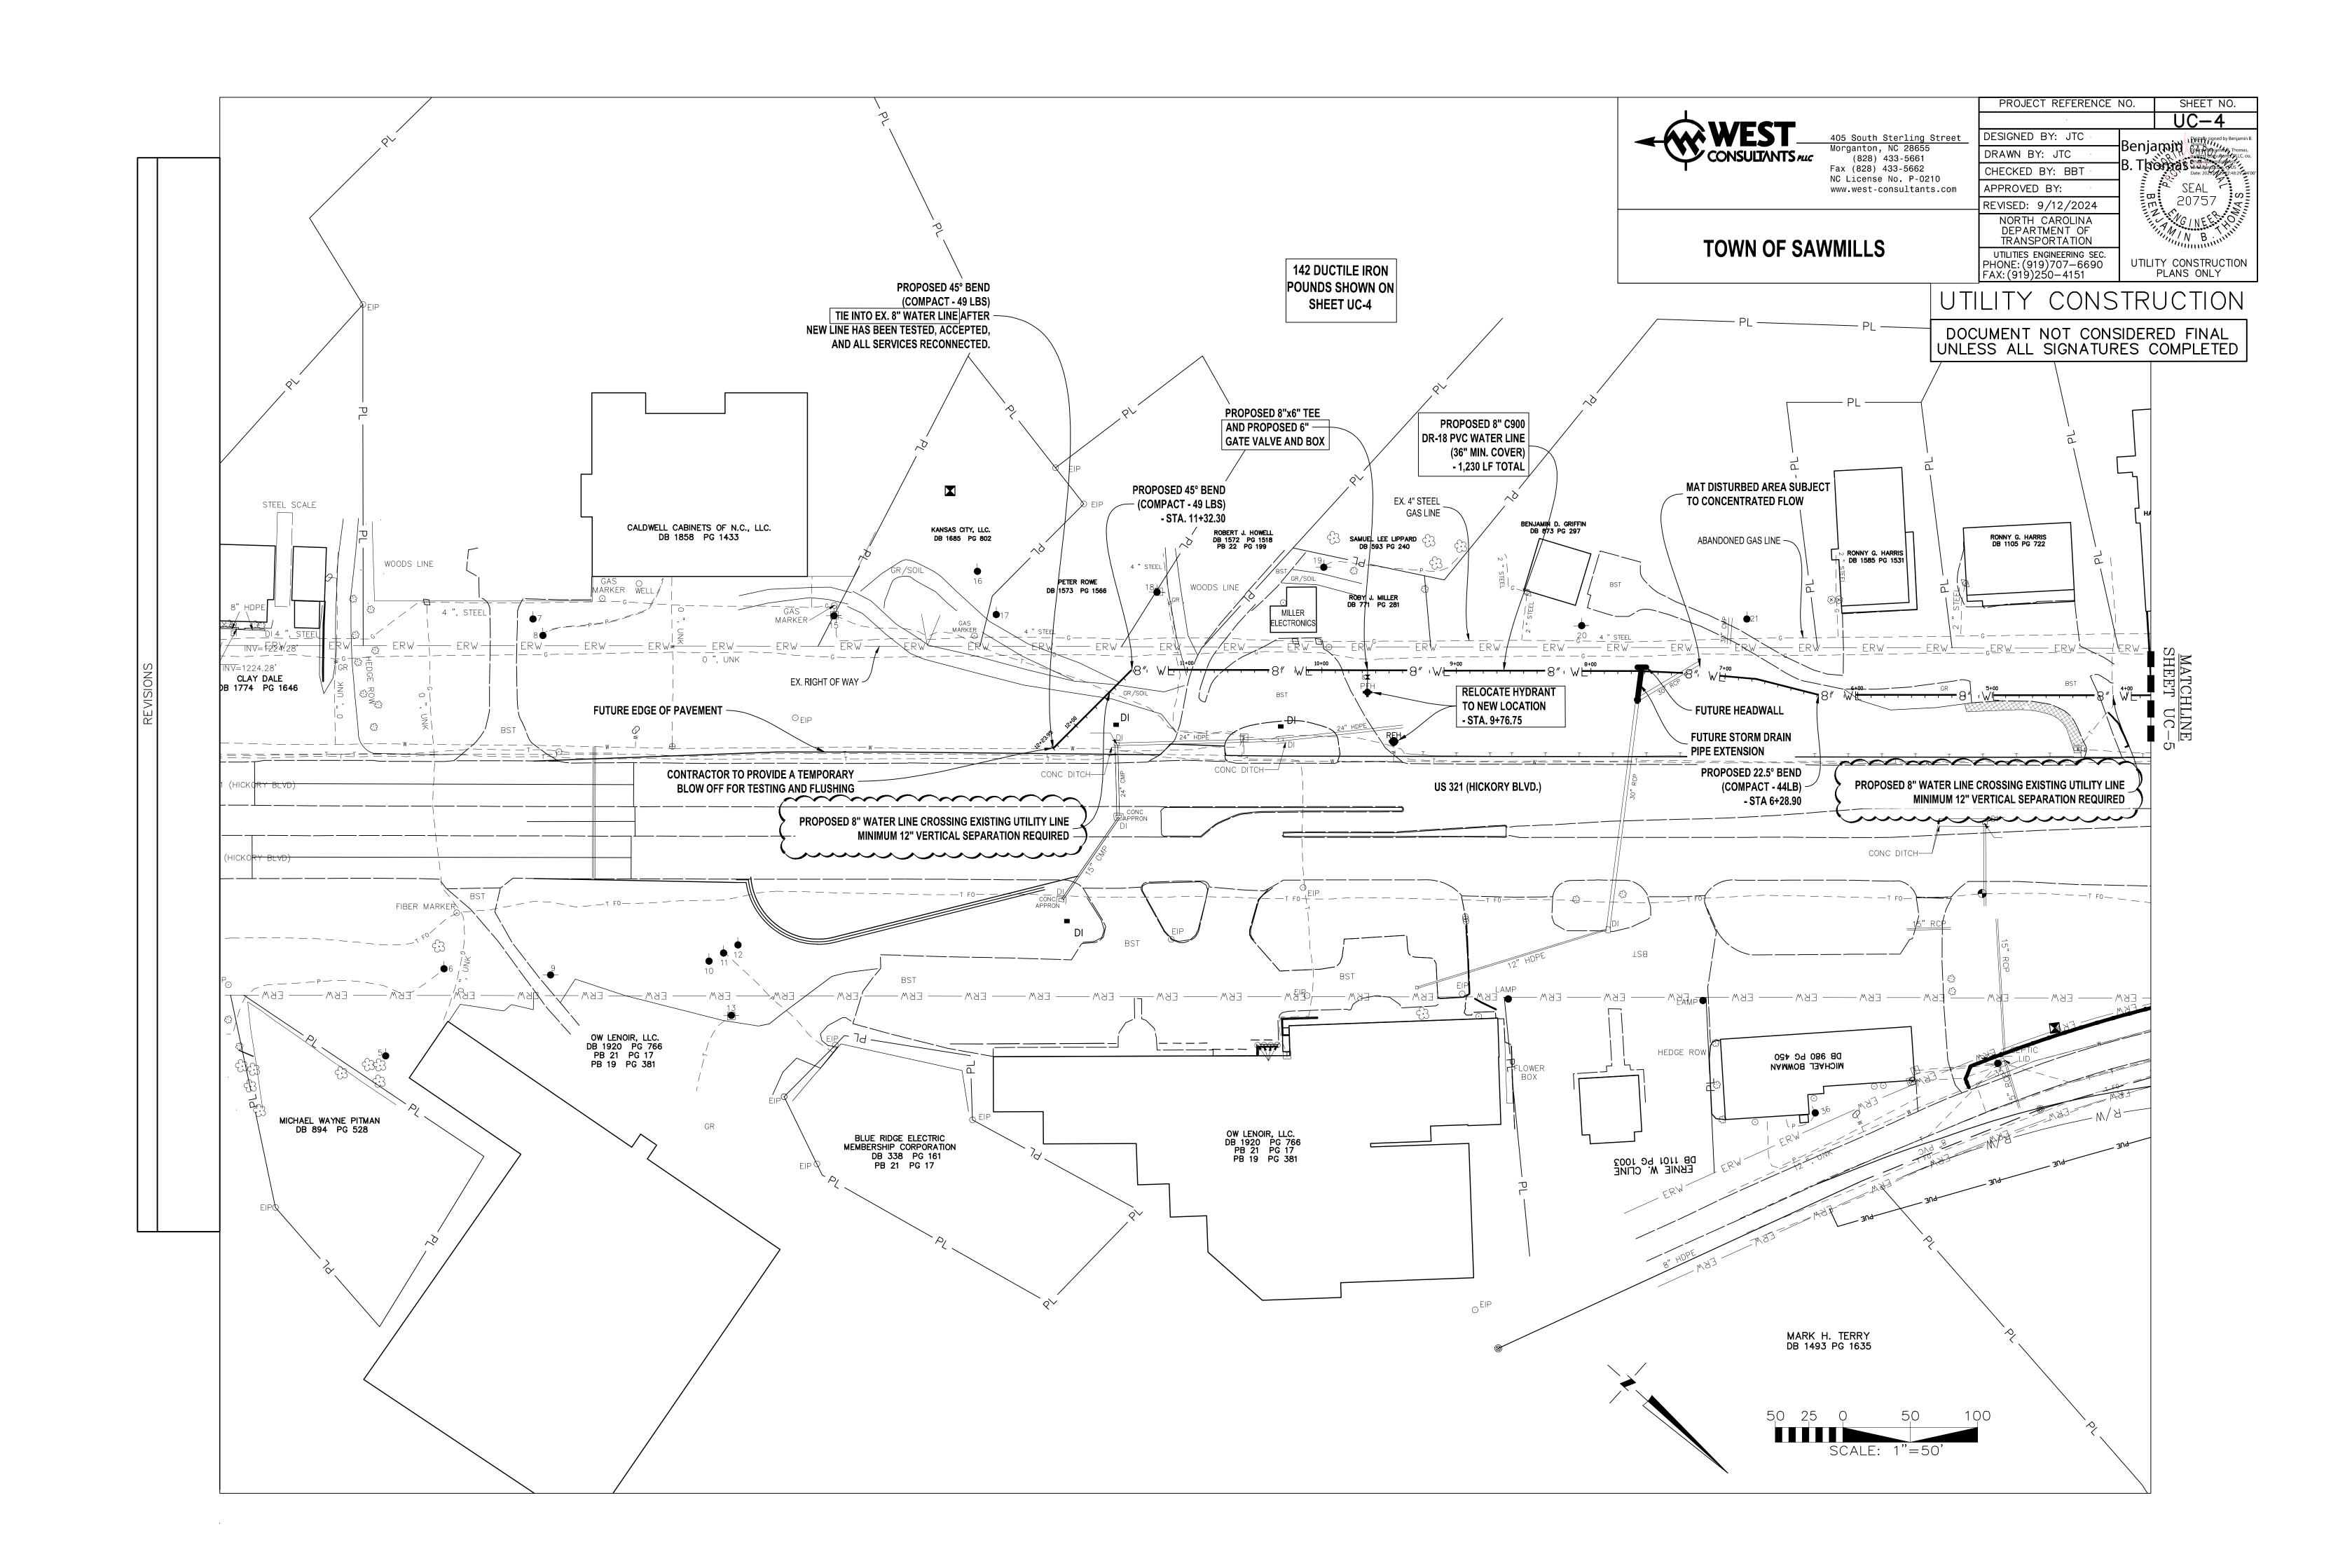


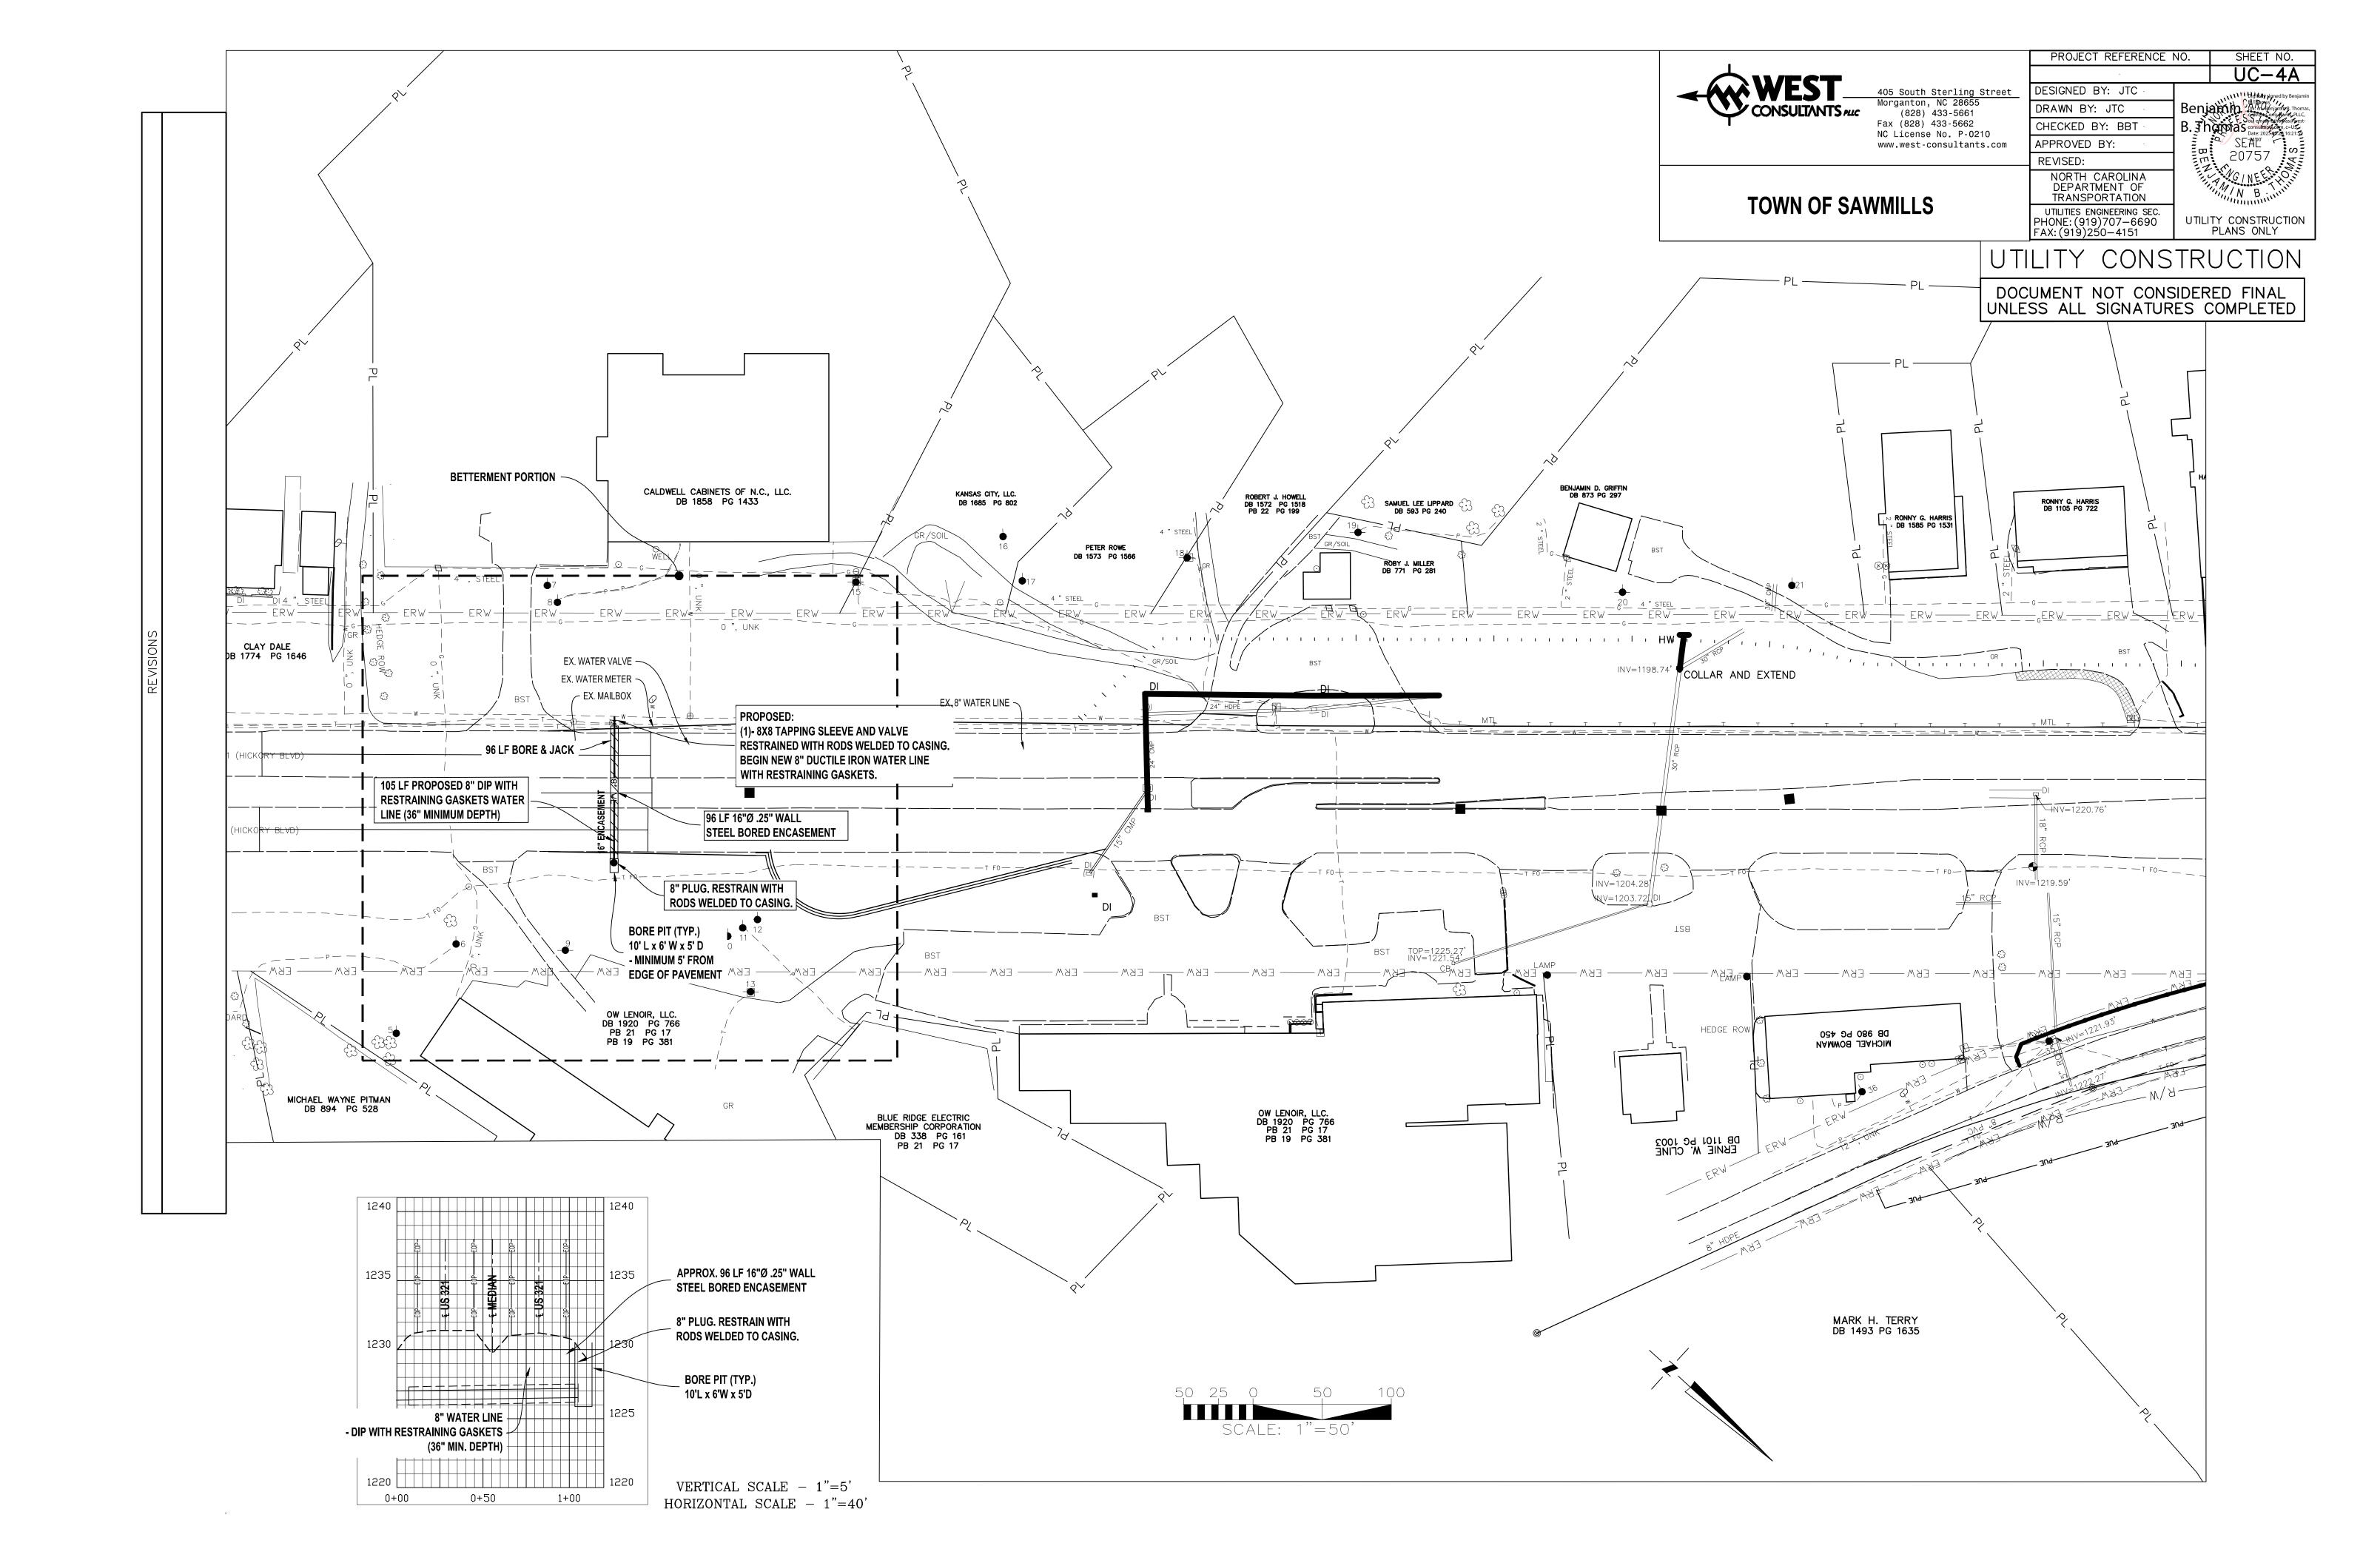

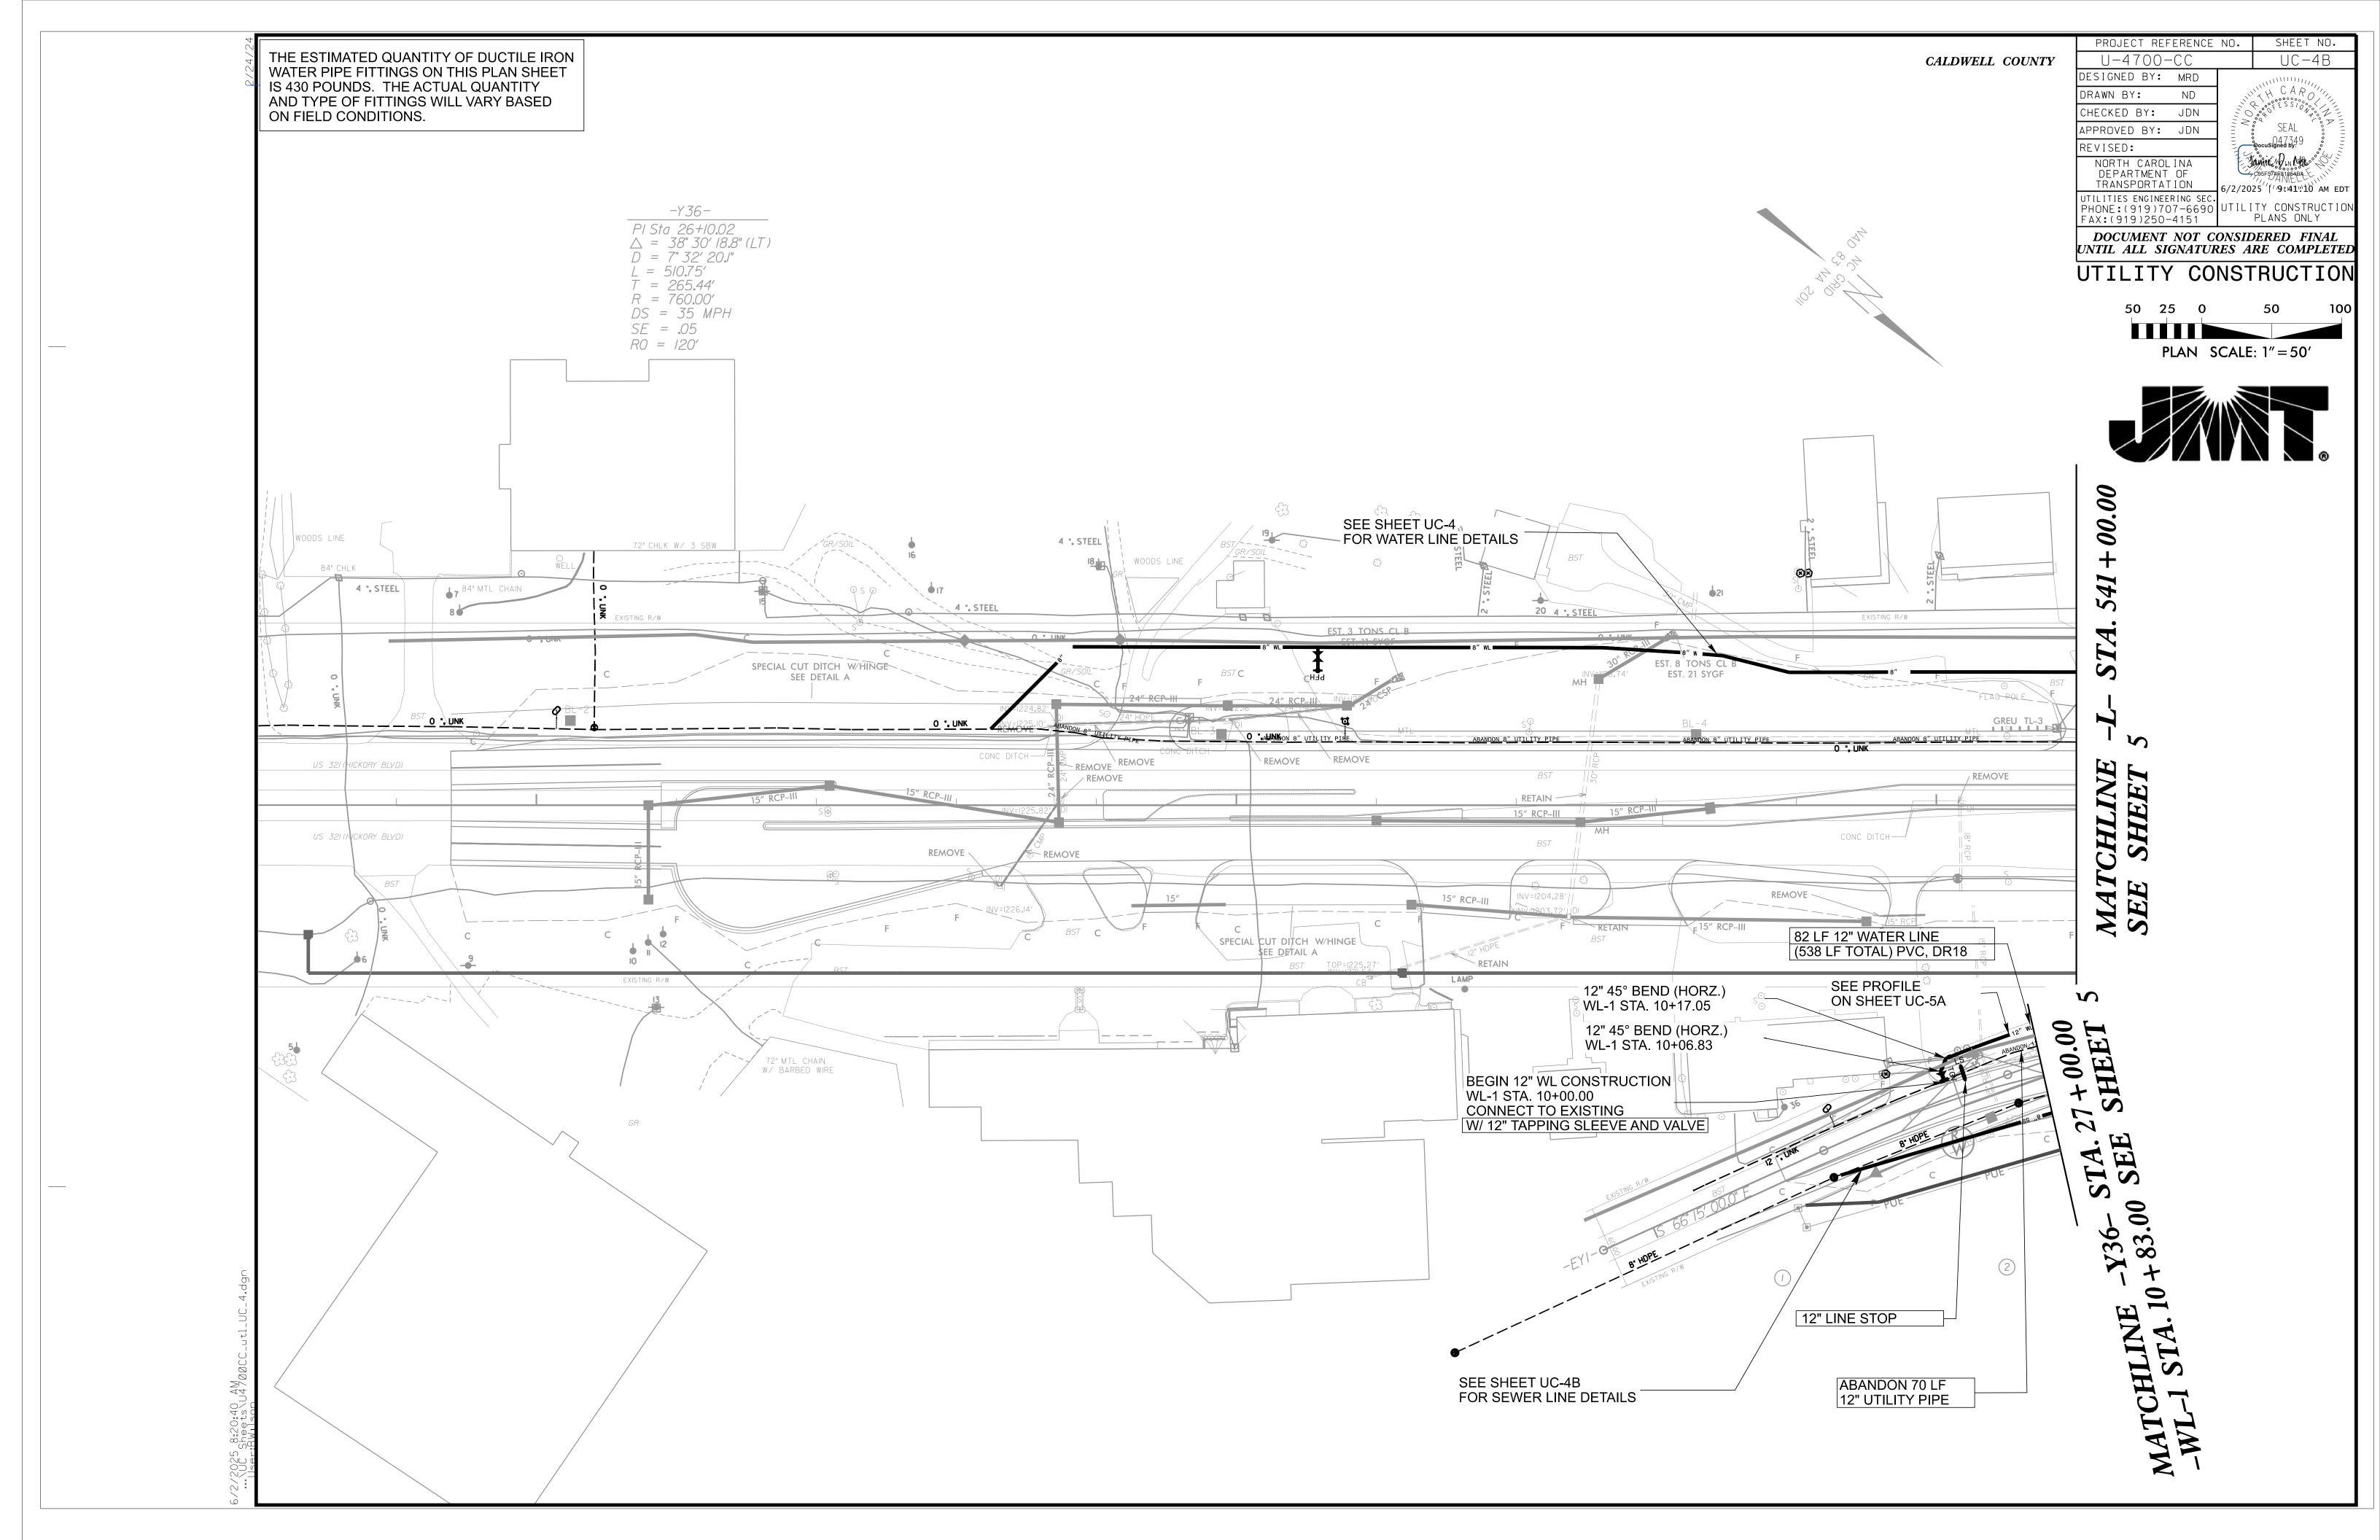

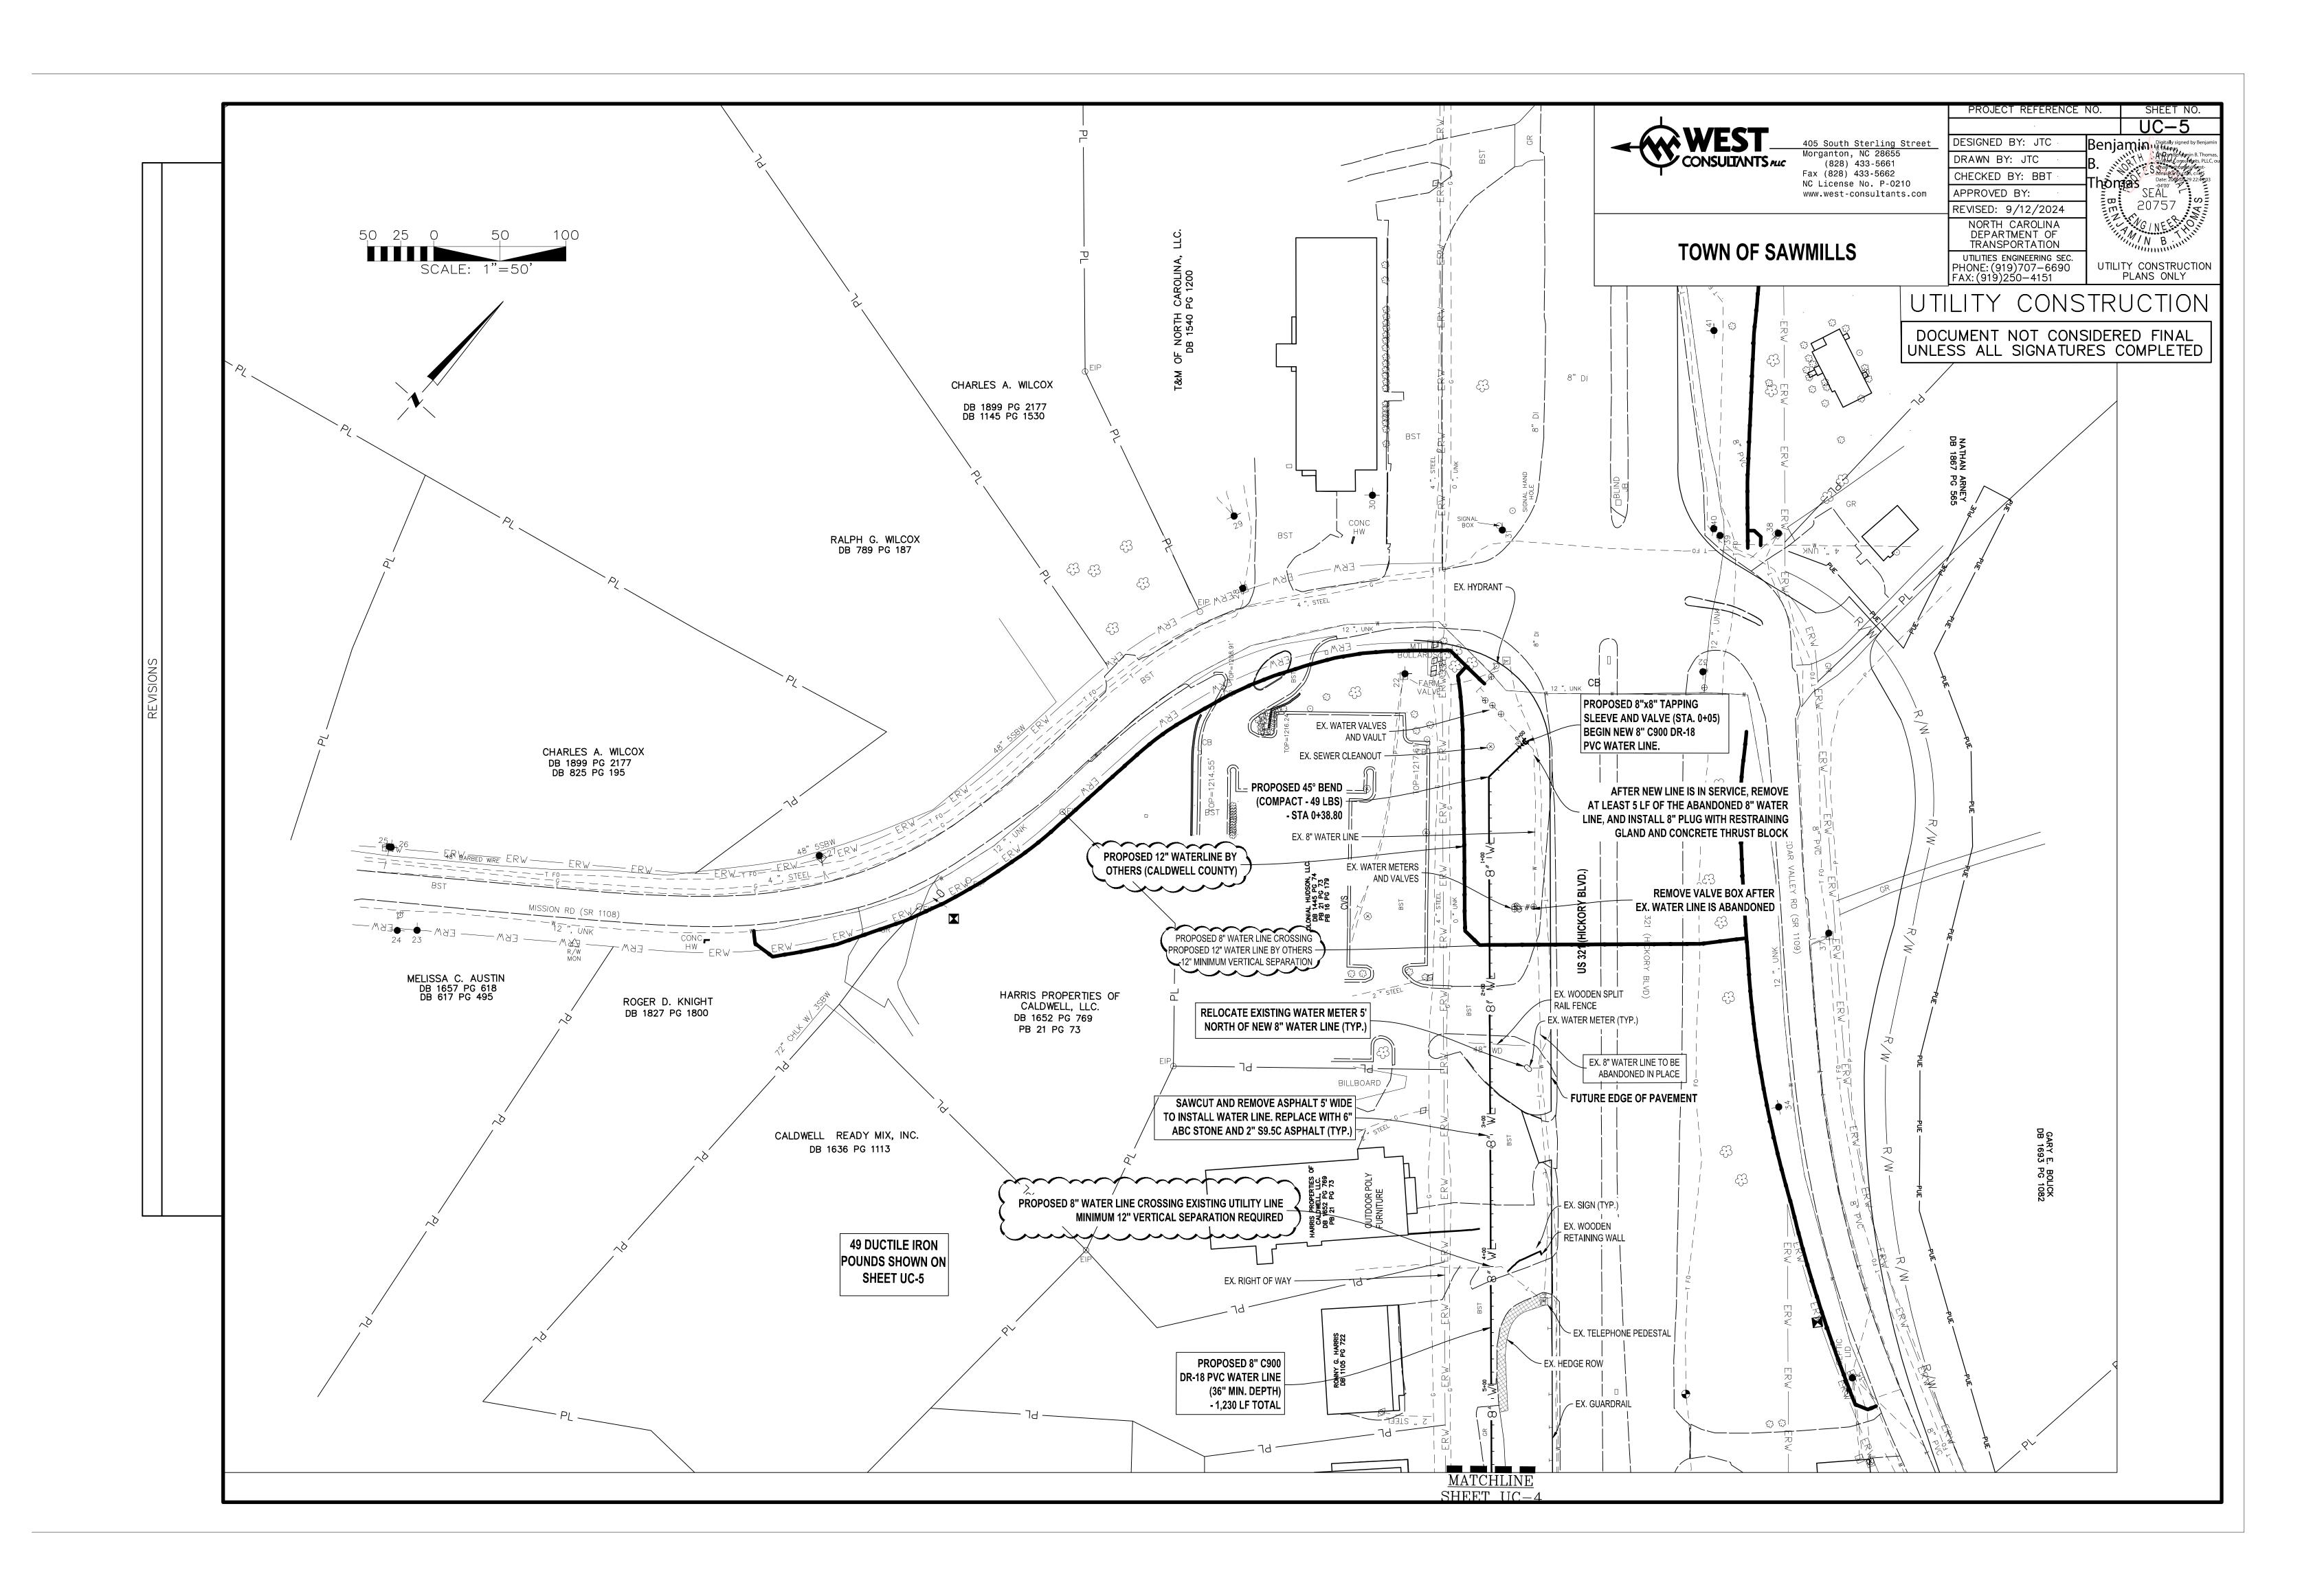

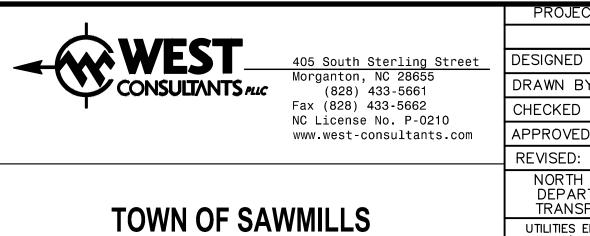

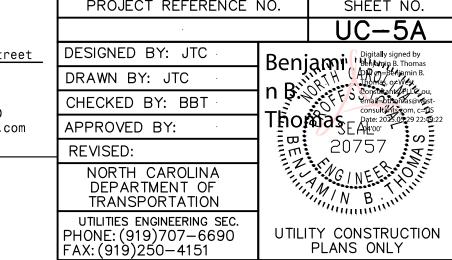

PROPOSED 45° BEND


(COMPACT - 49 LBS)

— TIE INTO EX. 8" WATER LINE AFTER


AND ALL SERVICES RECONNECTED.

NEW LINE HAS BEEN TESTED, ACCEPTED,

UTILITY CONSTRUCTION DOCUMENT NOT CONSIDERED FINAL UNLESS ALL SIGNATURES COMPLETED

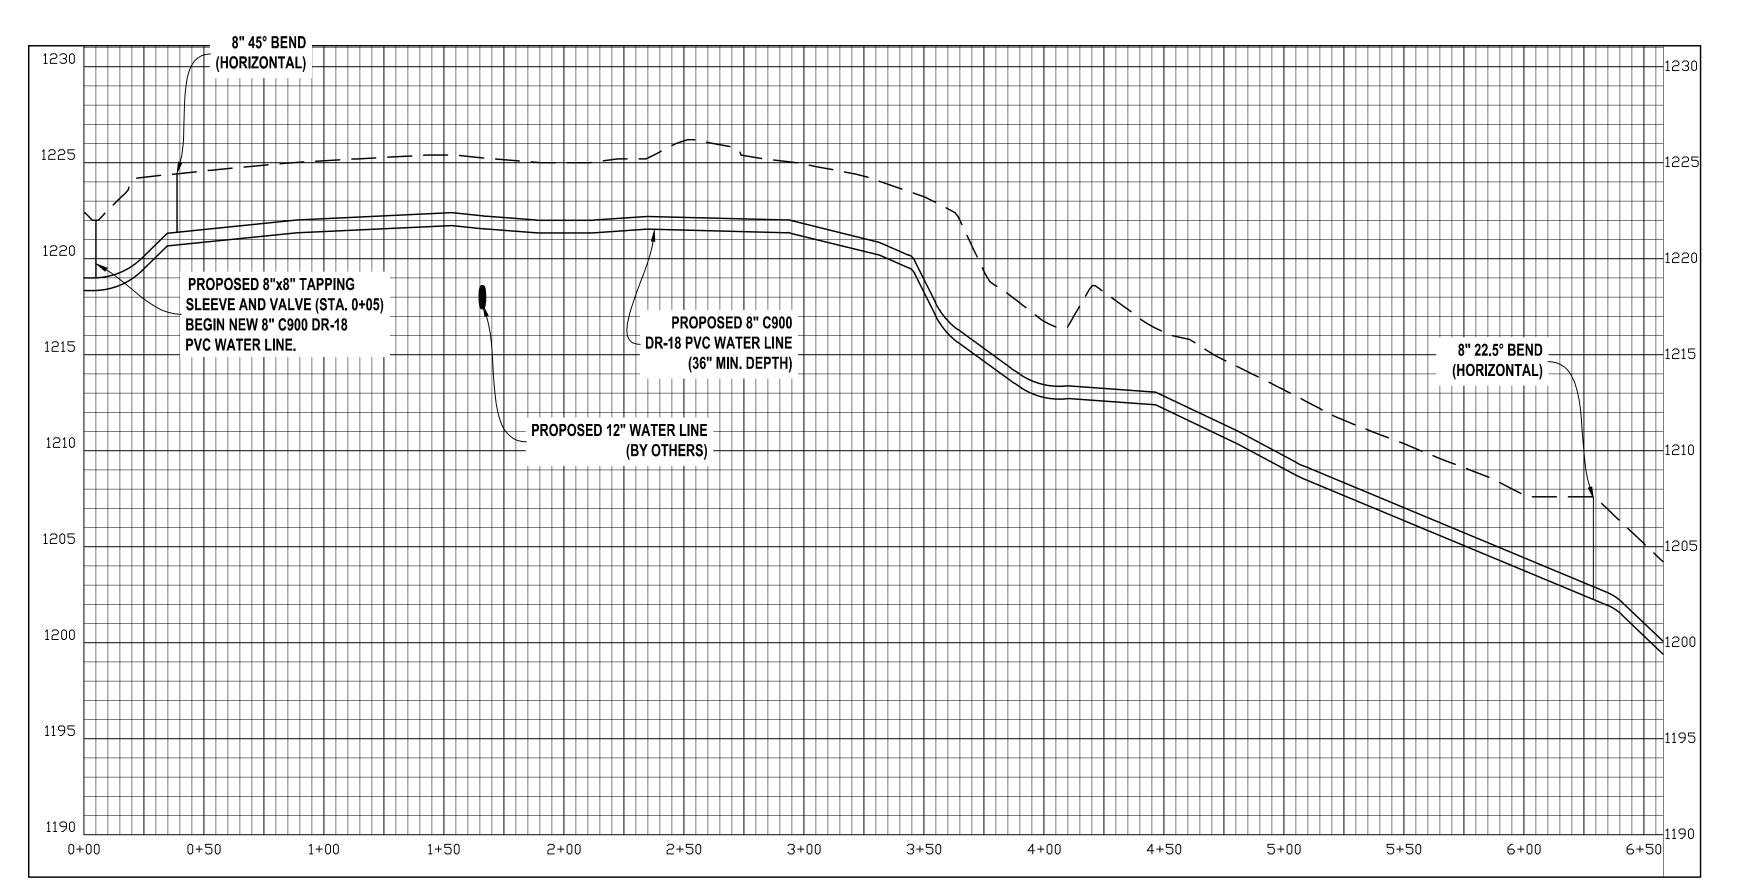

VERTICAL SCALE - 1"=5" HORIZONTAL SCALE - 1"=40'

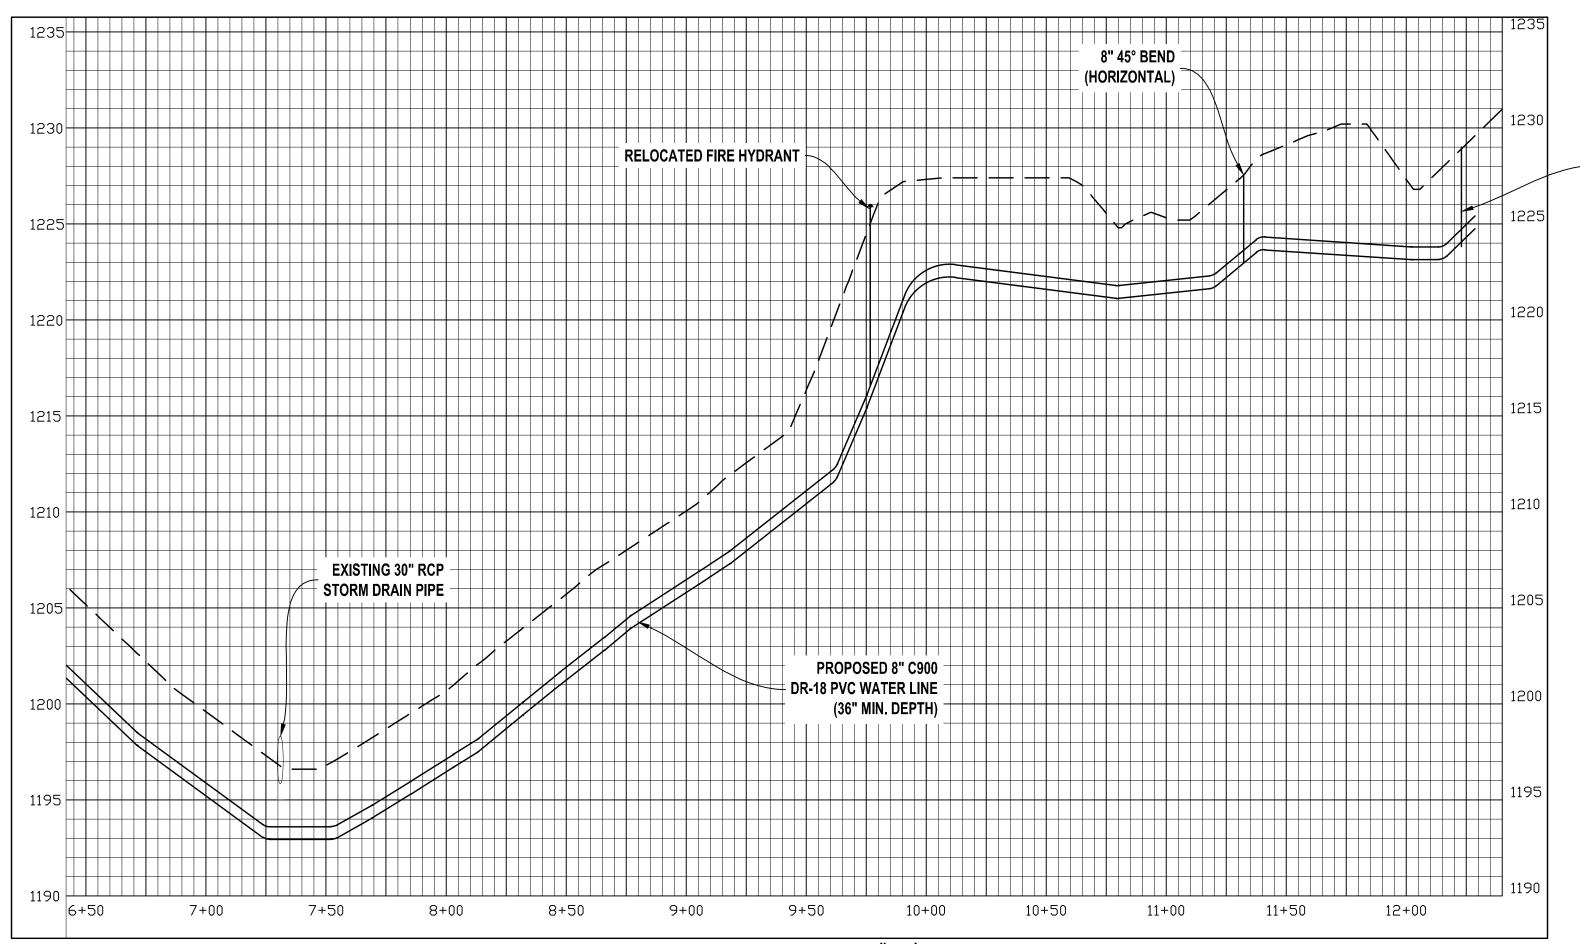

VERTICAL SCALE - 1"=5' HORIZONTAL SCALE - 1"=40"

