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ENTRAL HEIGHTS

BYP (70)

VICINITY MAP

PROJECT

SEE SHEET UC-2 FOR CONVENTIONAL PLAN SHEET SYMBOLS

BEGIN — PROJECT

BUS 70

N SPENCE

STATE OF NORTH CAROLINA DIVISION OF HIGHWAYS

T.I.P. NO.


U-5724

UC-1

SHEET NO.

UTILITY CONSTRUCTION PLANS WAYNE COUNTY

LOCATION: SR 1560 (ROYALL AVENUE) FROM NORTH PARK DRIVE TO US 13 (BERKELEY BOULEVARD) AND SR 1709 (CENTRAL HEIGHTS ROAD) FROM US 13 (BERKELEY BOULEVARD) TO SR 1711 (OAK FOREST ROAD)

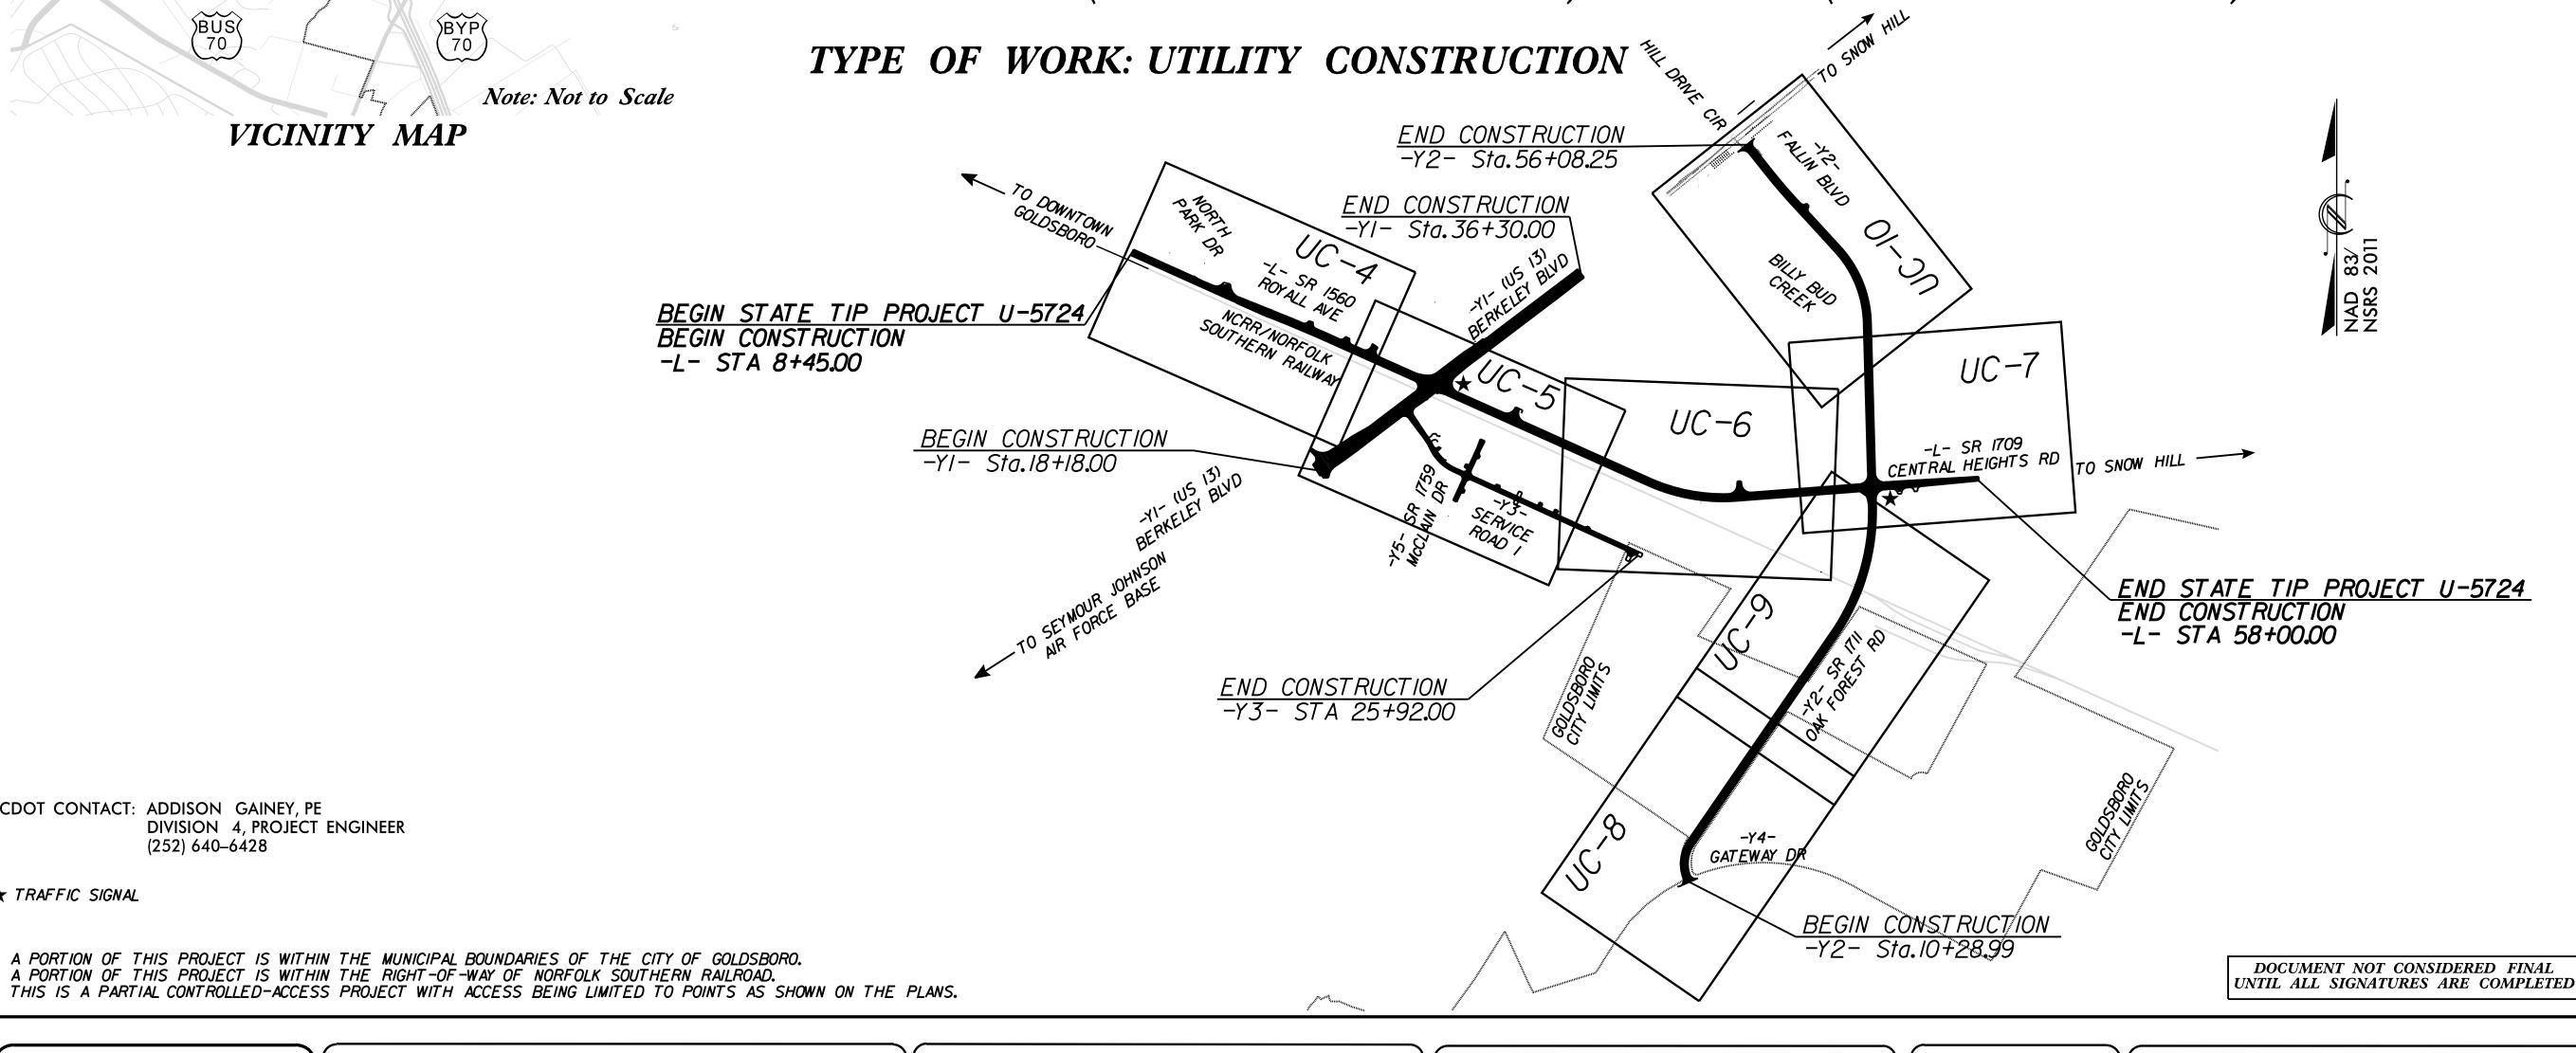

GRAPHIC SCALES PROFILE (HORIZONTAL) PROFILE (VERTICAL)

NCDOT CONTACT: ADDISON GAINEY, PE

* TRAFFIC SIGNAL

(252) 640–6428

DIVISION 4, PROJECT ENGINEER

INDEX OF SHEETS

SHEET NO.: **DESCRIPTION:**

UC-1 TITLE SHEET UTILITY SYMBOLOGY *UC-3* UTILITY NOTES UC-3A THRU UC-3E UTILITY DETAILS

UC-4 THRU UC-10 UTILITY CONSTRUCTION SHEETS UC-11 THRU UC-14 UTILITY PROFILE SHEETS

WATER AND SEWER OWNERS ON PROJECT

(A) WATER/SEWER – CITY OF GOLDSBORO: **BOBBY CROOM** 919–580–4367




RALEIGH, NORTH CAROLINA 27636 PHONE: (919) 677-2000

Nate Harvey, P.E. Cody Mangano, PE

Nolan Raney, PE

CONSULTANT CONTACT #1 CONSULTANT CONTACT #2

CONSULTANT CONTACT #3

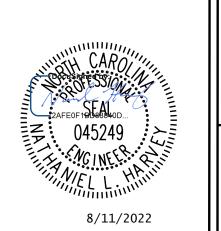

SEAL



DIVISION OF HIGHWAYS UTILITIES UNIT 1555 MAIL SERVICES CENTER RALEIGH NC 27699–1555 PHONE (919) 707–6690 FAX (919) 250–4151

<u>Nabil Ham</u>dan Kyle Pleasant

Frank Zdelar

UTILITIES REGIONAL ENGINEER

UTILITIES ENGINEER Tanga Sampson UTILITIES REGIONAL COORDINATOR

UTILITIES COORDINATOR

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PROJECT REFERENCE NO. SHEET NO. U-5724 UC-2

STATE OF NORTH CAROLINA DIVISION OF HIGHWAYS

UTILITIES PLAN SHEET SYMBOLS

PROPOSED WATER SYMBOLS

Water Line (Sized as Shown) ------90 Degree Bend ····· Gate Valve-----Butterfly Valve -----Tapping Valve -----Line Stop -----Line Stop with Bypass -----Blow Off -----Fire Hydrant -----Relocate Fire Hydrant -----Remove Fire Hydrant Water Meter Relocate Water Meter REM WM Remove Water Meter Water Pump Station -----RPZ Backflow Preventer -----DCV Backflow Preventer Relocate RPZ Backflow Preventer-----Relocate DCV Backflow Preventer PROPOSED SEWER SYMBOLS

Gravity Sewer Line

Force Main Sewer Line

(Sized per Note)

Sewer Pump Station ------PS(SS)

(Sized as Shown)

(Sized as Shown)

PROPOSED MISCELLANOUS UTILITIES SYMBOLS

Power Pole	δ	Thrust Block
Telephone Pole ····································	-> -	Air Release Valve
Joint Use Pole ····································	-	Utility Vault
Telephone Pedestal ······	© PED	Concrete Pier
Utility Line by Others(Type as Shown)	PROP O/H POW LINES	Steel Pier
Trenchless Installation	12" TL INSTALL	Plan Note
Encasement by Open Cut	24" ENCAS BY OC	Pay Item Note
Encasement	24" ENCASEMENT	

EXISTING UTILITIES SYMBOLS

Power Pole ·····	•
Telephone Pole	-
Joint Use Pole	-
Utility Pole	•
Utility Pole with Base	⊡
H-Frame Pole ·····	••
Power Transmission Line Tower	\boxtimes
Water Manhole ·····	W
Power Manhole	(P)
Telephone Manhole ·····	•
Sanitary Sewer Manhole	(
Hand Hole for Cable	F.,
Power Transformer	M
Telephone Pedestal	T
CATV Pedestal ······	C
Gas Valve ·····	♦
Gas Meter	♦
Located Miscellaneous Utility Object	0
Abandoned According to Utility Records	AATUR
End of Information	E.O.I.

"Underground Power Line	P ———
*Underground Telephone Cable	т
*Underground Telephone Conduit	тс
*Underground Fiber Optics Telephone Cable	т го
*Underground TV Cable	т v ———————————————————————————————————
*Underground Fiber Optics TV Cable	TV F0
*Underground Gas Pipeline	
Aboveground Gas Pipeline	A/G Gas
*Underground Water Line	
Aboveground Water Line	A/G Water
*Underground Gravity Sanitary Sewer Line	
Aboveground Gravity Sanitary Sewer Line-	A/G Sanitary Sewer
*Underground SS Forced Main Line	FSS —
*Underground SS Forced Main Line Underground Unknown Utility Line	
	?UTL
Underground Unknown Utility Line	? ∪TL —
Underground Unknown Utility LineSUE Test Hole	₹UTL
Underground Unknown Utility Line	?UTL ∵ ⊗

*For Existing Utilities	
Utility Line Drawn from Record	
Designated Utility Line	

GENERAL NOTES:

- 1. ALL WORK SHALL COMPLY WITH APPLICABLE STATE, FEDERAL, AND LOCAL CODES, AND ALL NECESSARY LICENSES AND PERMITS SHALL BE OBTAINED BY THE CONTRACTOR AT ITS EXPENSE, UNLESS PREVIOUSLY OBTAINED BY THE OWNER(S) AND PROVIDED AT THE PRECONSTRUCTION CONFERENCE.
- 2. DEVIATION FROM THESE PLANS AND NOTES WITHOUT THE PRIOR WRITTEN CONSENT OF THE UTILITY OWNER OR THEIR REPRESENTATIVE OR THE ENGINEER MAY BE CAUSE FOR THE WORK TO BE UNACCEPTABLE.
- 3. THE CONTRACTOR SHALL NOTIFY THE ENGINEER IMMEDIATELY SHOULD ANY FIELD CONDITIONS BE ENCOUNTERED THAT VARY FROM THE INFORMATION PROVIDED IN THE CONTRACT DOCUMENTS.
- 4. CONTRACTOR SHALL PLAN AND CONSTRUCT WORK SO AS TO CAUSE MINIMUM INCONVENIENCE TO THE UTILITY OWNER(S) AND PUBLIC. THE CONTRACTOR SHALL PROVIDE TRAFFIC CONTROL AND ERECT AND MAINTAIN AT ALL TIMES DURING THE PROGRESS OR TEMPORARY SUSPENSION OF WORK, SUITABLE BARRIERS, FENCES, SIGNS OR OTHER ADEQUATE PROTECTION, INCLUDING FLAG MEN AND WATCHMEN AS NECESSARY TO ENSURE THE SAFETY OF THE PUBLIC AS WELL AS THOSE ENGAGED IN THE CONSTRUCTION WORK.

 CONSTRUCTION SIGNAGE SHALL BE IN ACCORDANCE WITH THE LATEST EDITION OF "CONSTRUCTION AND MAINTENANCE OPERATIONS SUPPLEMENT TO THE MANUAL ON UNIFORM TRAFFIC CONTROL DEVICES" BY THE NCDOT.
- 5. ALL WATER AND SEWER CONSTRUCTION SHALL CONFORM TO NCDEQ REGULATIONS, AND TO CURRENT UTILITY OWNER REGULATIONS, STANDARDS, AND SPECIFICATIONS. CONTRACTOR SHALL OBTAIN FROM EACH UTILITY OWNER AND ENGINEER APPROVED SUBMITTALS FOR ALL MATERIALS PROPOSED TO BE INCORPORATED IN THE WORK PRIOR TO ORDERING ANY MATERIALS OR COMMENCING UTILITY CONSTRUCTION.
- 6. CONTRACTOR SHALL COORDINATE ALL WORK WITH UTILITY OWNERS LEAST 48 HOURS PRIOR TO THE START OF CONSTRUCTION, OR AS OTHERWISE SPECIFIED HEREIN. CITY OF GOLDSBORO CONSTRUCTION INSPECTORS JOHNATHAN PERRY AND JOHN HEATH CAN BE REACHED AT 919-580-4317 AND 919-580-4368, RESPECTIVELY.
- 7. ALL PIPE LENGTHS ARE MEASURED ALONG A HORIZONTAL PLANE. SANITARY SEWER LINES ARE MEASURED TO CENTER OF MANHOLE.
- 8. THE CONTRACTOR SHALL PROVIDE ALL STAKEOUT SURVEY. ANY EXISTING STAKEOUT OR BENCHMARKS SHALL NOT BE RELIED UPON BY THE CONTRACTOR.
- 9. COORDINATES SHOWN ON THE DRAWINGS ARE BASED ON THE NORTH CAROLINA STATE PLANE COORDINATE SYSTEM (NAD 83).
- 10. ANY NECESSARY FIELD REVISIONS ARE SUBJECT TO REVIEW & APPROVAL OF AN AMENDED PLAN &/OR PROFILE BY THE UTILITY OWNER PRIOR TO CONSTRUCTION.
- 11. LOCATIONS OF EXISTING SHOWN UTILITIES ARE APPROXIMATE. IT IS THE RESPONSIBILITY OF THE CONTRACTOR TO DETERMINE THE SIZE, DEPTH, MATERIAL AND LOCATION OF ALL EXISTING UNDERGROUND UTILITIES PRIOR TO CONSTRUCTION AND TO TAKE WHATEVER STEPS ARE NECESSARY TO PROVIDE FOR THEIR PROTECTION. THE ENGINEER HAS ATTEMPTED TO LOCATE AND INDICATE ALL EXISTING FACILITIES ON THE PLANS; HOWEVER, THIS INFORMATION IS SHOWN FOR THE CONTRACTOR'S CONVENIENCE ONLY. THE ENGINEER AND THE OWNER(S) ASSUME NO RESPONSIBILITY FOR THE LOCATIONS OF UTILITIES SHOWN OR NOT SHOWN. PRIOR TO DIGGING ON AND OFF SITE, THE CONTRACTOR SHALL HAVE ALL UTILITIES LOCATED BY "NC 811" 1-800-632-4949. THE CONTRACTOR SHALL CONTACT ANY UTILITY OWNER WHOSE UTILITIES ARE NOT LOCATED BY "NC 811" FOR EXACT LOCATION OF THEIR UTILITIES PRIOR TO STARTING CONSTRUCTION. IT SHALL BE THE SOLE RESPONSIBILITY OF THE CONTRACTOR TO REPAIR AND/OR REPLACE ANY AND ALL DAMAGE MADE TO UTILITIES BY THE CONTRACTOR TO PRECONSTRUCTION CONDITION OR BETTER AT THE CONTRACTOR'S EXPENSE.
- 12. DEPTH AND LOCATION OF BURIED DATA AND TELECOMMUNICATIONS CABLES (FIBER OPTICS AND CONVENTIONAL) ARE KNOWN TO VARY DUE TO INSTALLATION TECHNIQUES. CONTRACTOR SHALL COORDINATE ITS WORK WITH CONFLICTING CABLES AS NECESSARY FOR INSTALLATION OF THE PROPOSED WATER AND SEWER. COORDINATION WITH EXISTING UTILITIES SHALL BE INCLUDED IN THE PROJECT SCHEDULE. COORDINATION AND PHASING RELATED TO EXISTING UTILITIES ARE INCLUSIVE TO THE PROJECT AND NO SPECIFIC OR ADDITIONAL PAYMENT SHALL BE MADE.
- 13. THE CONTRACTOR SHALL BE RESPONSIBLE FOR COORDINATING WITH UTILITY PROVIDERS ANY SUPPORT OF EXISTING UTILITY POLES OR OTHER ITEMS AS REQUIRED FOR TRENCH EXCAVATION. ALL COSTS OF SUCH WORK SHALL BE PAID BY THE CONTRACTOR.
- 14. THE CONTRACTOR SHALL VERIFY THE VOLTAGES OF ALL ELECTRICAL UTILITIES AND FOLLOW THE APPROPRIATE OSHA STANDARDS WHEN WORKING IN THEIR VICINITY.
- 15. UNLESS OTHERWISE INDICATED, ALL GRADE ELEVATIONS SHOWN ARE ALONG THE PIPE CENTERLINE.
- 16. UTILITY OWNERS WILL FURNISH DESCRIPTIONS OF EASEMENTS UPON REQUEST.
- 17. ALL PAVEMENT CUTS SHALL BE SAWCUT OR MILLED ALONG A CONTINUOUS STRAIGHT LINE AND REPAVED PER NCDOT REQUIREMENTS AND AS SPECIFIED HEREIN.
- 18. TRAFFIC ISLANDS, CURBS, CONCRETE DRIVEWAYS, AND OTHER CONCRETE SURFACINGS SHALL BE REPLACED TO THE FIRST EXPANSION JOINT BEYOND THE TRENCH EXCAVATION LIMITS AND TO THE FULL WIDTH. ALL CONCRETE WORK SHALL MATCH EXISTING.
- 19. THE CONTRACTOR SHALL FURNISH AND INSTALL ALL SHEETING AND/OR ACTIVE SHORING REQUIRED FOR THE INSTALLATION OF THE UTILITY. ALL EXCAVATIONS SHALL BE KEPT WITHIN THE DESIGNATED EASEMENT WIDTHS. EXCAVATION WITHIN PAVED AREAS SHALL BE KEPT TO A MINIMUM. SHEETING AND/OR ACTIVE SHORING SHALL BE INSTALLED AS REQUIRED TO PROTECT EXISTING UTILITIES.
- 20. PLACED RIP-RAP SHALL HAVE A MINIMUM DEPTH OF 1.5 TIMES THE MAXIMUM STONE DIAMETER AND SHALL HAVE A LAYER OF TYPE II GEOTEXTILE SEPARATOR PLACED BETWEEN THE SOIL AND STONE.
- 21. ALL MATERIAL CLEARED AND GRUBBED BY THE CONTRACTOR IN ORDER TO CONSTRUCT THE WORK, SUCH AS TREES, VEGETATION, ETC., SHALL BECOME THE PROPERTY OF THE CONTRACTOR AND SHALL BE PROPERLY DISPOSED OF OFF-SITE AT A STATE APPROVED DISPOSAL SITE.
- 22. IMMEDIATELY PRIOR TO DISTURBANCE, CONTRACTOR SHALL OBTAIN DIGITALLY RECORDED VIDEO OF THE UTILITY ALIGNMENTS INCLUDING EACH DRIVEWAY, SIDEWALK, SIGN, LANDSCAPING, ETC., TO BE DISTURBED. EACH SHALL BE RESTORED TO ITS ORIGINAL CONDITION OR BETTER. VIDEO SHALL BE SUBMITTED TO THE UTILITY OWNER(S) AND THE ENGINEER PRIOR TO WORK.

- 23. CONTRACTOR SHALL MAINTAIN A MEANS FOR ACCESS TO EACH PROPERTY, RESIDENCE, AND BUSINESS AT ALL TIMES.
- 24. DURING CONSTRUCTION, EMERGENCY VEHICLE APPARATUS ACCESS AND ACCESS TO FIRE HYDRANTS SHALL BE MAINTAINED AT ALL TIMES.
- 25. ALL CONSTRUCTION SHALL BE LIMITED TO STREET RIGHTS-OF-WAY AND OBTAINED EASEMENTS. WHERE THE CONTRACTOR DETERMINES THAT ENCROACHMENT ONTO PRIVATE PROPERTY IS NECESSARY AND AN EASEMENT HAS NOT BEEN PROVIDED, THE CONTRACTOR SHALL CONTACT INDIVIDUAL PROPERTY OWNERS AND OBTAIN WRITTEN APPROVAL FOR THAT ENCROACHMENT. SUCH APPROVALS SHALL BE PROVIDED TO THE UTILITY OWNER, NCDOT, AND THE ENGINEER.
- 26. CONTRACTOR SHALL NOTIFY PROPERTY OWNERS AND TENNANTS AT LEAST 7 DAYS PRIOR TO CONSTRUCTION THAT CONSTRUCTION ACTIVITY WILL TAKE PLACE IN THEIR AREA.
- 27. CONTRACTOR SHALL REMOVE AND REPLACE ALL CONFLICTING MAIL BOXES, CULVERTS, HEADWALLS, ORNAMENTAL STRUCTURES, SIGNS, HARDSCAPING, ETC. WITHIN THE RIGHT OF WAY OR PERMANENT EASEMENT UNLESS OTHERWISE SHOWN ON THE PLANS OR IN THE CONTRACT DOCUMENTS. CONFLICTING TREES WITHIN THE RIGHT OF WAY SHALL BE REMOVED AND NOT REPLANTED.
- 28. THE CONTRACTOR SHALL INSTALL ALL SIGNS AS REQUIRED BY NCDOT ALONG STATE ROADWAYS AND AS REQUIRED BY CITY OF GOLDSBORO ALONG CITY STREETS AND PUBLIC PARKING AREAS.
- 29. LANE AND SHOULDER CLOSURES SHALL BE IN ACCORDANCE WITH NCDOT REQUIREMENTS.
- 30. TRENCHES AND EXCAVATIONS SHALL BE BACKFILLED OR COVERED WITH ROAD PLATES AT THE END OF EACH WORK DAY. OPEN ENDS OF INSTALLED LINE SHALL BE CAPPED WITH A WATERTIGHT CAP DESIGNED FOR THE INTENDED USE.
- 31. CONTRACTOR SHALL PATCH ALL ROADWAY PAVEMENT DISTURBANCES TO RECEIVE TRAFFIC BY THE END OF EACH WEEK. TEMPORARY PATCHES OF COMPACTED AGGREGATE BASE COURSE (ABC) OR COMPACTED ASPHALT MILLINGS SHALL BE PROVIDED DAILY AND MAINTAINED FLUSH WITH ADJACENT PAVEMENT UNTIL PAVEMENT PATCH IS PROVIDED. EROSION CONTROL SHALL BE PROVIDED AS NECESSARY FOR TEMPORARY PATCH AREAS.
- 32. AT THE COMPLETION OF THE WORK, CONTRACTOR SHALL REMOVE FROM THE SITE ALL TOOLS, APPLIANCES, CONSTRUCTION EQUIPMENT AND MACHINERY, SURPLUS MATERIALS, AND DEBRIS AND SHALL RESTORE TO ORIGINAL CONDITION OR BETTER ALL PROPERTY NOT DESIGNATED FOR ALTERATION BY THE CONTRACT DOCUMENTS.
- 33. CONTRACTOR SHALL PROVIDE AS-BUILT DRAWINGS FOR ALL UTILITY CONSTRUCTION PRIOR TO PLACING THE PIPELINE(S) IN SERVICE.

UTILITY NOTES:

- 1. UTILITY SEPARATION REQUIREMENTS:
- A. DISTANCE OF 100' SHALL BE MAINTAINED BETWEEN SANITARY SEWER & ANY PRIVATE OR PUBLIC WATER SUPPLY SOURCE SUCH AS AN IMPOUNDED RESERVOIR USED AS A SOURCE OF DRINKING WATER. IF ADEQUATE LATERAL SEPARATION CANNOT BE ACHIEVED, FERROUS SANITARY SEWER PIPE SHALL BE SPECIFIED & INSTALLED TO WATERLINE SPECIFICATIONS. HOWEVER, THE MINIMUM SEPARATION SHALL NOT BE LESS THAN 25' FROM A PRIVATE WELL OR 50' FROM A PUBLIC WELL.
- B. WHEN INSTALLING WATER &/OR SEWER MAINS, THE HORIZONTAL SEPARATION BETWEEN UTILITIES SHALL BE 10'. IF THIS SEPARATION CANNOT BE MAINTAINED DUE TO EXISTING CONDITIONS, THE VARIATION ALLOWED IS THE WATER MAIN IN A SEPARATE TRENCH WITH THE ELEVATION OF THE WATER MAIN AT LEAST 18" ABOVE THE TOP OF THE SEWER & MUST BE APPROVED BY THE OWNER. ALL DISTANCES ARE MEASURED FROM OUTSIDE DIAMETER TO OUTSIDE DIAMETER.
- C. WHERE IT IS IMPOSSIBLE TO OBTAIN PROPER SEPARATION, OR ANYTIME A SANITARY SEWER PASSES OVER A WATERMAIN, DIP MATERIALS OR STEEL ENCASEMENT EXTENDED 10' ON EACH SIDE OF CROSSING MUST BE SPECIFIED & INSTALLED TO WATERLINE SPECIFICATIONS.
- D. 5.0' MINIMUM HORIZONTAL SEPARATION IS REQUIRED BETWEEN ALL SANITARY SEWER & STORM SEWER FACILITIES. UNLESS DIP MATERIAL IS SPECIFIED FOR SANITARY SEWER.
- E. MAINTAIN 18" MIN. VERTICAL SEPARATION AT ALL WATERMAIN & RCP STORM DRAIN CROSSINGS; MAINTAIN 18" MIN. VERTICAL SEPARATION AT ALL SANITARY SEWER & RCP STORM DRAIN CROSSINGS. WHERE ADEQUATE SEPARATIONS CANNOT BE ACHIEVED, DIP MATERIALS & A CONCRETE CRADLE IN ACCORDANCE WITH DETAIL 6/UC-3A SHALL BE INSTALLED.
- F. ALL OTHER UNDERGROUND UTILITIES SHALL CROSS WATER & SEWER FACILITIES WITH 18" MIN. VERTICAL SEPARATION REQUIRED.
- 2. MINIMUM PIPE COVER FOR DISTRIBUTION WATER MAINS SHALL BE 4 FEET AND TRANSMISSION WATER MAINS SHALL BE 5 FEET, UNLESS DUCTILE IRON PIPE IS USED AND LESS COVER IS SPECIFICALLY SHOWN ON DRAWINGS OR AS APPROVED BY THE UTILITY OWNER OR ENGINEER.
- 3. TRENCHES SHALL BE IN STRICT ACCORDANCE WITH DETAIL 5/UC-3D. UNLESS OTHERWISE SPECIFIED BEDDING AND BACKFILL SHALL BE IN STRICT ACCORDANCE WITH BEDDING TYPE B (SEE DETAIL 2/UC-3D).
- 4. CONTRACTOR SHALL MAINTAIN CONTINUOUS WATER & SEWER SERVICE TO EXISTING CUSTOMERS THROUGHOUT CONSTRUCTION OF PROJECT. ANY NECESSARY SERVICE INTERRUPTIONS SHALL BE COORDINATION WITH AND TAKE PLACE AT A TIME AND DATE ACCEPTABLE TO THE UTILITY OWNER. A 72 HOUR ADVANCE NOTICE SHALL BE PROVIDED TO AFFECTED CUSTOMERS.
- 5. ALL WATERLINE FOR THIS PROJECT SHALL BE MATERIAL AND SIZE AS NOTED ON THE PROFILE DRAWINGS.
- 6. ALL PRESSURIZED FITTINGS SHALL BE DUCTILE IRON RESTRAINED MECHANICAL JOINT WITH PRESSURE RATING EQUAL TO OR HIGHER THAN HOST PIPE, UNLESS OTHERWISE SHOWN ON THE DRAWINGS.
- 7. ALL MECHANICAL JOINTS SHALL BE FITTED WITH WEDGE-TYPE MECHANICAL RESTRAINT ACCESSORY KITS DESIGNED FOR THE INTENDED USE AND MATERIAL, AS APPROVED BY UTILITY OWNER. RESTRAINED JOINT PIPING SHALL BE INSTALLED TO THE NEXT FULL JOINT BEYOND THE STATIONS SHOWN ON THE PROFILE DRAWINGS AT MINIMUM.



PROJECT REFERENCE NO.

U-5724

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SHEET NO.

UC-3


- 8. PIPE ALIGNMENT SHOWN IS BASED ON STANDARD DUCTILE IRON MECHANICAL JOINT FITTINGS. JOINT DEFLECTIONS SHALL NOT EXCEED 75 PERCENT OF MANUFACTURER'S RECOMMENDED DEFLECTION. CONTRACTOR SHALL ADJUST PIPELINE ALIGNMENT AND DEFLECT JOINTS AS NECESSARY TO ACCOMMODATE THE STANDARD BENDS SHOWN.
- 9. DETECTABLE WARNING TAPE AND TRACER WIRE IS REQUIRED FOR ALL BURIED PIPE AND SHALL BEAR THE APPROPRIATE AWPA COLORING AND TEXT FOR THE APPLICABLE UTILITY. INSULATED 14GA TRACER WIRE SHALL BE INSTALLED ALONG ALL PIPELINES AND SHALL BE ACCESSIBLE FROM THE FINISHED GRADE WITHIN ALL VALVE BOXES, MANHOLES, AND OTHER END POINTS OF TRACER WIRE. SPLICES IN TRACER WIRE SHALL BE MADE WITH SPLICE CONNECTORS DESIGNED FOR THE INTENDED PURPOSE AND IN ACCORDANCE WITH TRACER WIRE MANUFACTURER'S RECOMMENDATIONS.
- 10. ALL MANHOLE COVERS AND VALVE BOX LIDS FOR WATER SHALL READ "WATER", ALL MANHOLE COVERS AND VALVE BOX LIDS FOR SEWER SHALL READ "SEWER", AND ALL SHALL BE IN ACCORDANCE WITH NCDOT AND APPLICABLE UTILITY OWNER STANDARDS AND DETAILS.
- 11. CONTRACTOR SHALL VERIFY ALL DIMENSIONS AND CONDITIONS IN THE FIELD PRIOR TO FABRICATION AND ERECTION OF ANY MATERIAL. ANY UNUSUAL CONDITIONS SHALL BE REPORTED TO THE ATTENTION OF THE OWNER(S) AND ENGINEER.
- 12. EXISTING WATER SERVICES SHALL REMAIN IN SERVICE AT ALL TIMES UNTIL THE PROPOSED MAIN IS TESTED AND PHASED INTO SERVICE.


ASBESTOS CEMENT PIPE NOTES:


- 1. CONTRACTOR SHALL FOLLOW ALL FEDERAL, STATE, AND LOCAL RULES AND REGULATIONS FOR SAFELY CUTTING, DEMOLISHING, AND DISPOSING OF ASBESTOS CEMENT PIPE.
- 2. CONTRACTOR SHALL TAKE ANY PRECAUTIONS NECESSARY TO AVOID EXPOSING WORKERS OR THE PUBLIC TO ASBESTOS FIBERS.
- 3. CONTRACTOR SHALL OBTAIN ALL PERMITS NECESSARY FOR CUTTING, DEMOLISHING, OR DISPOSING OF ASBESTOS CEMENT PIPE.
- 4. CONTRACTOR SHALL FOLLOW ALL NORTH CAROLINA DEPARTMENT OF HEALTH AND HUMAN SERVICES REQUIREMENTS DURING CONSTRUCTION.
- 5. CONTRACTOR SHALL FOLLOW ALL OSHA ASBESTOS REQUIREMENTS DURING CONSTRUCTION.
- 6. ALL ASBESTOS PIPE DISPOSAL SHALL CONFORM WITH ALL FEDERAL AND STATE REQUIREMENTS.
- 7. ASBESTOS PIPE ABANDONED IN PLACE SHALL BE FILLED WITH FLOWABLE FILL.


GENERAL SEQUENCE:

- 1. FOR EACH WATER LINE AND SEWER LINE RELOCATION, THE CONTRACTOR SHALL PROVIDE THE UTILITY OWNER WITH A DETAILED INSTALLATION, CONNECTION, AND SERVICE INTERRUPRTION PLAN FOR APPROVAL AT LEAST SEVEN (7) DAYS PRIOR TO THE RELOCATION. AT A MINIMUM, EACH PLAN SHALL ADDRESS THE FOLLOWING:
 - A. SEQUENCE OF CONSTRUCTION OPERATIONS.
- B. PROCEDURE FOR FLUSHING, TESTING, AND DISINFECTION OF ALL AFFECTED PIPING AND VALVES. AS REQUIRED BY THE UTILITY OWNER.
- C. PHASING AND SCHEDULE FOR ALL CONNECTIONS, INCLUDING PLANNED SERVICE OUTAGES, DURATION, AND CONTINGENCY PLAN.
- 2. NO INTERRUPTION OF SERVICE WILL BE PERMITTED UNTIL THE FOREGOING PLAN HAS BEEN APPROVED BY THE UTILITY OWNER. THE UTILITY OWNER'S PERSONNEL SHALL OPERATE THE UTILITY OWNER'S EXISTING FACITLITIES INVOLVED IN THE INTERRUPTIONS OF SERVICE.
- 3. PLANNED SERVICE CONNECTION INTERRUPTIONS SHALL LAST NO LONGER THAN 8 HOURS UNLESS OTHERWISE APPROVED BY THE UTILITY OWNER. ALL INTERRUPTIONS OF SERVICES SHALL BE COORDINATED WITH AND SCHEDULED AT TIMES ACCEPTABLE TO THE UTILITY OWNER.
- 4. WRITTEN WATER SERVICE INTERRUPTION NOTICES SHALL BE PROVIDED TO ALL AFFECTED CUSTOMERS AT LEAST 72 HOURS PRIOR TO EACH PLANNED INTERRUPTION.

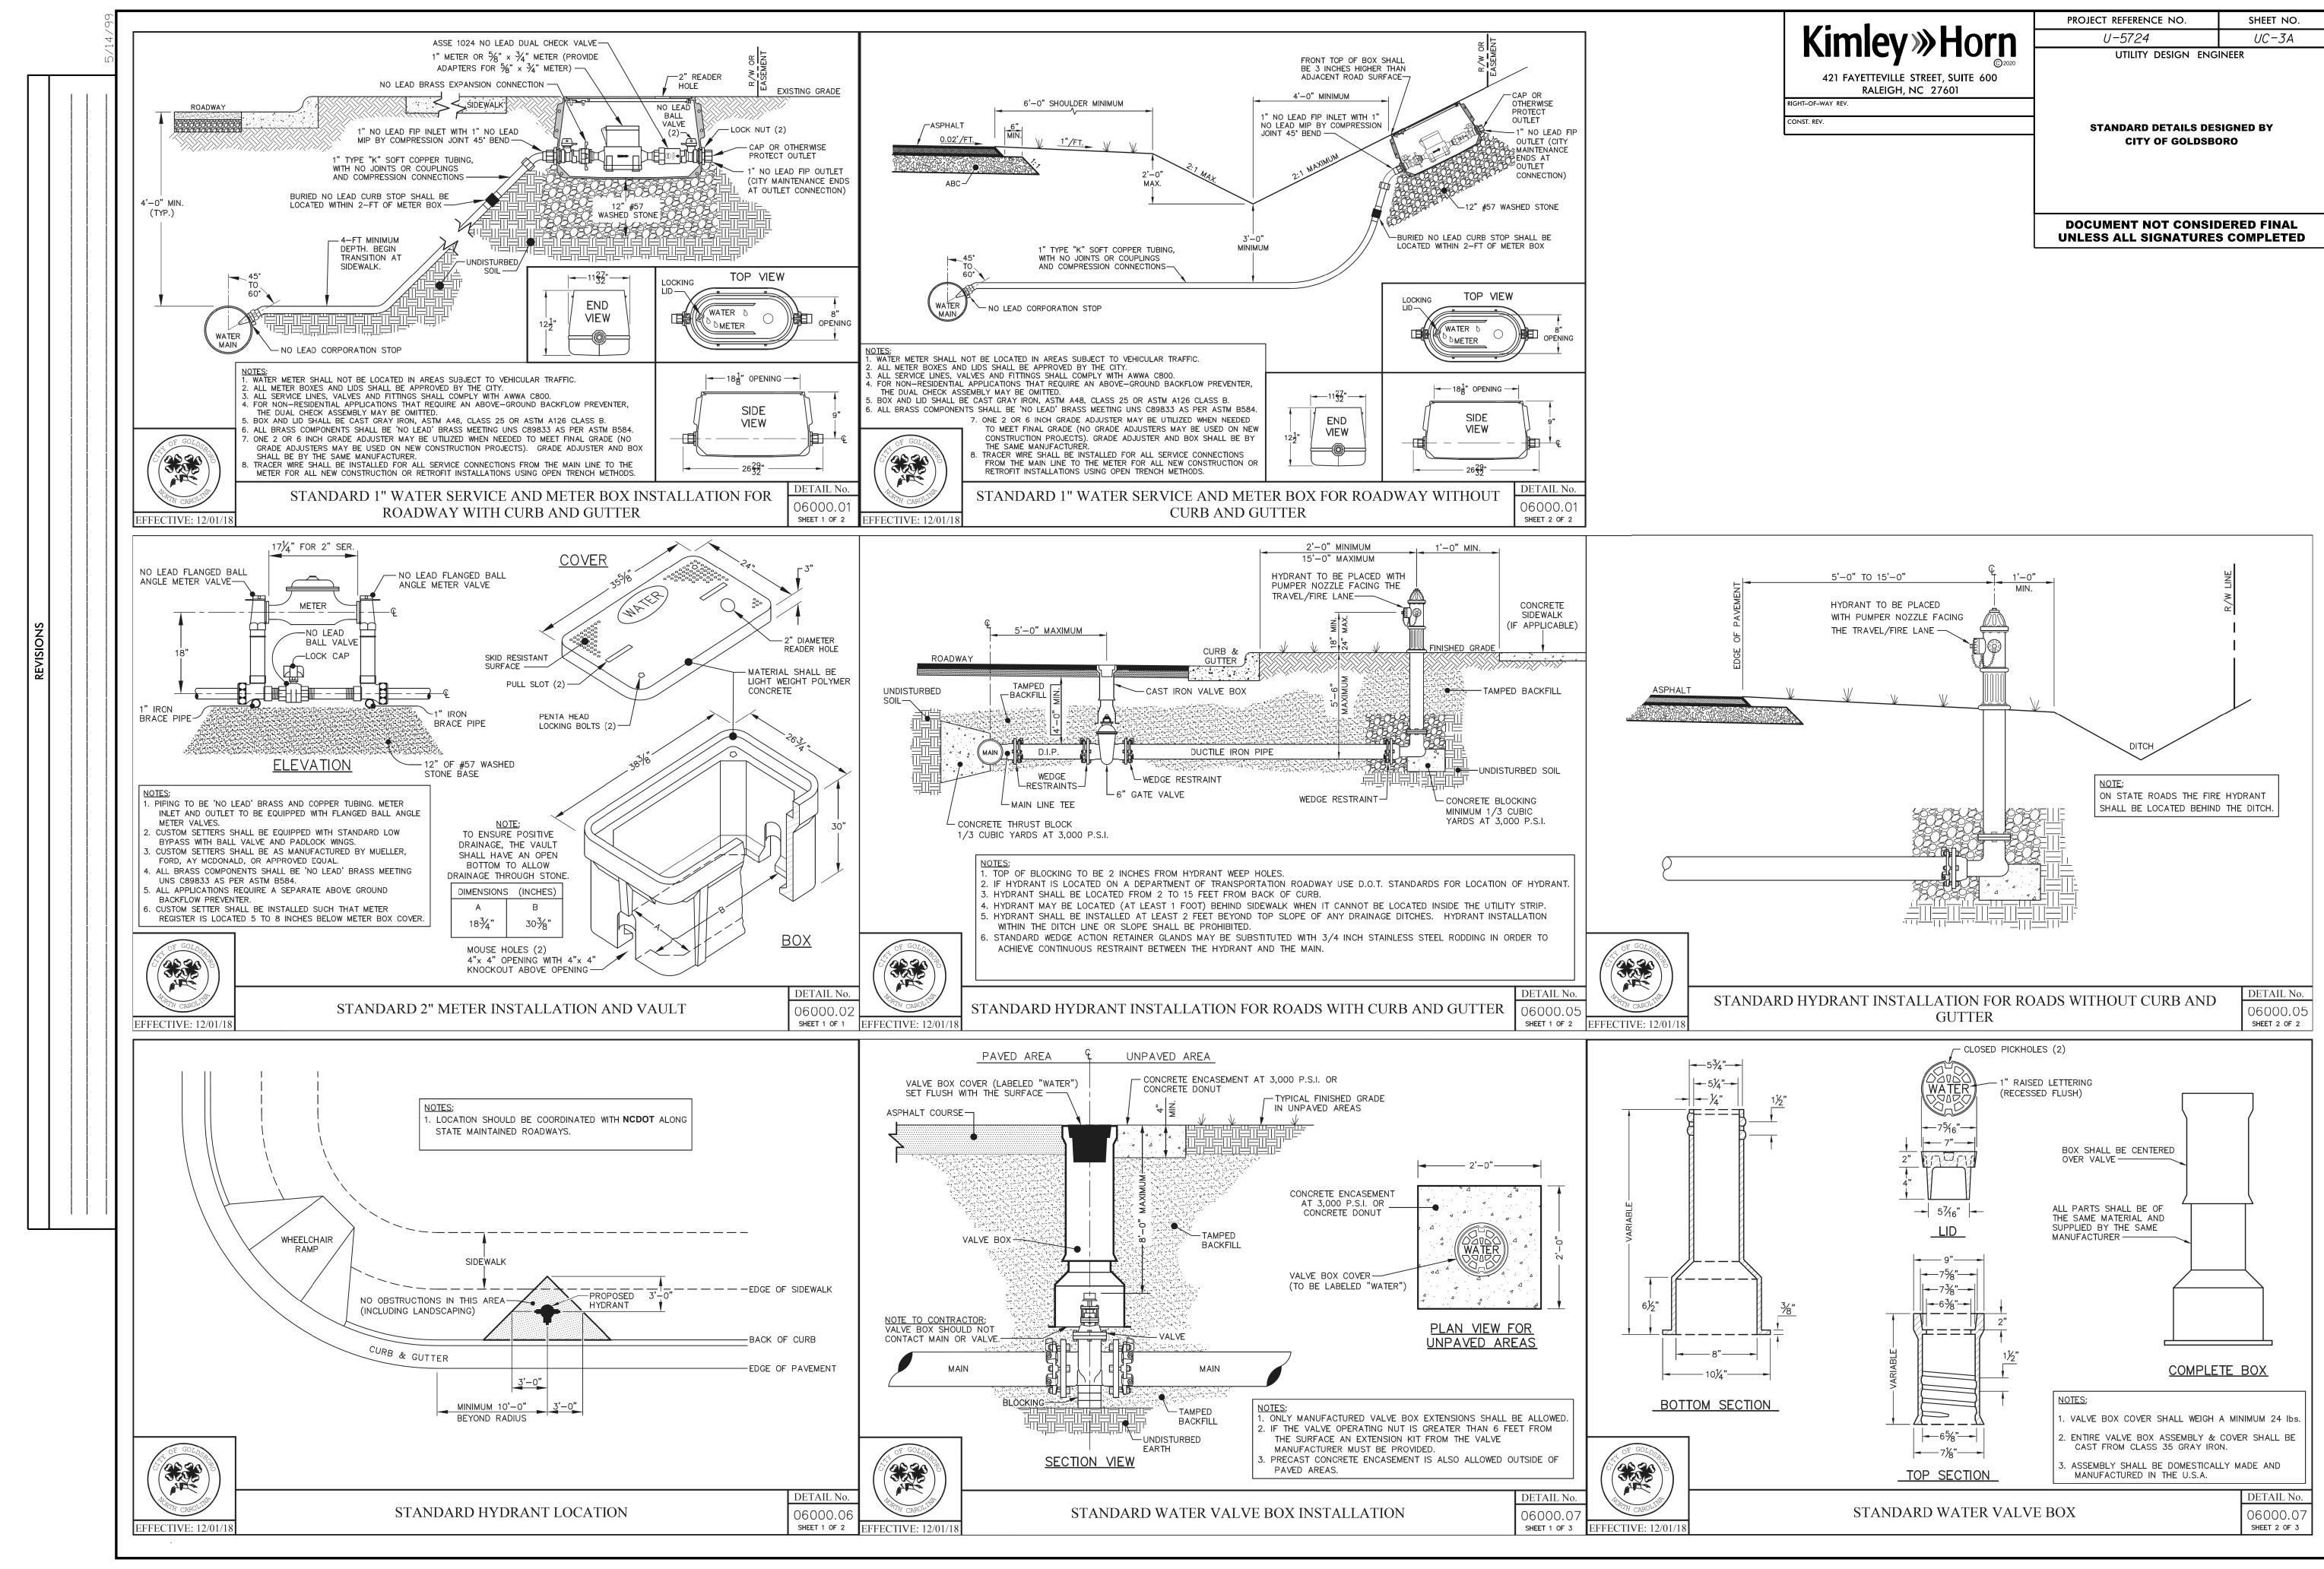

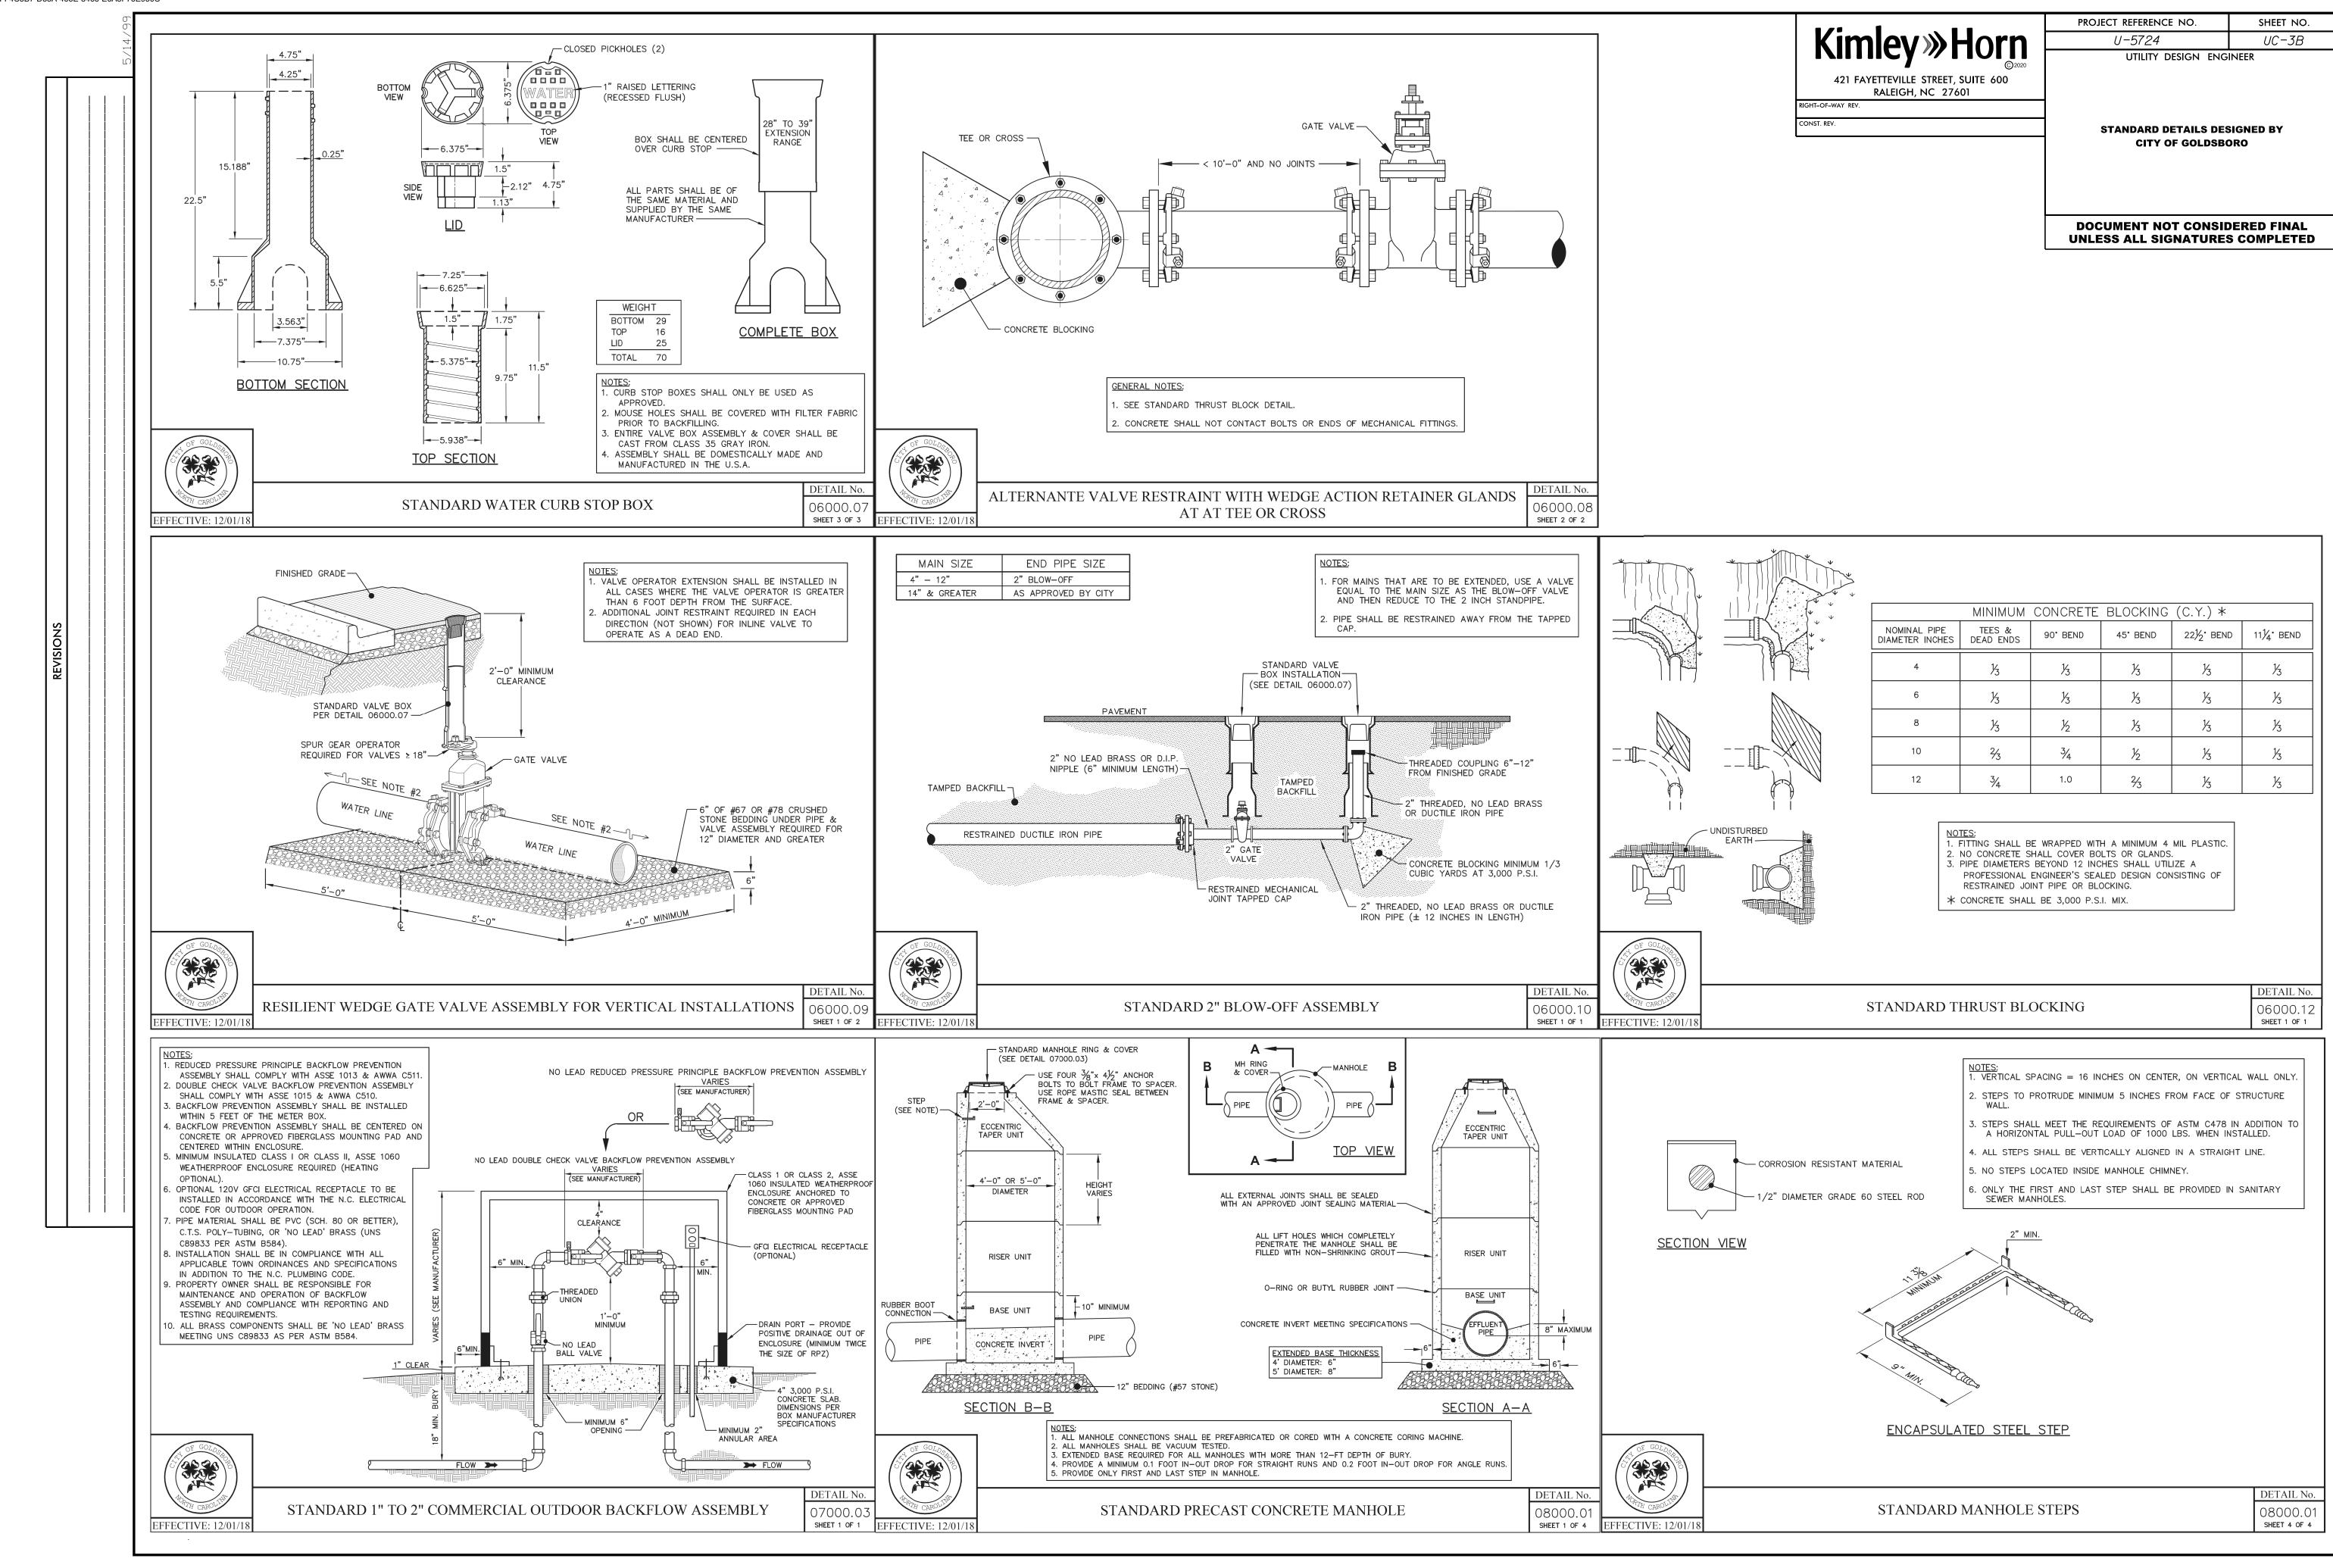

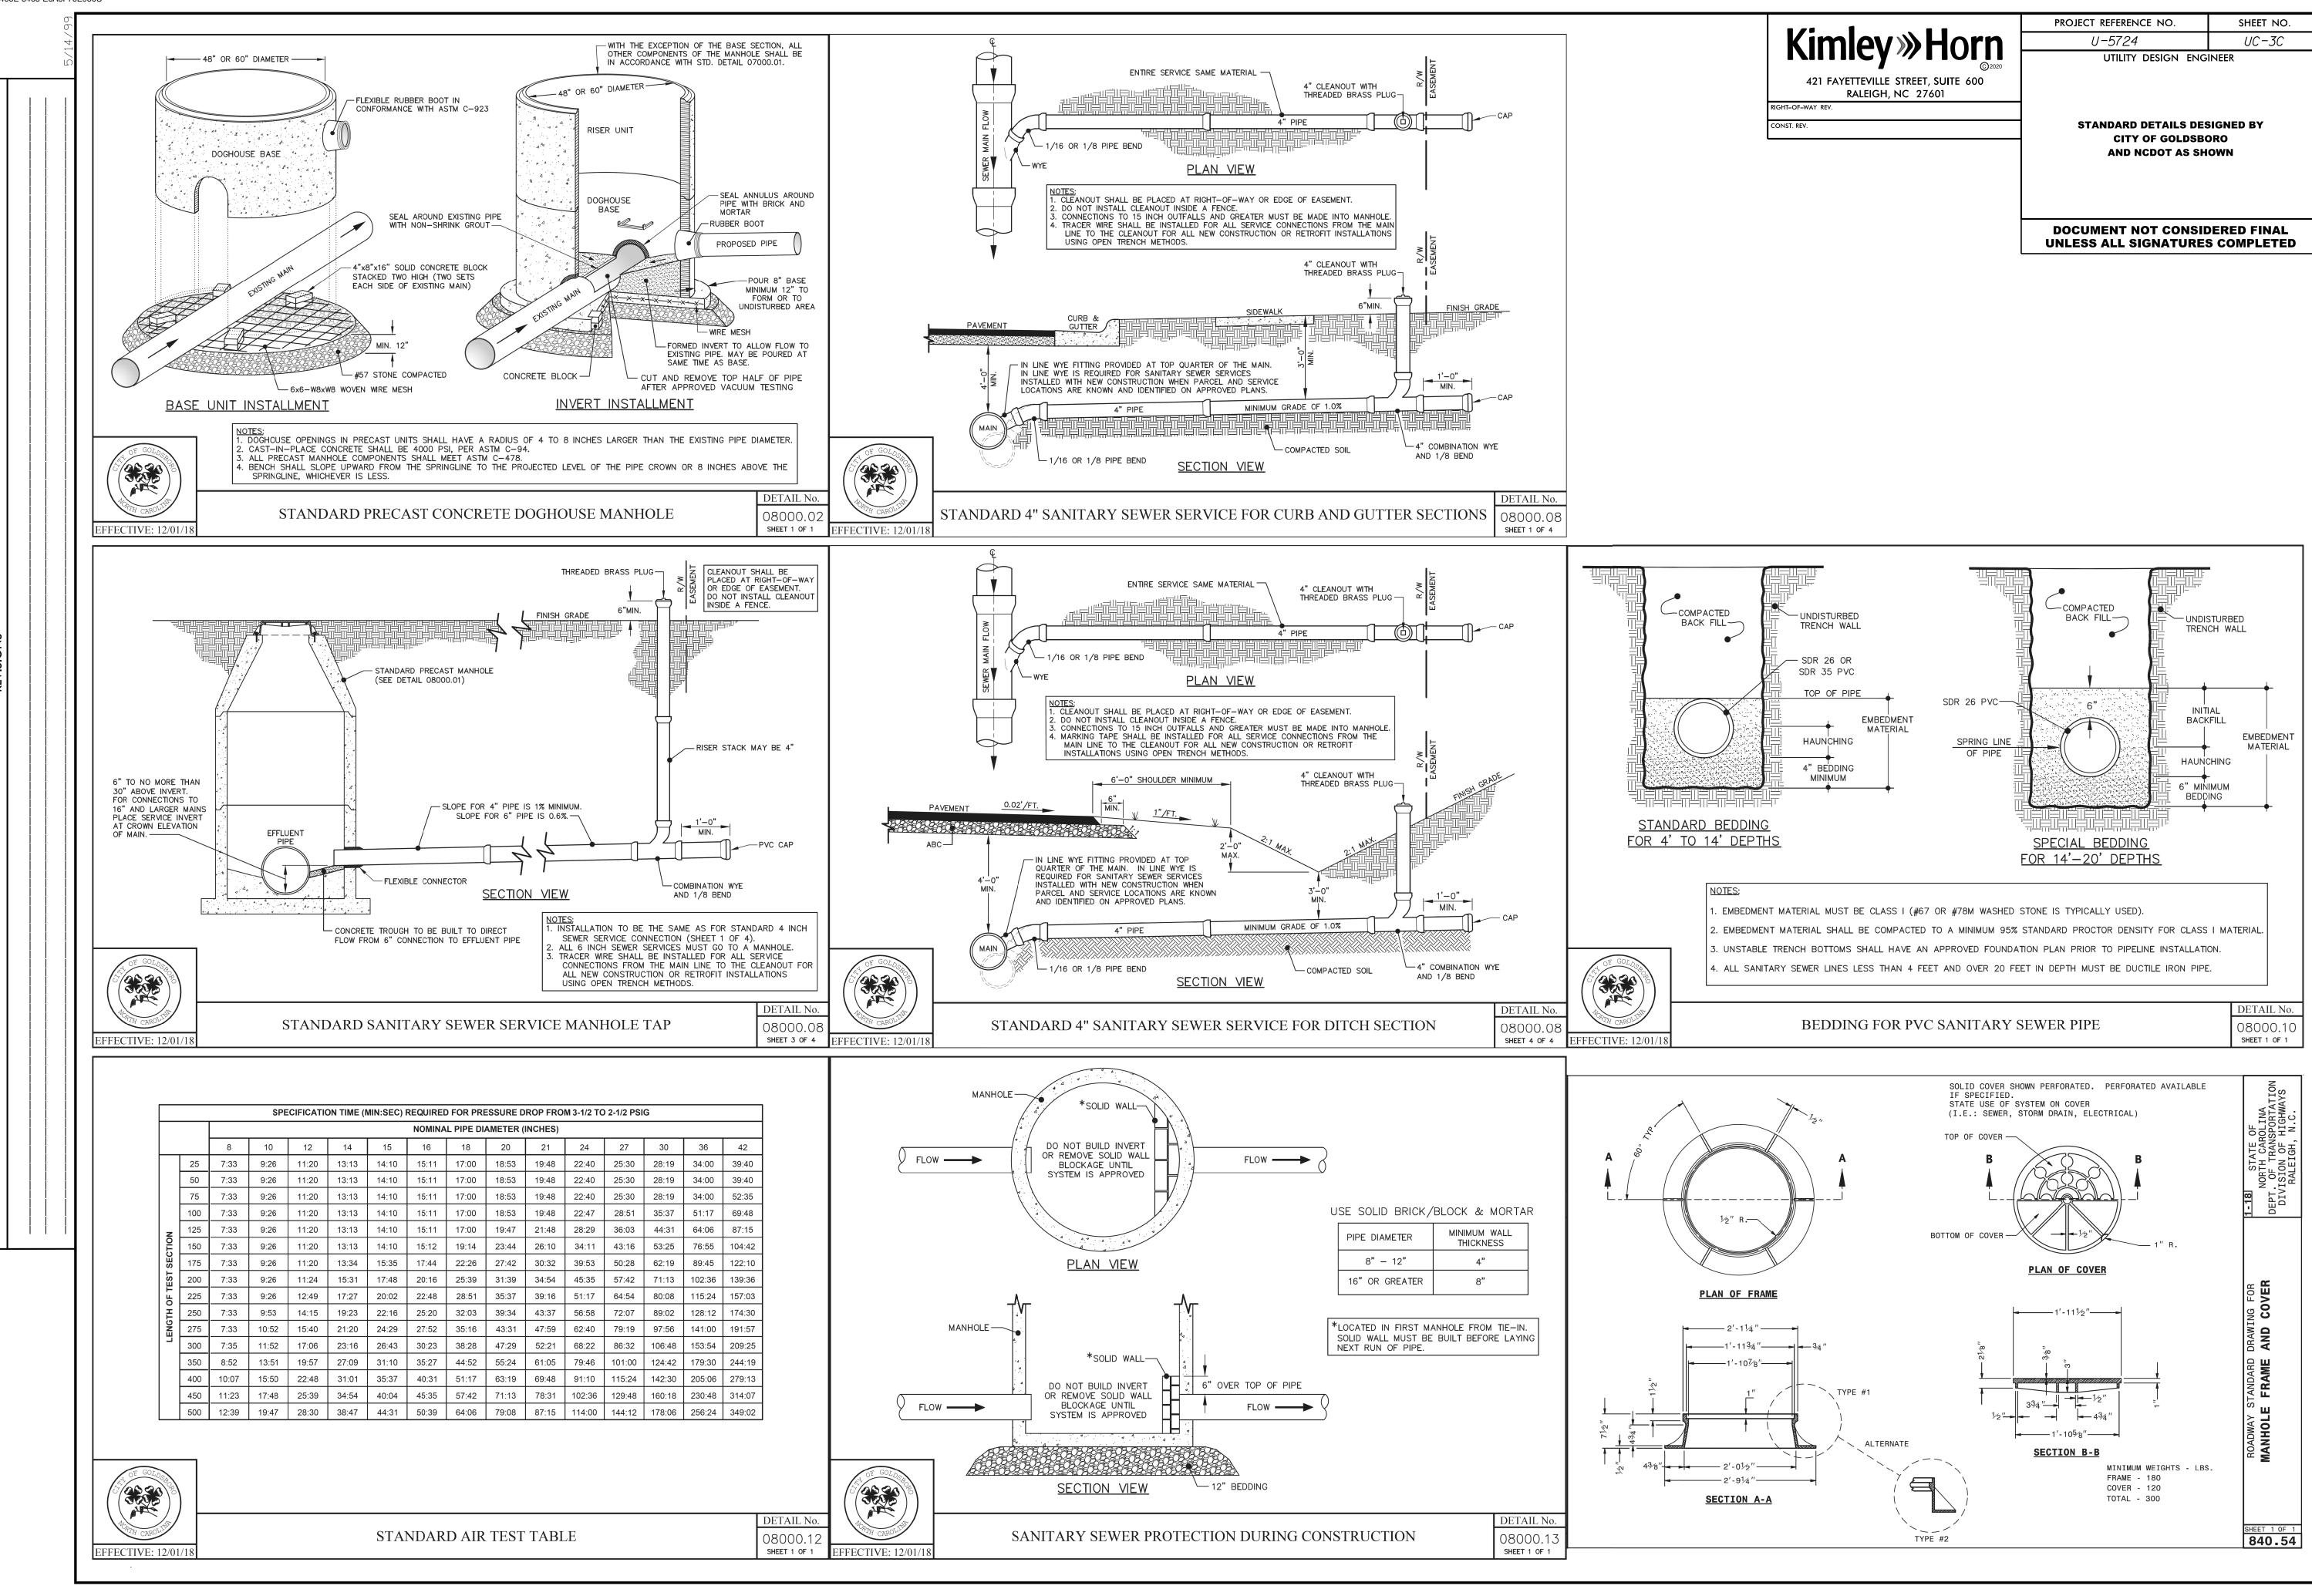


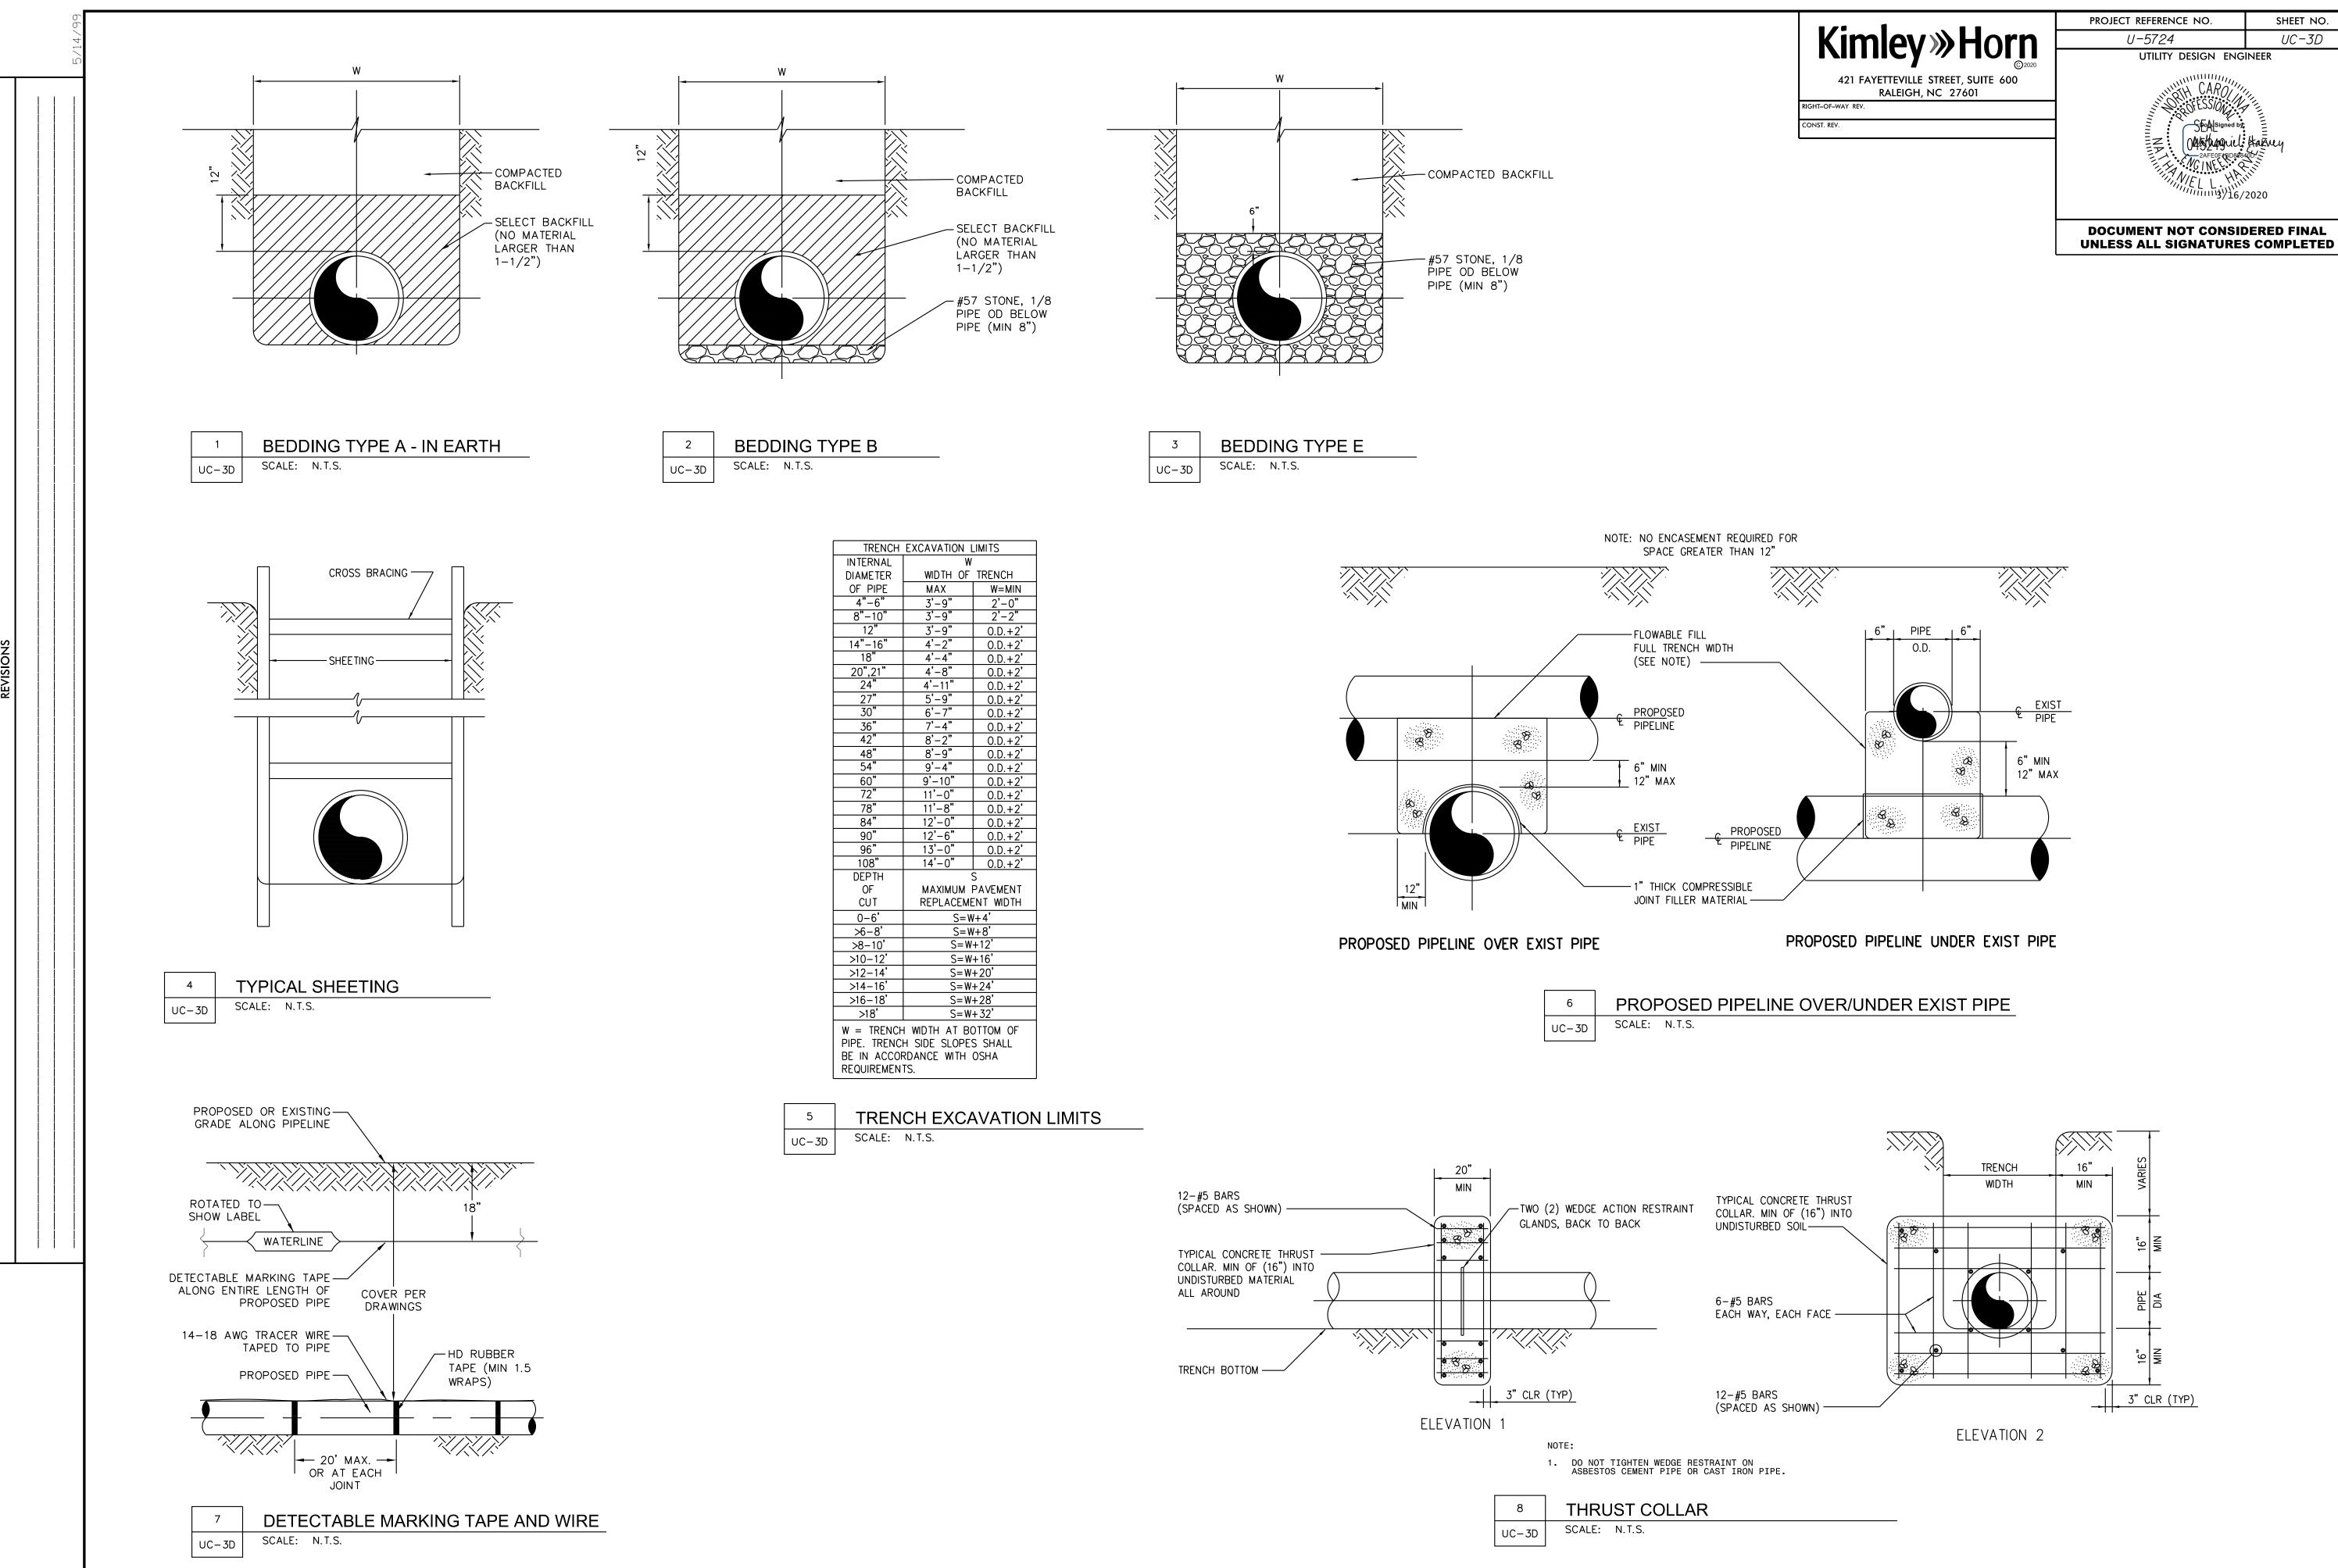

	DESIGN P	RESSURE
	200	PSI
PIPE SIZE	DOD DIA	NUMBER
PIPE SIZE	SIZE ROD DIA	REQ'D
4" TO 8"	3/4"	2
10" TO 20"	3/4"	4
24"	3/4"	6
30 "	1"	6
36"	1"	8

- 1. THREADED RODS FOR PIPE DIAMETERS LARGER THAN 12" SHALL BE ASTM A193 (GRADE B7). ALL OTHER THREADED RODS SHALL BE ASTM A36.
- 2 ALL HARDWARE IN CONTACT WITH SOIL SHALL BE PAINTED WITH TWO COATS HIGH BUILD COAL TAR EPOXY (MIN 26 MIL DRY FILM THICKNESS)
- 5. RODS SHALL BE EQUALLY SPACED AROUND PIPE.

1	THRE	EADED ROD SCHEDULE
UC-3E	SCALE:	N.T.S.

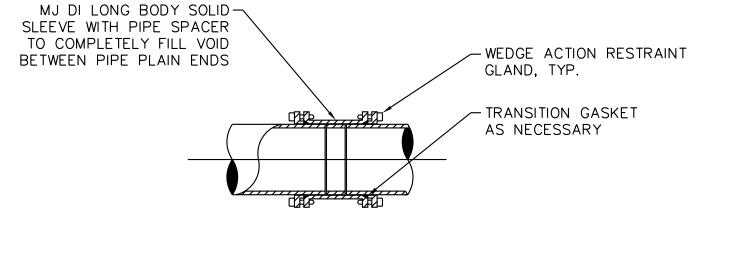



PROJECT REFERENCE NO. 421 FAYETTEVILLE STREET, SUITE 600 RALEIGH, NC 27601


UTILITY DESIGN ENGINEER

U-5724

SHEET NO.

UC-3E

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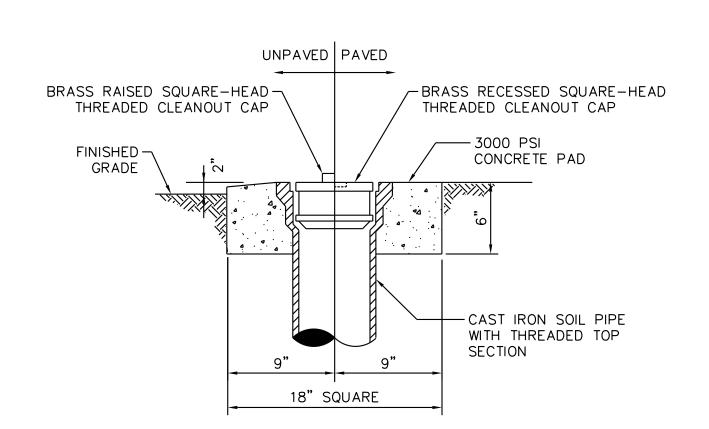
1. ONCE INSTALLED AND TIGHT, THE STEEL RODS AND BOLTS SHALL BE COATED WITH 2 COATS OF BITUMINOUS BASE PAINT. 2. CONCRETE SHALL NOT CONTACT BOLTS OR ENDS OF MECHANICAL JOINT

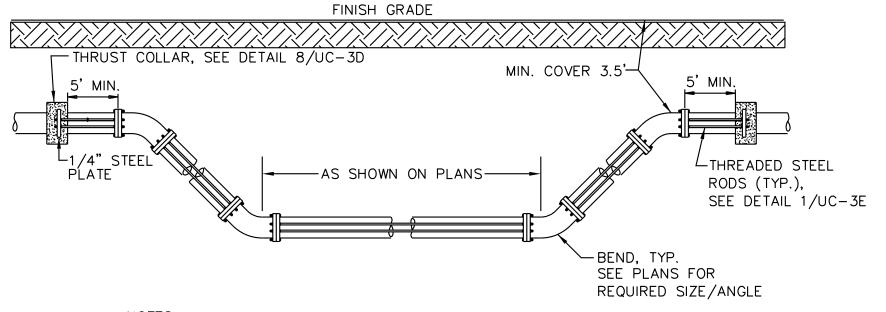3. MEGALUGS OR RESTRAINED JOINT PIPE AND FITTINGS ARE ALLOWED IN LIEU


4. THRUST COLLARS SHALL BE IN ACCORDANCE WITH DETAIL 8/UC-3D 5. ALL PIPE AND FITTINGS BETWEEN THRUST COLLARS SHALL BE RODDED.


NOT TO SCALE

3	STANDARD VERTICAL BEND
UC-3E	SCALE: N.T.S.



SANITARY SEWER CLEANOUT TOP SCALE: N.T.S. UC-3E

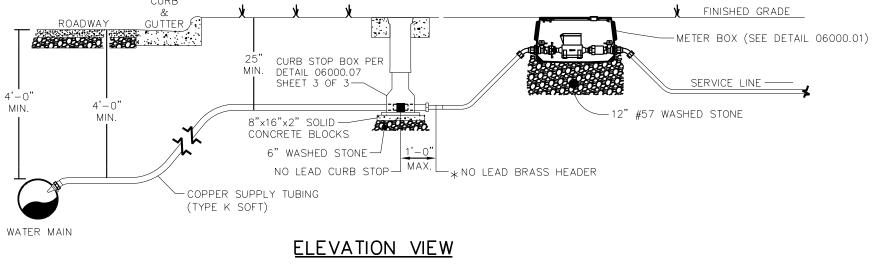

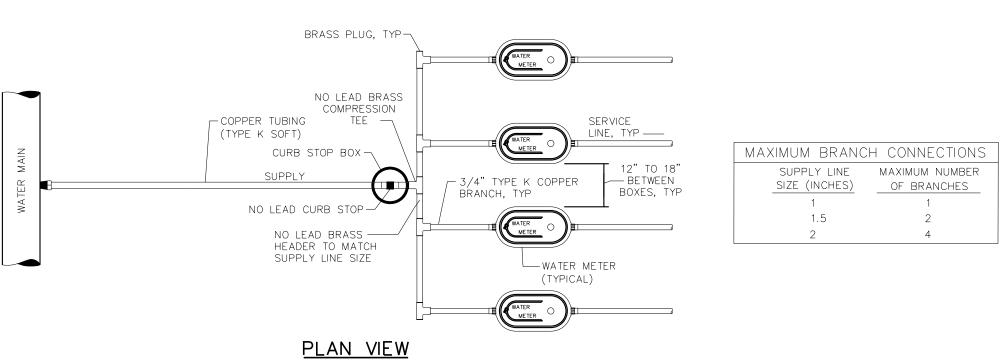

1. THERE SHALL BE NO MULTIPLE CONNECTIONS FROM EXISTING 3/4 INCH SERVICE 2. METER BOXES SHALL NOT BE LOCATED IN AREAS SUBJECT TO VEHICULAR TRAFFIC.

3. NO LEAD CURB STOP SHALL BE CENTERED ON MULTIPLE BRANCH SERVICE. 4. ALL BRASS COMPONENTS SHALL BE 'NO LEAD' BRASS MEETING UNS C89833 AS PER ASTM B584.

MULTI-GANG METER ASSEMBLY SCALE: N.T.S. UC-3E

DETAÌL´3/UC-3E

