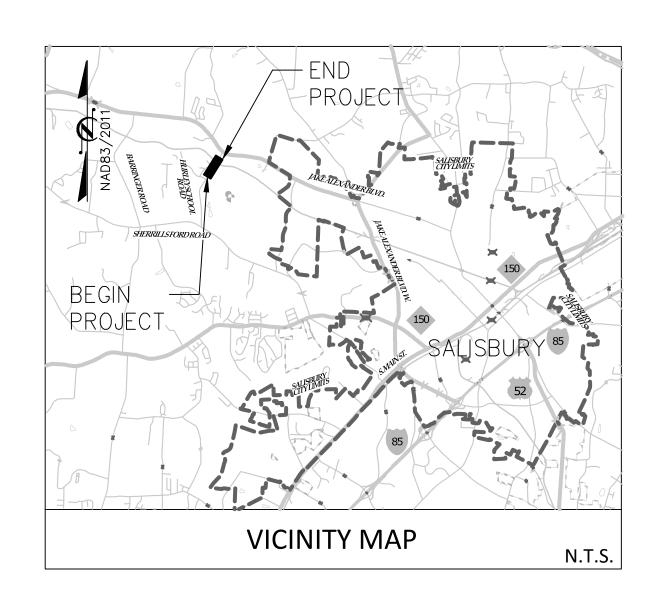
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STATE OF NORTH CAROLINA DIVISION OF HIGHWAYS

UTILITY CONSTRUCTION PLANS ROWAN COUNTY


T.I.P. NO.

B-5772

SHEET NO.

UC-1

LOCATION: HURLEY SCHOOL ROAD IN SALISBURY TYPE OF WORK: UTILITY CONSTRUCTION

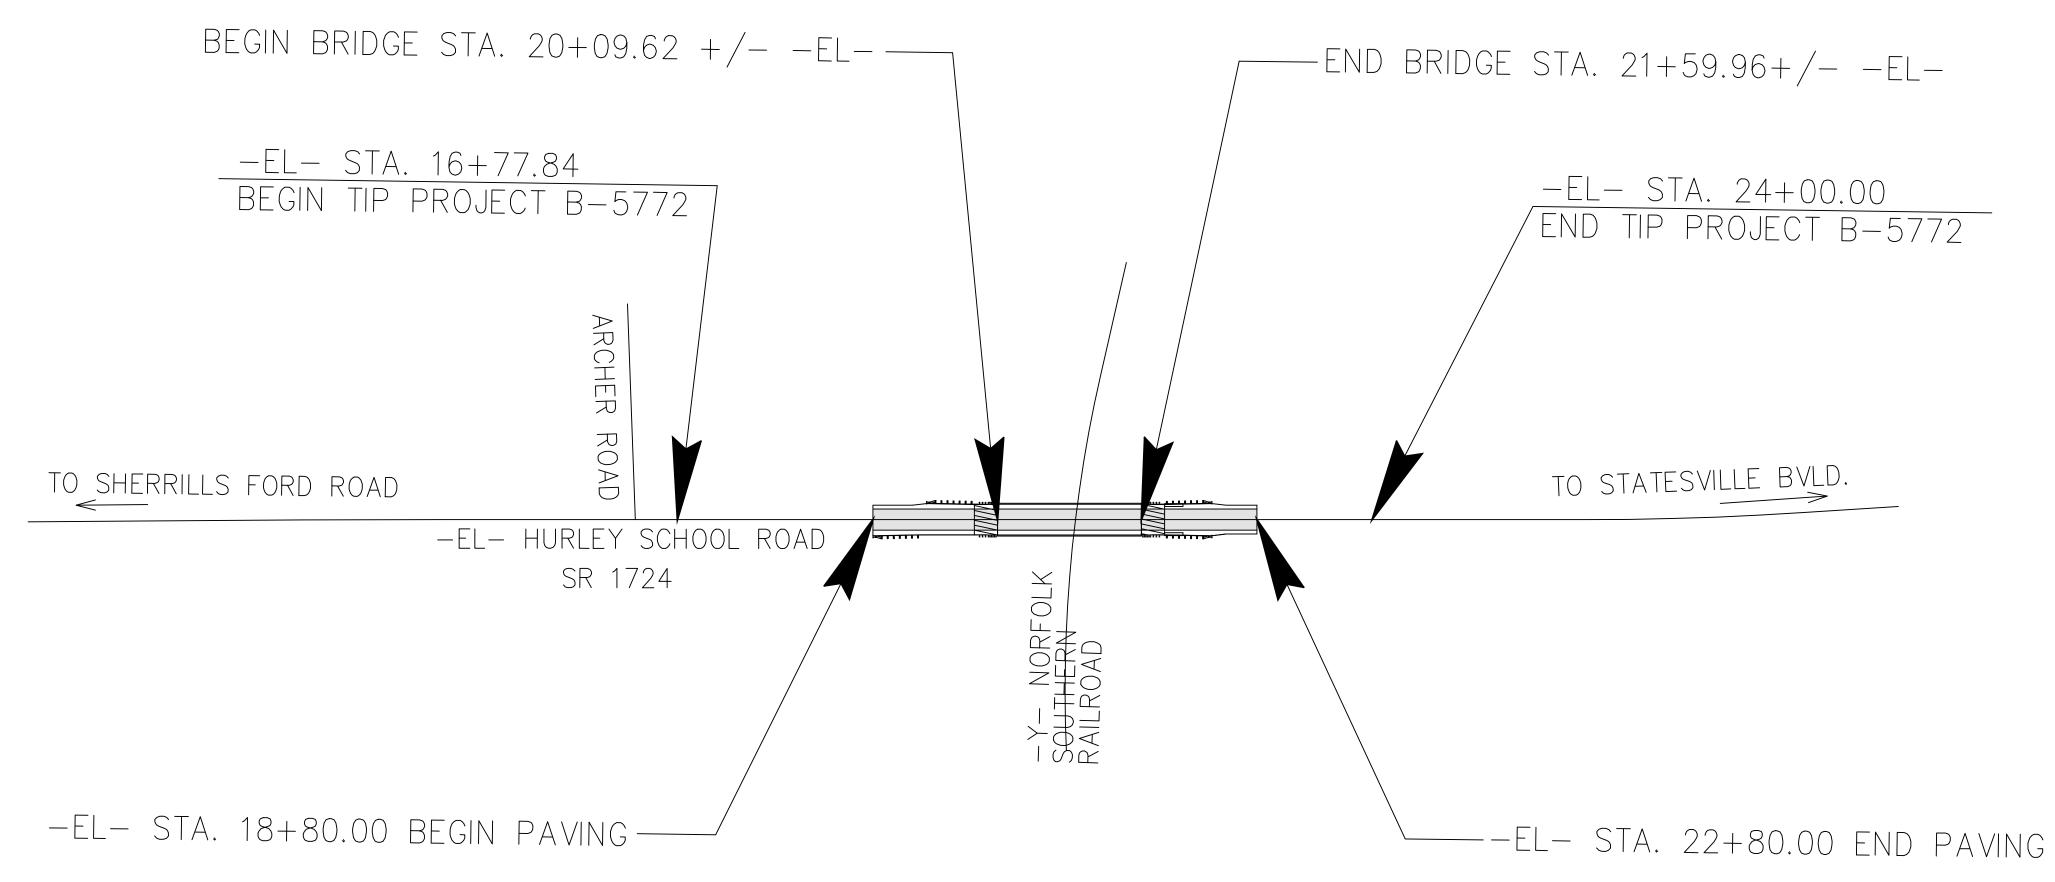

CLEARING ON THIS PROJECT SHALL BE PERFORMED TO THE LIMITS ESTABLISHED BY METHOD III.

THIS PROJECT IS NOT WITHIN ANY MUNICIPAL BOUNDARIES.

INDEX OF SHEETS

GRAPHIC SCALES

SHEET NO.

TITLE SHEET UTILITY SYMBOLOGY SHEET NOTES SHEET UC-3A THRU UC-3H DETAIL SHEETS UC-4 THRU UC-4A TEMP. UTILITY PLAN & PROFILE SHEETS UC-5 THRU UC-5A PERM. UTILITY PLAN & PROFILE SHEETS UC-6A THRU UC-6C TEMP. WATERLINE SUPPORT BRIDGE SHEETS

DESCRIPTION

WATER AND SEWER OWNERS ON PROJECT

(1) WATER - SALISBURY-ROWAN UTILITIES (SRU)


Jason Wilson, PE Assistant Utilities Director (704) 216-7553



alley, williams, carmen, & king, inc. CONSULTING ENGINEERS 120 SOUTH MAIN STREET KANNAPOLIS, NC 28082 P.O. BOX 1248 704/938-1515

PREPARED IN THE OFFICE OF:

Jeffery D. Moody, PE UTILITIES PROJECT ENGINEER

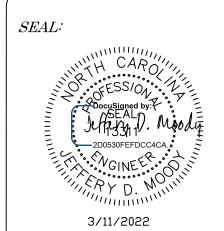

DOCUMENT NOT CONSIDERED FINAL UNLESS ALL SIGNATURES COMPLETED



DIVISION OF HIGHWAYS UTILITIES UNIT 1555 MAIL SERVICE CENTER RALEIGH NC 27699-1555 PHONE (919) 707-6690

FAX (919) 250-4151

Amy York CENTRAL UTILITIES MANAGER Ali Koucheki, PE REGIONAL UTILITIES ENGINEER Jon Loughry SENIOR UTILITIES ENGINEER Dayton Martin REGIONAL UTILITY COORDINATOR UTILITY COORDINATOR Tanga Sampson

CT REFERENCE NO.	SHEET NO.
R-5772	110-2

UTILITIES PLAN SHEET SYMBOLS

POWER POLE

TELEPHONE POLE

POWER POLE TO BE REMOVED.....

TELEPHONE POLE TO BE REMOVED

JOINT USE POLE TO BE REMOVED

UTILITY POLE

UTILITY POLE TO BE REMOVED

UTILITY POLE WITH BASE

POWER MANHOLE

TELEPHONE MANHOLE ①

POWER TRANSFORMER

TELEPHONE PEDESTAL I

TELEPHONE BOOTH

TRAFFIC SIGNAL BOX S

CATV PEDESTAL

LOCATED MISCELLANEOUS UTILITY OBJECT O

SANITARY SEWER MANHOLE

HAND HOLE

JOINT USE POLE

WATER MANHOLE

PROPOSED WATER AND SEWER SYMBOLS

WATER LINE 11 1/4 DEGREE BEND..... 22 1/2 DEGREE BEND..... 45 DEGREE BEND... 90 DEGREE BEND. PLUG ... CROSS ... REDUCER . GATE VALVE BUTTERFLY VALVE TAPPING VALVE BLOW OFF FIRE HYDRANT RELOCATE FIRE HYDRANT WATER METER . RELOCATE WATER METER: REMOVE WATER METER ABANDON UTILITY MANHOLE ABANDON WATER VALVE GRAVITY SEWER LINE MANHOLE . SANITARY SEWER CLEANDUT....

PROPOSED MISCELLANEOUS UTILITIES SYMBOLS

THRUST BLOCK	
PLAN NOTE	NOTE
ENCASEMENT	18" ENCASEMENT
TO BE ABANDONED	(TBA)

EXISTING UTILITIES SYMBOLS

ABANDONED ACCORDING TO UTILITY RECORDS	AATUR
END OF INFORMATION	E.O.I.
UNDERGROUND POWER LINE	UG UG UG UG UG UG
UNDERGROUND POWER SUE······	UG UG UG UG UG UG
ABOVEGROUND POWER LINE	— us—— us—— us—— us—— us——
UNDERGROUND TELEPHONE CABLE	UT UT UT UT UT UT
UNDERGROUND TELEPHONE CONDUIT	
UNDERGROUND TELEPHONE SUE	
UNDERGROUND FIBER OPTICS TELEPHONE CABLE	
UNDERGROUND TV CABLE	UT UT UT UT UT UT
UNDERGROUND GAS PIPELINE	
UNDERGROUND GAS PIPELINE SUE	
UNDERGROUND WATER LINE	vvvvvv
UNDERGROUND WATER LINE SUE	vvvvvv
UNDERGROUND GRAVITY SANITARY SEWER LINE	s s s s s s s
UNDERGROUND SS FORCED MAIN LINE	z z z z z z z
UNDERGROUND UNKNOWN UTILITY LINE	
WATER METER	\odot
WATER VALVE	\otimes
FIRE HYDRANT	Ф
SANITARY SEWER CLEANOUT	•

UTILITY CONSTRUCTION

GENERAL NOTES:

- 1. NCDOT PROVIDED THE EXISTING CONDITIONS SURVEY DATA, AND PROPOSED ROADWAY DESIGN PLANS AND DETAILS IN AUTOCAD FORMAT TO AWCK FOR THE DESIGN OF PROPOSED SALISBURY WATERLINE UTILITY TO BE REPLACED UNDER THIS CONTRACT.
- 2. THE PROPOSED UTILITY CONSTRUCTION SHALL MEET THE APPLICABLE REQUIREMENTS OF THE NC DEPARTMENT OF TRANSPORTATION'S "STANDARD SPECIFICATIONS FOR ROADS AND STRUCTURES" DATED JANUARY 2018, THE CITY OF SALUSBURY UTILITY CONSTRUCTION STANDARDS MANUAL, NORFOLK SOUTHERN CORPORATION SPECIFICATIONS FOR PIPELINE OCCUPANCY NSCE-8.
- 3. BLASTING IS NOT PERMITTED WITHIN THE NORFOLK-SOUTHERN RAILROAD RIGHT-OF-WAY.
- 4. CONFLICTS BETWEEN SPECIFICATION SHALL BE DECIDED IN FAVOR OF THE MOST RESTRICTIVE SPECIFICATION.
- 5. THE EXISTING WATER LINES BELONG TO SALISBURY-ROWAN UTILITIES (SRU).
- 6. ALL WATER LINES SHALL BE INSTALLED IN COMPLIANCE OF THE RULES AND REGULATIONS OF THE NORTH CAROLINA DEPARTMENT OF ENVIRONMENTAL AND NATURAL RESOURCES, DIVISION OF WATER RESOURCES, PUBLIC WATER SUPPLY SECTION. PERFORM ALL WORK IN ACCORDANCE WITH THE APPLICABLE PLUMBING CODES.
- 7. THE UTILITY OWNER OWNS THE EXISTING UTILITY FACILITIES AND WILL DWN THE NEW UTILITY FACILITIES AFTER ACCEPTANCE BY THE DEPARTMENT. THE DEPARTMENT DWNS THE CONSTRUCTION CONTRACT AND HAS ADMINISTRATIVE AUTHORITY, COMMUNICATIONS AND DECISIONS BETWEEN THE CONTRACTOR AND UTILITY OWNER ARE NOT BINDING UPON THE DEPARTMENT OR THIS CONTRACT UNLESS AUTHORIZED BY THE ENGINEER, AGREEMENTS BETWEEN THE UTILITY OWNER AND CONTRACTOR FOR THE WORK THAT IS NOT PART OF THIS CONTRACT OR IS SECONDARY TO THIS CONTRACT ARE ALLOWED, BUT ARE NOT BINDING UPON THE DEPARTMENT.
- 8. PROVIDE ACCESS FOR THE DEPARTMENT PERSONNEL AND THE OWNER'S REPRESENTATIVES TO ALL PHASES OF CONSTRUCTION NOTIFY DEPARTMENT PERSONNEL AND THE UTILITY OWNER TWO WEEKS PRIOR TO COMMENCEMENT OF ANY WORK AND ONE WEEK PRIOR TO SERVICE INTERRUPTION, KEEP UTILITY OWNERS' REPRESENTATIVES INFORMED OF WORK PROGRESS AND PROVIDE OPPORTUNITY FOR INSPECTION OF CONSTRUCTION AND TESTING.
- 9. THE PLANS DEPICT THE BEST AVAILABLE INFORMATION FOR THE LOCATION, SIZE, AND TYPE OF MATERIAL FOR ALL EXISTING UTILITIES. MAKE INVESTIGATIONS FOR DETERMINING THE EXACT LOCATION, SIZE, AND TYPE MATERIAL OF THE EXISTING FACILITIES AS NECESSARY FOR THE FACILITIES AS NECESSARY FOR THE CONSTRUCTION OF THE PROPOSED UTILITIES AND FOR AVOIDING DAMAGE TO EXISTING FACILITIES. REPAIR ANY DAMAGE INCURRED TO EXISTING FACILITIES TO THE ORIGINAL OR BETTER CONDITION AT NO ADDITIONAL COST TO THE DEPARTMENT.
- 10. MAKE FINAL CONNECTIONS OF THE NEW WORK TO THE EXISTING SYSTEM WHERE INDICATED ON THE PLANS, AS REQUIRED TO FIT THE ACTUAL CONDITIONS, OR AS DIRECTED.
- 11. MAKE CONNECTIONS BETWEEN EXISTING AND PROPOSED UTILITIES AT TIMES MOST CONVENIENT TO THE PUBLIC, WITHOUT ENDANGERING THE UTILITY SERVICE, AND IN ACCORDANCE WITH THE UTILITY DWNER'S REQUIREMENTS, MAKE CONNECTIONS ON WEEKENDS, AT NIGHT, AND ON HOLIDAYS IF NECESSARY.
- 12. ALL UTILITY MATERIALS SHALL BE APPROVED PRIOR TO DELIVERY TO THE PROJECT. SEE 1500-7, "SUBMITTALS AND RECORDS" IN SECTION 1500 OF THE STANDARD SPECIFICATIONS.

PROJECT SPECIFIC NOTES:

CITY OF SALISBURY GENERAL NOTES

2.03 WATER LINES - GENERAL NOTES

- 1. CONCRETE BLOCKING (3000 PSI) TO BE PLACED AT ALL BENDS OR AS REQUIRED UNLESS MEGA LUGS OR RESTRAINED JOINTS ARE USED.
- 2. STANDARD DEPTH OF COVER TO BE 3 FEET EXCEPT AT VALVE OR HYDRANT LOCATIONS OR OTHER SPECIAL SITUATIONS, COVER IS BASED ON ELEVATION BELOW EDGE OR PAVEMENT OR AS INDICATED ON THE PLANS.
- 3. PROVIDE POURED IN PLACE CONCRETE PADS (18" X 18" X 6") (OR CONCRETE "DONUTS" MAY BE USED AS AN ALTERNATIVE AT THE DISCRETION OF THE UTILITIES INSPECTOR) AT ALL VALVE BOXES.
- 4. EXTENSIONS FOR VALVE BOXES, WHEN REQUIRED, ARE TO BE VALVE BOXES OR DIP (NO PVC OR C900), 5-8
- 5. ALL PAVEMENT CUTS, CONCRETE OR ASPHALT, ARE TO BE REPLACED ACCORDING TO THE STANDARD DETAILS OR AS REQUIRED BY THE NORTH CAROLINA DEPARTMENT OF TRANSPORTATION.
- 6. PAVEMENT CUTS ARE TO BE REPLACED IMMEDIATELY AFTER BACKFILLING OF INITIAL CUT EITHER WITH PERMANENT REPLACEMENT OR A TEMPORARY REPLACEMENT OF 10" OF BASE IF APPROVED BY THE CITY (FOR CITY MAINTAINED STREETS) OR DOT (FOR STATE MAINTAINED STREETS).
- 7. REPAIRS TO MAIN BREAKS:
- a) SOLID SLEEVES TO BE USED FOR CONNECTING SPIGOT ENDS SHALL BE OF THE LONG BODY TYPE.
- b) ALL REPAIRS SHALL BE INSPECTED BY CITY BEFORE BACKFILLING.
- 8. IN ANY INSTANCE WHERE IT WILL BE NECESSARY TO HAVE THE WATER SHUT OFF ON EXISTING MAINS IN ORDER TO MAKE A TIE-IN, THE WORK MUST BE DONE BY CITY FORCES OR A CONTRACTOR WORKING FOR THE CITY, SCHEDULED 48 HOURS TO 7 DAYS IN ADVANCE DEPENDING ON THE LOCATION AND TYPES OF BUSINESSES THAT WILL BE AFFECTED.
- 9. WHEN A WATER MAIN CROSSES AN EXISTING SEWER MAIN, THE CONTRACTOR IS TO REPLACE THE SEWER PIPE SPANNING THE DITCH WITH DUCTILE PIPE WHEN THE FOLLOWING CONDITIONS OCCUR: a) ANYTIME A WATER MAIN IS INSTALLED UNDER A SEWER MAIN.
- 6) WHEN A WATER MAIN IS OVER A SEWER MAIN AND THE VERTICAL DISTANCE BETWEEN THE TWO MAINS IS 18" OR LESS (MINIMUM 12" CLEARANCE BETWEEN WATER AND SEWER LINES).
- 10. WATER MAINS SHALL BE INSTALLED WITH A MINIMUM OF 10' HORIZONTAL SEPARATION FROM SEWER LINES. WHERE THIS IS NOT POSSIBLE, BOTH THE WATER LINE AND SEWER LINE SHALL BE DUCTILE IRON PIPE.
- 11. WATER LINES SHALL BE DISINFECTED AND HYDROSTATICALLY TESTED IN ACCORDANCE WITH ALL STATE AND CITY OF SALISBURY REQUIREMENTS.
- 12. ALL PLANS SHALL MEET ALL FEDERAL, STATE, CITY OF SALISBURY, AND SALISBURY-ROWAN UTILITIES REGULATIONS, DESIGN CRITERIA, AND CONSTRUCTION STANDARDS.

NORFOLK SOUTHERN GENERAL NOTES:

- 1. CONTRACTOR SHALL FOLLOW ALL REQUIREMENTS OF NORFOLK SOUTHERN'S NSCE-8 SPECIFICATIONS.
- 2. PIPELINE AND CROSSING TO BE INSTALLED AND MAINTAINED IN ACCORDANCE WITH LAST APPROVED AMERICAN RAILWAY ENGINEERING AND MAINTENANCE-OF-WAY ASSOCIATION SPECIFICATIONS FOR PIPELINES CONVEYING FLAMMABLE AND NON-FLAME SUBSTANCES.
- 3. BLASTING NOT PERMITTED.

PROJECT REFERENCE NO. SHEET NO. B-5772UC-3

DESIGNED BY: JDM DRAWN BY: RCC CHECKED BY: APPROVED BY:

FAX: (919)250-4151

REVISED: NORTH CAROLINA

DEPARTMENT OF TRANSPORTATION UTILITIES ENGINEERING SEC.


WH CARO Docusigned by: P. J. SEAL D. Moode GINEER. 3/11/2022 PHONE: (919)707-6690 UTILITY CONSTRUCTION


PLANS ONLY

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alley, williams, carmen, & king, inc CONSULTING ENGINEERS 120 SOUTH MAIN STREET KANNAPOLIS, NC 28082



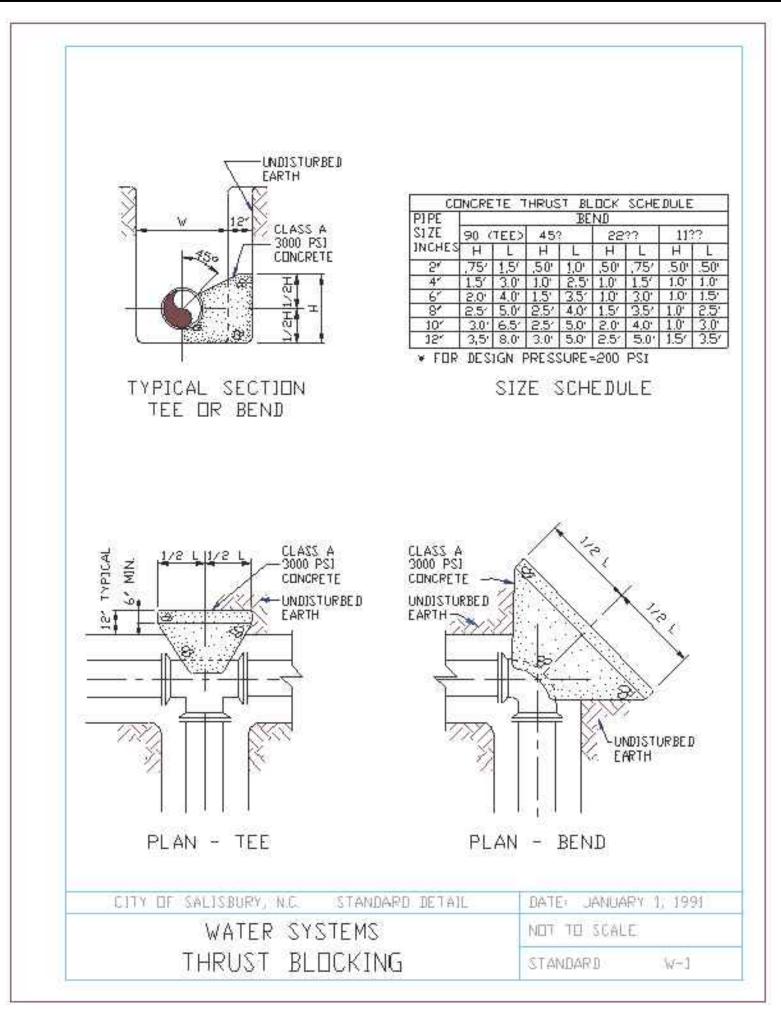

TAPS MAY BE REQUIRED IN SUBDIVISIONS AND APARTMENT COMPLEXES).

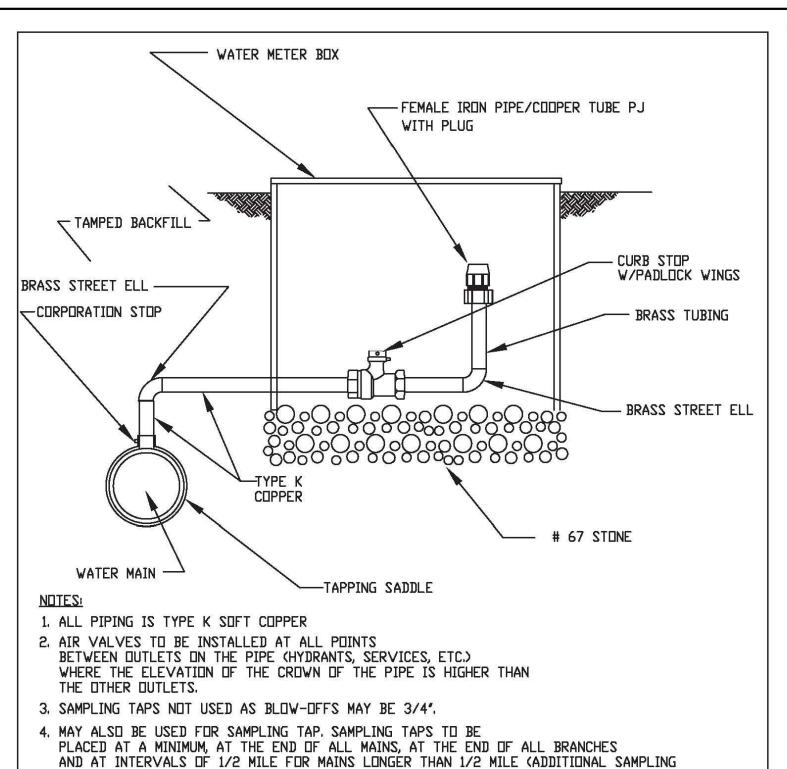16" - MINIMUM SIZE BLOW-OFF 4" (DUCTILE IRON PIPE REQUIRED)

24" - MINIMUM SIZE BLOW-OFF 6" (DUCTILE IRON PIPE REQUIRED)

CITY OF SALISBURY, N.C. STANDARD DETAIL


WATER SYSTEM BLOW OFF VALVE


APPROVED TYPES LOCATED IN APPENDIX "A" OF THE CITY OF SALISBURY UNIFORM CONSTRUCTION STANDARDS


6. BLOW-OFF SIZES:


5. SEE CURRENT CITY OF SALISBURY WATER & SEWER APPROVED PRODUCTMANUFACTURER'S SHEET FOR

6" TO 12" - MINIMUM SIZE BLOW-OFF 2" - COPPER AND BRASS IN METER BOX (AS SHOWN ABOVE).

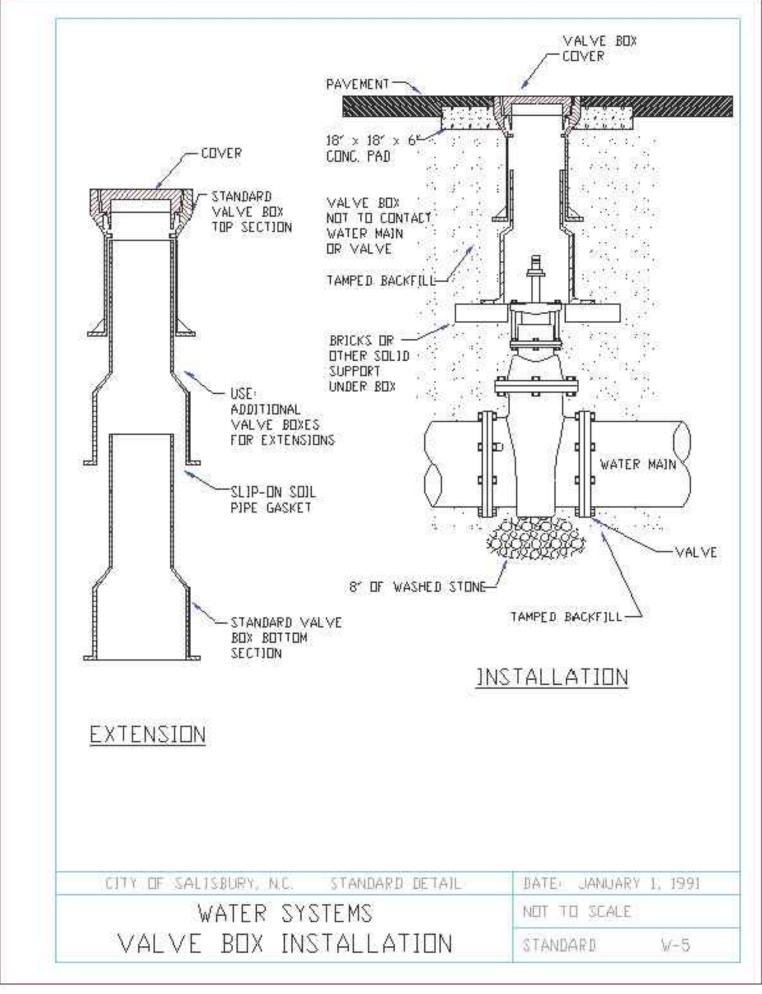

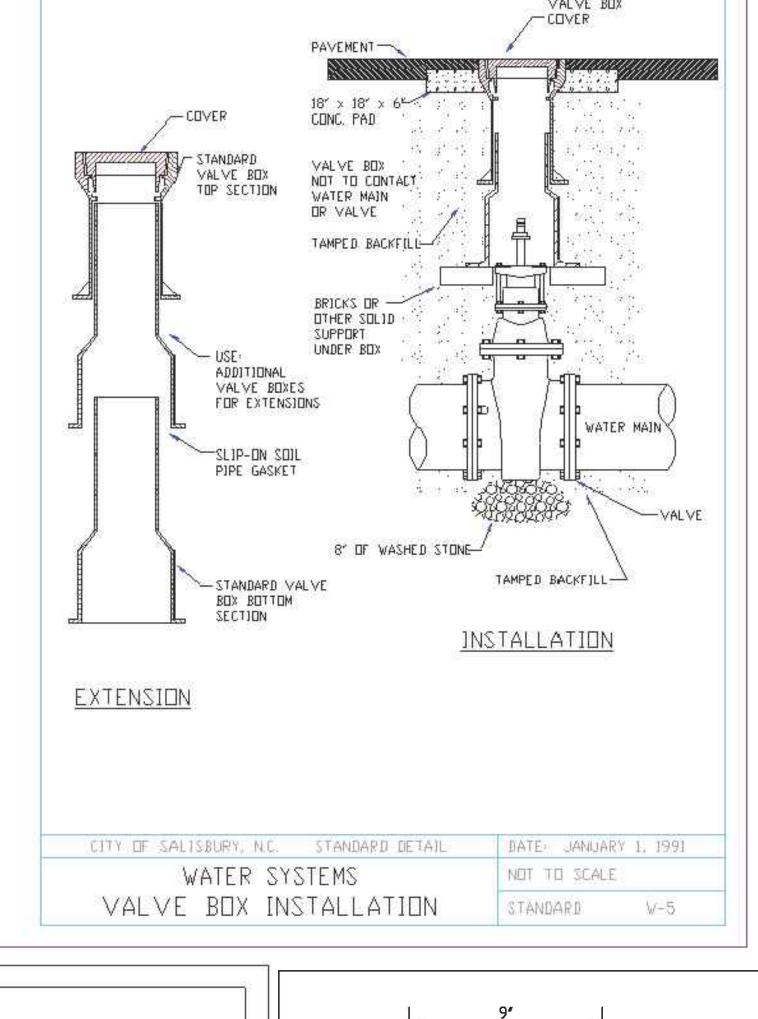

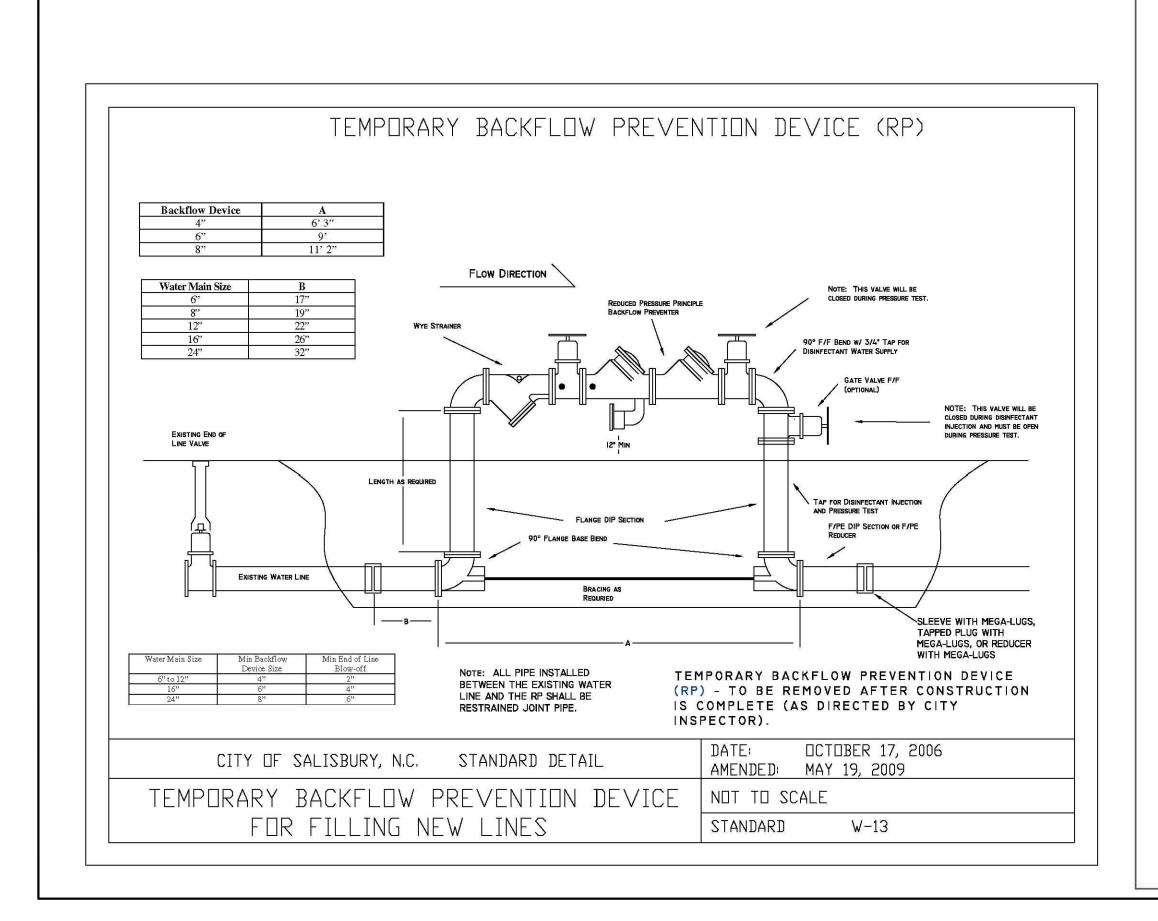

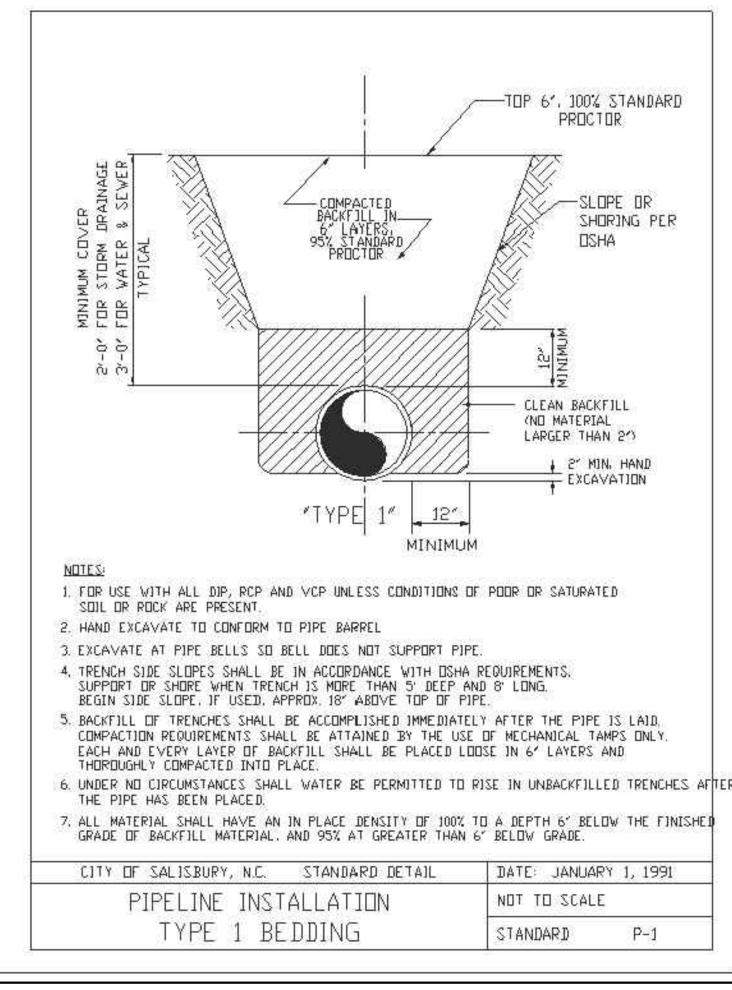


DATE: OCTOBER 17, 2006

AMENDED: MAY 19, 2009

NOT TO SCALE

STANDARD W-7

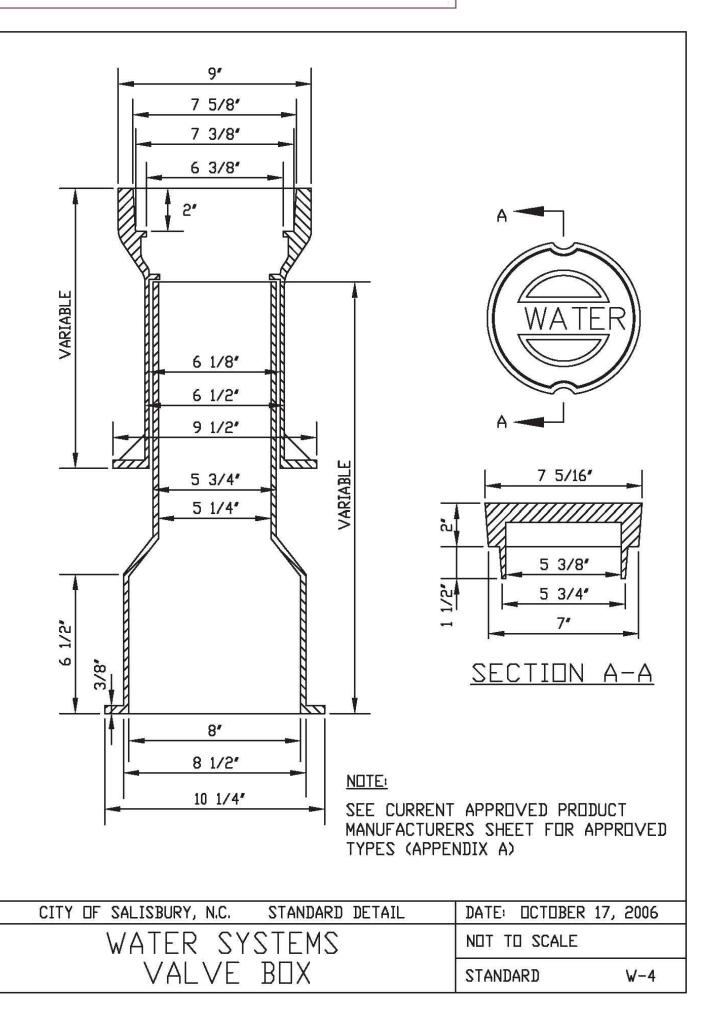

PROJECT REFERENCE NO.

B-5772

RCC

PHONE: (919)707-6690 UTILITY CONSTRUCTION

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120 SOUTH MAIN STREET KANNAPOLIS, NC 28082

alley, williams, carmen, & king, inc. CONSULTING ENGINEERS

FIRM LICENSE No. F-0203

DESIGNED BY: JDM

NORTH CAROLINA

DEPARTMENT OF

TRANSPORTATION

UTILITIES ENGINEERING SEC.

FAX: (919)250-4151

DRAWN BY:

CHECKED BY:

REVISED:


APPROVED BY:


SHEET NO. UC-3A

WH CARO

ESS/ON

CANCINE E.

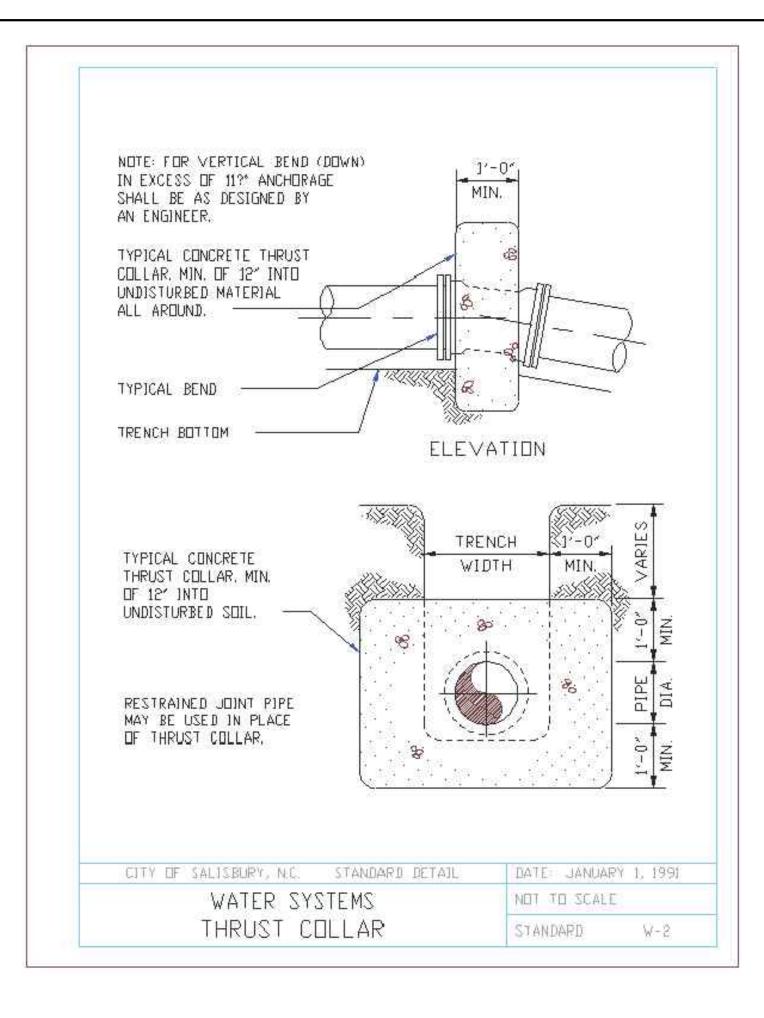

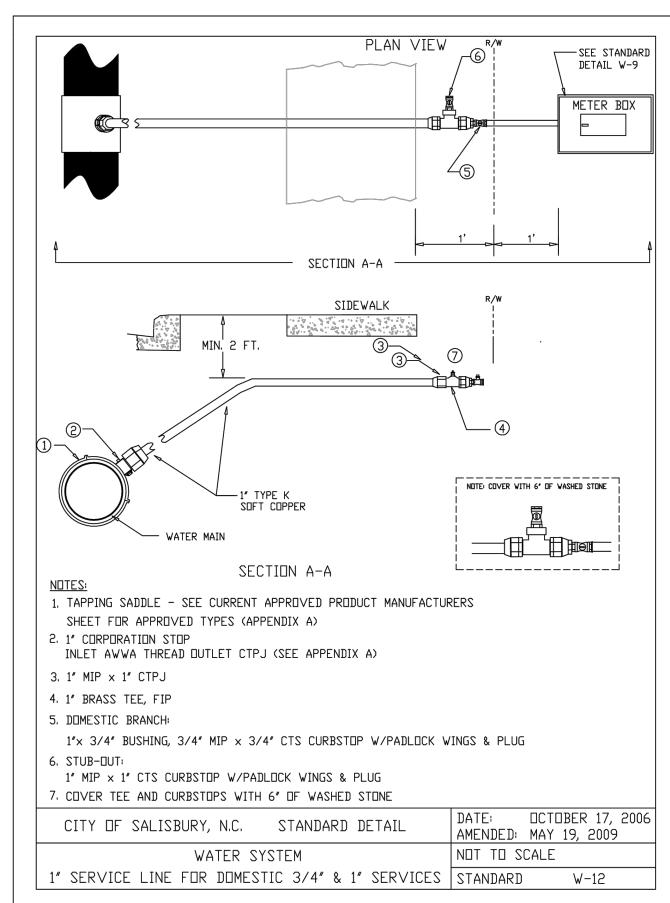

Appendix A 04-12-2018

City of Salisbury Water Sewer Maintenance Department Approved Product Manufacturers (Domestic Products Only)

- 1. Ductile Iron Pipe Domestic, Pressure Class 350, AWWA C-151/ANSI A21.51, ANSI C-111/AWWA A21.11, AWWA C-150/ANSI A21.50:
- American Cast Iron Pipe Co.*
- Griffin Pipe*
- Tyler Pipe / Union Foundry* U S Pipe*
- Atlantic States*
- 2. Ductile Iron Mechanical Joint Fittings Domestic, Pressure Class 350, AWWA C-153/ANSI A21.53, AWWA C-111/ANSI A21.11, AWWA C-104/ANSIA A21.4:
- Griffin Pipe*
- Tyler Pipe / Union Foundry*
- U S Pipe*
- 3. Gate Valves Resilient Seated, NRS, (3" 16") 200 PSI Rating, (Open Left): • American Flow Control Series 500 or 2500 (With Slotted Bolt Holes at 11:00 & 1:00
- Clow Series F-6100 (With Slotted Bolt Holes at 11:00 & 1:00 position Only)* • Mueller Series 2360 (With Slotted Bolt Holes at 11:00 & 1:00 position)*
- 4. Tapping Valves Resilient Seated, NRS (4" 16") Flange x M.J. 200 PSI Rating, (Open
- American Flow Control Series 500 or 2500 (No Slots on Flange side)*
- Clow F-6114 (No Slots on Flange side)*
- 5. Ductile Iron Tapping Sleeve Two-Piece (4" through 12") M.J. 200 PSI Rating:
- American Flow Control Series 2800 (No Slots on Tapping Flange side)*
- Mueller H-615 (No Slots on Tapping Flange side)*
- Tyler/Union*

Mueller T-2360*

- 6. Cast Iron Valve Boxes Two-Piece:
- Tyler Series 6855 Slip-Type with 5 1/4" Drop Lid*
- 7. Fire Hydrants 200 PSI minimum Rating, Grease Filled, Painted Silver, 6" M.J. Shoe, (2) 2-1/2" Hose & (1) 4-1/2" Pumper Nozzles (bronze) with NST Threads, 4-1/2" Main Valve Opening (Open Left), UL Listed & FM Approved:
- American Flow Control MK-73*
- Clow Medallion*
- Mueller Super Centurion*

FIRM LICENSE No. F-0203 120 SOUTH MAIN STREET

alley, williams, carmen, & king, inc.

CONSULTING ENGINEERS

PHONE: (919)707-6690 UTILITY CONSTRUCTION

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PROJECT REFERENCE NO. B - 5772

RCC

DESIGNED BY: JDM

NORTH CAROLINA

DEPARTMENT OF

TRANSPORTATION

UTILITIES ENGINEERING SEC.

FAX: (919)250-4151

DRAWN BY:

REVISED:

CHECKED BY: APPROVED BY: SHEET NO.

UC-3B

CARO

PLANS ONLY

Appendix A

8. Curb Stops - Full Port Ball Valve, (Brass with Padlock Wings):

- Ford B11W & B41W* No Lead McDonald 6101W & 6102W* No Lead
- 9. Corporation Stops Ball Valve, (3/4" 1", Brass, AWWA/CC Thread Inlet x Copper
- **Tube Compression Nut Outlet):** Ford FB1000G* No Lead
- McDonald 4701BT* No Lead
- Mueller B-25008* No Lead

10. Corporation Stops - Ball Valve, (1-1/2" - 2", Brass, AWWA/CC Thread Inlet x Copper

- **Tube Pack Nut Outlet):**
- Ford FB1000* No Lead McDonald 4701B-22* No Lead
- Mueller P-25008* No Lead

11. Service Saddles for AC/CI/DI Pipe - (Stainless Steel Double Strap, Nylon Coated

- **Ductile Iron Saddle):**
- Romac 202NS* • Smith-Blair 317*

- 12. Service Saddles for PVC Pipe (Brass): Ford S70 & S90*
- McDonald 3801, 3805, 3891 & 3895*

13. Copper Meter Setters:

- Ford CS-VBEHC72-95157-05 for 3/4" Services* No Lead McDonald 21U207WNTT33 for 3/4" Services* No Lead
- Ford CS-VBEHC74-95319-03 for 1" Services* No Lead
- McDonald 21U412WNTT44 for 1" Services* No Lead
- Ford VBHH77-15HBHC-41-77 for 2" Services* No Lead McDonald 26R715WD2F7754 for 2" Services* No Lead

14. Copper Tubing:

• Type "K" soft, ASTM B-88*

15. Miscellaneous Brass Couplings:

- Ford* No Lead
- McDonald* No Lead
- Mueller* No Lead

Appendix A

16. Meter Boxes:

- DFW Plastics Inc. DFW1324C-18-BODY with DFW Plastics Inc. DFW1324C-1CF ORION-LID for 3/4" & 1" Services (meter box lids shall be plastic lids with recessed knockouts for cellular transmitters)*
- DFW Plastics Inc. DFW1730C-18-BODY with DFW Plastics Inc. DFW1730C-1CF ORION-LID for 2" services (meter box lids shall be plastic lids with recessed knockouts for cellular transmitters)*

17. Joint Restraint:

- EBAA Megalug 1100 Series for DI/CI Pipe*
- EBAA Megalug 2000PV Series for PVC Pipe*
- Romac GripRing PVC/DI/CI Pipe*
- UNI-FLANGE 1400 ("U" domestic) Seriesfor DI/CI Pipe* • UNI-FLANGE 1500 ("U" (domestic) Series for PVC Pipe*

18. Cast Couplings, Straight & Transition:

- Ford FC1 & FC2*
- Romac 501* Smith-Blair 441*

19. Repair Clamps: (repair only – not approved for new construction)

- Romac Stainless Steel SS1 & SS2*
- Smith-Blair Stainless Steel 261 & 262*

20. RP Backflows - University of Southern California Foundation for Cross-Connection Control & Hydraulic Research Approval:

- Ames*
- Cobraco*
- Febco* Wilkins*
- 21. Sewer Manholes Domestic, Gray Iron Castings Conform to ASTM-A48 Class 35B, Ductile Iron Casting Conform to ASTM-A536, NCDOT 840.54 Standard, Support H20 Wheel Load, Cover dimension of 23-1/2" x 1" thick across the top with a minimum weight of 125Lbs. Marked "Sanitary Sewer". Frame dimension of 7-1/2" tall x 33-1/4" across the bottom with a minimum weight of 189Lbs:
- East Jordan Iron Works #41384173*
- U.S. Foundry 669KL*

22. PVC Pipe & Fittings – Pressure Rated Water Distribution, ASTM D-1784, ASTM D-

Appendix A

- 2" SDR 13.5, Class 315*
- 6" 8" AWWA C900 DR14, Class 200*

23. PVC Pipe & Fittings – Gravity Sewer, ASTM D-3034, ASTM F-679, ASTM D-2665 (Charlotte Pipe, North American, or approved equal):

- 4" 30" SDR-35*
- 4" 6" SCH 40 NSF-DW*


24. Sewer Transition Couplings – (repair only – not allowed on new construction):

- Fernco Strong Back RC Coupling Series*
- Mission Rubber Company, Flex –Seal ARC MR Series Couplings

25. Sewer Wyes:

- Saddle Wye Contech PFSP & PFTP style*
- Adapter Harco 35-4004 (4") & 35-4006 (6") Plastic Trends P1213 (4") P1215 (6")*
- Wye Lasco, Charlotte Pipe, Spears, or approved equal*

*Note: Some manufacturers are producing both domestic and import materials. In some instances the part numbers may be the same or have just a letter or number difference (example – the Ford Uni-Flange 1400 series joint restraint – a "U" has been added to the part number for USA made). Only the domestic manufactured materials will be accepted. Suppliers and contractors should verify the materials are domestically manufactured before installation. Shop drawings are required to be submitted and approved prior to the start of construction.

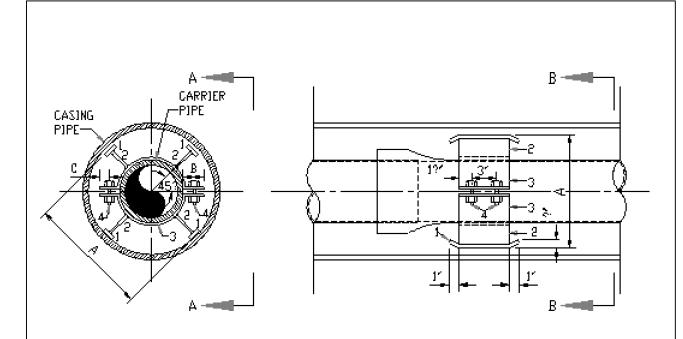

SECTION A-A SECTION B-B

CARF	ARRIER PIPE CASING PIPE			PIPE SUPPORT ASSEMBLY MARK NUMBERS				DIMENSIONS		
ID	OD	OD	WALL/TH	1	2	3	4	Α	В	С
8"	9.05"	14"	0.250"	7" x 1-1/4" x 1/4"	4" x 3/16"	4" x 1/2"	?	12-5/16"	?	?
12"	13.20"	18"	0.312"	7" x 1-1/4" x 1/4"	4" x 3/8"	4" x 3/8"	?	16-5/8"	?	?

NOTES:


- 1. ALL STEEL ENCASEMENT PIPE SHALL BE BEVELED AND PREPARED FOR FIELD WIELDING AT THE
- CIRCUMFERENTIAL JOINTS. 2. ALL STEEL ENCASEMENT PIPE SHALL BE APPROVED BY THE APPROPRIATE CONTROLLING AGENCY
- (NCDOT, RR, ETC.) PRIOR TO ORDERING THE MATERIAL. 3. NO SPECIAL COATING IS REQUIRED ON THE TEMPORARY 14" STEEL ENCASEMENT PIPE. 4. THE PERMANENT 18" STEEL ENCASEMENT PIPE SHALL BE COATED INSIDE AND OUTSIDE WITH A

SECTION 1080 -PAINT AND PAINT MATERIALS".

PIPELINE INSTALLATION PIPE SUPPORT ASSEMBLY

SELF-CURING INORGANIC ZINC PAINT IN ACCORDANCE WITH "NCDOT STANDARD SPECIFICATIONS,

TEMPORARY WATER LINE DETAILS

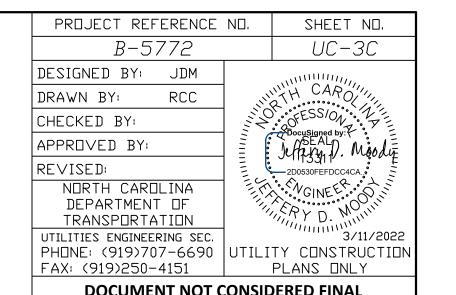

DOCUMENT NOT CONSIDERED FINAL UNLESS ALL SIGNATURES COMPLETED




alley, williams, carmen, & king, inc.

CONSULTING ENGINEERS


FIRM LICENSE No. F-0203

120 SOUTH MAIN STREET P.O. BOX 1248

KANNAPOLIS, NC 28082 704/938-1515

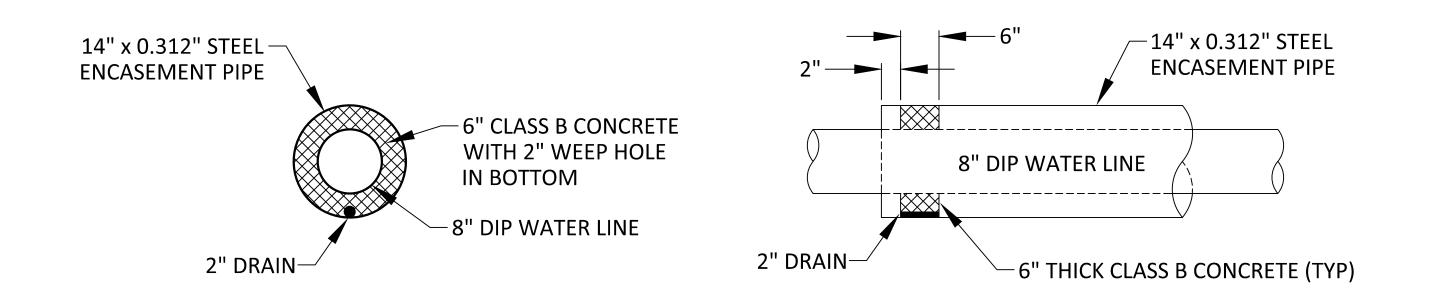


14" TEMPORARY ENCASEMENT PIPE END SEALS

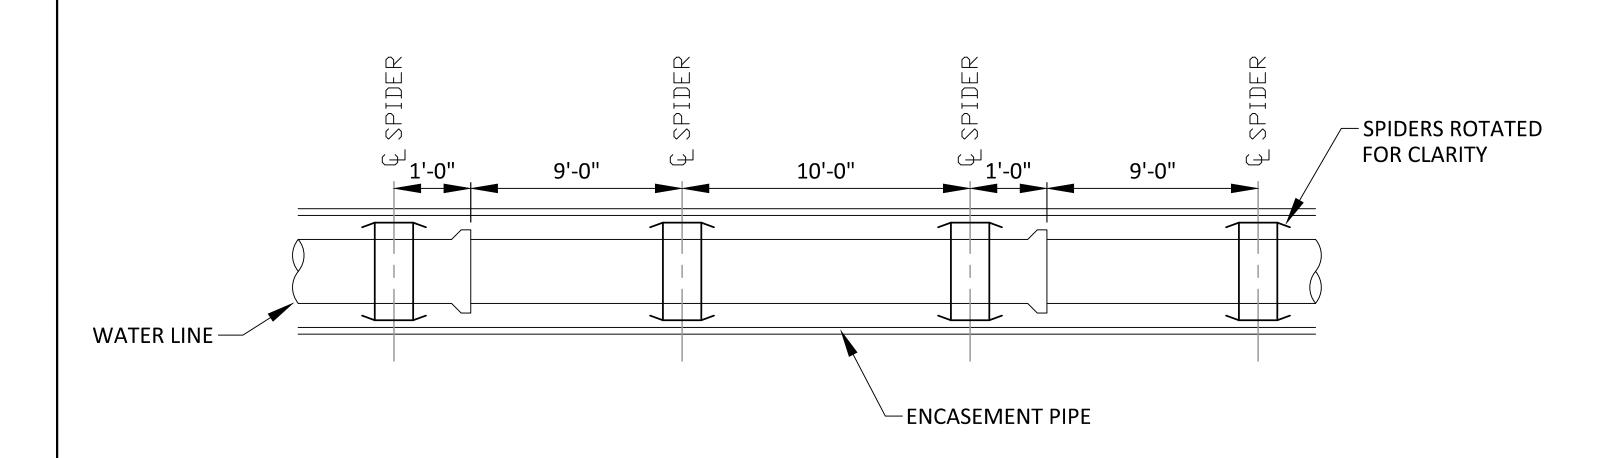



WATER LINE SPIDER SPACING DETAIL

PERMANENT WATER LINE DETAILS

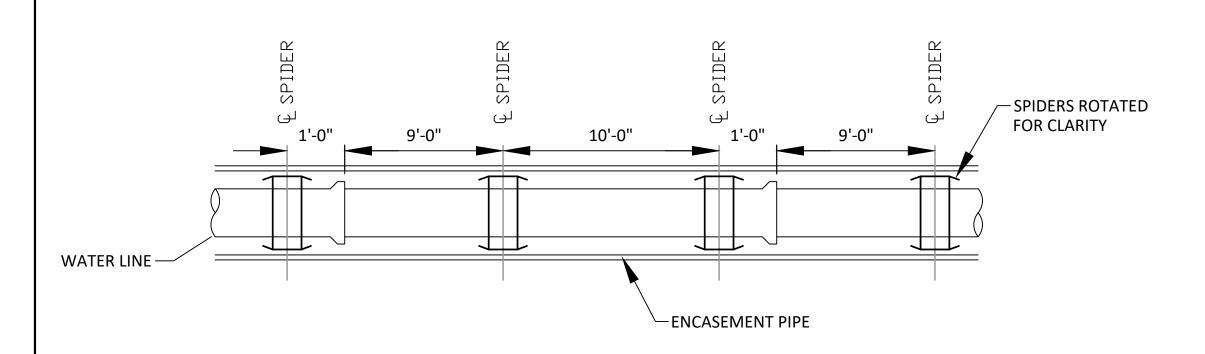

WATER LINE SPIDER SPACING DETAIL
NOT TO SCALE

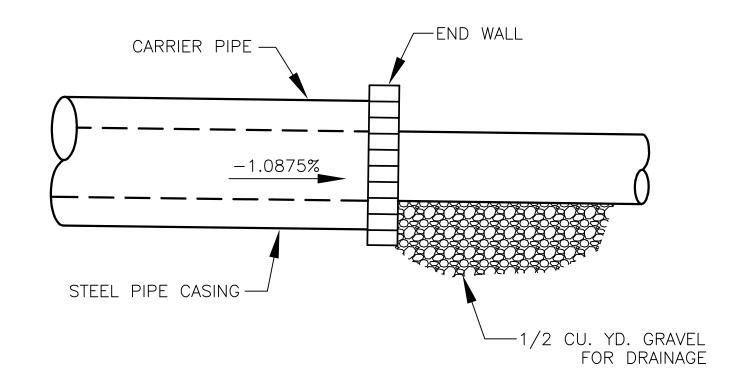


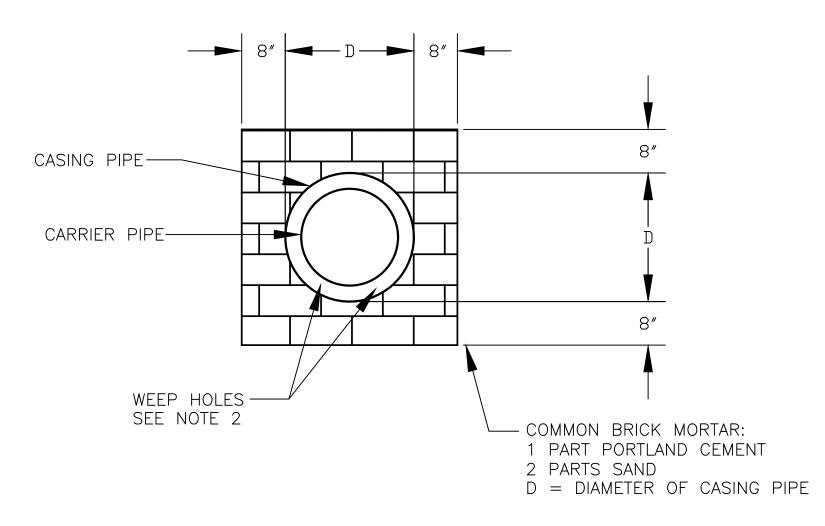

END WALL SECTION NOT TO SCALE

NOTES:

SEE DRAWINGS FOR LOCATION, SIZE AND LENGTH OF STEEL PIPE CASINGS.
 INSTALL TWO (2) 1" DRAINS EACH SIDE OF CARRIER PIPE IN DOWNHILL END WALL.

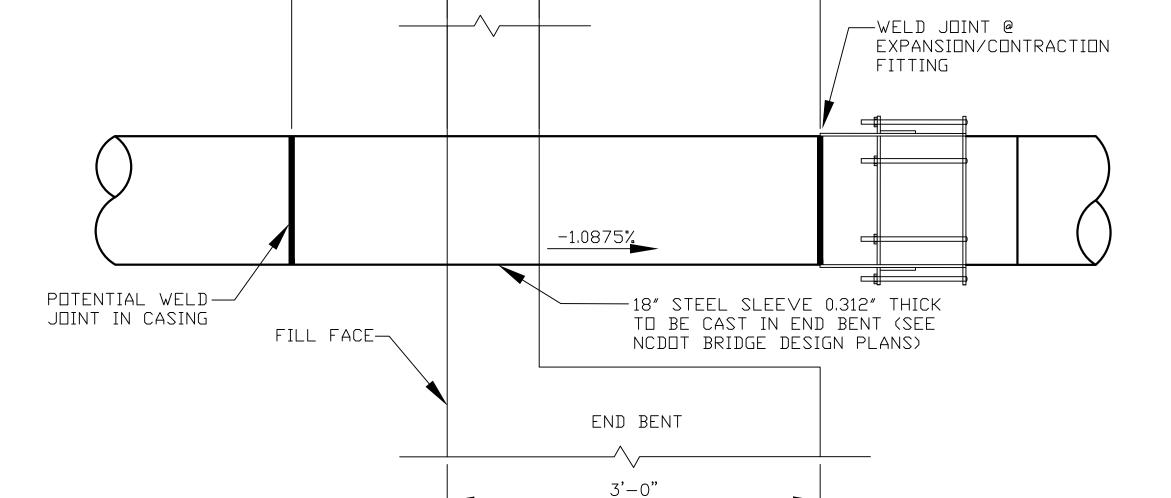


9'-0"

BACKWALL

2'-0"

PROFILE SECTION THRU END BENT (TYP.)
NOT TO SCALE

WRENCH SIZE CHART NUT SIZE 5/8"-11UNC HH 1-1/16"

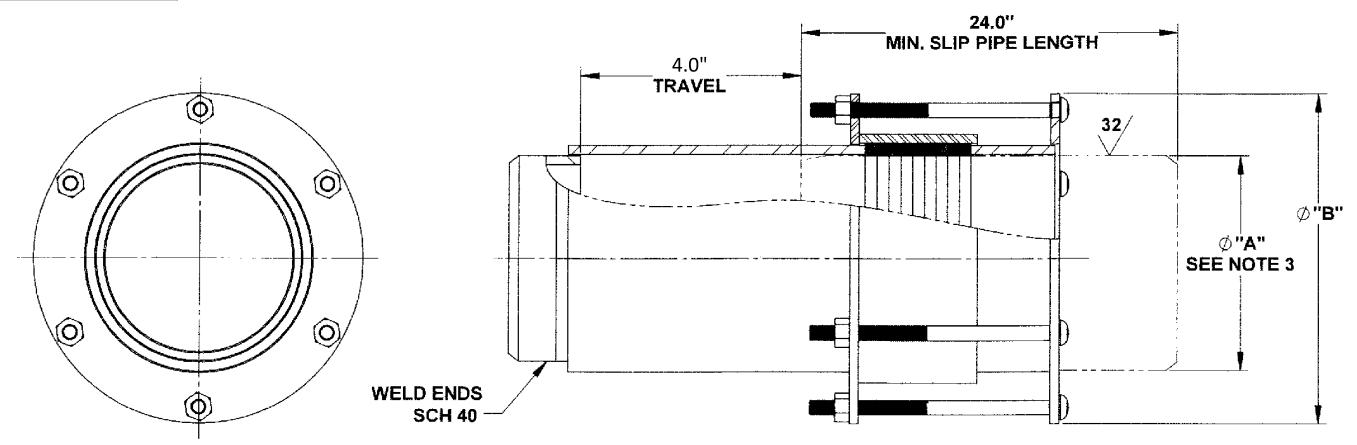

WELD END WITHOUT SLIP PIPE - WITHOUT LIMIT RODS

PROJECT REFERENCE NO.

B-5772

RCC

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FIRM LICENSE No. F-0203

120 SOUTH MAIN STREET P. KANNAPOLIS, NC 28082 70

alley, williams, carmen, & king, inc.
CONSULTING ENGINEERS

DESIGNED BY: JDM

NORTH CAROLINA
DEPARTMENT OF
TRANSPORTATION

UTILITIES ENGINEERING SEC.

DRAWN BY:

REVISED:

CHECKED BY: APPROVED BY: SHEET NO.

UC-3D

NOM. PIPE SIZE	SLIP PIPE O.D. "A"	MAX O.D. "B"	APPROX. WEIGHT (LBS)
3	3.50	8.38	50
4	4.50	9.63	65
6	6.63	11.88	90
8	8.63	13.88	125
10	10.75	16.00	165
12	12.75	18.00	195
14	14.00	19.25	220
16	16.00	21.25	250
18	18.00	23.25	280
20	20.00	25.25	310
22	22.00	27.25	340
24	24.00	2 9.31	370

OTES:

- 1. SEE MANUFACTURER'S CATALOG FOR ADDITIONAL DETAILS


 2. 8" WELD END EXPANSION JOINT SHOWN OTHER SIZES SIMILAR


 3. CUSTOMER FURNISHED SUR PROFESSIONAL AND ENDERABLED END
- 3. CUSTOMER FURNISHED SLIP PIPE MUST HAVE A PREPARED END AT LEAST 24IN IN LENGTH THAT IS ROUND, SURFACE ROUGHNESS OF 32µIN OR BETTER 18IN MIN. FROM STAB END, AND NO GREATER THAN +.030" OR -.010" FROM NOMINAL SIZE.


 4. ENGINEERED FOR AXIAL PIPE MOVEMENT ONLY


EXPANSION COUPLING DETAIL


NOT TO SCALE

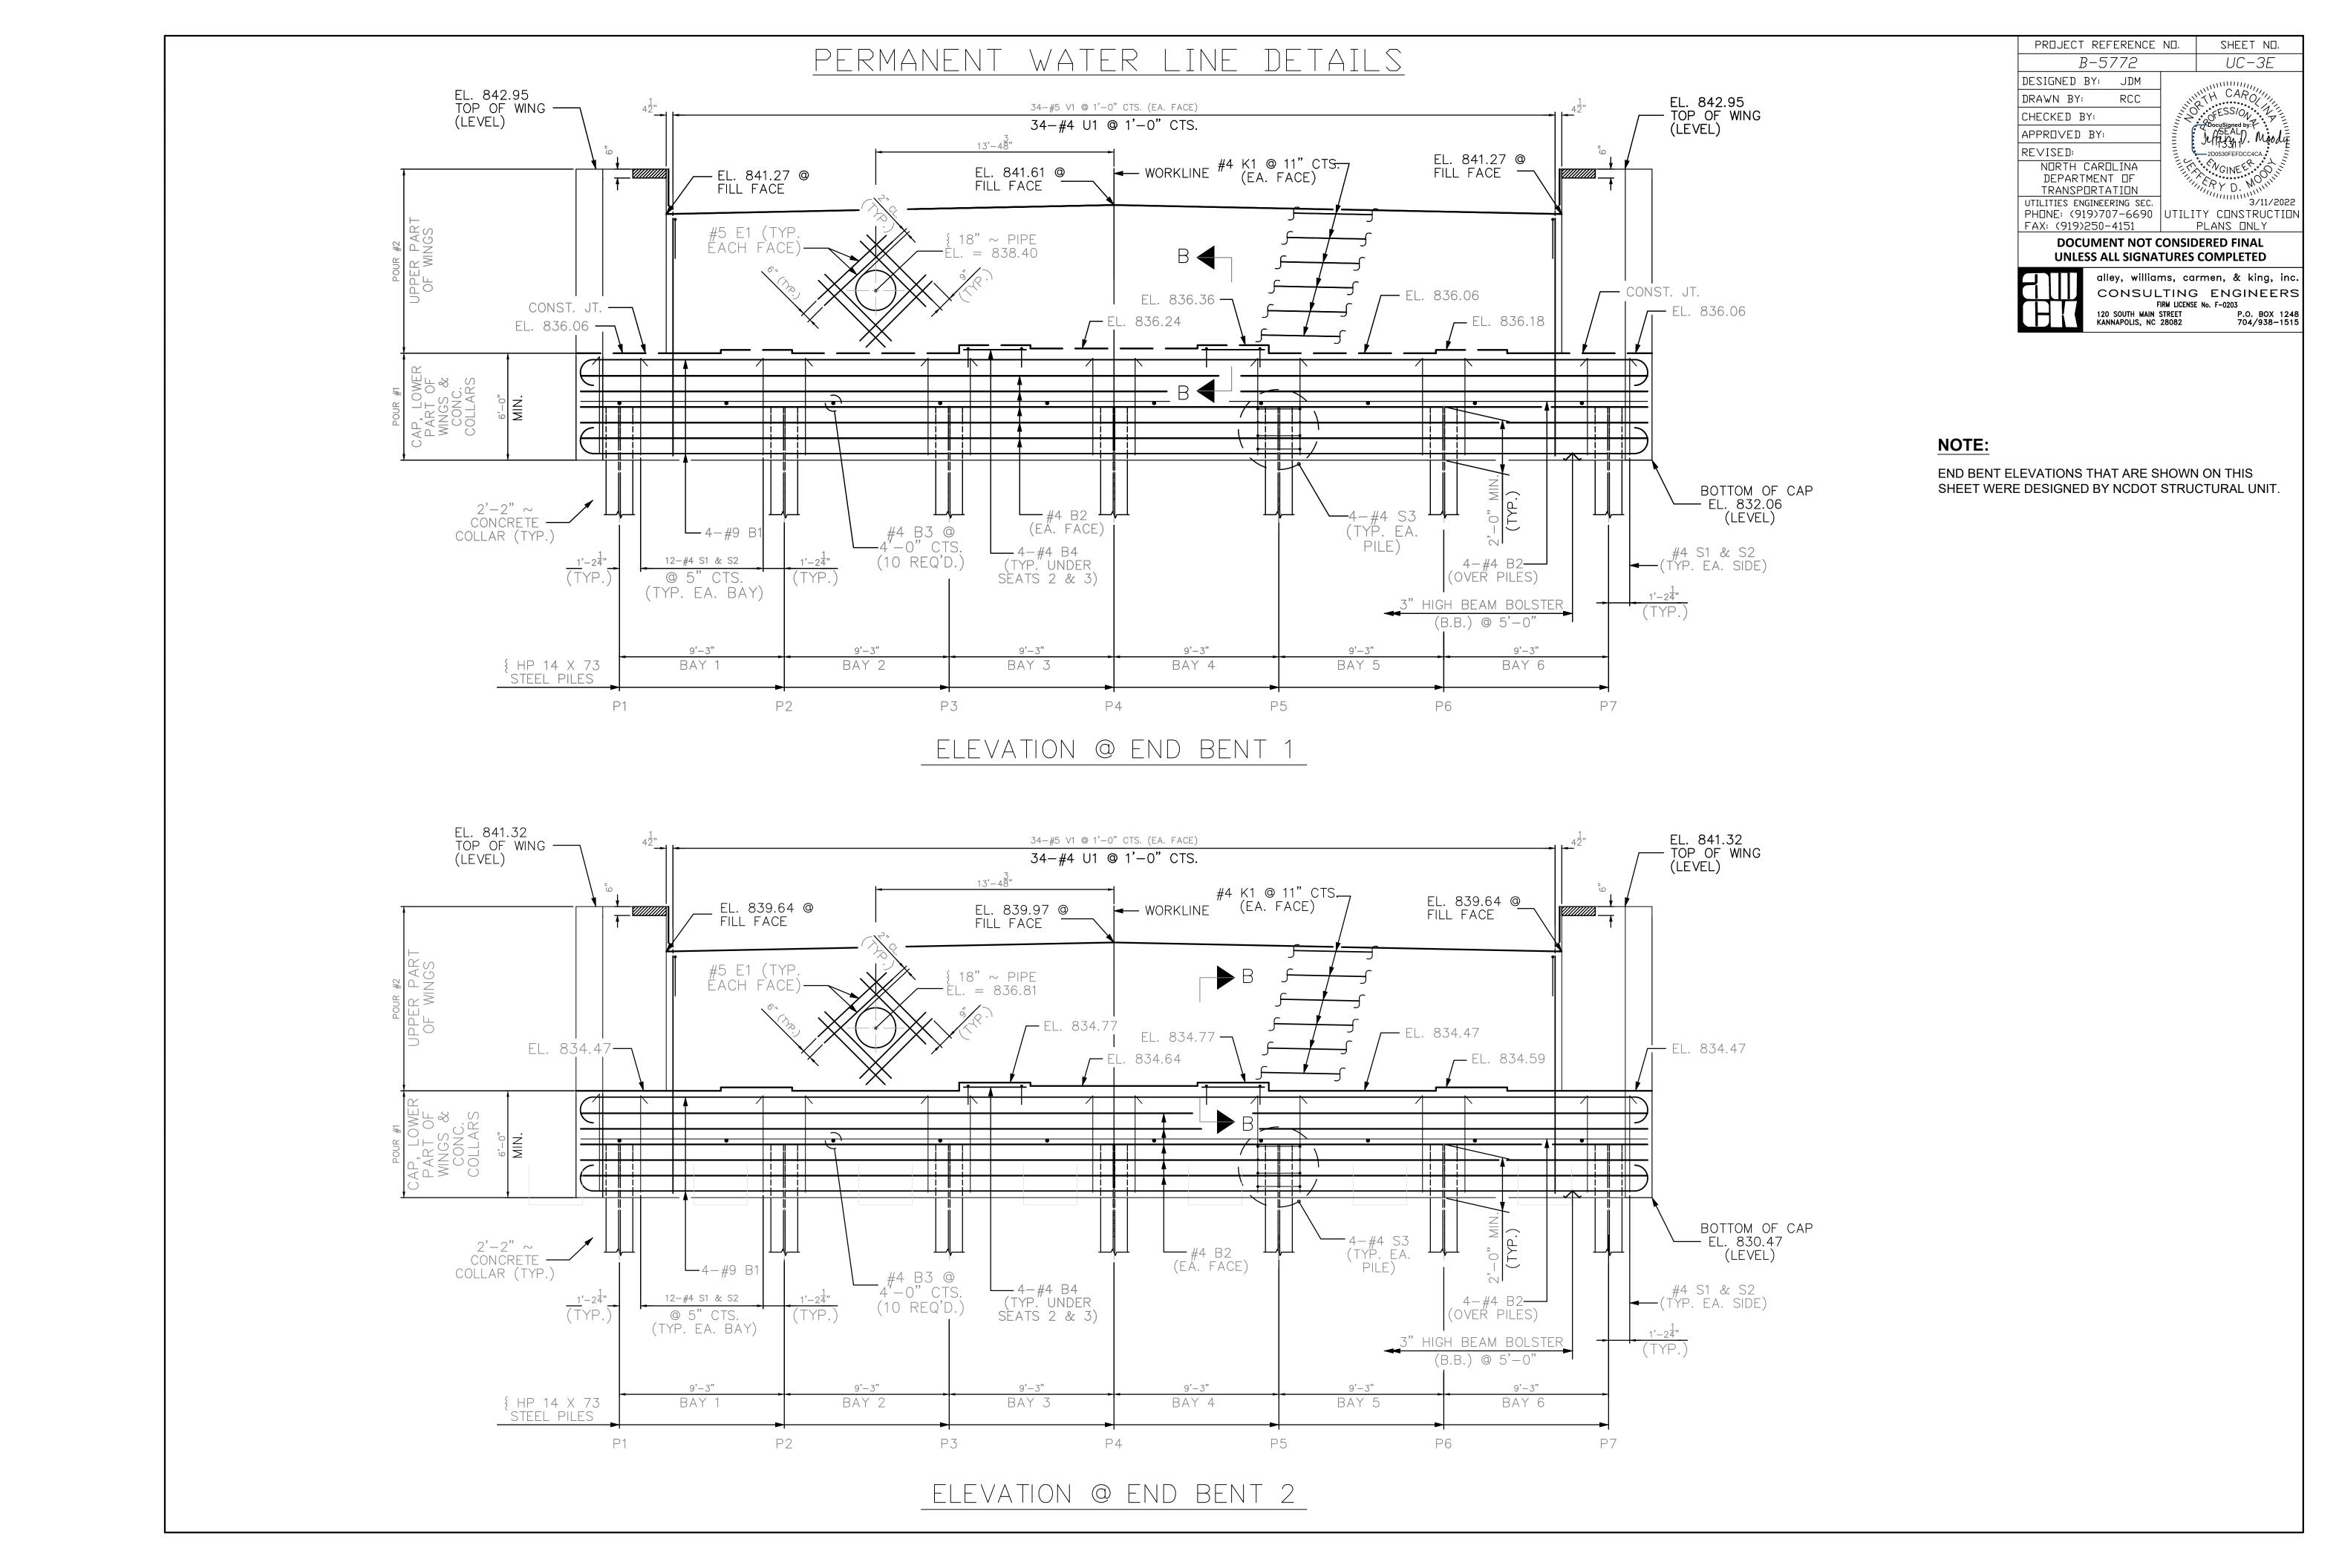


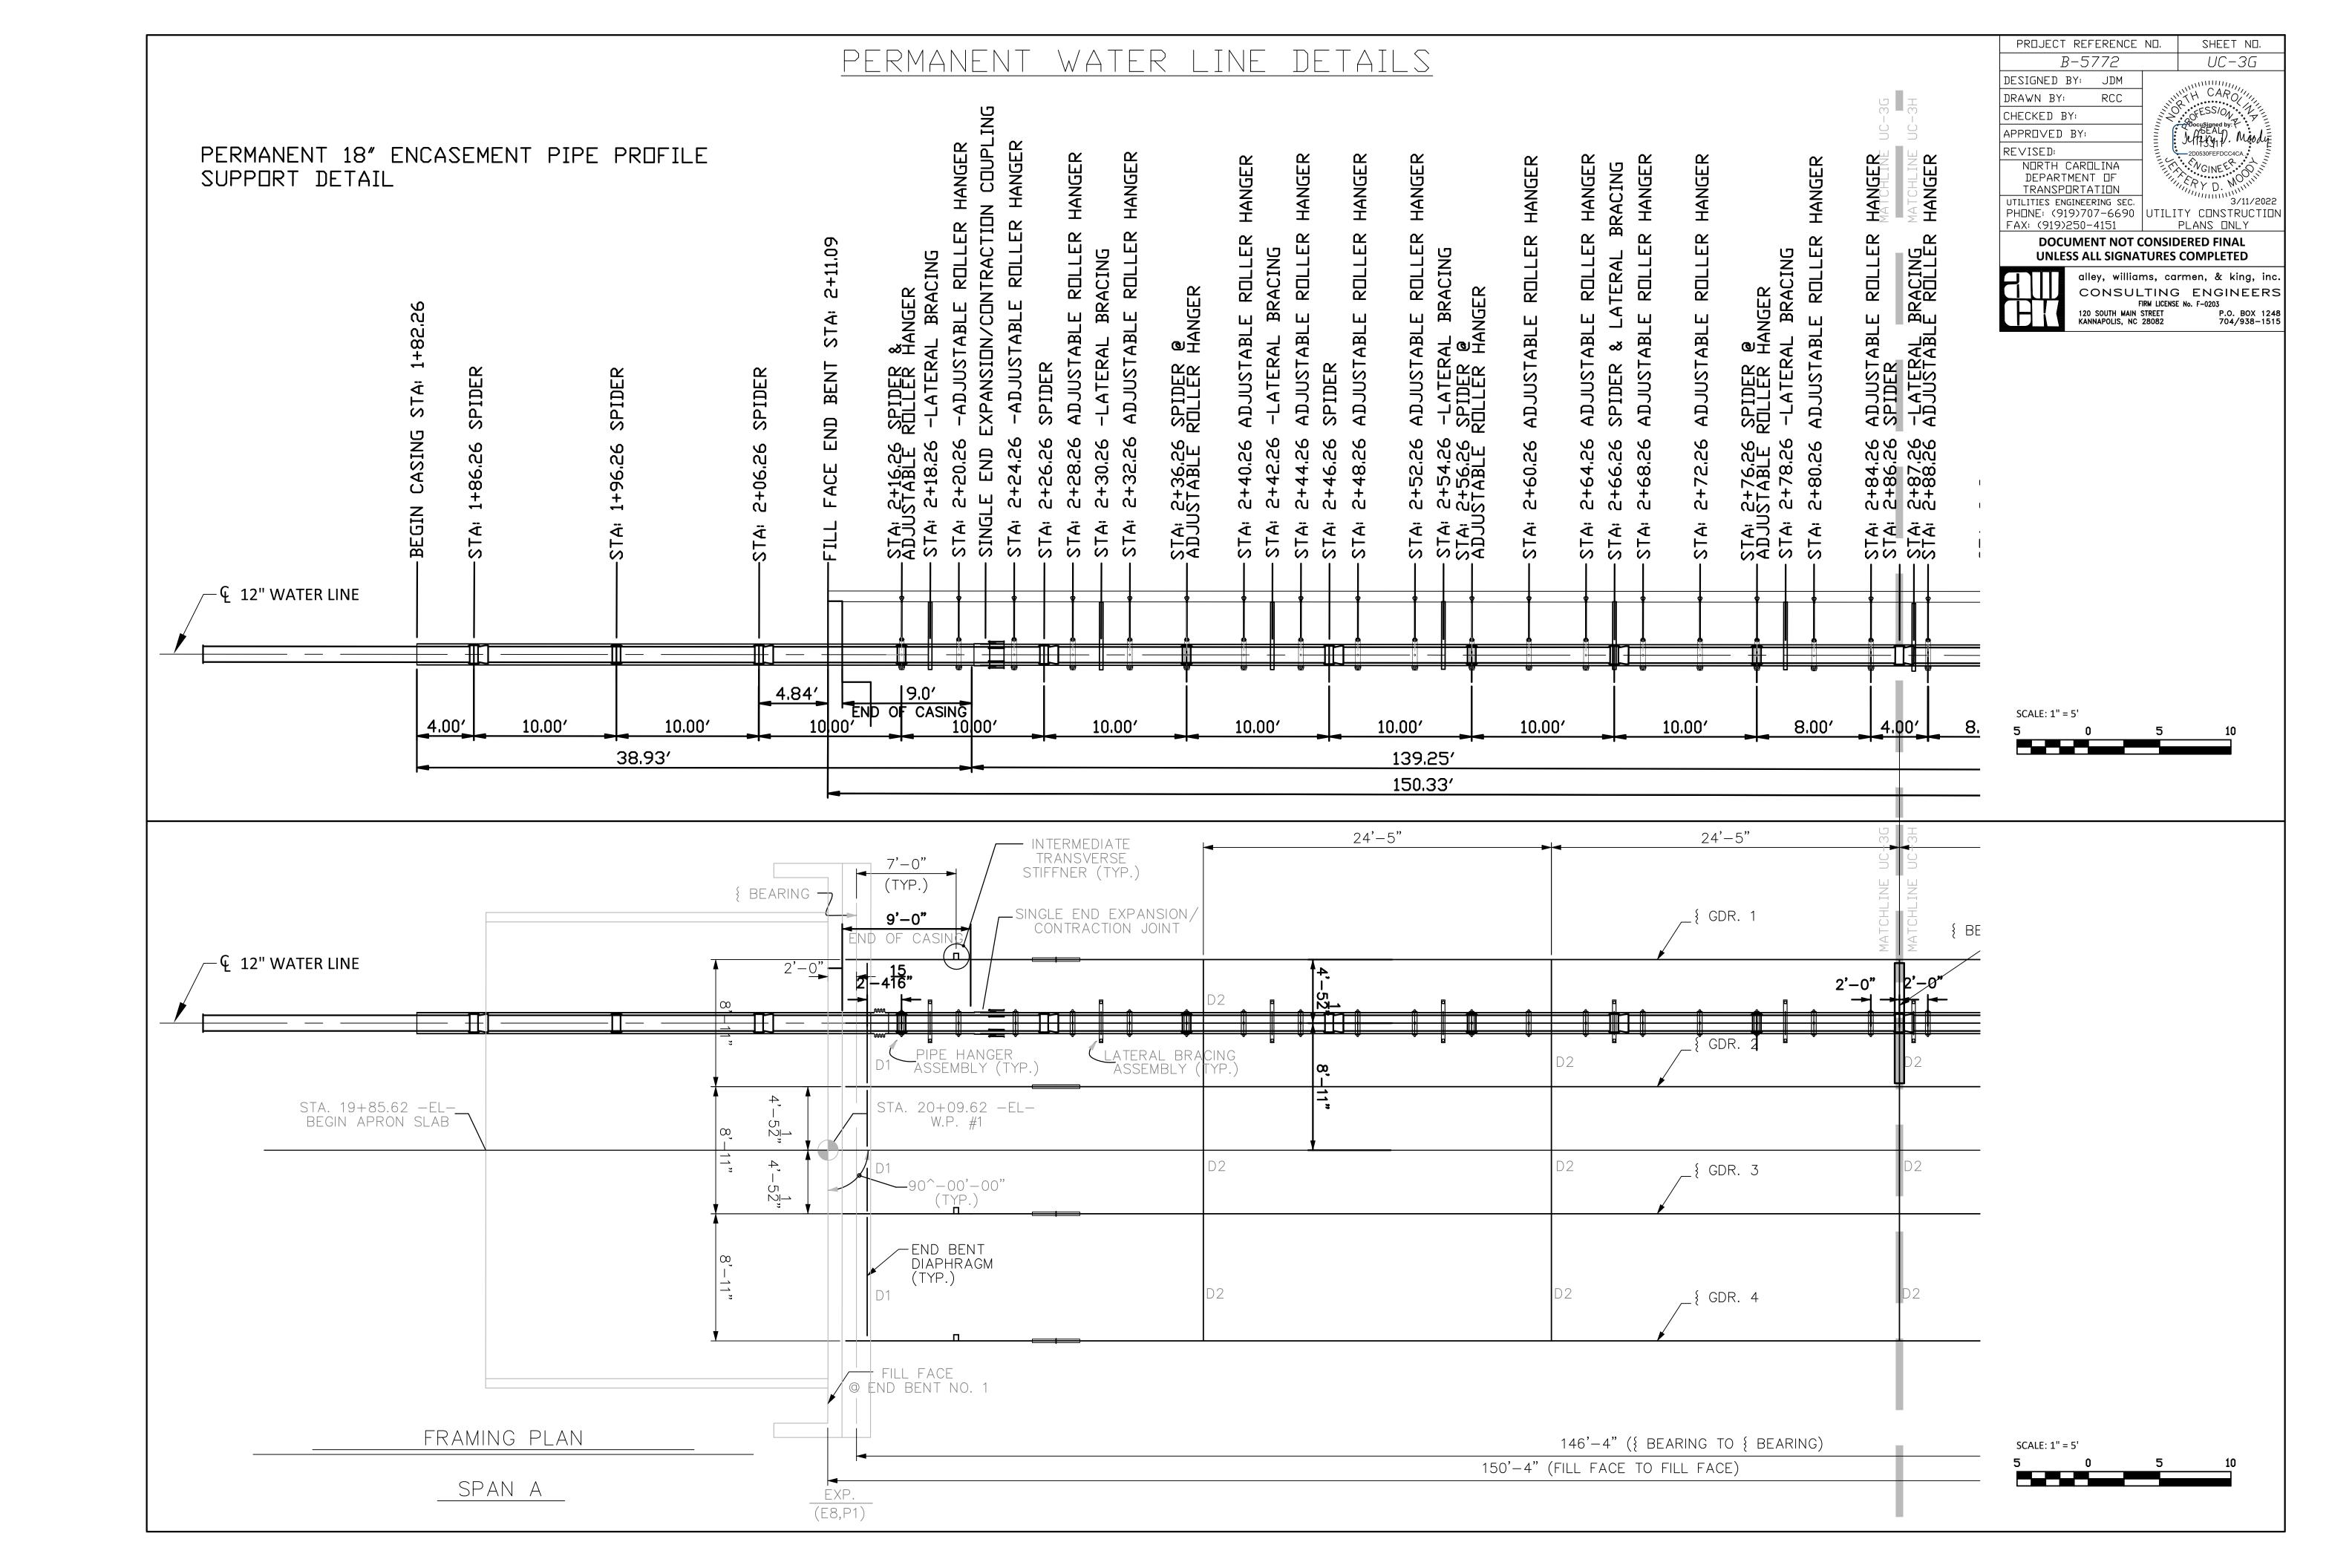


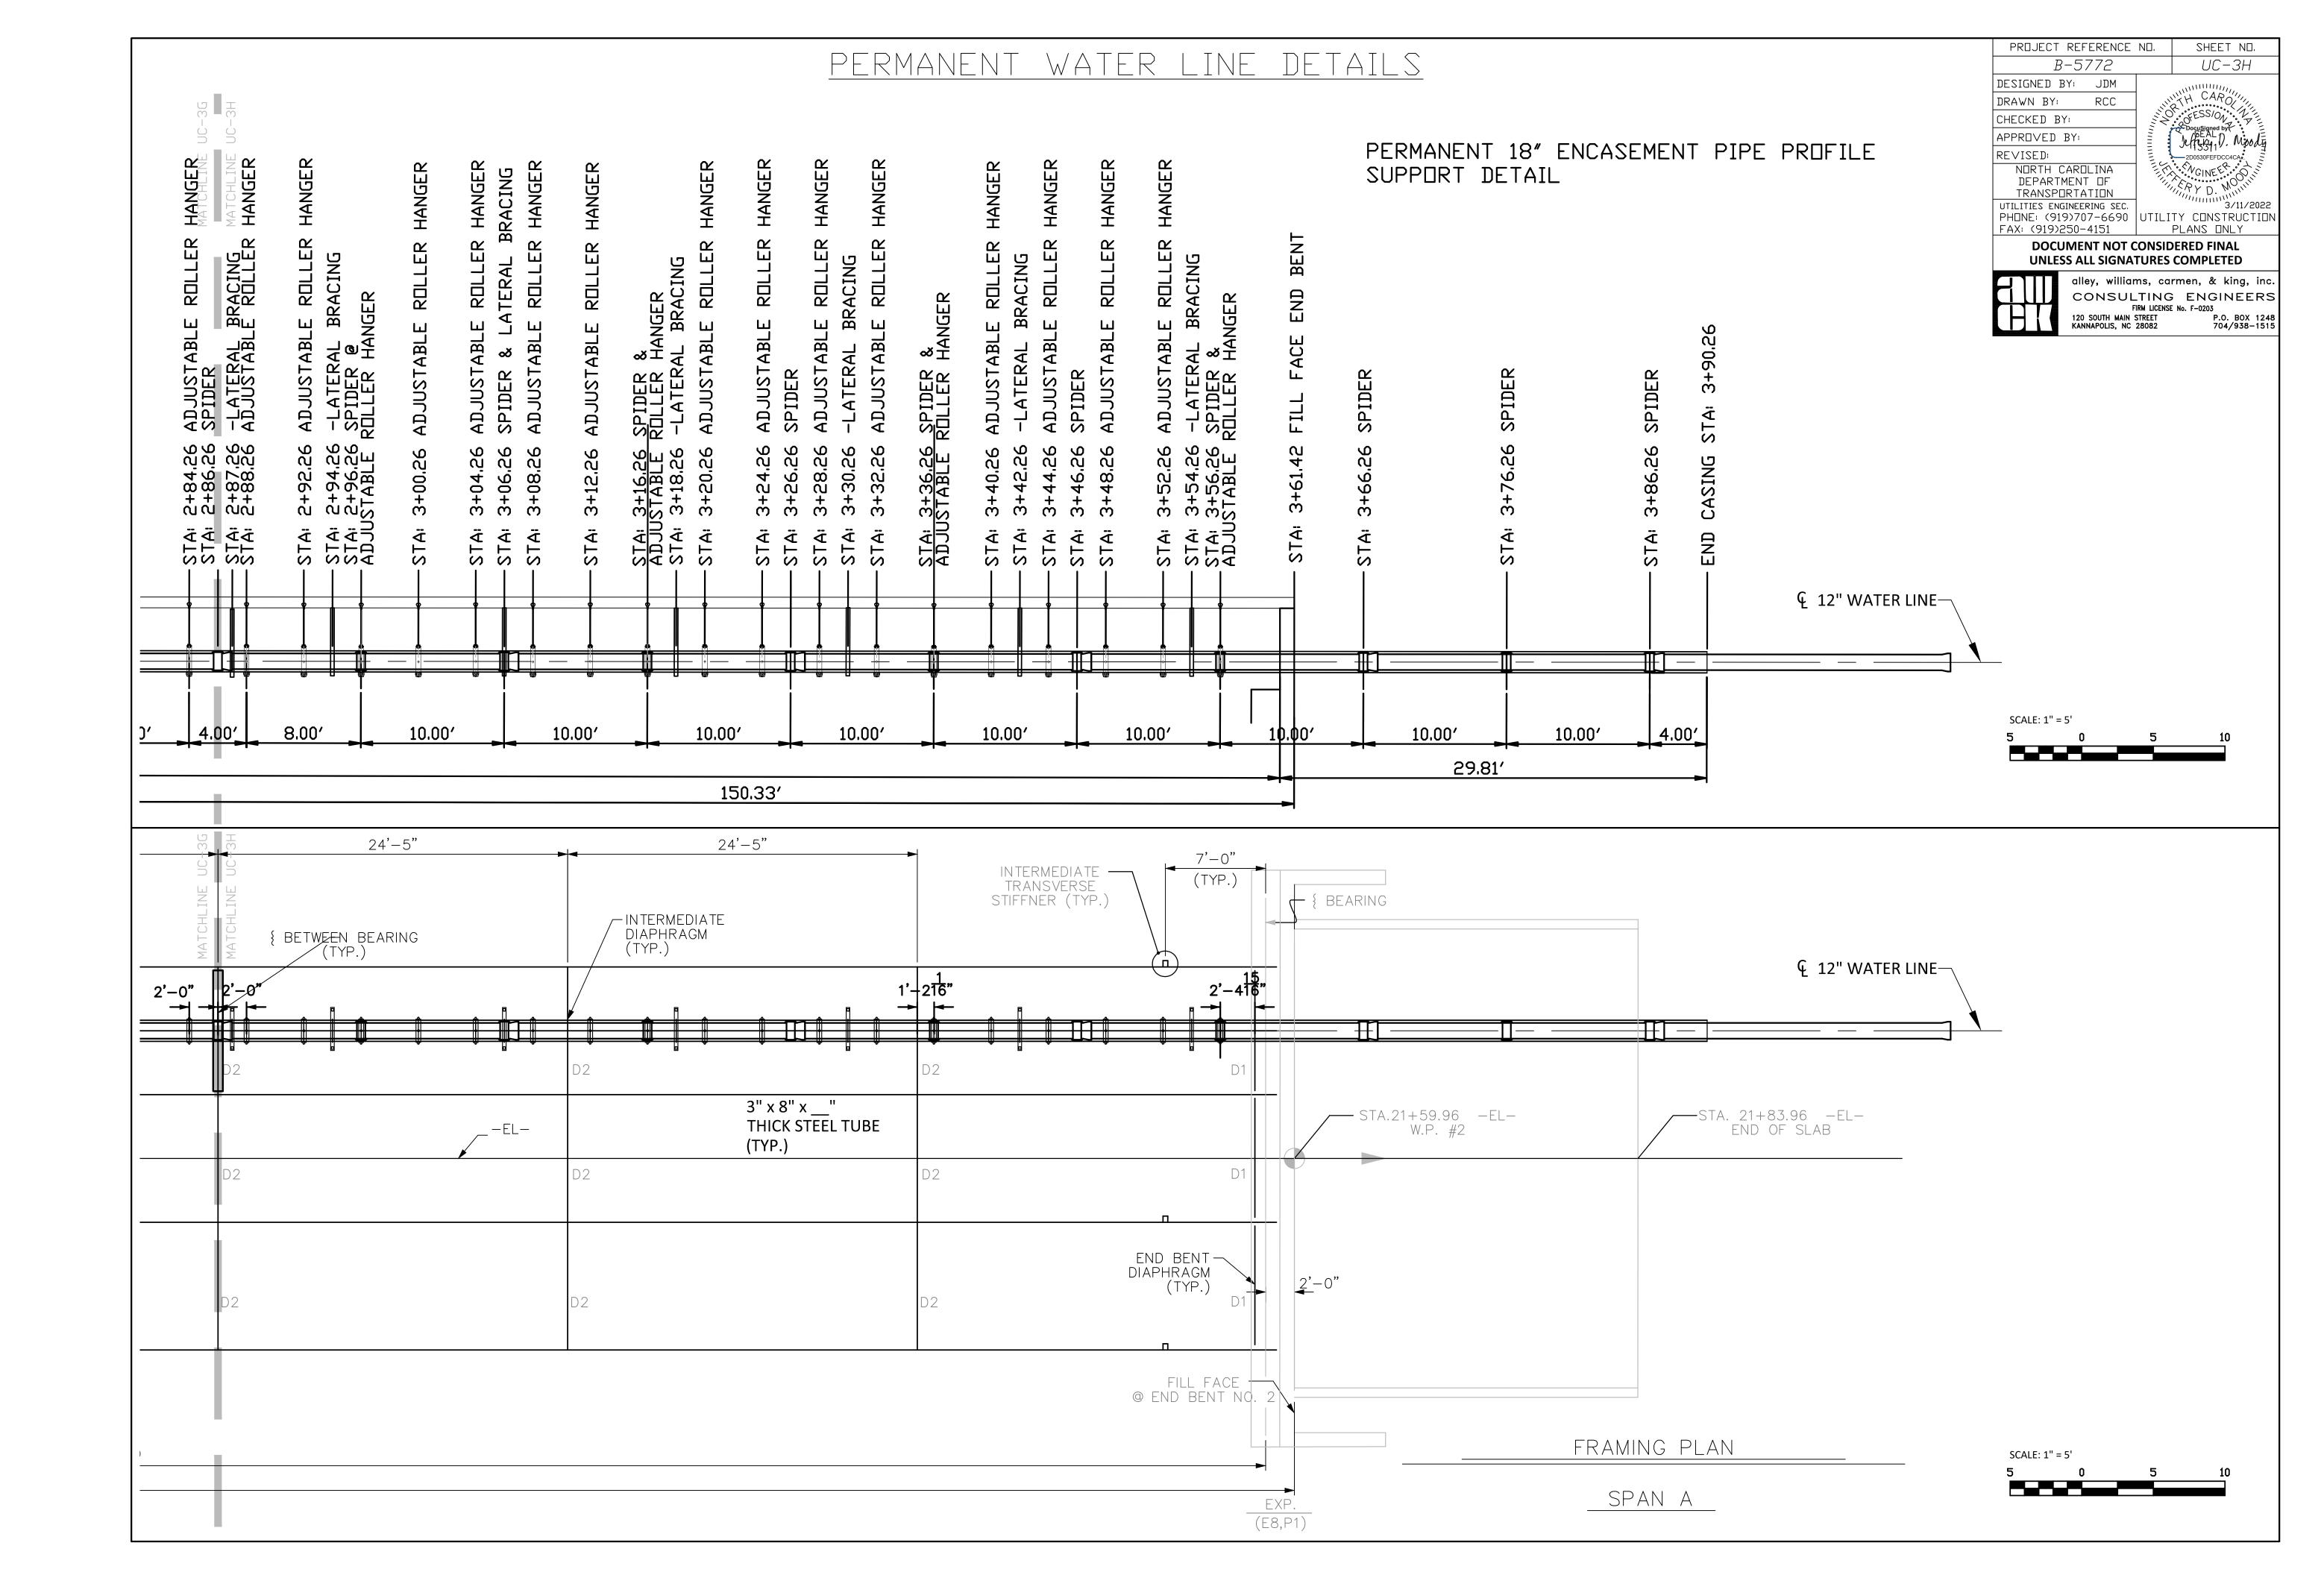

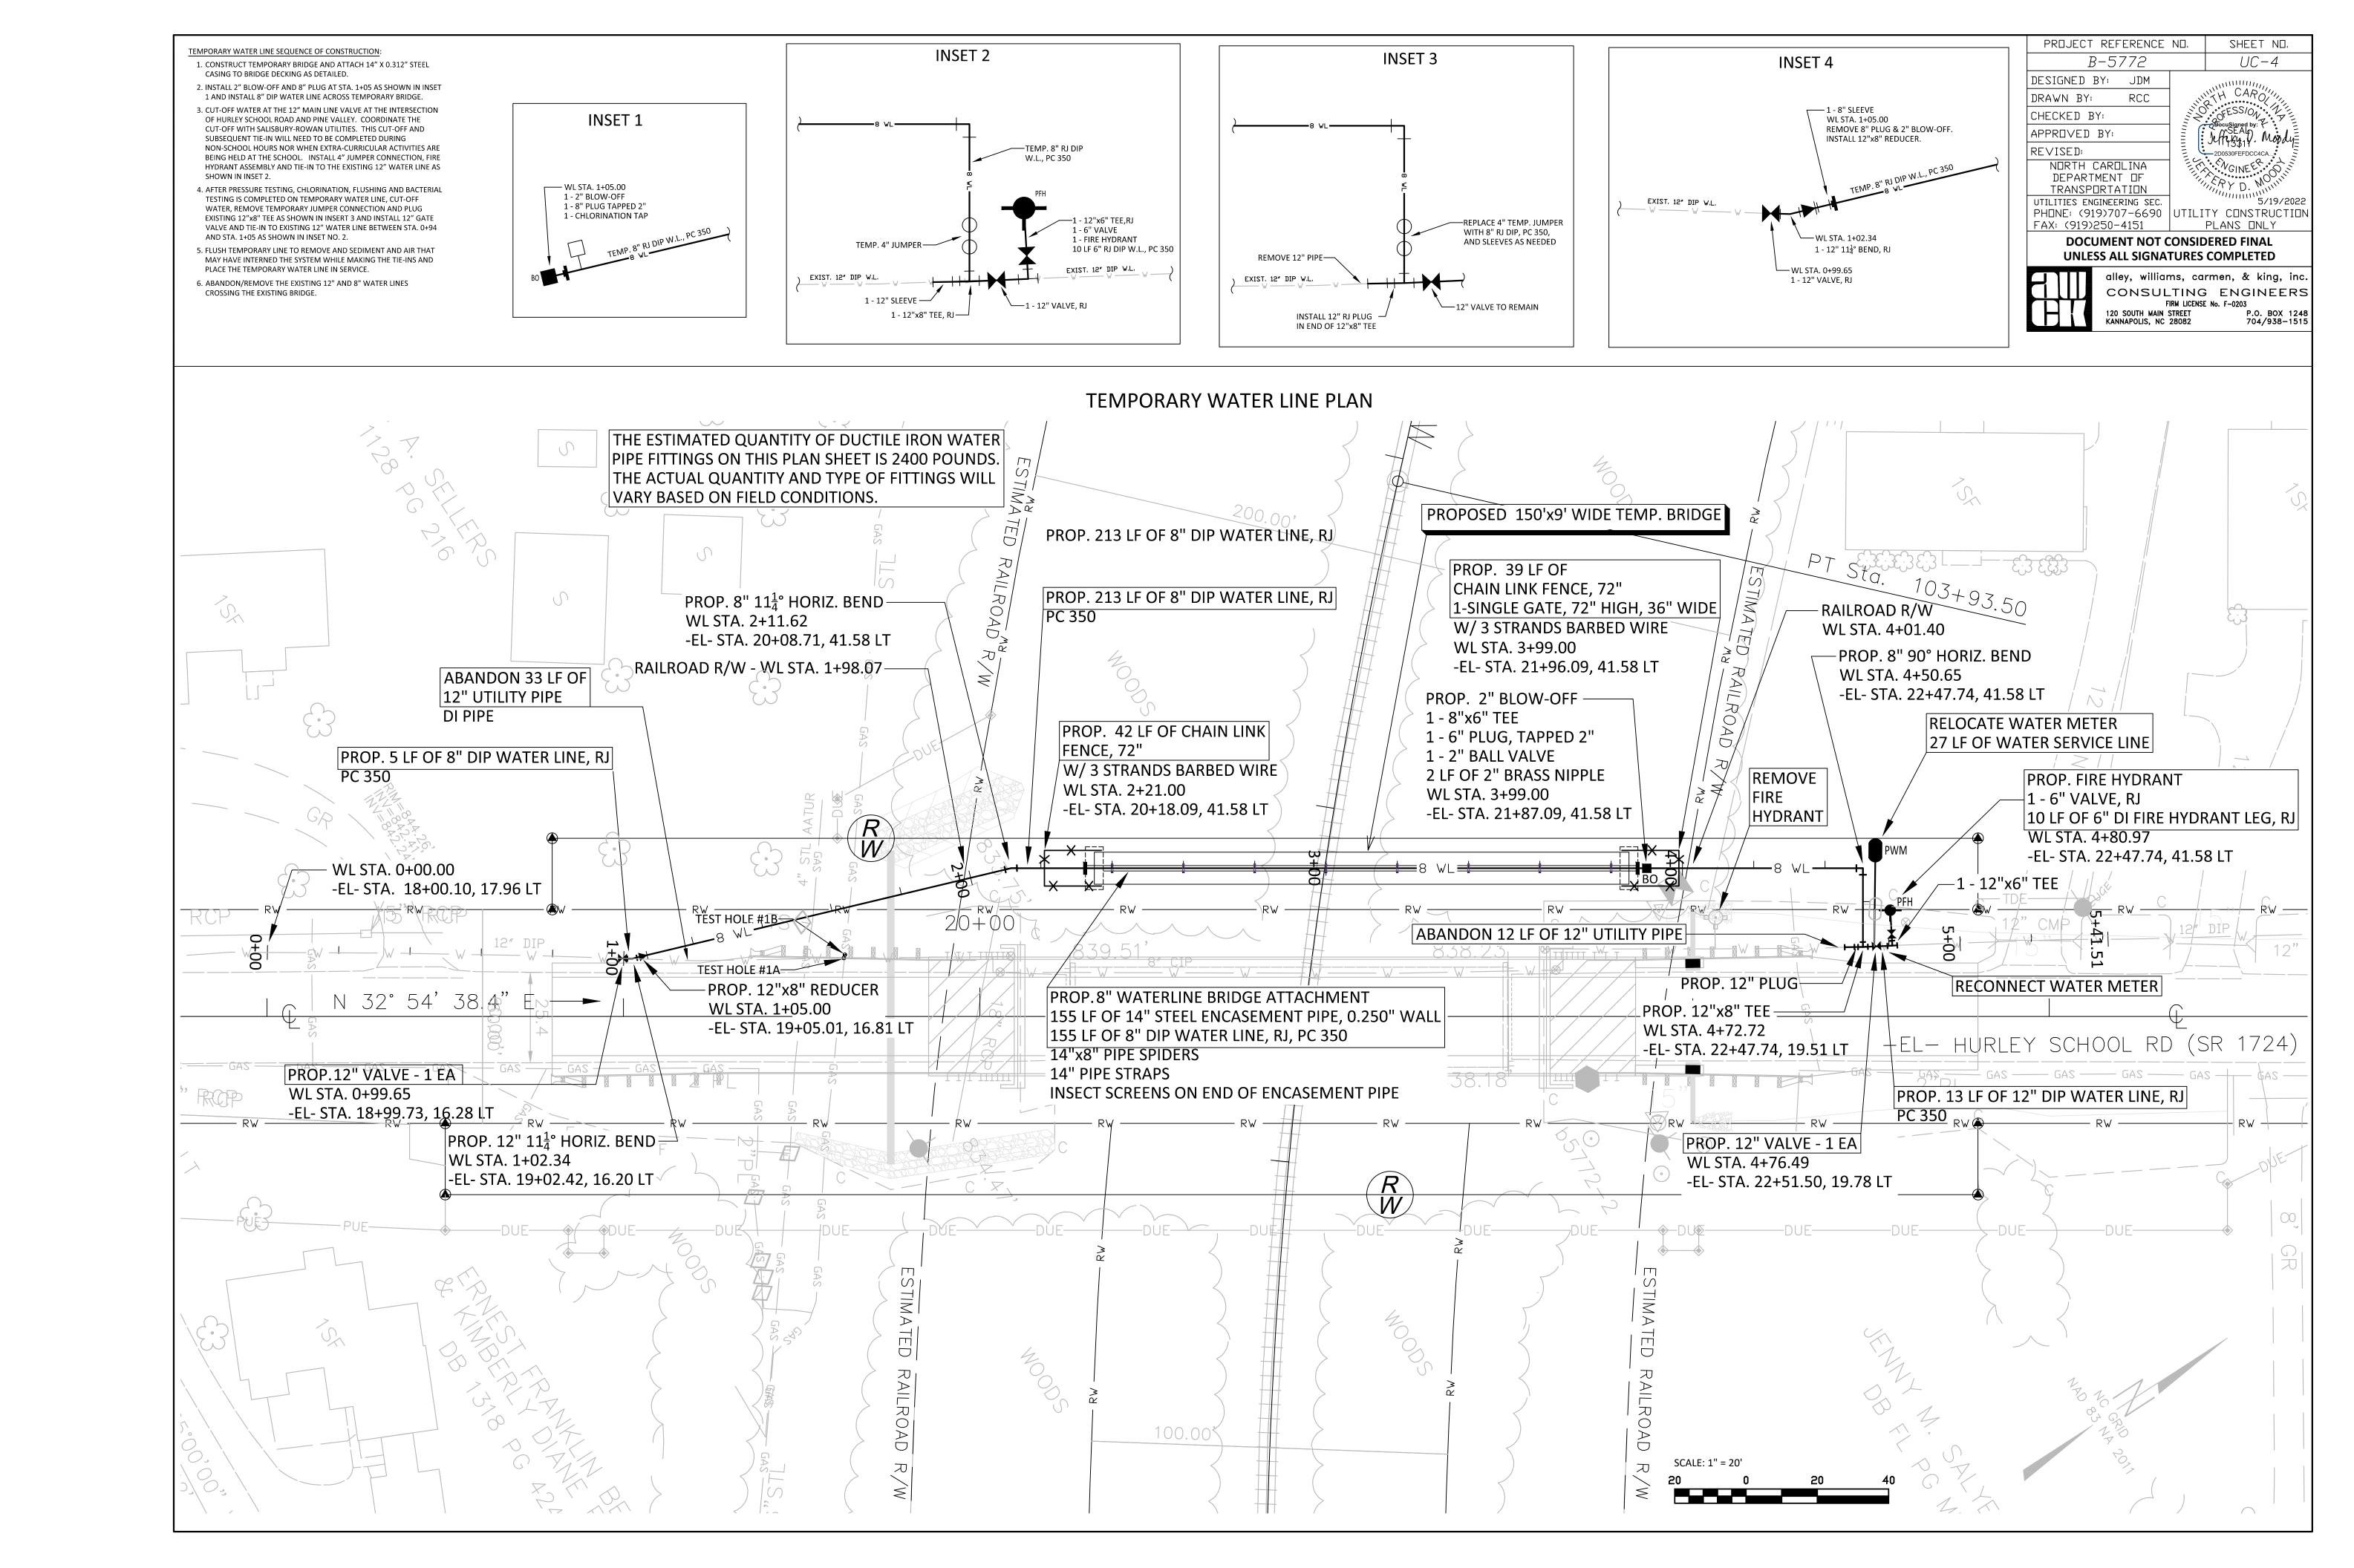

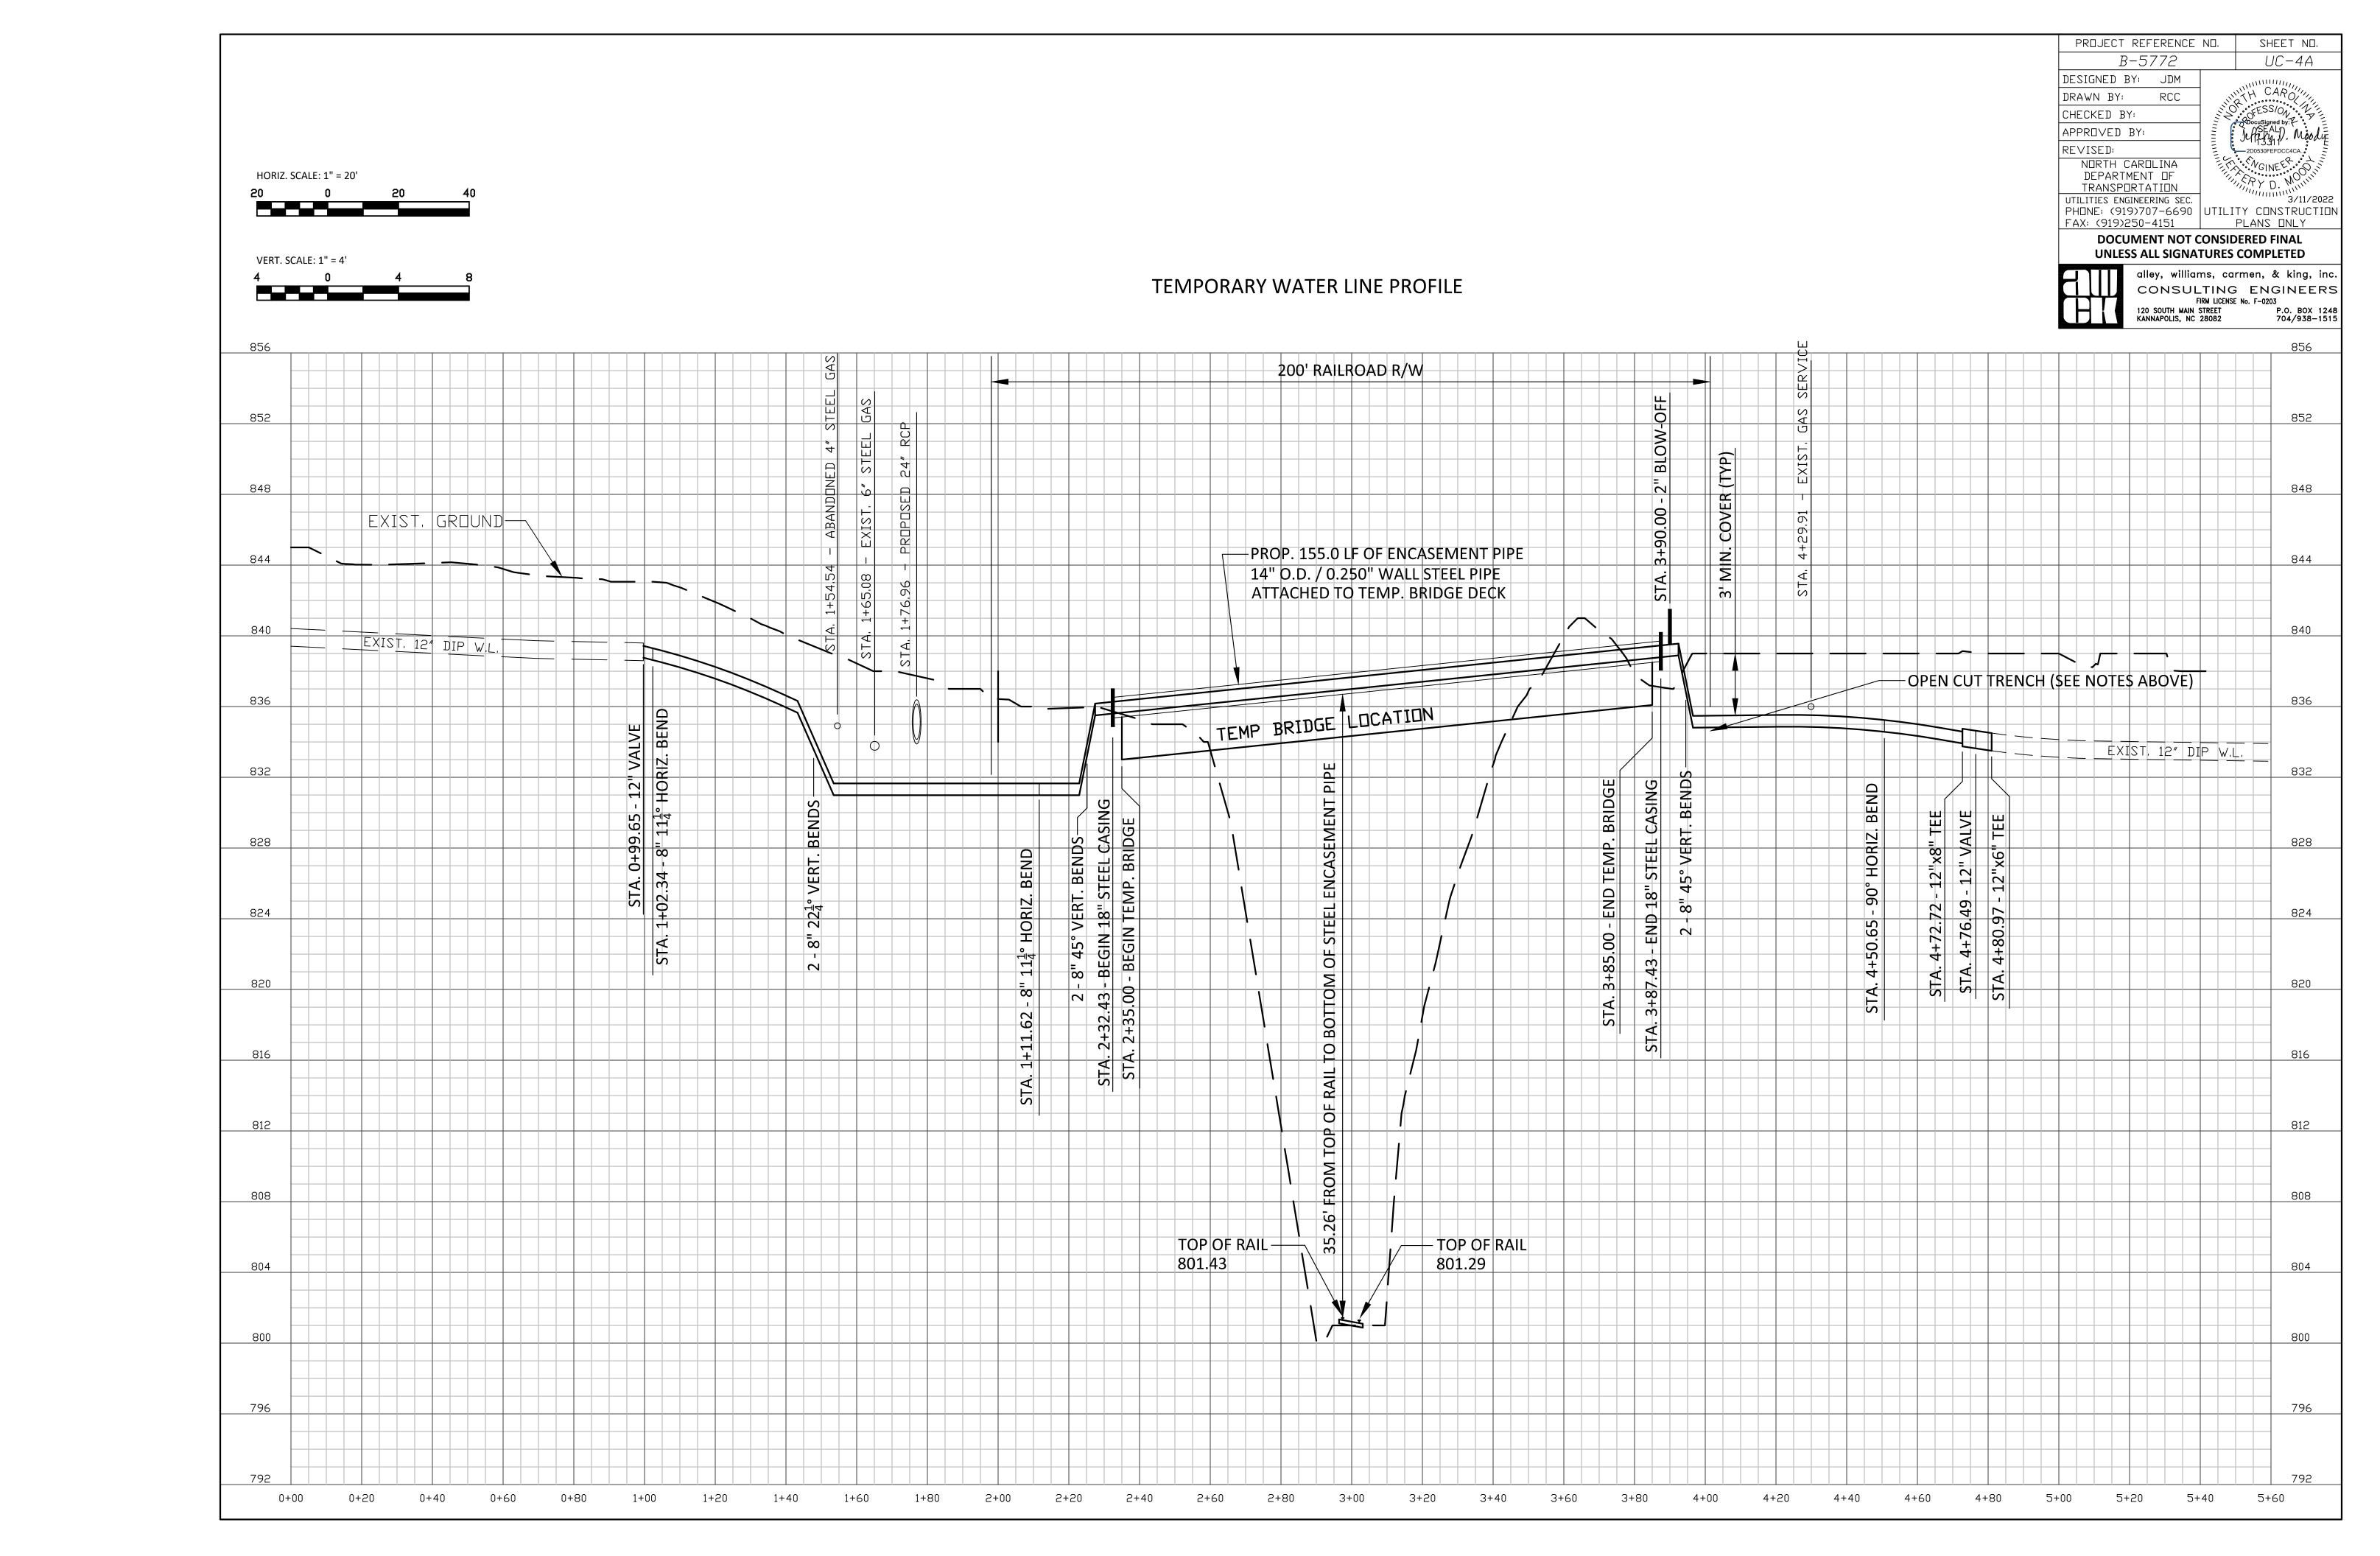

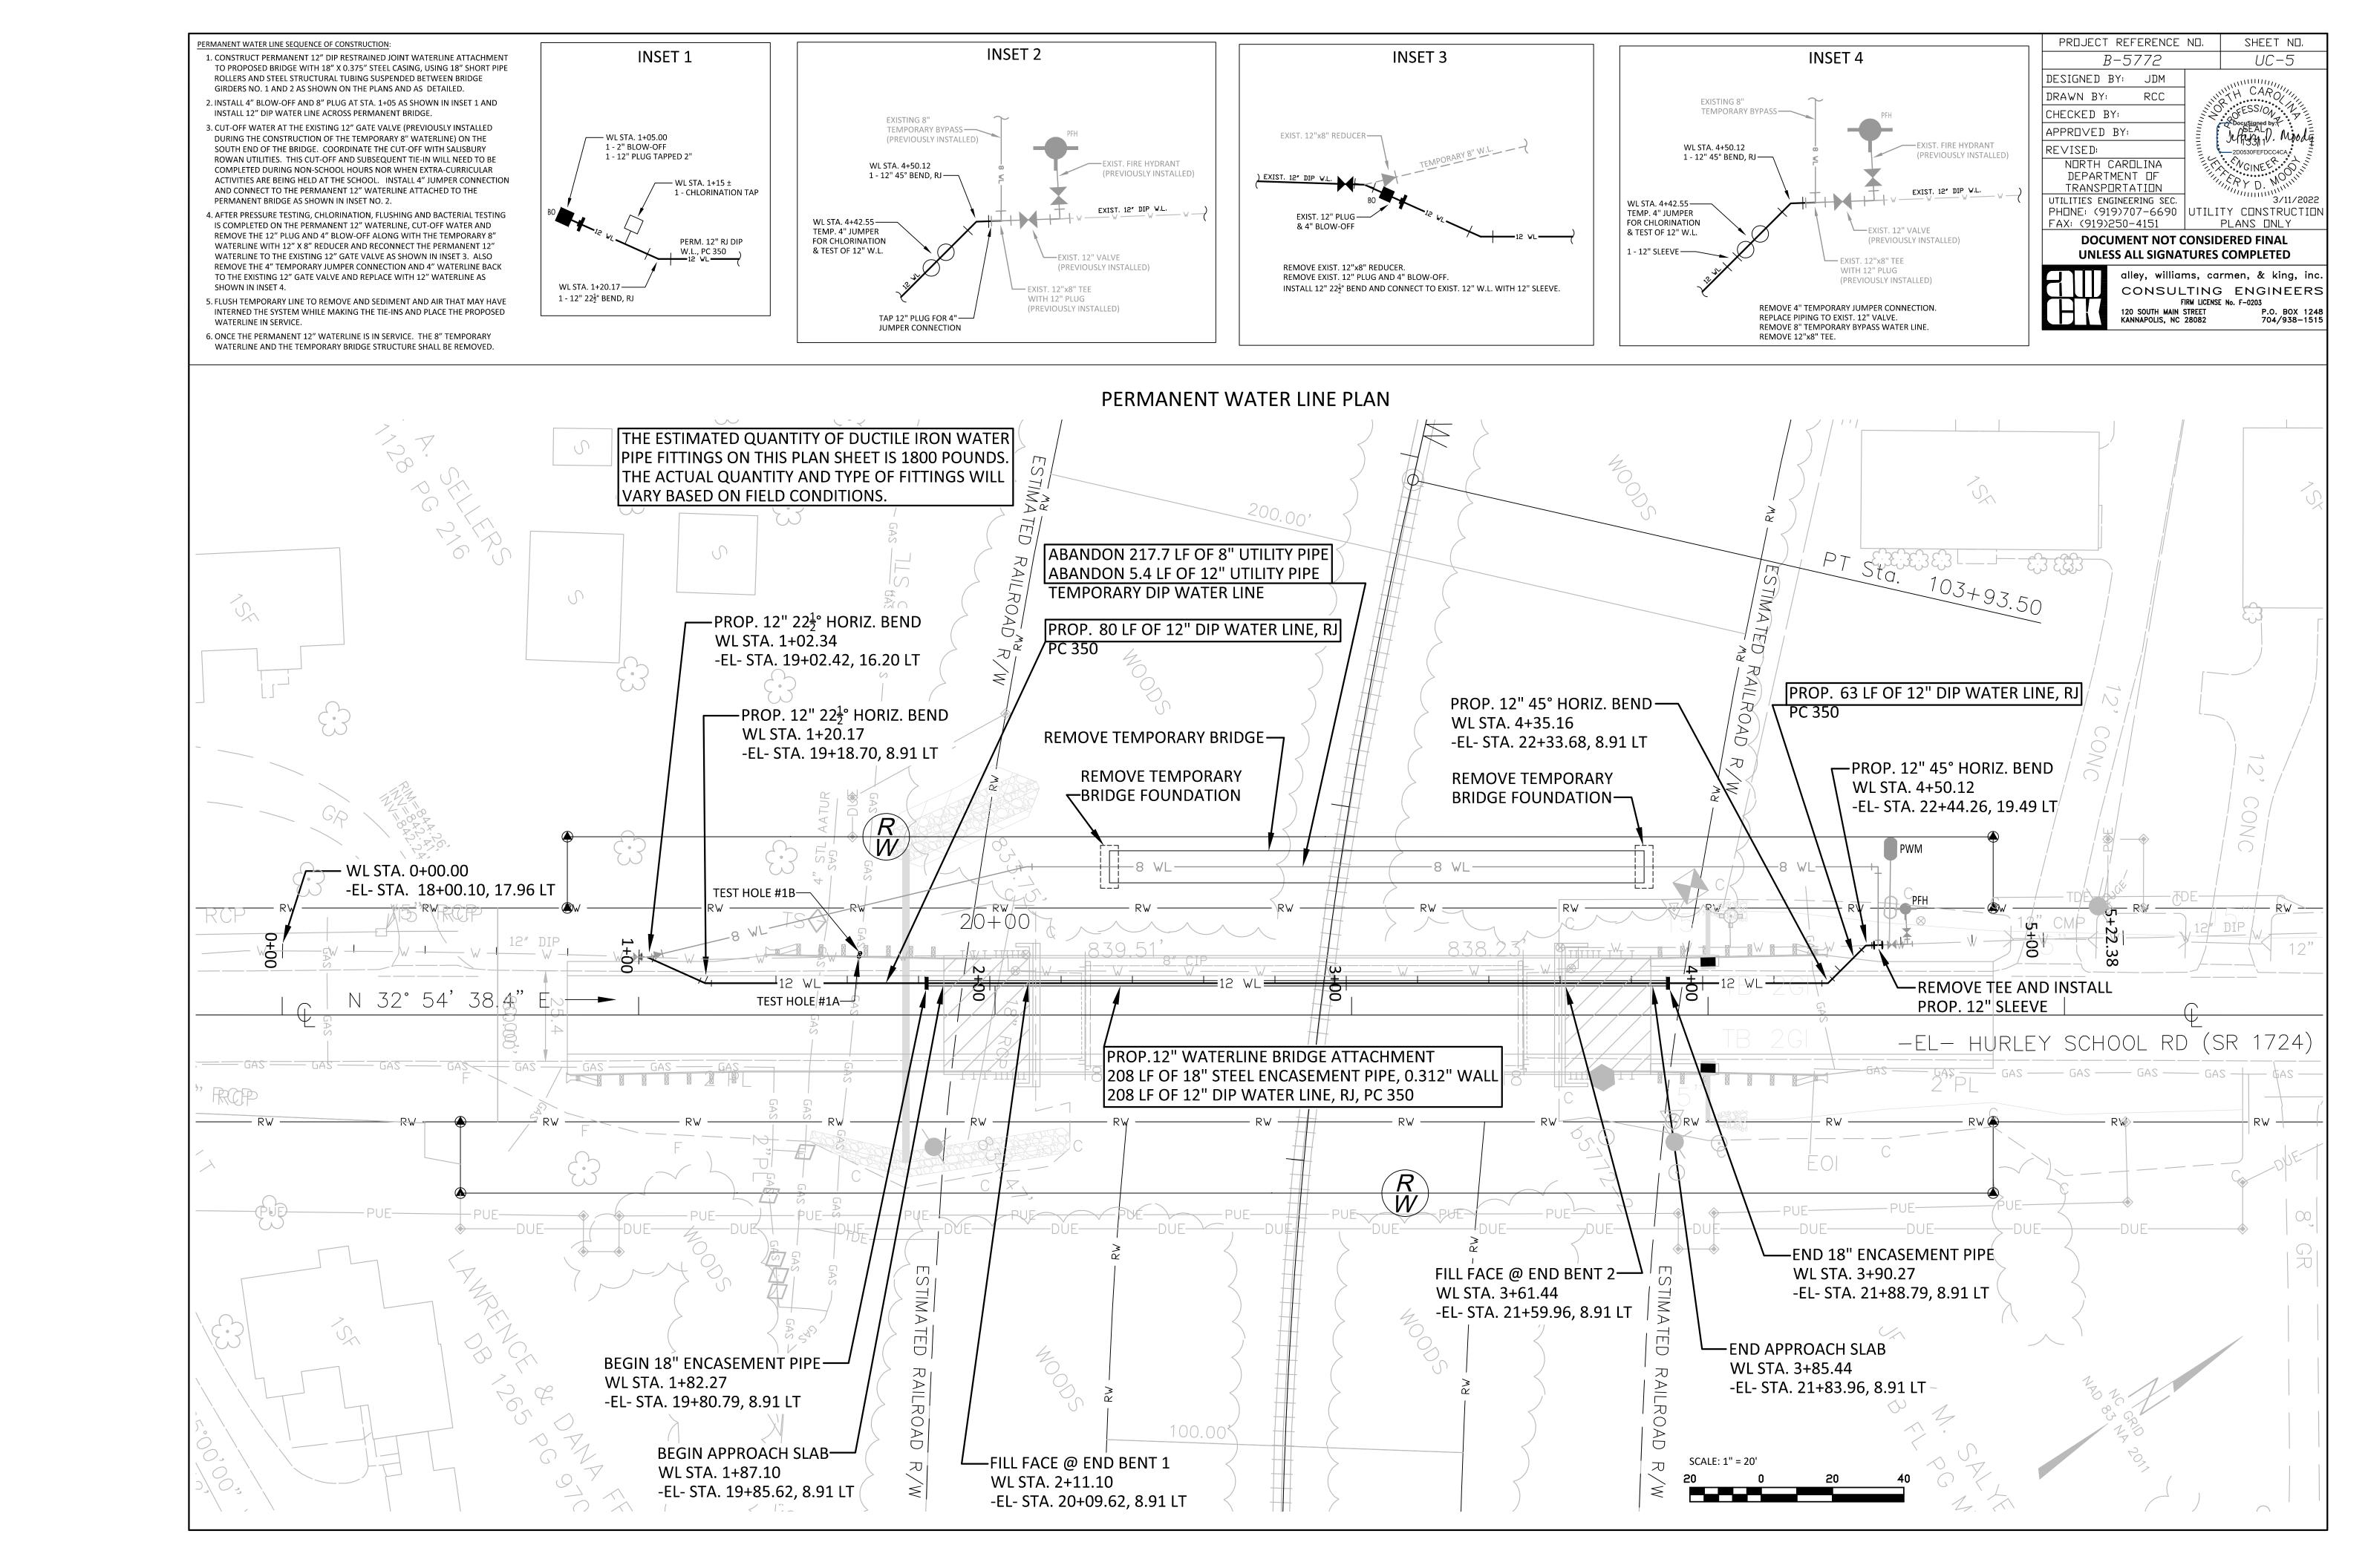

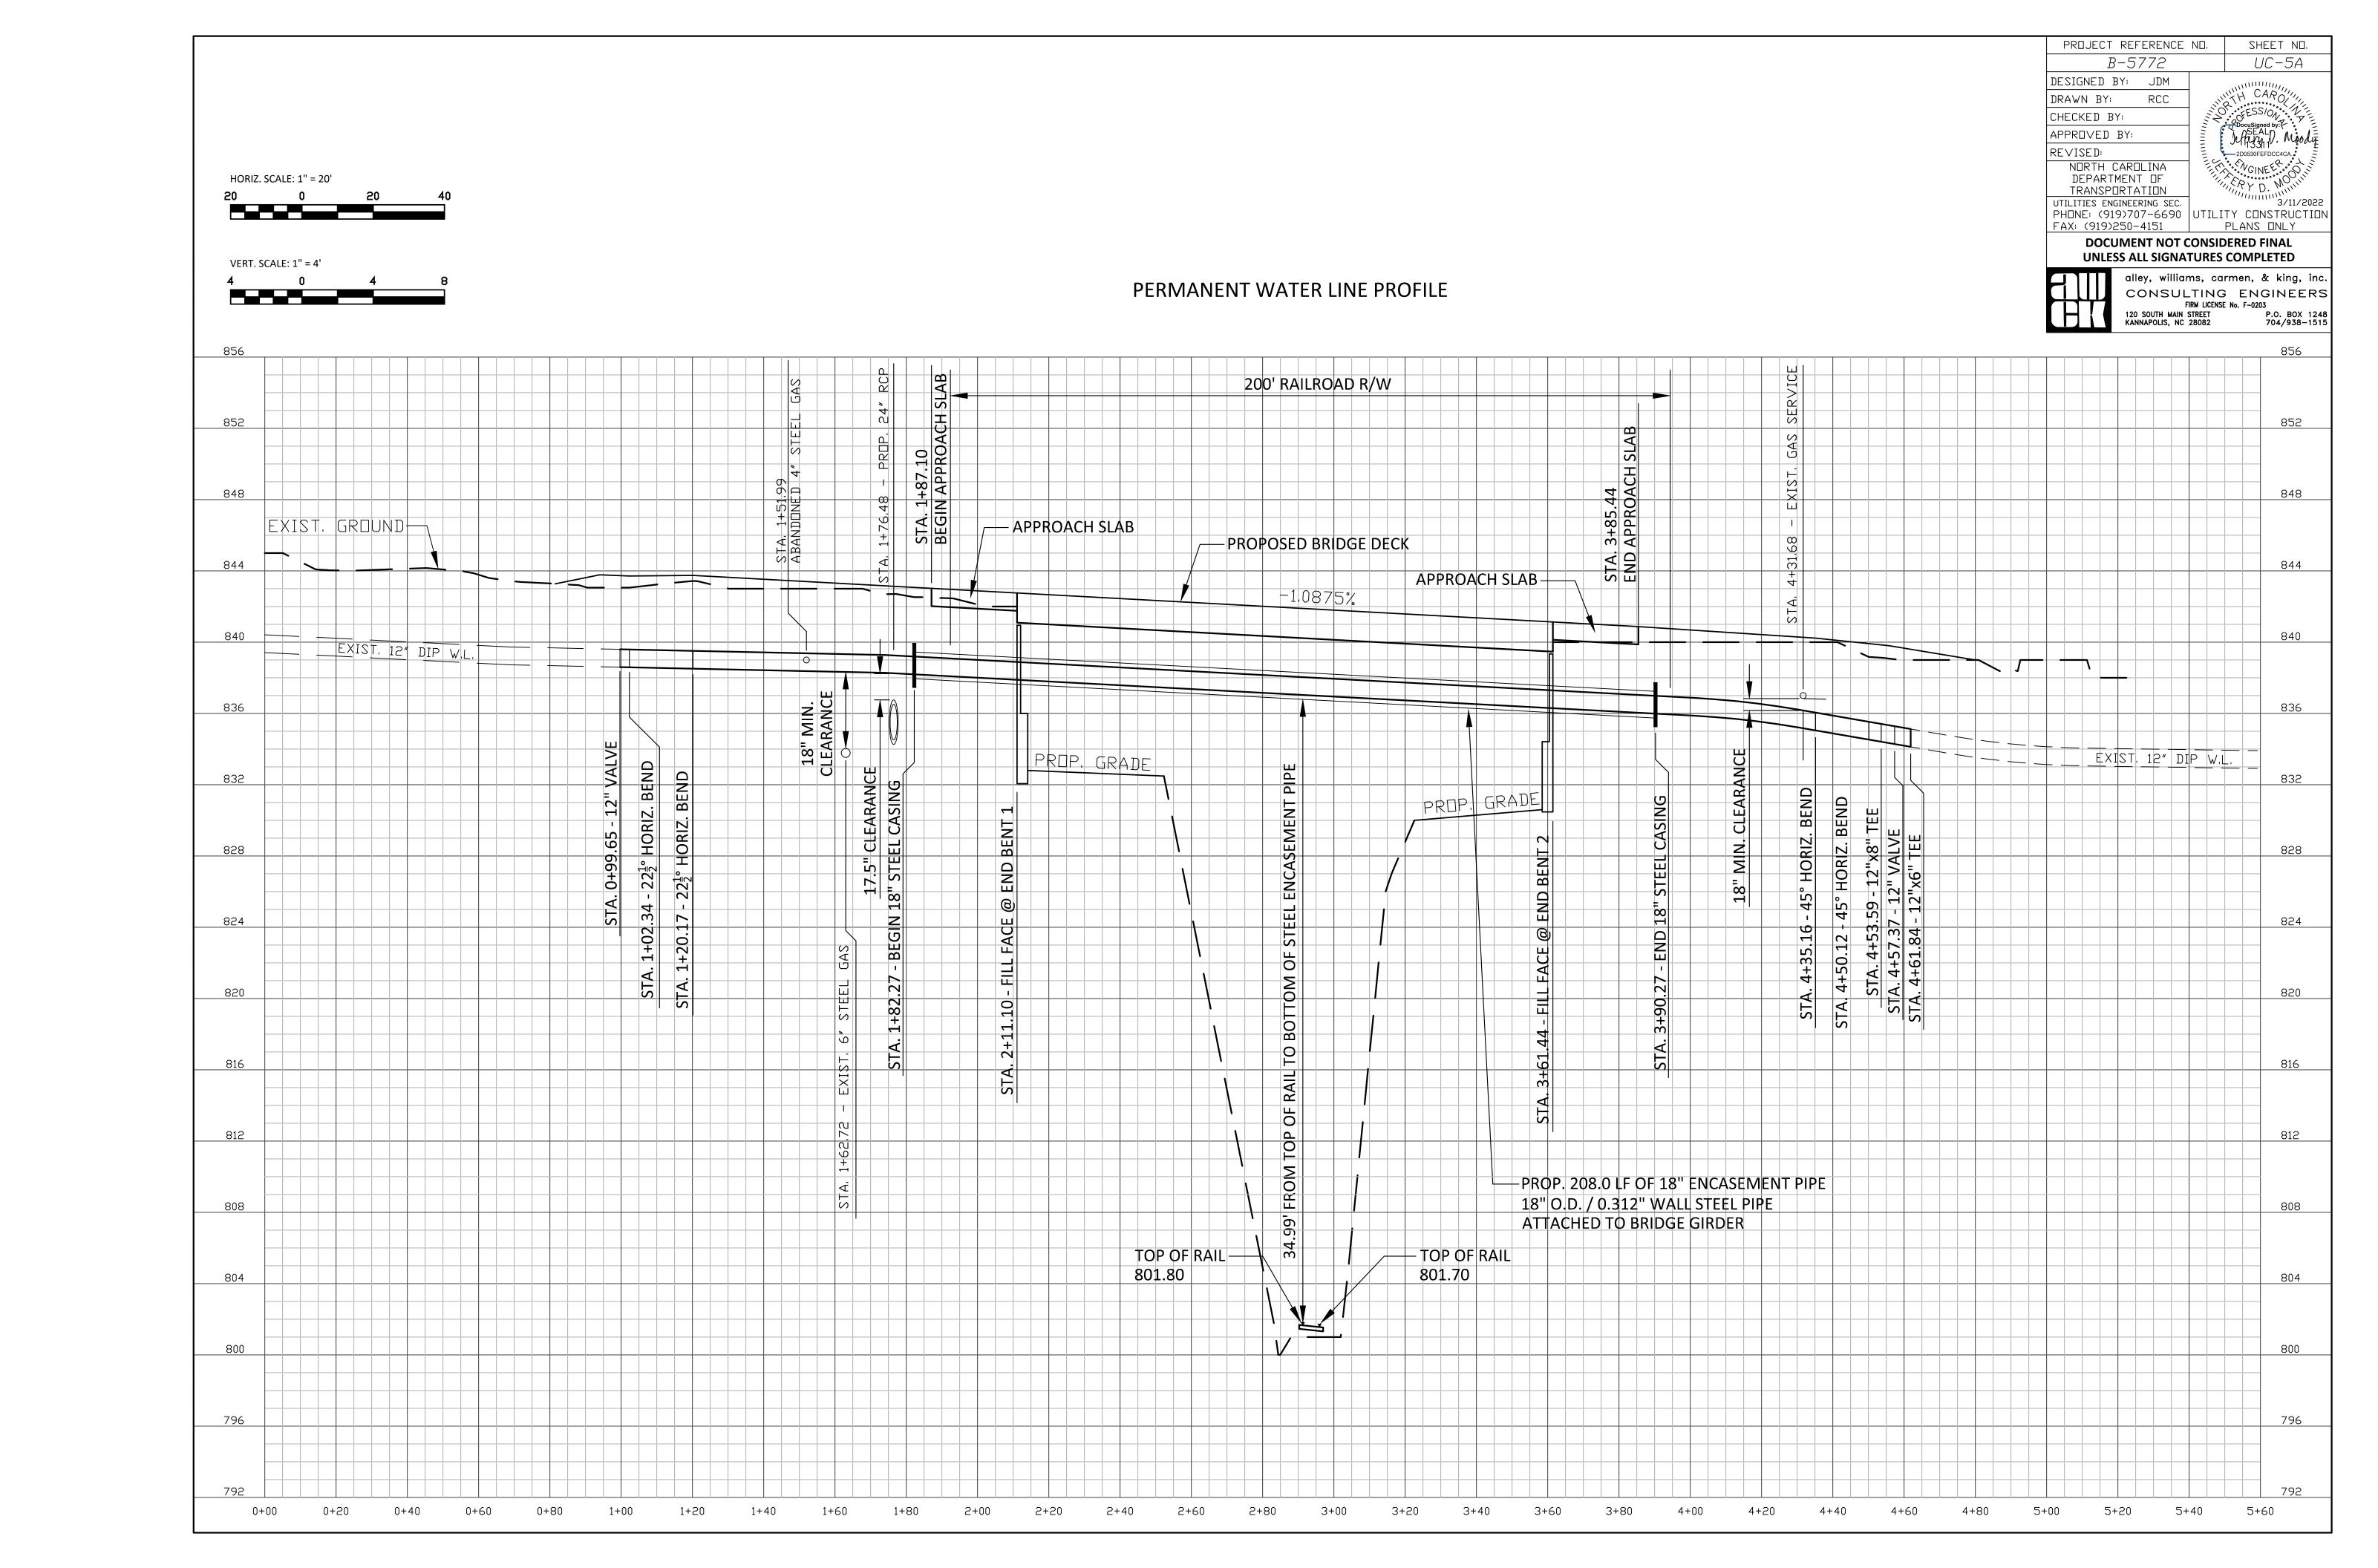

TEMPORARY BRIDGE FOR SUPPORT OF WATER LINE

THE BRIDGE STRUCTURE SHOWN ON THESE DRAWINGS IS FOR THE TEMPORARY SUPPORT OF THE WATER LINE THAT IS TO REMAIN IN SERVICE DURING THE CONSTRUCTION OF THE BRIDGE REPLACEMENT. THE DESIGN AND CONSTRUCTION OF THE TEMPORARY BRIDGE SHALL CONFORM TO THE FOLLOWING STANDARDS.

DESCRIPTIO

THE CONTRACTOR SHALL FURNISH DESIGN CALCULATIONS AND DRAWINGS REQUIRED; FURNISH MEMBERS AND DECK MATERIALS FOR STRUCTURES AND ANY OTHER MATERIALS NECESSARY; ERECT, MAINTAIN, REMOVE AND DISPOSE OF TEMPORARY STRUCTURES REQUIRED FOR THE MAINTENANCE OF THE WATER LINE AND FOR MAINTENANCE PERSONNEL ACCESS. THE BRIDGE STRUCTURE DOES NOT NEED TO BE DESIGNED FOR PEDESTRIAN, HIGHWAY AND OTHER TRAFFIC LOADINGS. CONSTRUCT TEMPORARY STRUCTURES IN ACCORDANCE WITH THE CONTRACT.

MATERIAL

USE MATERIALS FOR TEMPORARY STRUCTURES THAT CONFORM TO DIVISION 10 OR PREVIOUSLY USED MATERIALS CONFORMING TO THE CONTRACT. OBTAIN APPROVAL FOR THE USE OF SALVAGED MATERIALS AND MATERIALS NOT COVERED BY DIVISION 10 BEFORE

PLANS

- A. FURNISHING PLANS:
- USE THE PLANS FOR THE TEMPORARY STRUCTURE FURNISHED IN THESE DRAWINGS AND SUBMIT A DESIGN IN ACCORDANCE WITH PARAGRAPH B.
- 2. FOR ALL CONTRACTOR DESIGNS, FURNISH ONE SET OF DESIGN CALCULATIONS AND DETAIL DRAWINGS OF THE STRUCTURE IN ACCORDANCE WITH PARAGRAPH B.
- 3. SUBMIT DETAIL DRAWINGS AND DESIGN CALCULATIONS FOR TEMPORARY STRUCTURES FOR REVIEW AND COMMENT BEFORE BEGINNING WORK. DO NOT PERFORM ANY WORK UNTIL THE DETAIL DRAWINGS ARE REVIEWED AND ACCEPTED.

- ACCEPTANCE OF SUCH DRAWINGS DOES NOT RELIEVE THE CONTRACTOR OF ANY RESPONSIBILITY FOR SAFETY AND CONTINUOUSLY MAINTAINING SUPPORT FOR THE WATER LINE
- B. DESIGN REQUIREMENTS FOR CONTRACTOR FURNISHED DRAWINGS:
 PROVIDE TEMPORARY STRUCTURES OF SUCH CARRYING CAPACITY, DIMENSIONS, GRADES AND ALIGNMENT AS REQUIRED BY THESE DRAWINGS. DESIGN TEMPORARY STRUCTURE TO CARRYING THE UTILITY LOADS AND UNIFORM LIVE LOADS IN THE
- 2. UTILITY LOADING (WATER LINE + ENCASEMENT): 90 POUNDS PER LINEAR FOOT* UNIFORM LIVE LOADING: 20 POUNDS PER SQUARE FOOT

*UNIFORM LINE LOAD PLACED AT CENTERLINE OF BRIDGE

- 3. ENSURE AN ENGINEER LICENSED BY THE STATE OF NORTH CAROLINA DESIGNS AND DETAILS THE TEMPORARY STRUCTURE. CONSTRUCT THE TEMPORARY STRUCTURE IN ACCORDANCE WITH THIS DESIGN. THE DRAWINGS SHALL BE SEALED AND SIGNED BY THE DESIGN ENGINEER.
- 4. INDICATE IN THE PLANS, THE SPECIFICATIONS FOR THE MATERIALS USED IN THE TEMPORARY STRUCTURE.
- 5. FOUNDATIONS SHALL BEAR ON RESIDUAL SOIL OR ENGINEERED FILL HAVING A MINIMUM NET ALLOWABLE BEARING CAPACITY OF 2,000 PSF. THE CONTRACTOR SHALL HAVE THE FOUNDATION BEARING SOILS VERIFIED BY AN INDEPENDENT TESTING COMPANY PRIOR TO CASTING CONCRETE.

CONSTRUCTION METHOD

FOLLOWING MAGNITUDES:

 CONSTRUCT AND MAINTAIN TEMPORARY STRUCTURE TO ADEQUATELY AND SAFELY CARRY SPECIFIED LOADING DURING THE ENTIRE PERIOD FOR WHICH THEY ARE REQUIRED.

- 2. REMOVE AND DISPOSE OF THE TEMPORARY STRUCTURES AFTER THEY ARE NO LONGER REQUIRED IN ACCORDANCE WITH THE SECTION BELOW.
- 3. UPON REMOVAL OF THE TEMPORARY STRUCTURE, ALL MATERIAL FURNISHED BY THE CONTRACTOR FOR USE IN THIS STRUCTURE SHALL REMAIN THE PROPERTY OF THE CONTRACTOR UNLESS OTHERWISE PROVIDED IN THE CONTRACT.
- 4. UNLESS OTHERWISE SPECIFIED IN THE CONTRACT, REMOVE TEMPORARY PILING TO THE STREAMBED LEVEL OR TO ONE FOOT BELOW EXISTING GROUND.

MEASUREMENT AND PAYMENT 1. THE PRICE AND PAYMENT BELOW WILL BE FULL COMPENSATION FOR ALL WORK

- 2. THE WORK COVERED BY THIS SECTION WILL BE PAID AT THE CONTRACT LUMP SUM PRICE FOR 8" TEMPORARY WATER LINE BRIDGE ATTACHMENT.
- 3. PAYMENT WILL BE MADE UNDER:
- PAY ITEM PAY UNIT 8" TEMPORARY WATERLINE BRIDGE ATTACHMENT LUMP SUM

REQUIRED TO PROVIDE TEMPORARY STRUCTURES.

REMOVAL OF TEMPORARY STRUCTURES

- 1. EXCAVATE AS NECESSARY TO REMOVE THE STRUCTURE; DISMANTLE, SALVAGE AND STOCKPILE MATERIALS AND COMPONENTS OF THE TEMPORARY STRUCTURE.
- 2. MAINTAIN ACCESS AND SUPPORT OVER THE TEMPORARY STRUCTURE IN ACCORDANCE WITH DIVISION 11 UNLESS OTHERWISE STIPULATED BY THE CONTRACT. COMPLY WITH THE POSTED LOAD LIMITS OF THE TEMPORARY STRUCTURE. THE MAINTENANCE OF THE TEMPORARY STRUCTURE IS THE RESPONSIBILITY OF THE CONTRACTOR.

- 3. USE APPROVED METHODS AND OPERATIONS FOR REMOVAL OF THE TEMPORARY STRUCTURE. UPON REMOVAL, ALL MATERIALS BECOME THE PROPERTY OF THE CONTRACTOR UNLESS OTHERWISE INDICATED IN THE CONTRACT. DISPOSE OF WASTE AND DEBRIS FROM THE TEMPORARY STRUCTURE IN ACCORDANCE WITH SECTION 802.
- 4. PERFORM REMOVAL OPERATIONS WHILE PREVENTING DAMAGE TO ADJACENT PROPERTY. PROTECT NEW CONSTRUCTION DURING OTHER OPERATIONS NECESSARY FOR THE REMOVAL OF THE TEMPORARY STRUCTURE.
- 5. UNLESS OTHERWISE REQUIRED BY THE CONTRACT, REMOVE TEMPORARY SUBSTRUCTURE DOWN TO ONE FOOT BELOW THE NATURAL GROUND SURFACE. REMOVE THE SUBSTRUCTURE AS NECESSARY TO AVOID INTERFERENCE WITH CONSTRUCTION OF THE PROPOSED STRUCTURE.
- 6. THE CONTRACTOR SHALL BE RESPONSIBLE FOR FURNISHING, THE DESIGN OF, ERECTING, AND REMOVING ANY TEMPORARY SHORING AND BRACING DURING CONSTRUCTION (INCLUDING SUPPORT OF ALL EXCAVATIONS).
- 7. ALL SAFETY REGULATIONS SHALL BE STRICTLY FOLLOWED. WITH THE EXCEPTION OF SPECIFIC DIRECTION PROVIDED IN THE CONSTRUCTION DOCUMENTS HEREIN, THE ENGINEER SHALL NOT HAVE CONTROL OR CHARGE OF AND SHALL NOT BE RESPONSIBLE FOR CONSTRUCTION MEANS, METHODS, TECHNIQUES, SEQUENCES OR PROCEDURES FOR SAFETY PRECAUTIONS AND PROGRAMS IN CONNECTION WITH THE WORK, FOR ACTS OF OMISSIONS OF THE CONTRACTOR, SUBCONTRACTORS, OR ANY OTHER PERSONS PERFORMING ANY OF THE WORK IN ACCORDANCE WITH THE CONTRACT DOCUMENTS.
- 8. THE CONTRACTOR SHALL PROTECT FROM DAMAGE EXISTING BUILDING(S), OWNER EQUIPMENT, ROADS, WALKS, AND UTILITIES. HE SHALL MAINTAIN THEM DURING THE COURSE OF WORK AND REPAIR ALL DAMAGES AT HIS OWN EXPENSE.

PROJECT REFERENCE NO. SHEET NO. B-5772 UC-6A DESIGNED BY: NEA DRAWN BY: JDC/JRM CHECKED BY: APPROVED BY: REVISED: NORTH CAROLINA DEPARTMENT OF TRANSPORTATION UTILITIES ENGINEERING SEC. PHONE: (919)707-6690 UTILITY CONSTRUCTION FAX: (919)250-4151 PLANS ONLY


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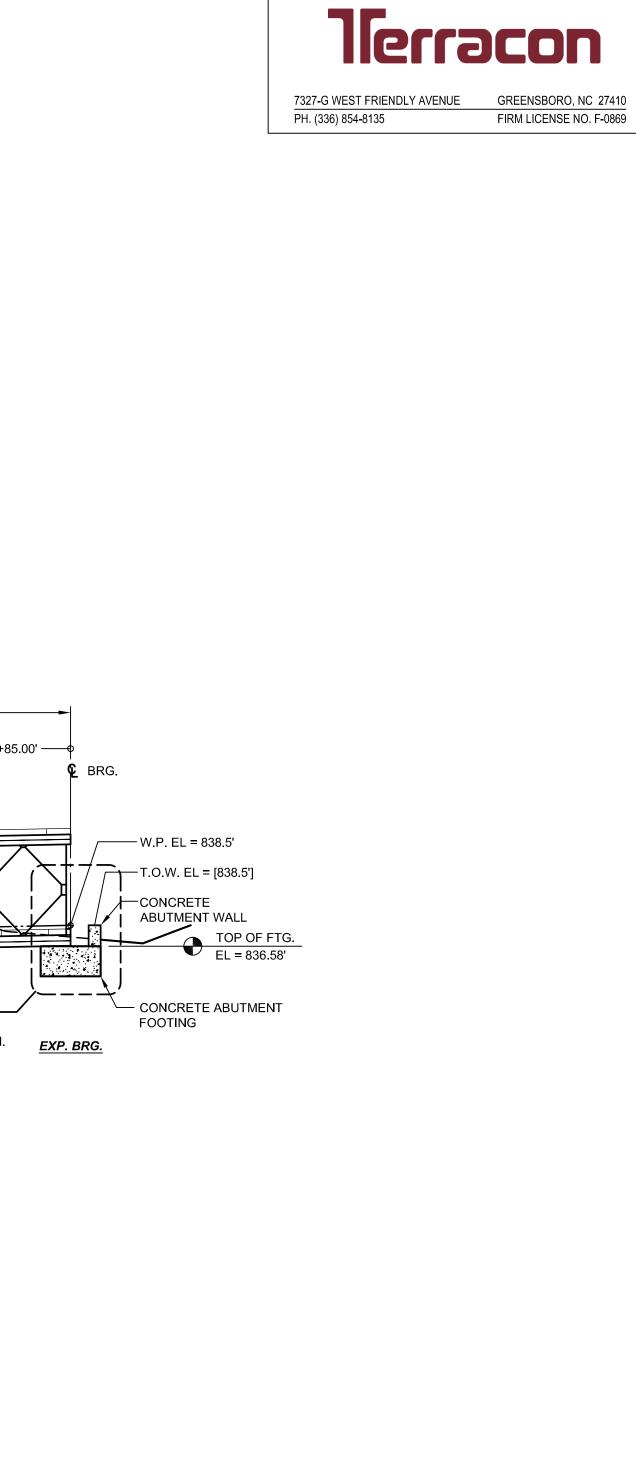
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7327-G WEST FRIENDLY AVENUE GREENSBORO, NC 27410
PH. (336) 854-8135 FIRM LICENSE NO. F-0869





PROJECT REFERENCE NO.

B-5772

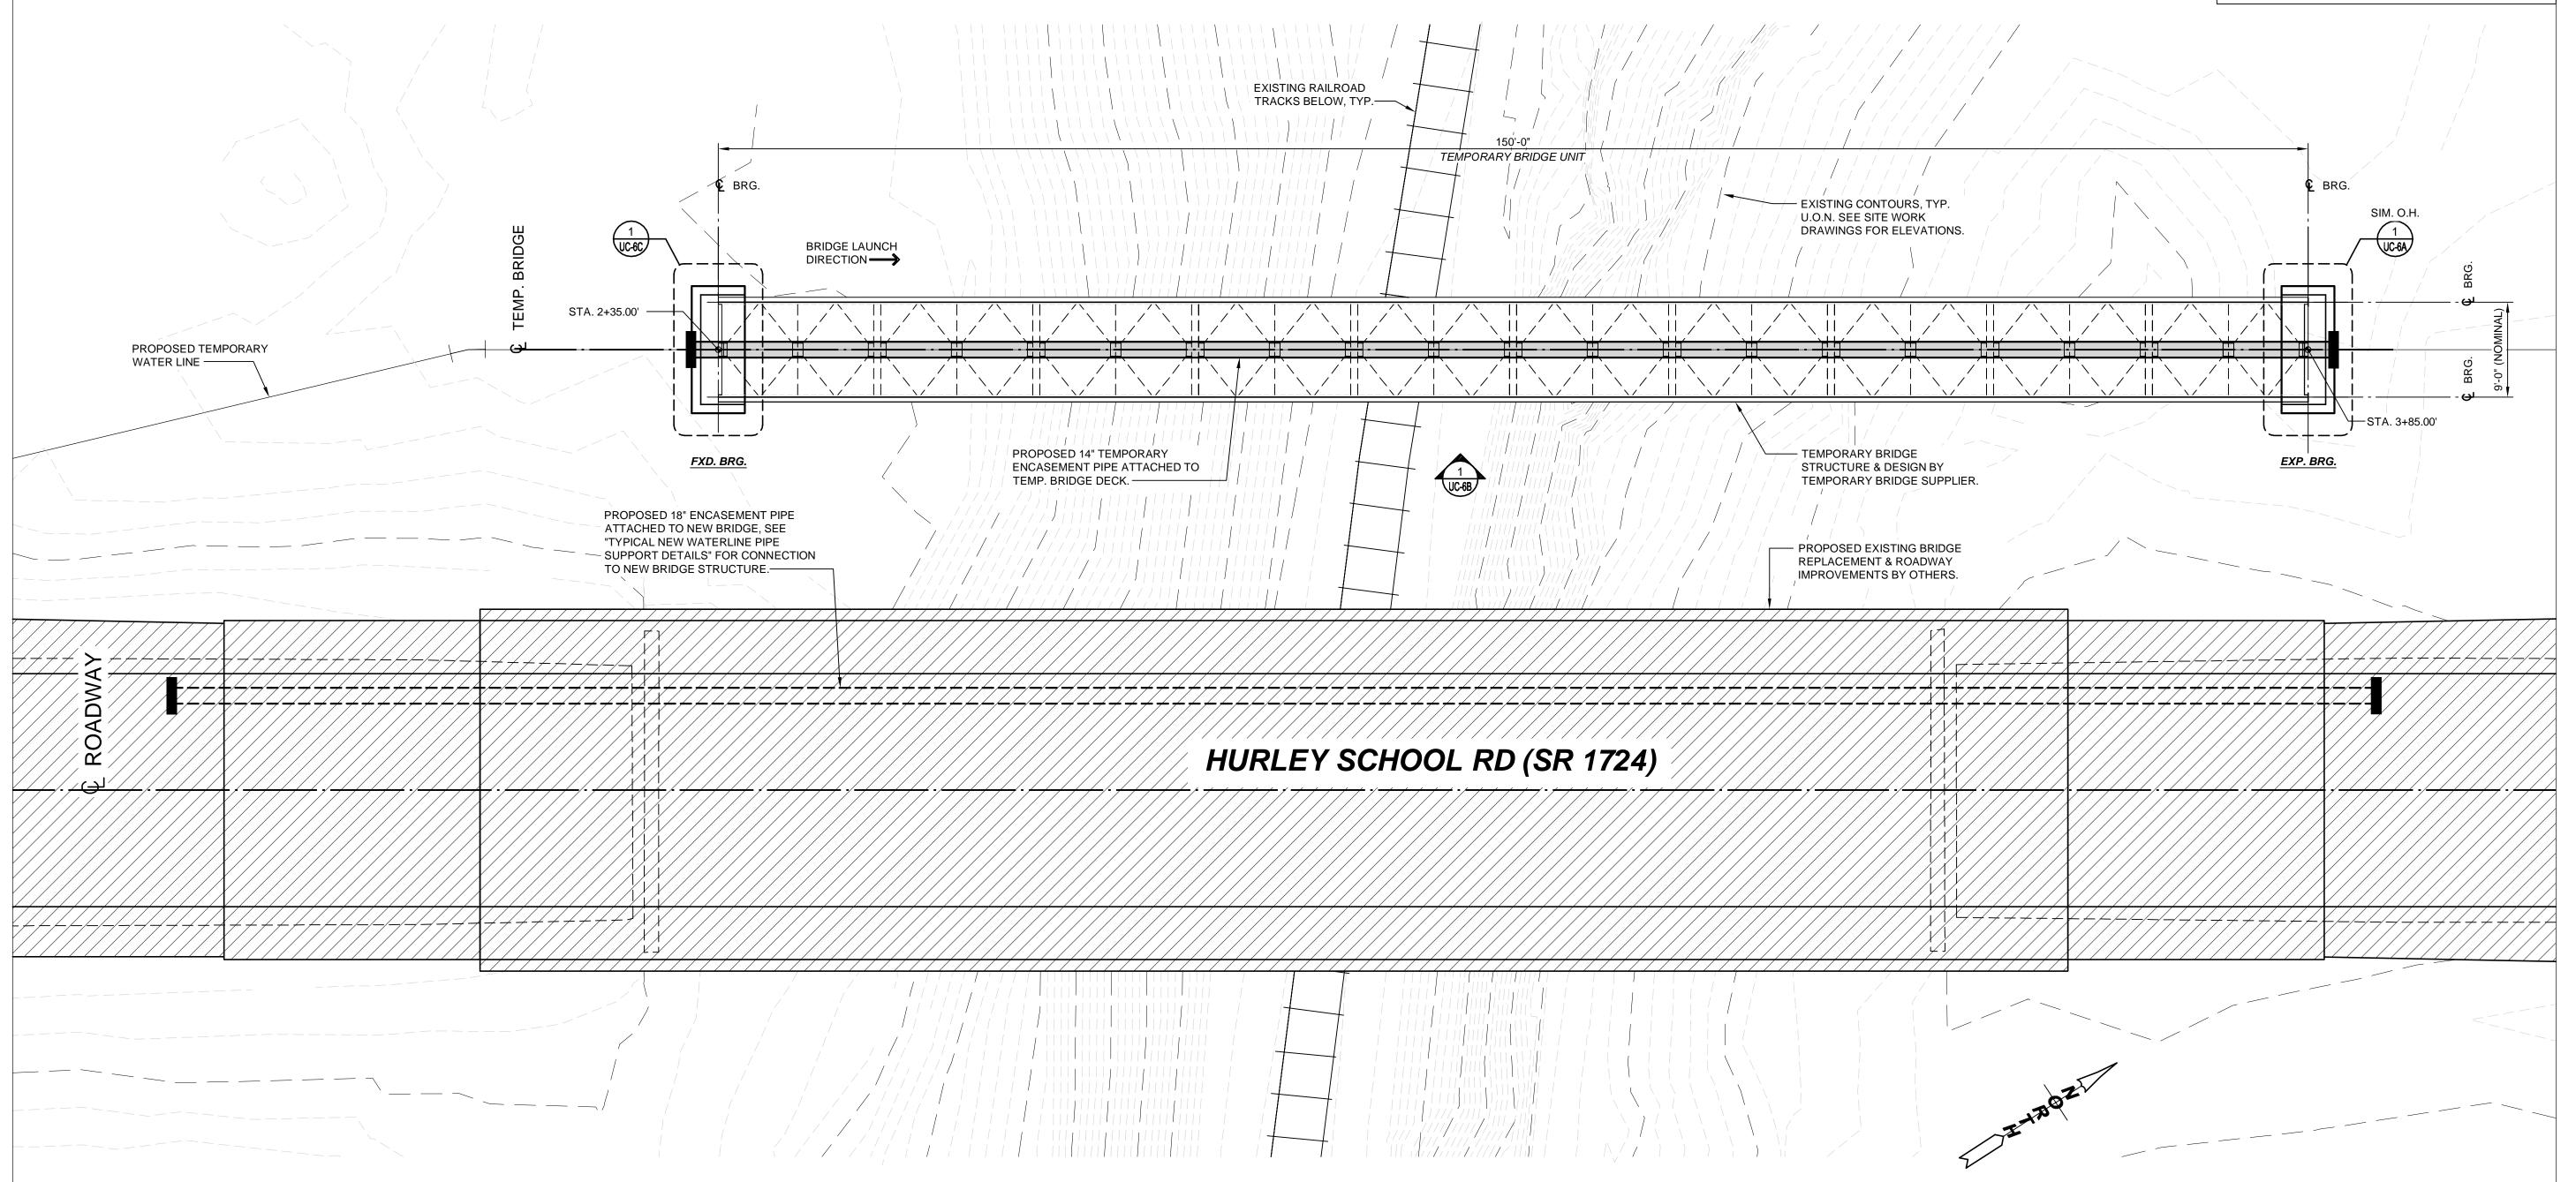DESIGNED BY: RGK

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FIRM LICENSE No. F-0203

120 SOUTH MAIN STREET P.O. BOX 1248
KANNAPOLIS, NC 28082 704/938-1515


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CHECKED BY:
APPROVED BY:

SHEET NO.

UC-6B



TEMPORARY WATERLINE SUPPORT BRIDGE

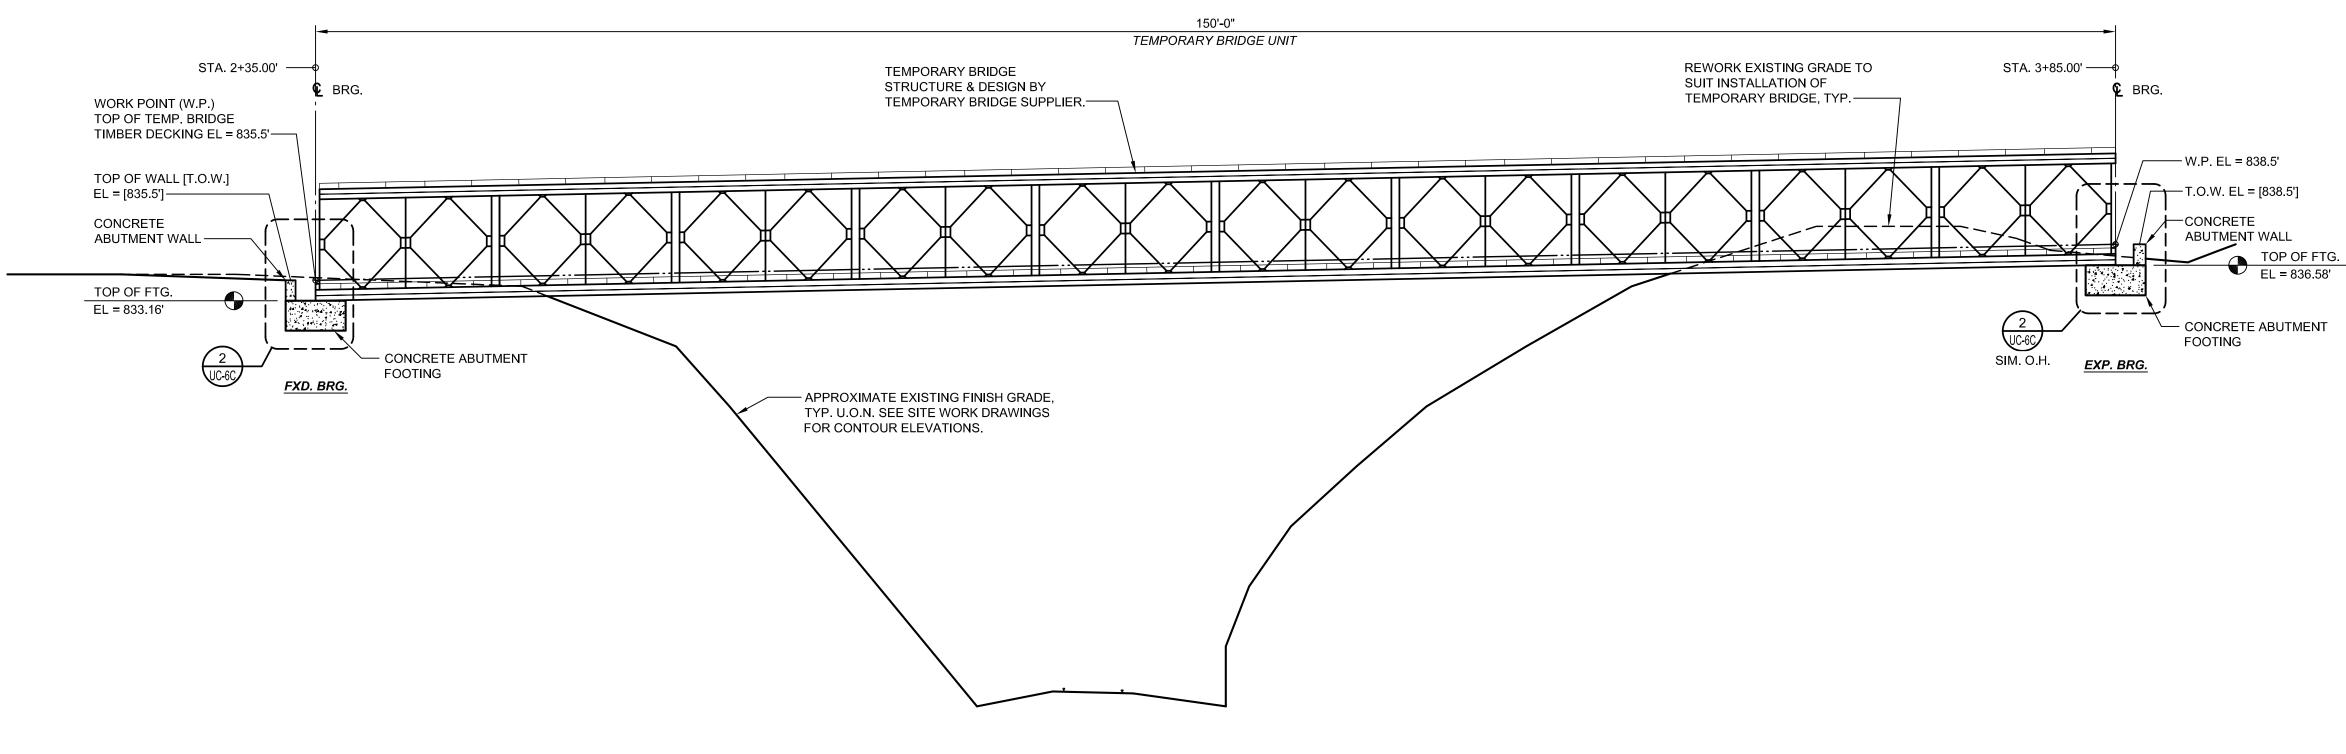ELEVATION

1/8" = 1'-0"
FY216011-ELEV

UC-6B

