


		PEDESTAL FOUND	OITAC	N T	YPE /	AND S	SIZE	
Г				SIZE		ANCHOR	INSTALL	
	TYPE	PEDESTAL DESCRIPTION	DIAMETER "A" FT	DEPTH "B" FT	CONCRETE VOLUME CY	DIAMETER (MIN.) IN	LENGTH FT-IN	GROUNDING SYSTEM (YES/NO)
	I	PEDESTRIAN PUSHBUTTON	2'-0"	3'-6"	.41	1/2	1'-6"	NO
	II	NORMAL-DUTY	2'-0"	5'-0"	.58	3⁄4	2'-0"	YES
	III	2'-6"	7'-0"	1.27	1	4'-0"	YES	

REIN					=OF	ORCING STEEL SCHEDULE							
V-BAR					STIRRUP								
						QUANTITY							
TYPE				<u> </u>		VERTICAL	SPACING			DIAMETER	OVERI AP	WETOUT	TOTAL
1111	SIZE	QTY	LENGTH	WEIGHT		ON 6"	ON 12"		LENGTH		MIN.	WEIGHT	STEE
	#	<u> </u>		LBS	#	CENTERS	CENTERS	TOTAL		FT		LBS	LBS
I	8	6	3'-0"	56	4	0	4	4	5'-7"	1'-6"	0'-10"	15	71
II	8	6	4'-6"	86	4	5	3	8	5'-7"	1'-6"	0'-10"	30	116
III	8	6	6'-6"	122	4	7	4	11	7'-2"	2'-0"	0'-10"	53	175

See Plate for Title

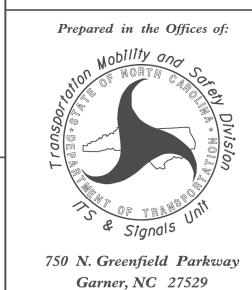

SHEET 1 OF 1

1743D01

SEAL

SEAL

O28094

SEAL

O28094

OCINEER

Docusigned by:

Dubush C. Sarkar

10/11/2017

DIVISION OF HIGHWAYS DIVISION 11 DIVISION 9 DIVISION 7 DIVISION 5 WIND ZONE 4 & 5 WIND ZONE 4 WIND ZONE 4 WIND ZONE 4 DIVISION 13 WIND ZONE 4 & 5 GUILFORD ALAMANCE ORANGE RANDOLPH LINCOLN DIVISION 12 RICHMOND WIND ZONE 4 DIVISION 14 WIND ZONE 4 & 5 DIVISION 10 WIND ZONE 4 DIVISION 8 WIND ZONE LEGEND WIND ZONE 4 - COLUMBUS WIND ZONE 1 (140 mph) Special Wind Zone DIVISION 6 WIND ZONE 2 (130 mph) Coastal Region WIND ZONE 3 WIND ZONE 3 (110 mph) Eastern Region WIND ZONE 4 (90 mph) Central & Mtn. Region [WIND ZONE 5 (120 mph) Special Wind Zone https://connect.ncdot.gov/resources/safety/Pages/ITS-Design-Resources.aspx INDEX OF PLANS **NCDOT CONTACTS:** Prepared in the Offices of: Designed in conformance **DRAWING** with the latest **DESCRIPTION NUMBER** MOBILITY AND SAFETY DIVISION - ITS AND SIGNALS UNIT 2015 Interim to the 6th Edition 2013 Sig. M 1 Statewide Wind Zone Map M.M. MCDIARMID, P.E. - STATE ITS AND SIGNALS ENGINEER **AASHTO** Typical Fabrication Details-All Metal Poles Sig. M 2 Sig. M 3 Typical Fabrication Details-Strain Poles J. P. GALLOWAY, P.E. - STATE SIGNALS ENGINEER Standard Specifications for Typical Fabrication Details-Mast Arm Poles Sig. M 4 Typical Fabrication Details-Mast Arm Connection Structural Supports for **Sig.** M 5

Typical Fabrication Details-Strain Pole Attachments

Standard Strain Pole Foundation-All Soil Conditions

Construction Details-Foundations

Sig. M 6

Sig. M 7

Sig. M 8

Highway Signs, Luminaires,

and Traffic Signals

750 N.Greenfield Pkwy, Garner,NC 27529


PROJECT I.D. NO. SHEET NO

R-3300B

Sig.M1


STANDARD DRAWINGS FOR ALL METAL POLES


STATE OF NORTH CAROLINA

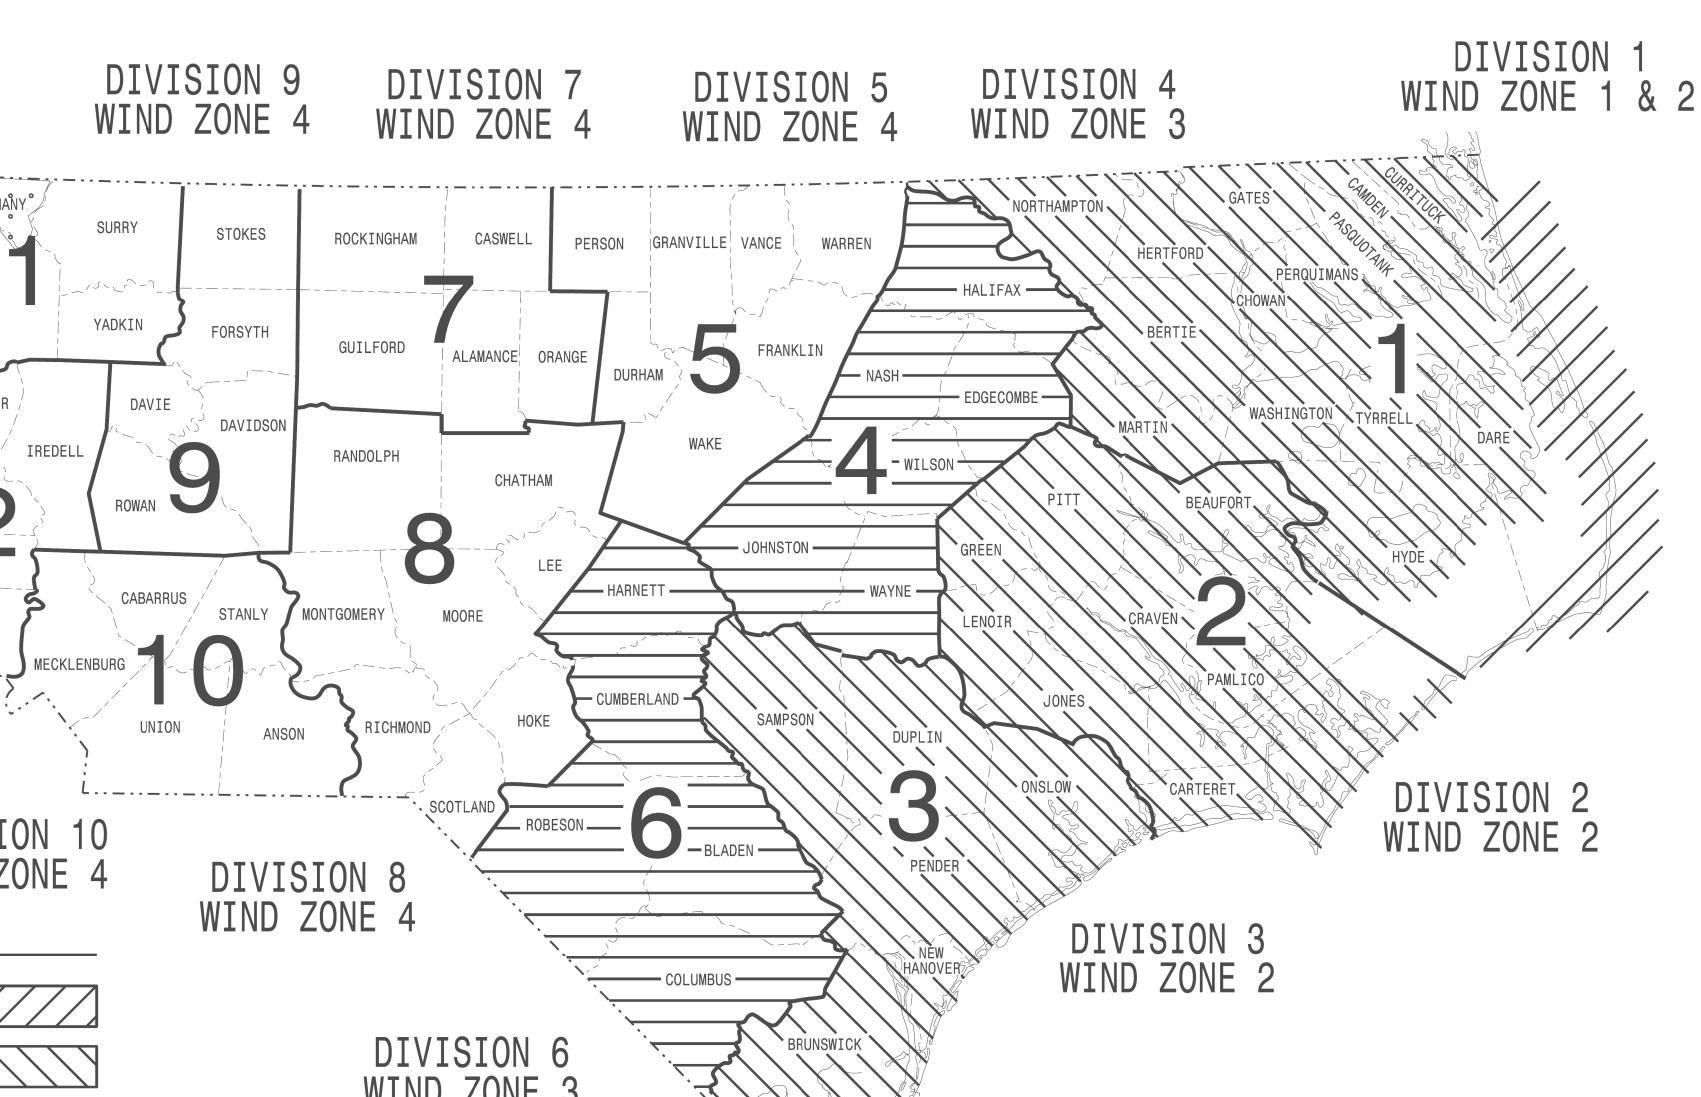


D.C. SARKAR, P.E. – ITS AND SIGNALS SENIOR STRUCTURAL ENGINEER



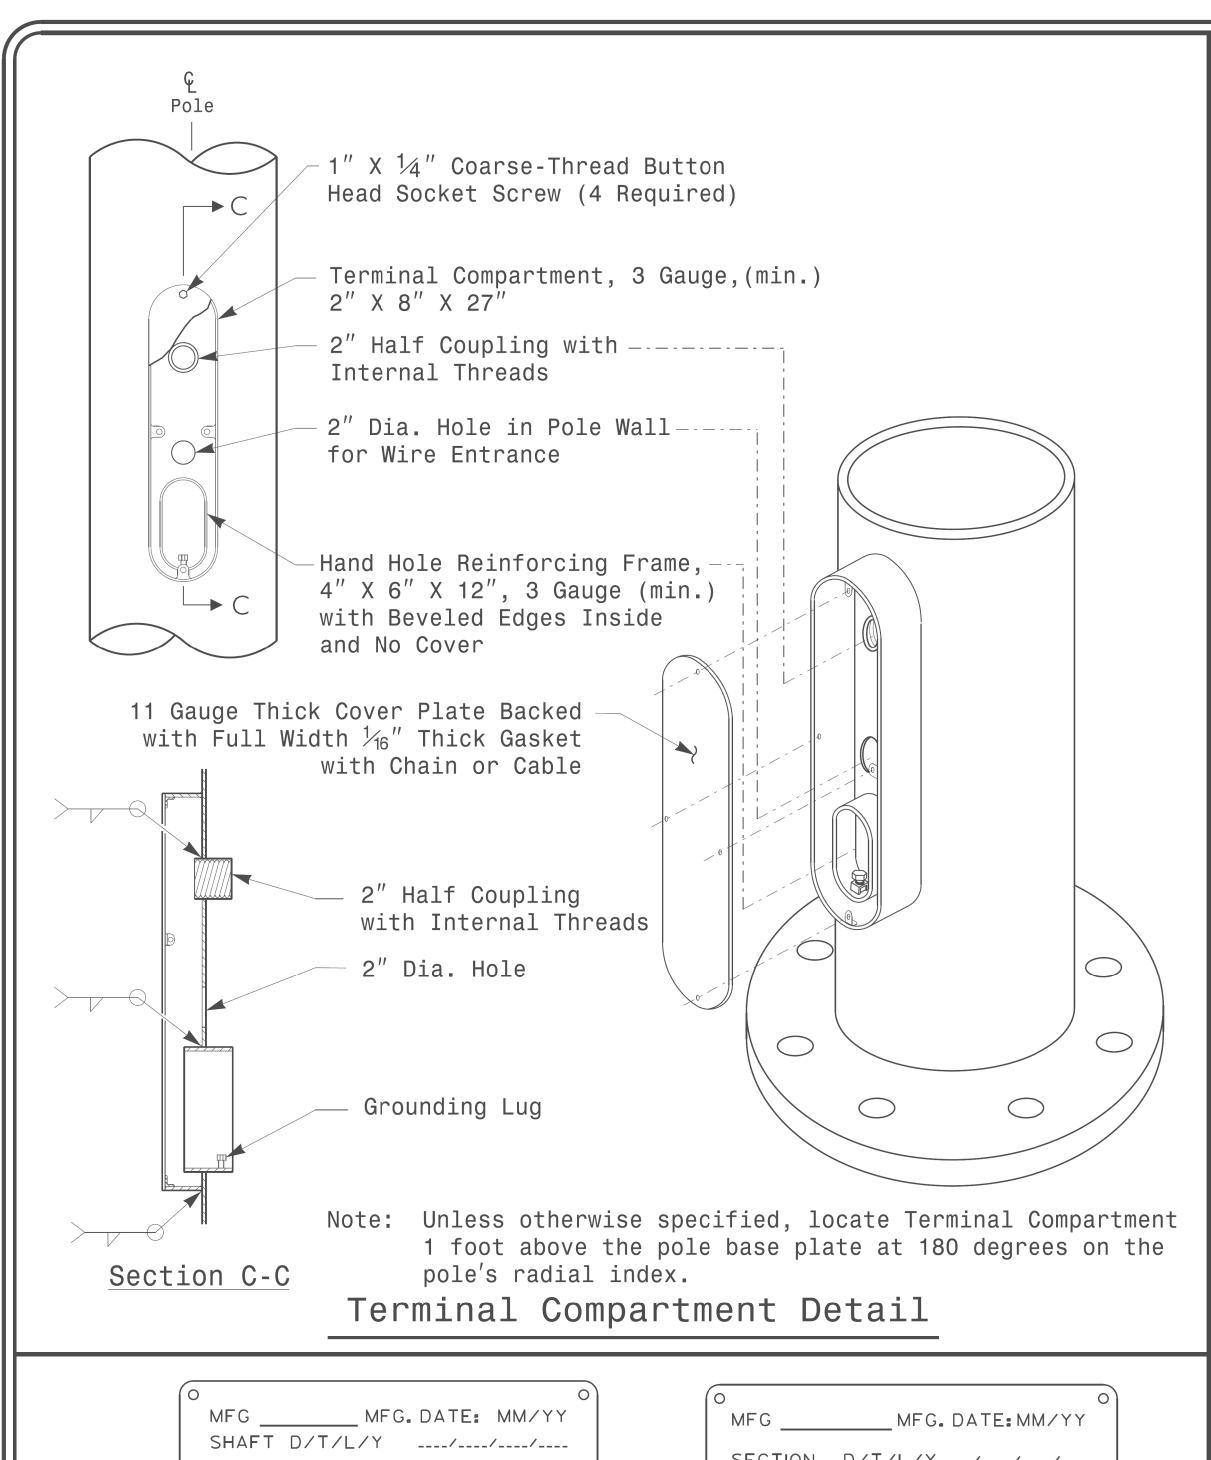


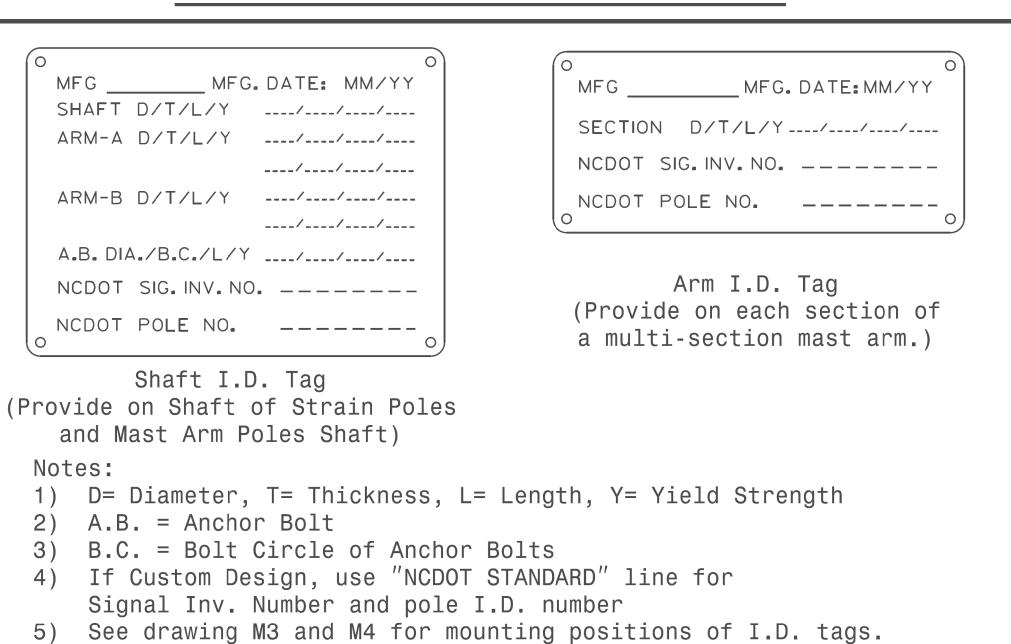


Identification Tag Details

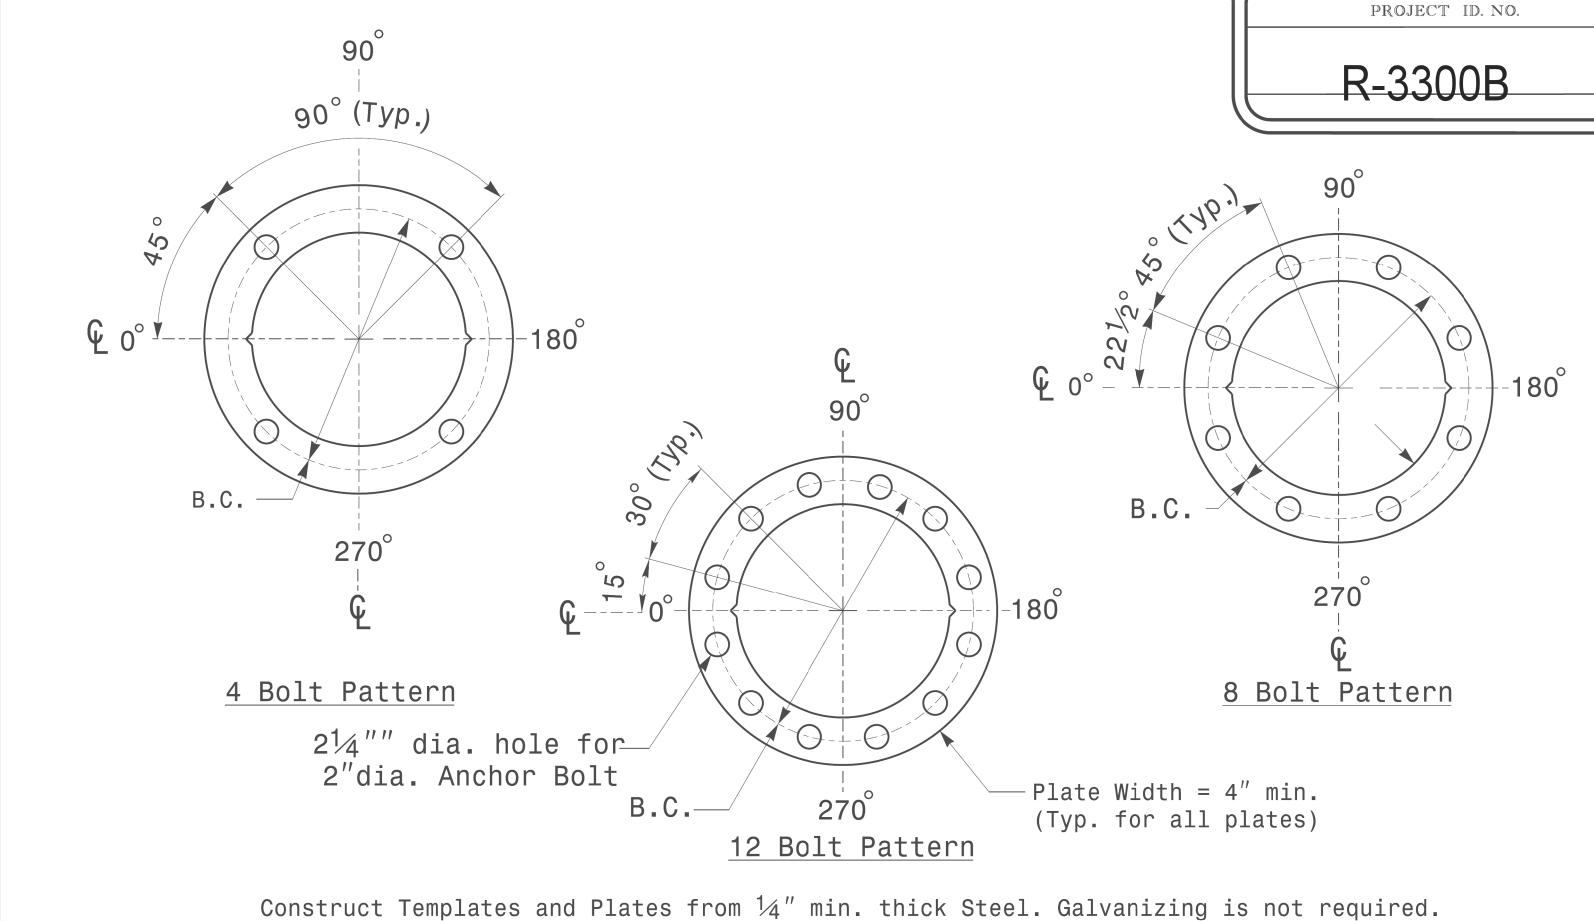



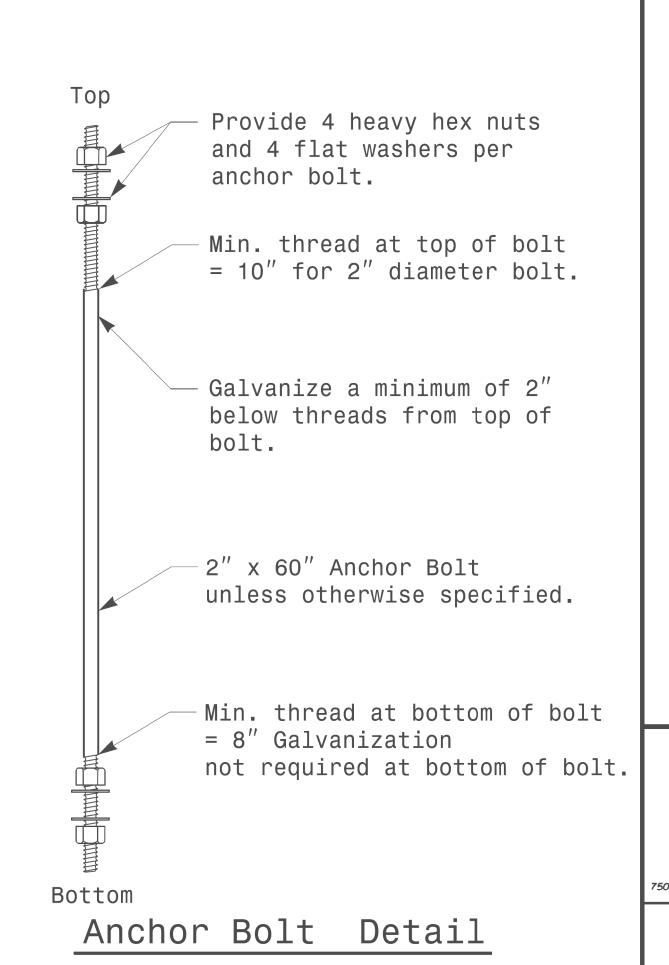


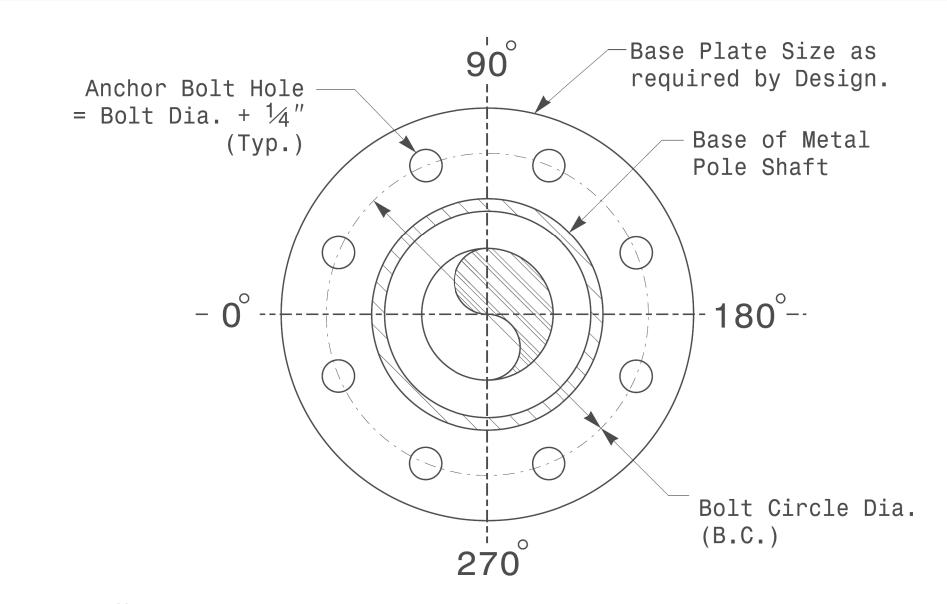

Note: Base plate may be circular,octagonal,square or rectangular in shape.

Typical Base Plate Detail

Prepared in the Offices of:	Typi	cal Fabri. Fo All Meta	r		ils
noi Design Section	PLAN DATE:	OCTOBER 2017	DESIGNED BY:	C.F.AN	DREWS
N.Greenfield Pkwy,Garner,NC 27529	PREPARED BY:	N. BITTING	REVIEWED BY:	D.C. S	ARKAR
SCALE		REVISIONS		INIT.	DATE
O NA					

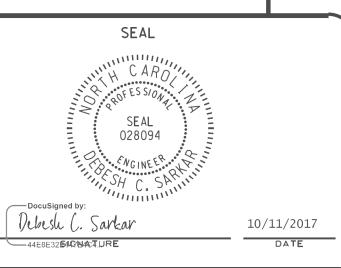

SHEET NO.

Sig.M2

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S:*ITS&SU*ITS Signals*Signal Design Section*Eastern Region*M Sheets*2016*2014 Sig.M2 Std. Fabrication Details rnzinser

1

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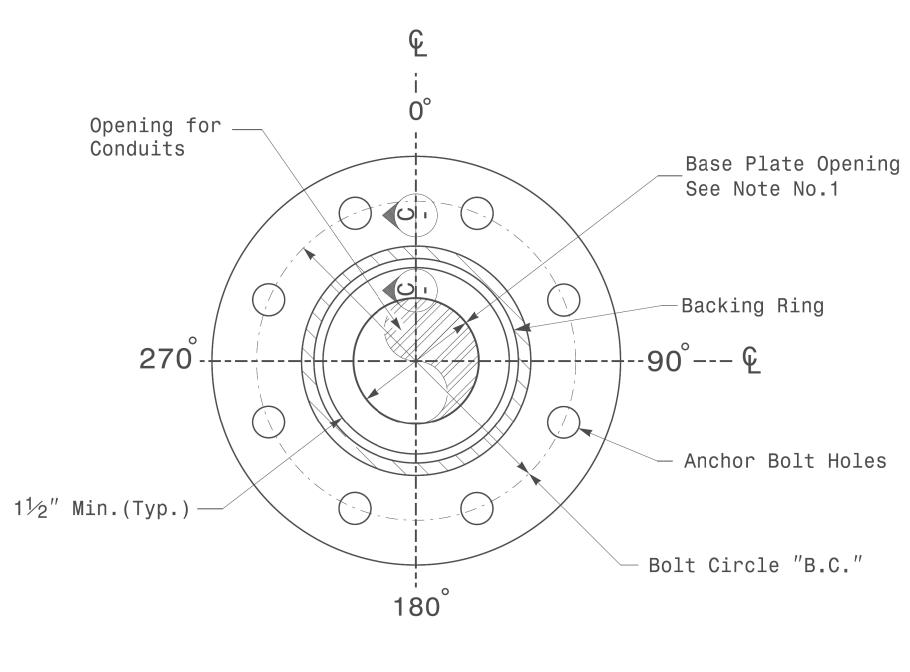
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Fa


Note:

1.Opening in pole base plate shall be equal to pole base inside diameter minus $3\frac{1}{2}$ " but shall not be less than $8\frac{1}{2}$ ".




Section B-B

Pole Base Plate Details
(8 and 12 Bolt Pattern)

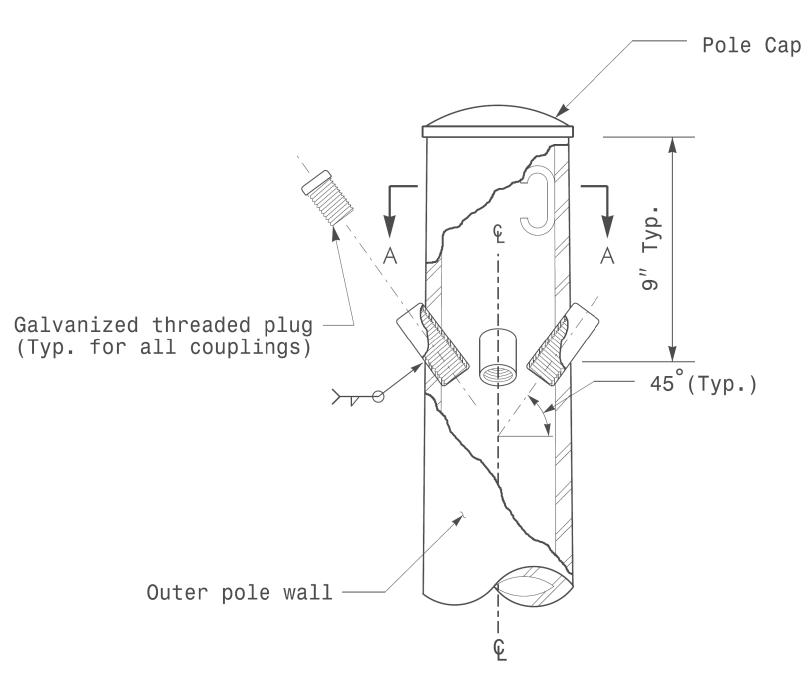


Cable Entrances at Top of Pole

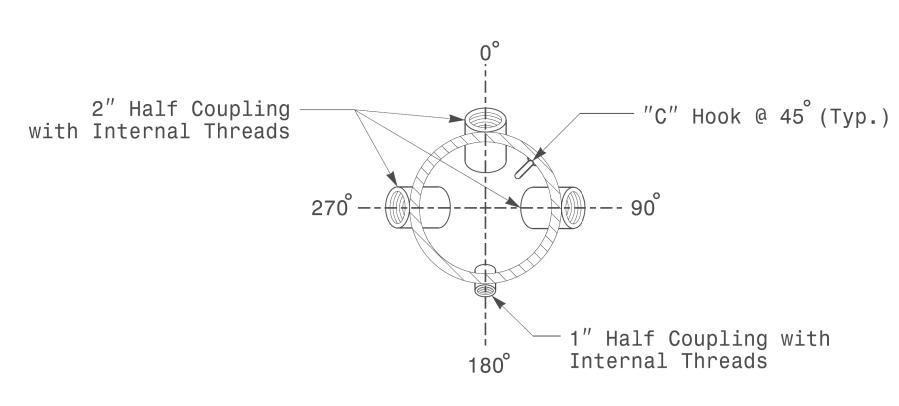

Section A-A

Radial Orientation for Factory Installed
Accessories at Top of Pole

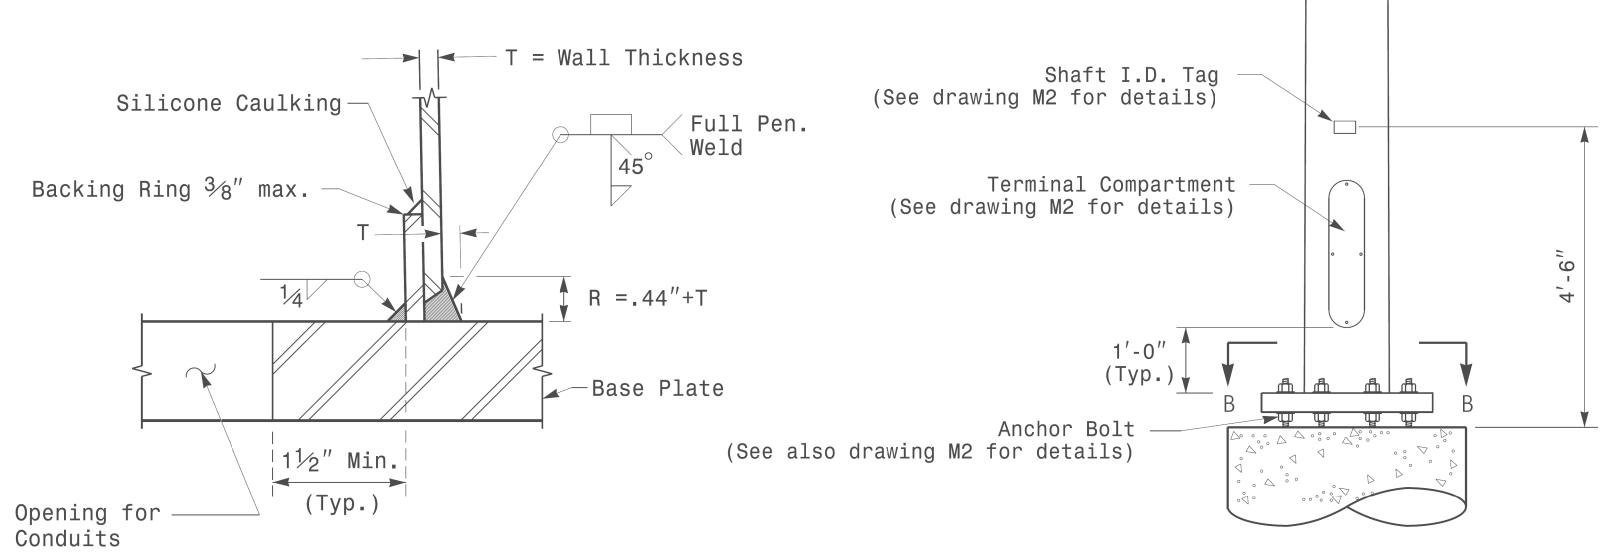


2 Cable Clamps designed for -variable attachment heights from 1'-6" to 5'-0" below

the top of the pole.

Section C-C
(Pole Attachment to Base Plate)

<u>Full-Penetration</u> <u>Groove Weld Detail</u>




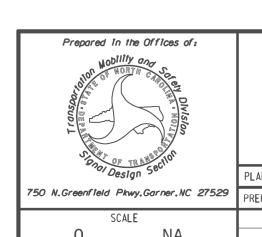

NONE


Typical Fabrication Details For Strain Poles

Sector Design Sector		001 4111 1 0103						
	PLAN DATE:	OCTOBER 2017	DESIGNED BY:	K.C.D	URIGON			
O N.Greenfield Pkwy,Garner,NC 2752	PREPARED BY:	N. BITTING	REVIEWED BY:	D.C.	SARKAR			
SCALE		REVISIONS		INIT.	DATE			
O NA								
					1			

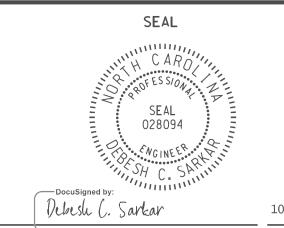


II-UUI-2017 US:23 S:*ITS&SU*ITS Signals*Signal Design Section*Eastern Region*M Sheets*2016*2014 Sig.M3 Std. Fabrication Deta rnzinser


10/11/2017 DATE

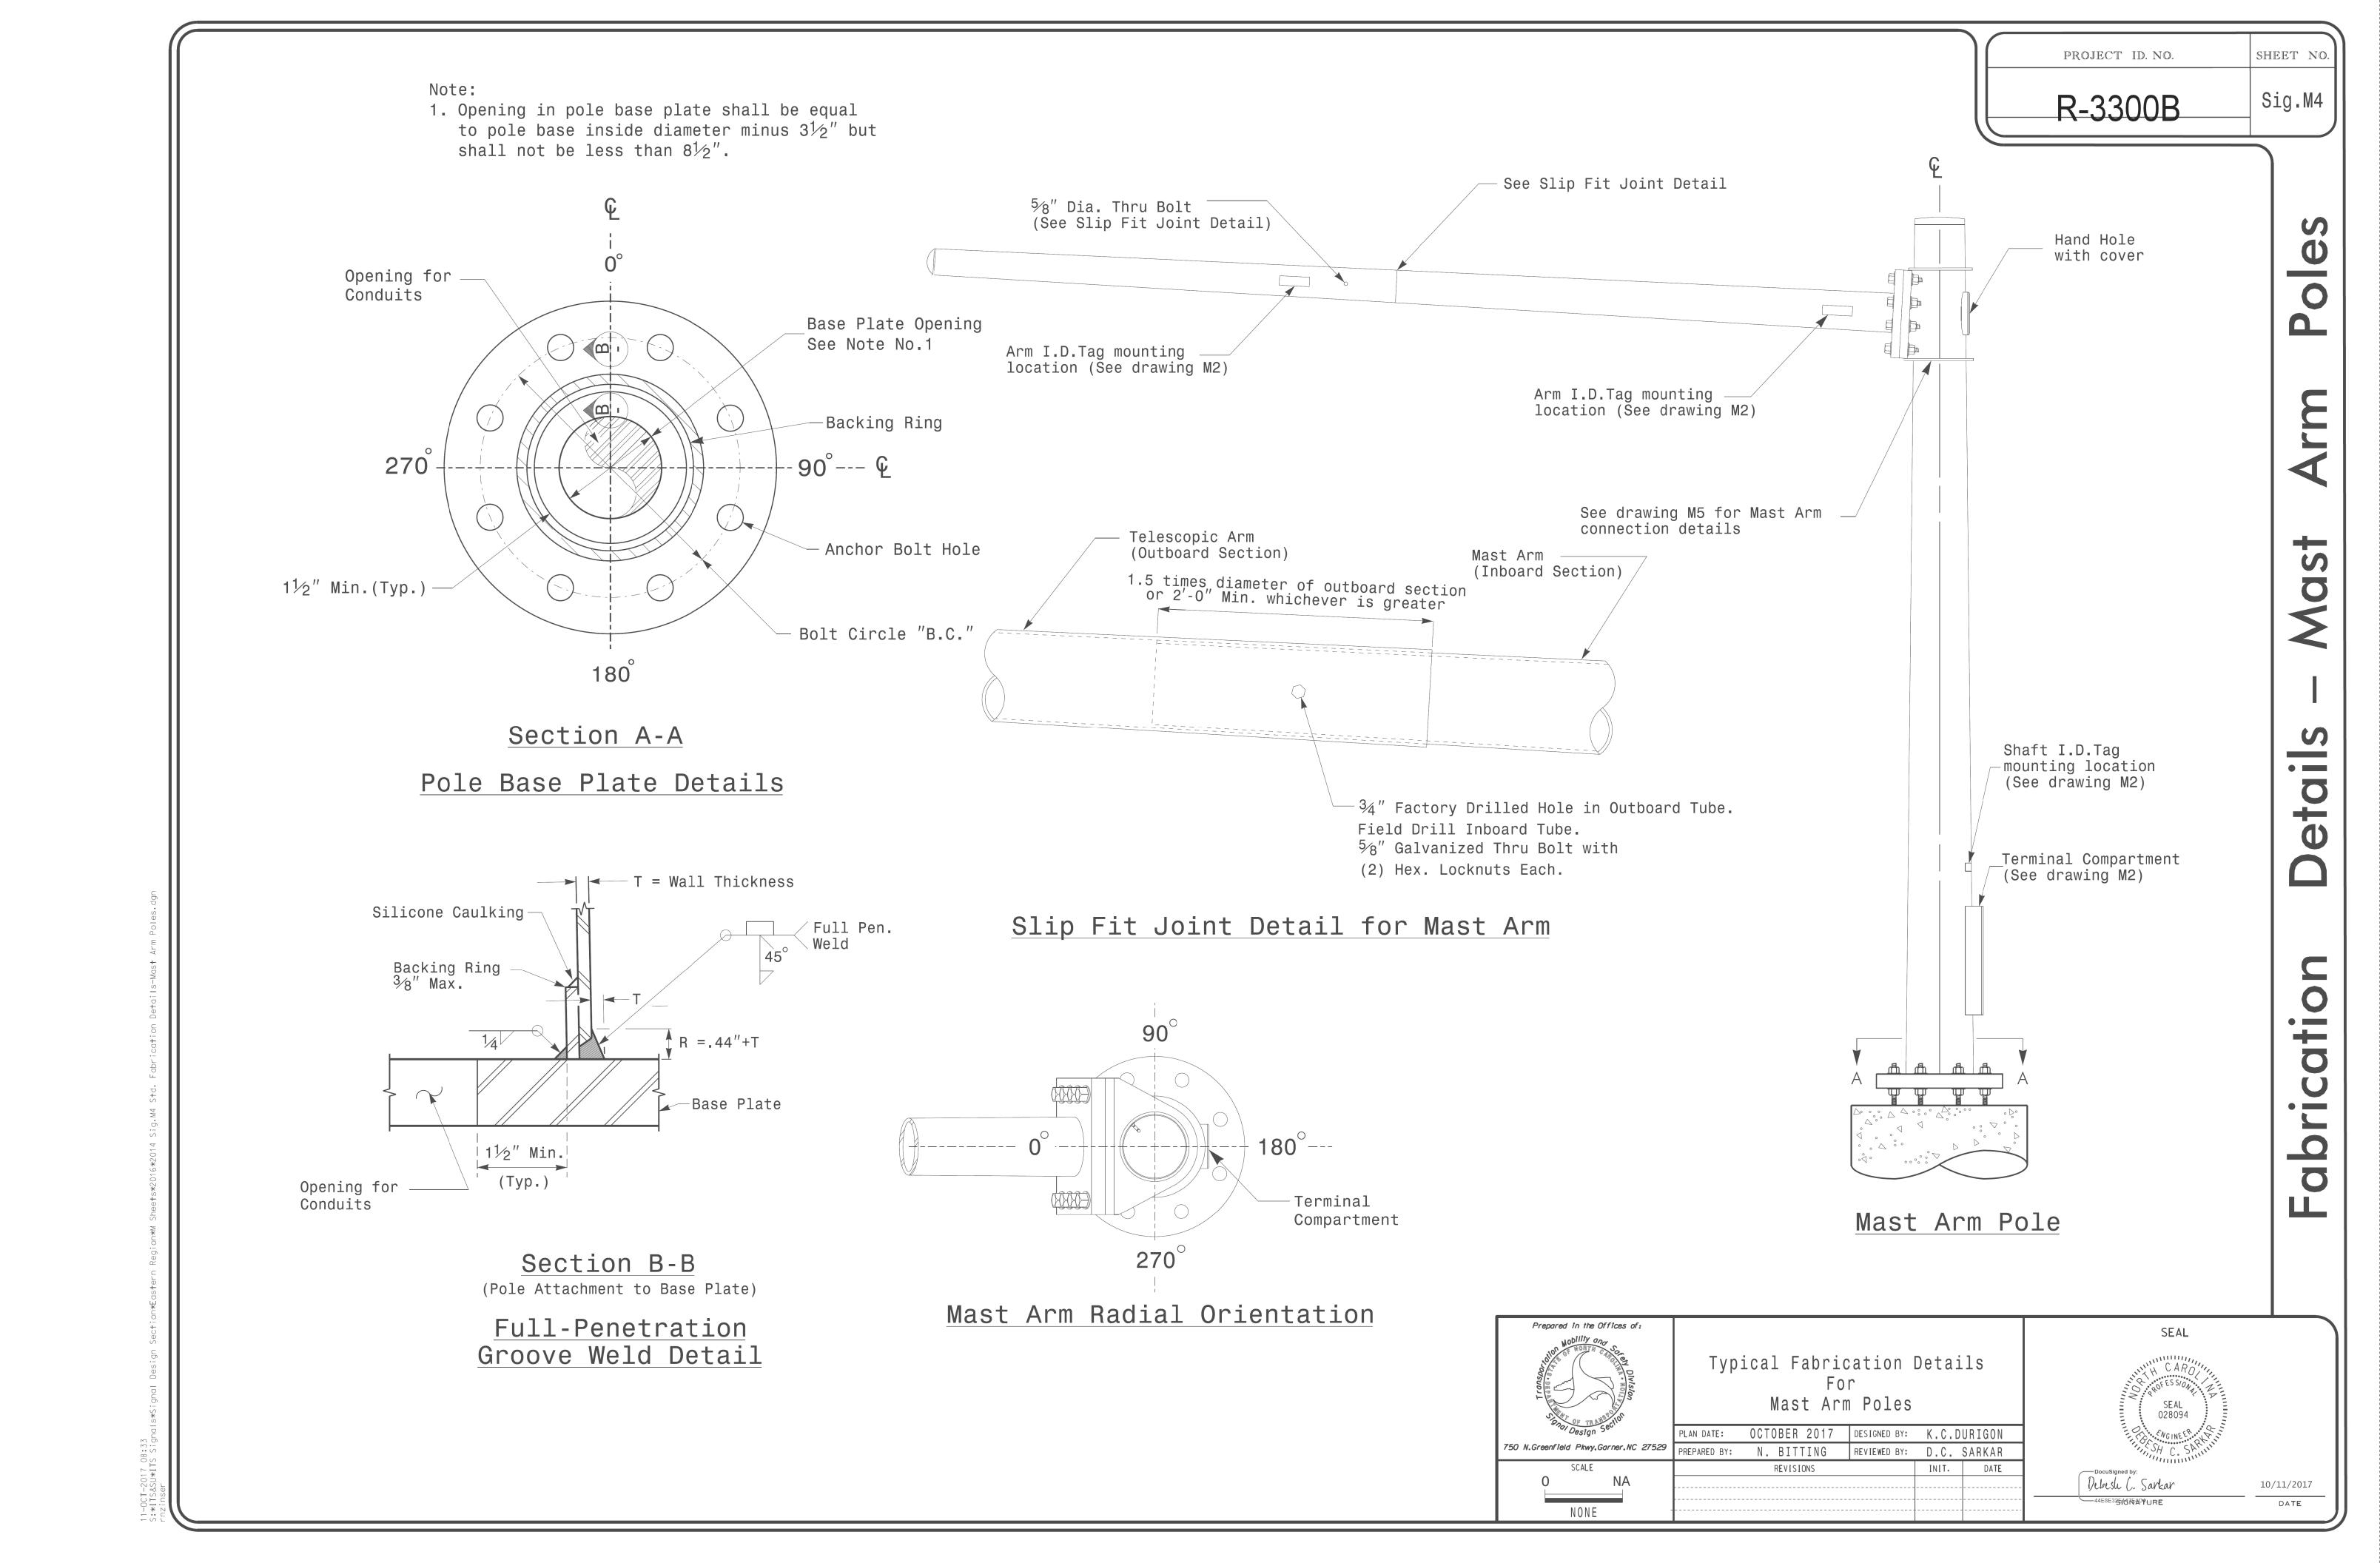

Welded Ring Stiffened Mast Arm Connection

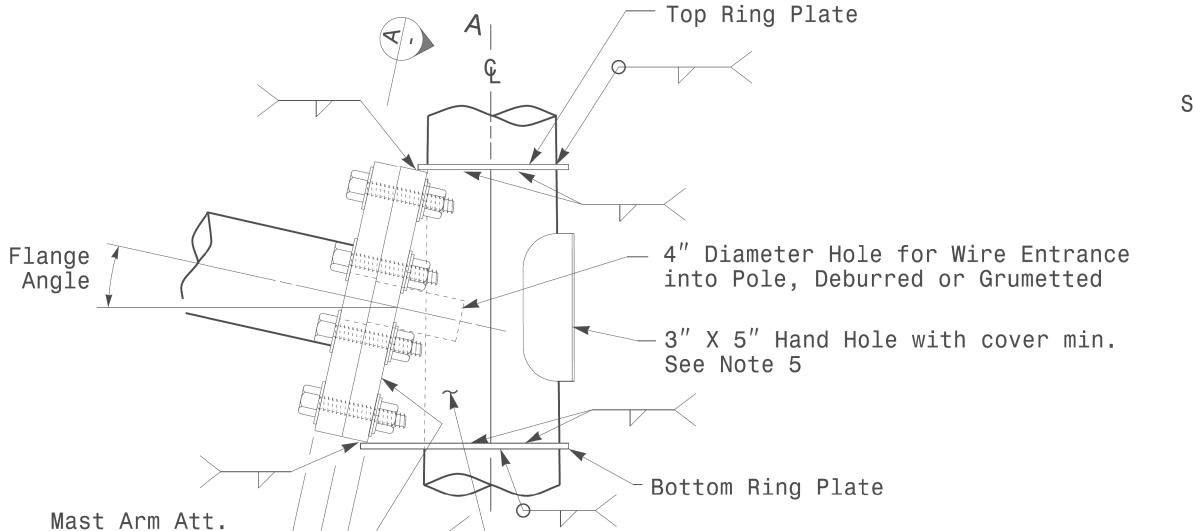

Side Gusset Plate

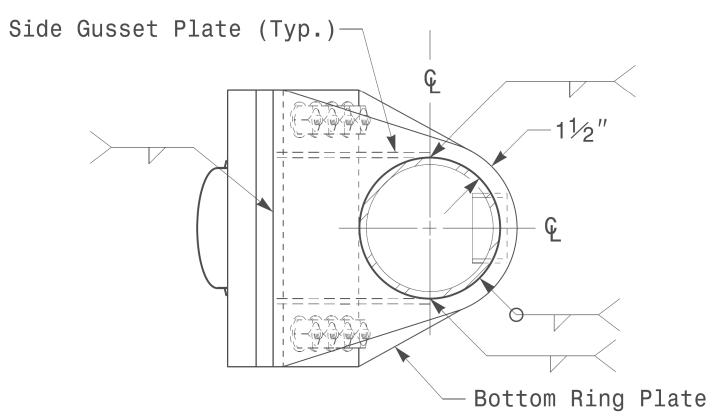

Side Elevation View

-Edge Distance 4" Diameter Hole for Wire Entrance ├── Plate Width into Pole, Deburred or Grumetted See Note 4 ⊢Bolt Sp.→ See Note 1 Backing Ring 3/8" max. Mast Arm Wall **B** 0 M | M Bolt Hole Diameter = Bolt Dia.+ $\frac{1}{16}$ " Edge Distance —— See Note 4 (Typ.)

Front Elevation View

Plan View

Side Gusset

Plate (Typ)

Backing Ring —

 $-1\frac{1}{2}''$

—Top

Ring Plate

High Strength Bolt

Full-Penetration

Groove Weld Detail


(See Section B-B)

(Typ.)

+ hardened flat washer


Plate Thickness

Flange Plate Thickness

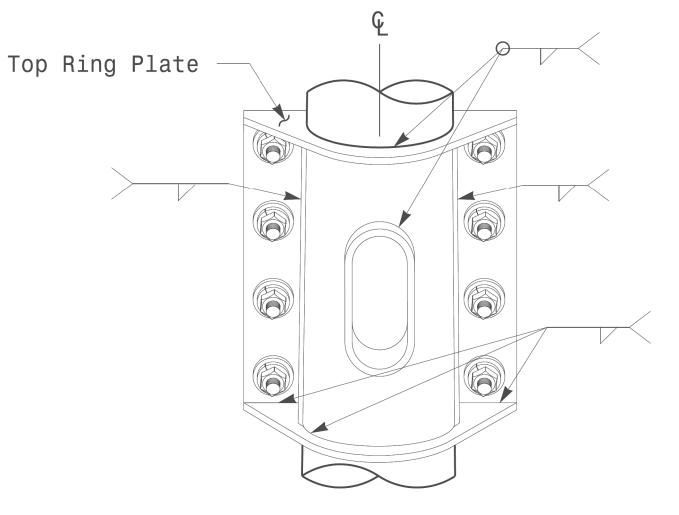


Back Elevation View

Section A-A Mast Arm Attachment Plate

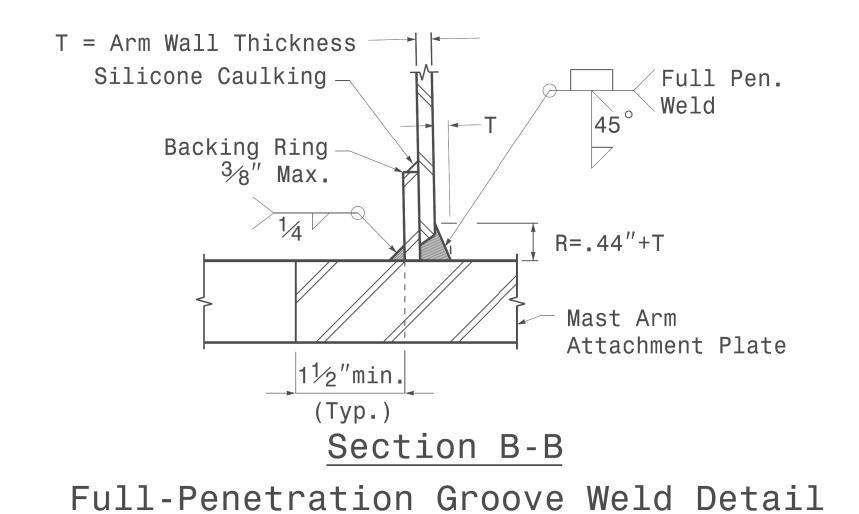

Notes:

- 1. Provide a permanent means of identification above the mast arm to indicate proper attachment orientation of the mast arm.
- 2. Designer will determine the size of all structural components, plates, fasteners, and welds shown unless they are already specified.
- 3. Fabricator is responsible for providing appropriate holes at drainage points to drain galvanizing materials.
- 4. For minimum edge distance follow AISC Table J3.4 and J3.5. For nominal bolt hole size use Table J3.3.
- 5. Provide upper handhole as necessary when shaft extensions are reguired for luminaire arms or camera. For poles without luminaires/camera, wiring can be done through the top of pole.
- 6. Allowable range of flange tilt angle will vary from 0° to as required.

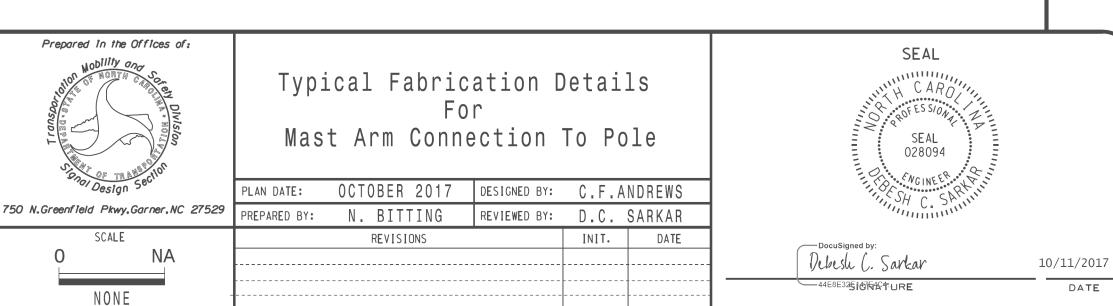

Strain Pole Attachments

NOTE:


- 1. Strap all signal cables to the side of the pole with $\sqrt[3]{4}$ " stainless steel straps when the distance between the spanwire attachment clamp and the weatherheads exceeds 3'-0''.
- 2. Provide minimum two spanwire pole clamps per pole.
- 3. It is prohibited to attach two span wires at one pole clamp.
- 4. For general requirements refer to NCDOT Standard Specifications for Roadway and Structures, January 2018.

PROJECT ID. NO. SHEET NO. Sig.M6


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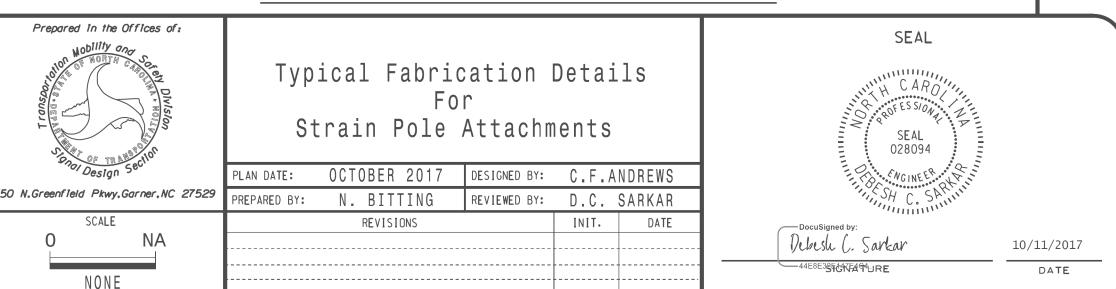
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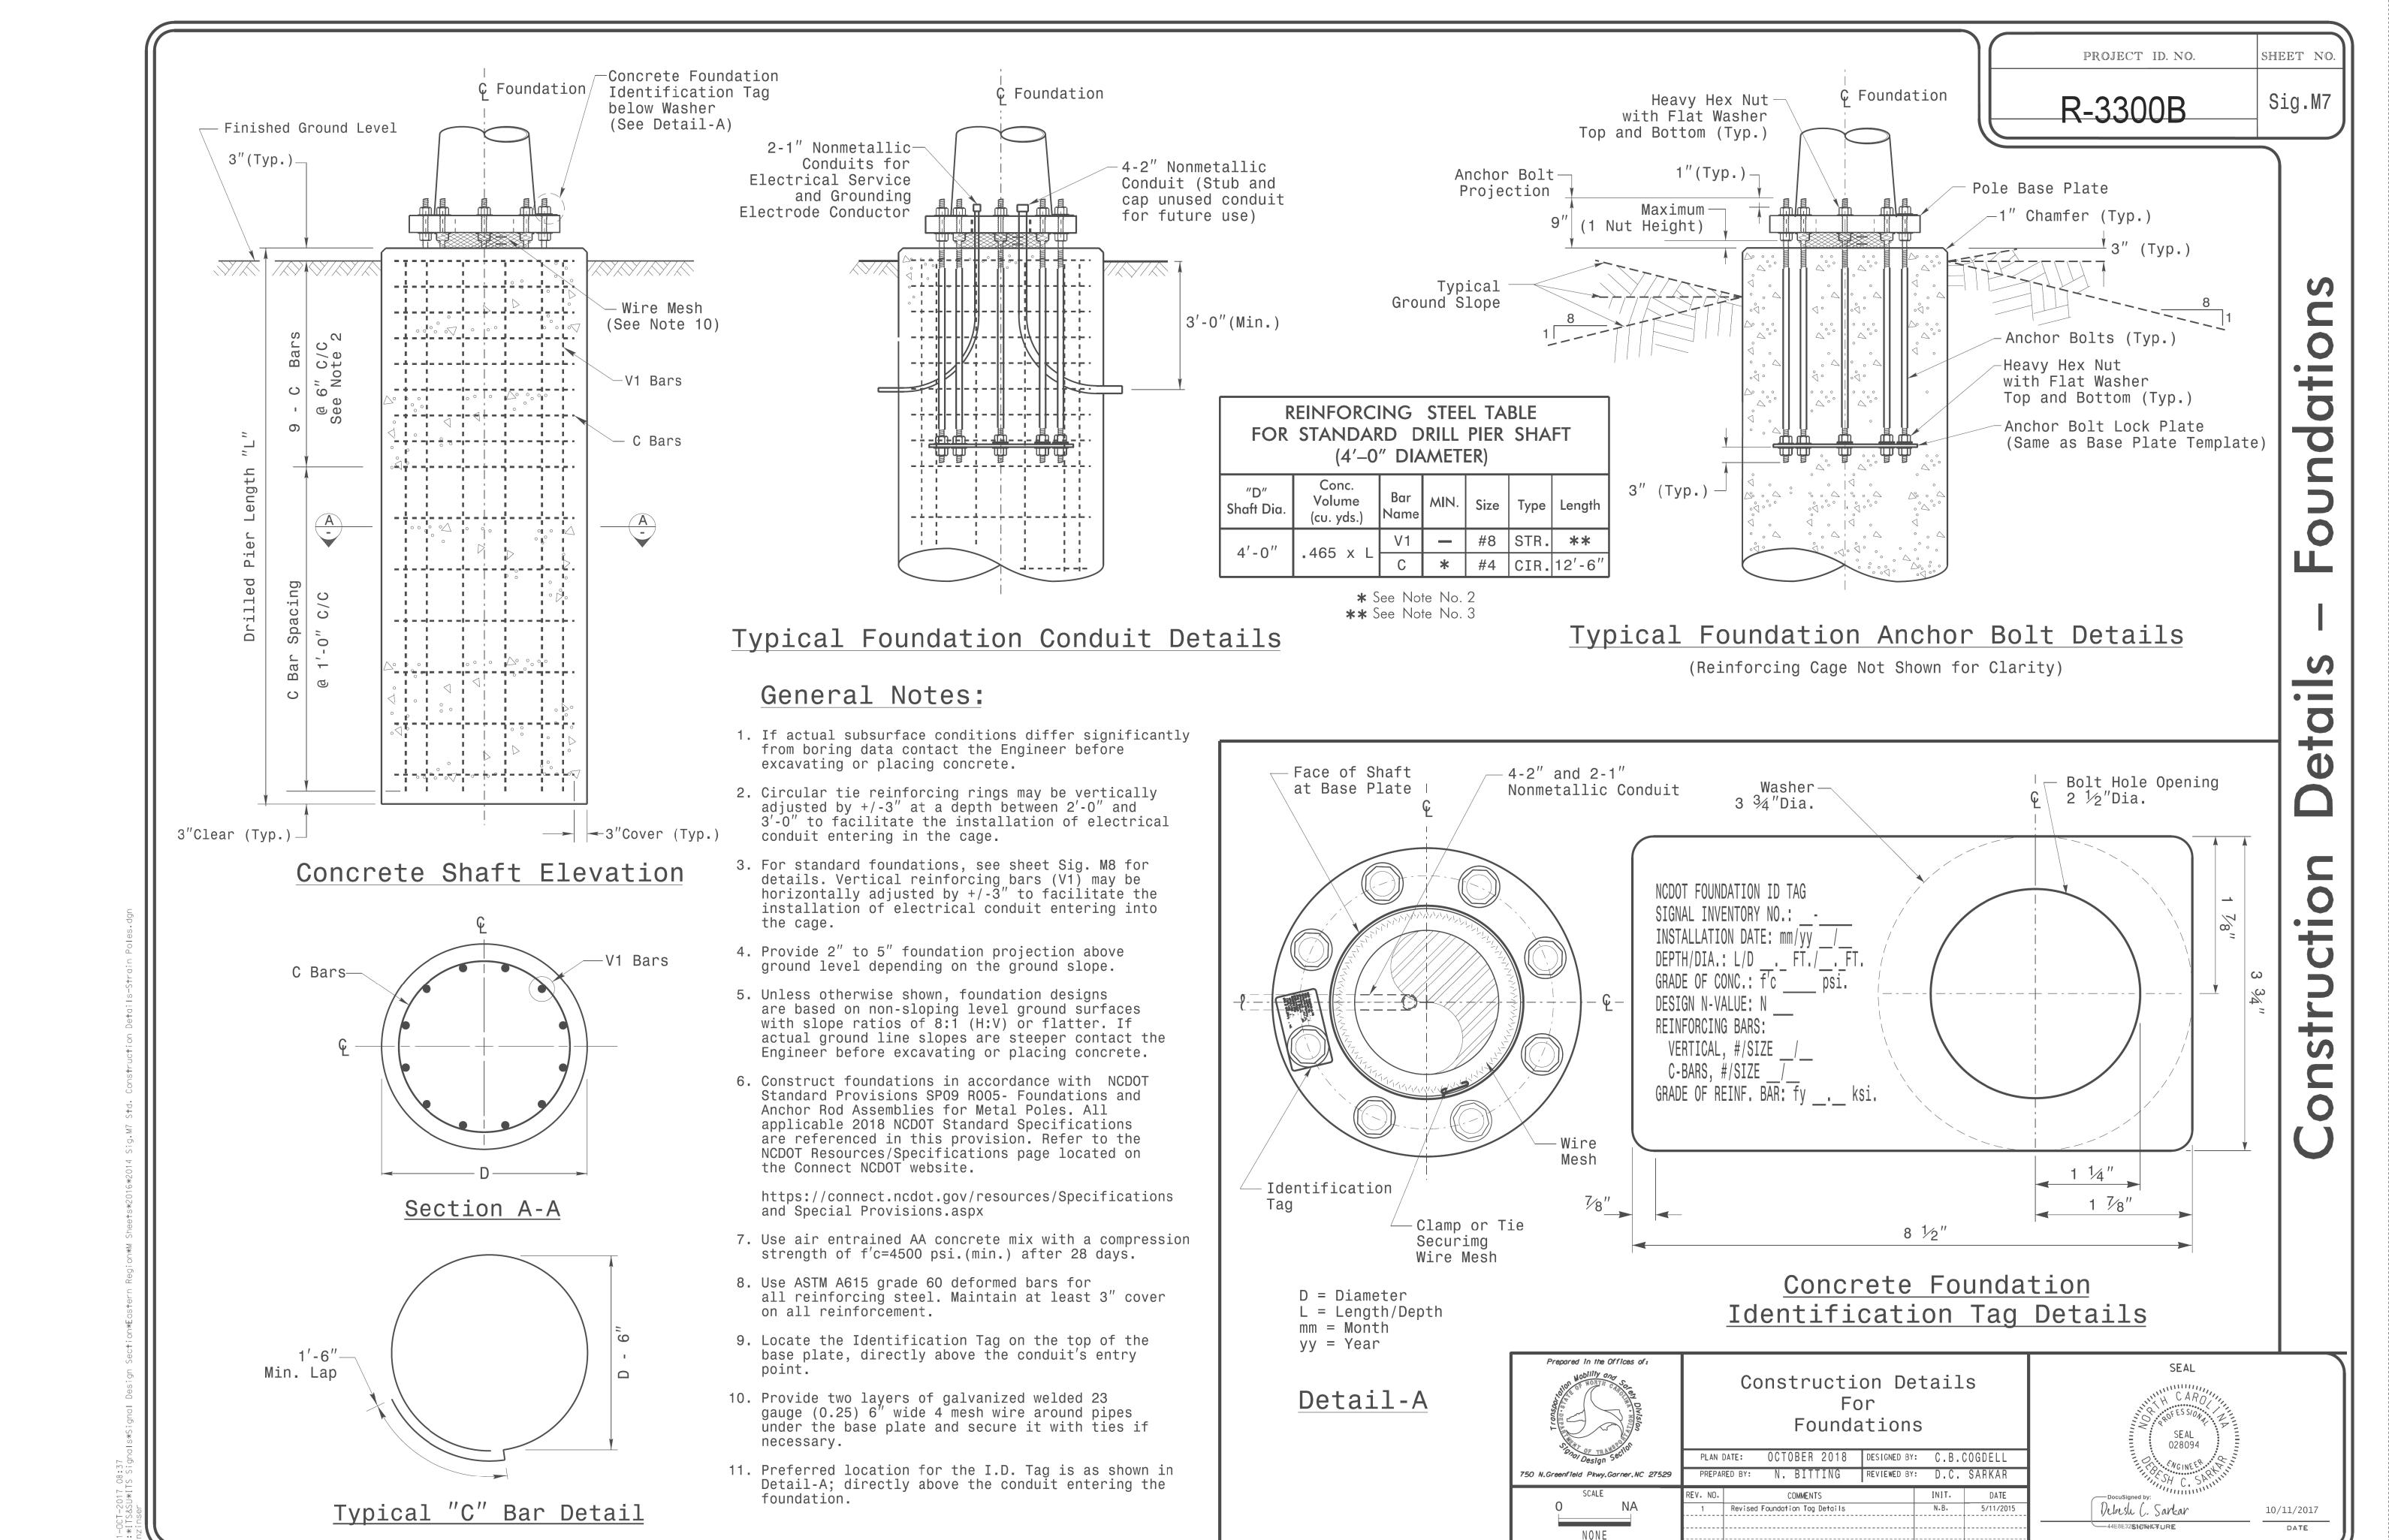
Attachment of Cable to Intermediate Metal Pole



Metal Pole Grounding Detail For Strain Pole and Mast Arm

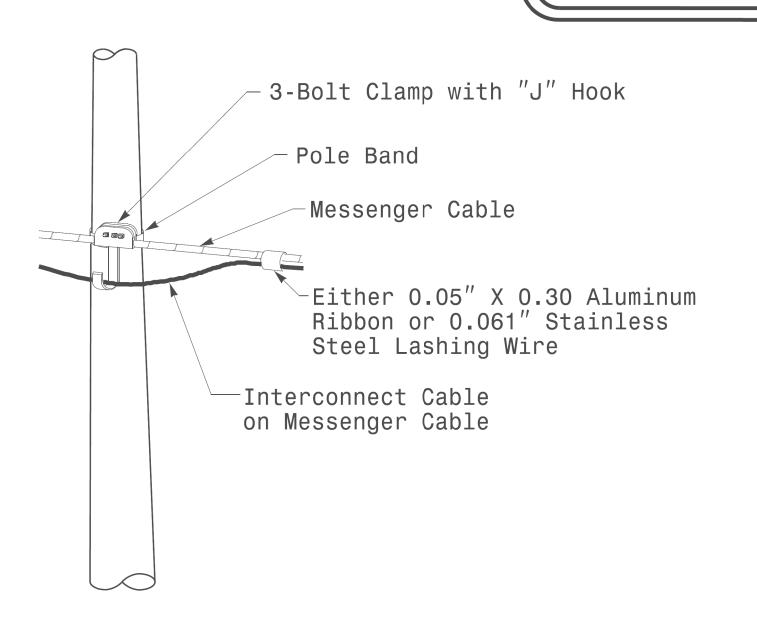

S:*ITS&SU*ITS Signals*Signal Design Section*Eastern Region*M Sheets*2016*2014 Sig.M6 Std. Fabrication Details—Strain Pole rnzinser

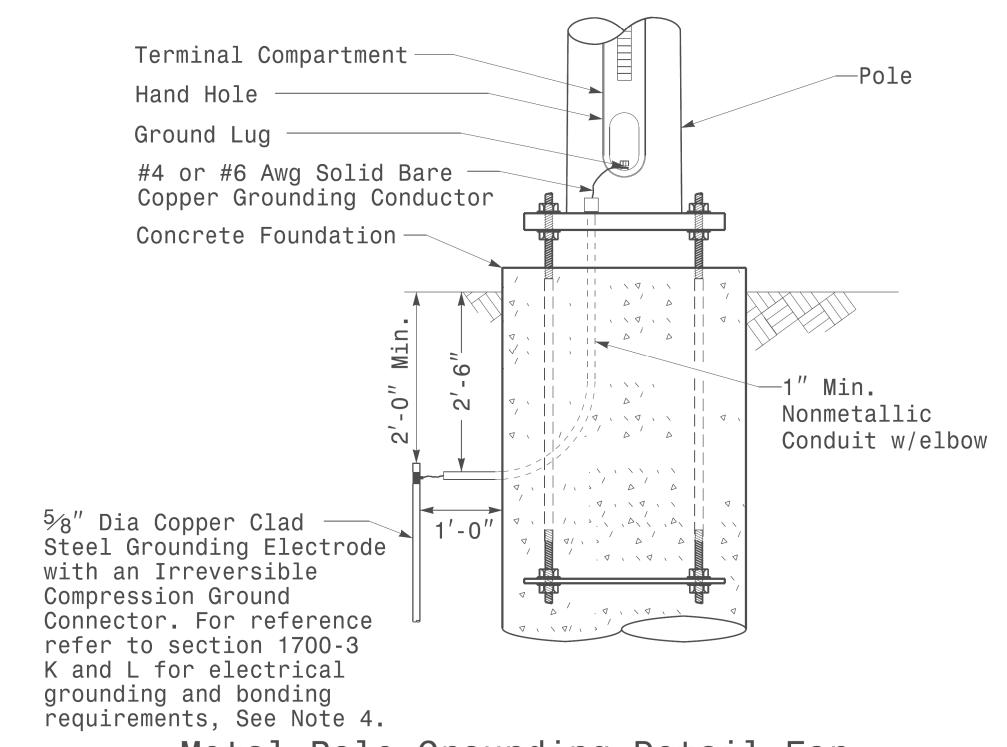

Condition Soil oundation-All Ш <u>o</u>

SOIL CONDITION

									301L COMDITION										
	STANDARD STRAIN POLES									TANDAR Diameter D						Reinfor	cement		
					Base	Reaction	ns at the	Pole Base		Cl	ay			Sand		Longit	tudinal	Stirr	ups
			Case No.	Pole Height (Ft.)	Plate BC (In.)	Axial (kip)	Shear (kip)	Moment (ft–kip)	Medium N–Value 4–8	Stiff N–Value 9–15	Very Stiff N–Value 16–30	Hard N-Value >30	Loose N–Value 4–10	Medium N–Value 11–30	Dense N–Value >30	Bar Size (#)	Quantity (ea.)	Bar Size (#)	Spacing (in.)
	W	Ļ	S26L3	26	25	2	11	270	19	13	10	8	17	14.5	12.5	8	12	4	12
	N D	G H	S30L3	30	25	2	11	300	19.5	13.5	10	8	17.5	15	13	8	14	4	12
	Z 0	Ή	S35L3	35	25	3	11	320	20	13.5	10.5	8	17.5	15	13	8	14	4	12
	N E	H E A	S30H3	30	29	3	16	450	24.5	16	12	9	21	17.5	15	8	16	4	6
	1	V Y	S35H3	35	29	4	16	515	26	17	12.5	9.5	22	18.5	16	8	16	4	6
	W	Ļ	S26L2	26	23	2	10	245	18	12.5	9.5	8	16.5	14	12	8	12	4	12
	N D	G	S30L2	30	23	2	10	270	18.5	12.5	10	8	16.5	14	12.5	8	12	4	12
		H	S35L2	35	23	3	10	300	19.5	13	10	8	17	14.5	13	8	12	4	12
	Z O N E	HE^	S30H2	30	29	3	15	415	23	15.5	11.5	9	20	17	14.5	8	16	4	6
	2	V Y	S35H2	35	29	4	15	475	25	16.5	12	9.5	21	17.5	15.5	8	16	4	6
	W	Ļ	S26L2	26	23	2	10	245	18	12.5	9.5	8	16.5	14	12	8	12	4	12
	N D	G H	S30L2	30	23	2	10	270	18.5	12.5	10	8	16.5	14	12.5	8	12	4	12
	Z 0	Ϋ	S35L2	35	23	3	10	300	19.5	13	10	8	17	14.5	13	8	12	4	12
	N E	HE	S30H2	30	29	3	15	415	23	15.5	11.5	9	20	17	14.5	8	16	4	6
	3	A V Y	S35H2	35	29	4	15	475	25	16.5	12	9.5	21	17.5	15.5	8	16	4	6
	W	L I	S26L1	26	22	2	8	190	16	11.5	8.5	8	15	12.5	11	8	12	4	12
	N D	G H	S30L1	30	22	2	8	205	16.5	11.5	9	8	15	13	11.5	8	12	4	12
	Z	Ϊ	S35L1	35	22	3	8	230	17	12	9	8	15.5	13.5	11.5	8	12	4	12
	O N E	H E A	S30H1	30	25	3	12	320	20.5	13.5	10.5	8	18	15	13.5	8	16	4	6
	4	V Y	S35H1	35	25	4	12	350	21	14	10.5	8.5	18.5	15.5	13.5	8	16	4	6
	WI	Ļ	S26L2	26	23	2	10	245	18	12.5	9.5	8	16.5	14	12	8	12	4	12
	N D	G H	S30L2	30	23	2	10	270	18.5	12.5	10	8	16.5	14	12.5	8	12	4	12
	Z 0	Η̈́	S35L2	35	23	3	10	300	19.5	13	10	8	17	14.5	13	8	12	4	12
)	N E	H E A	S30H2	30	29	3	15	415	23	15.5	11.5	9	20	17	14.5	8	16	4	6
,	5	V Y	S35H2	35	29	4	15	475	25	16.5	12	9.5	21	17.5	15.5	8	16	4	6

General Notes:

- 1. Values shown in the "Reactions at the Pole Base" column represent the minimum acceptable capacity allowed for design using a design CSR of 1.00.
- 2. Use chairs and spacers to maintain proper clearance.
- 3. For foundation, always use air-entrain concrete mix.

Foundation Selection:

- 1. Perform a standard penetration test at each proposed foundation site to determine "N" value.
- 2. Select the appropriate wind zone from M 1 drawing.
- 3. Select the soil type (Clay or Sand) that best describes the soil characteristics.
- 4. Get the appropriate standard pole case number from the plans or from the Engineer.
- 5. Select the appropriate column under "Standard Foundations" based on soil type and "N" value. Select the appropriate row based on the pole load case.
- 6. The foundation depth is the value shown in the "Standard Foundations" category where the column and the row intersect.
- 7. Use Construction Procedures and Design Methods prescribed by FHWA-NHI-10-016 for Reference Drilled Shafts.

Prepared in the Offices of:


Standard Strain Pole Foundation for All Soil Conditions

PLAN DATE: OCTOBER 2017 DESIGNED BY: C.B. COGDELL

PREPARED BY: N. BITTING REVIEWED BY: D.C. SARKAR

REVISIONS INIT. DATE

Changed "Foundation Depth" to "Drilled Pier Length" in Conc. Eqn. N.B. 7/12/2015

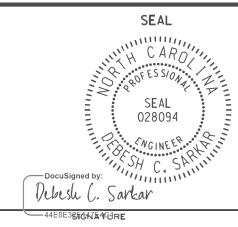

10/11/2017

48" Dia. Foundations Concrete Volume (cubic yards) = (0.465) x Drilled Pier Length

PROJECT: R-3300B

STATE OF NORTH CAROLINA
DIVISION OF HIGHWAYS

Project No. **R**-3300**B**


Sheet No.

SCP-1

PENDER COUNTY

LOCATION: NC 417 (HAMPSTEAD BYPASS) FROM SOUTH OF NC 210 TO NORTH OF SR 1563 (SLOOP POINT LOOP ROAD).

TYPE OF WORK: TRAFFIC SIGNAL COMMUNICATIONS SYSTEM #10324

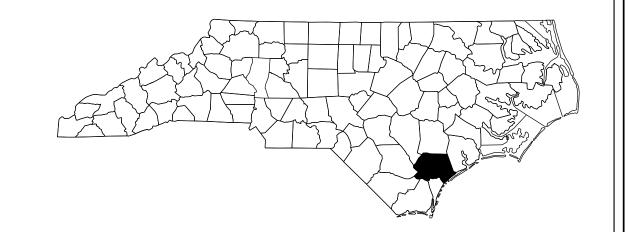



2018 STANDARD SPECIFICATIONS

PROJECT LENGTH:
6.916 MILES

BEGIN PROJECT R-3300B

END PROJECT R-3300B

LETTING DATE:
SEPTEMBER 2020

LEGEND

XX-XXXX SIGNAL INVENTORY No.

INDEX OF PLANS

SCP-1
SCP-2
SCP-3 thru SCP-15
SCP-16 thru SCP-18
SCP-19 thru SCP-22
SCP-23
TITLE SHEET
CONSTRUCTION NOTES AND LEGEND
CABLE ROUTING PLANS
FIBER-OPTIC SPLICING DETAILS
DMS INSTALLATION (DUAL-MOUNTED
DMS UNDERGROUND FED ELECTRICATION)

SCP-24

CABLE ROUTING PLANS
FIBER-OPTIC SPLICING DETAILS
DMS INSTALLATION (DUAL-MOUNTED ON SINGLE POLE PEDESTAL)
DMS UNDERGROUND FED ELECTRICAL SERVICE DETAIL
CCTV ON METAL POLE WITH AERIAL ELECTRICAL SERVICE DETAIL

ROADWAY STANDARD DRAWINGS

THE FOLLOWING ROADWAY STANDARDS AS APPEAR IN "ROADWAY STANDARD DRAWINGS" ROADWAY DESIGN UNIT - N.C. DEPARTMENT OF TRANSPORTATION - RALEIGH, N.C. DATED JANUARY 2018 ARE APPLICABLE TO THIS PROJECT AND BY REFERENCE HEREBY ARE CONSIDERED A PART OF THESE PLANS.

STD. No.	TITLE
1101.01	WORK ZONE WARNING SIGNS
1101.02	TEMPORARY LANE CLOSURE
1101.04	TEMPORARY SHOULDER CLOSURE
1715.01	UNDERGROUND CONDUIT - TRENCHING
1716.01	JUNCTION BOXES
1730.01	FIBER OPTIC CABLE - SPARE CABLE STORAGE
1751.01	CONTROLLERS AND CABINETS - CABINET COMPONENT LAYOUT
1751.02	CONTROLLERS AND CABINETS - POWER, GROUND, AND AUXILIARY

NCDOT CONTACT: TRANSPORTATION SAFETY AND MOBILITY INTELLIGENT TRANSPORTATION SYSTEMS SECTION

Gregory Green
Signal Communication Project Engineer
Doug Sonderfan

Regina Muncey, PE



Stantec Consulting Services Inc. 801 Jones Franklin Rd-Suite 300 Raleigh, NC 27606

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Fax. 919.851.7024
www.stantec.com
License No. F-0672

Signal Communication Design Engineer

Raleigh, NC 27606 www.stantec.com
License No. F-0672

Larry Overn, PE, PTOE

Senior Transportation Engineer

Dean Harris

Senior Transportation Designer

Transporation Engineer



ONTRACT:

INSTALL INTERCONNECT CENTER, PATCH PANEL,

29 > INSTALL UNDERGROUND SPLICE ENCLOSURE

IUMPERS, AND FUSION SPLICE CABLE IN CABINET

30 > INSTALL AERIAL SPLICE ENCLOSURE MODIFY EXISTING SPLICE ENCLOSURE OR INTERCONNECT CENTER 32 > INSTALL POLE MOUNTED SPLICE CABINET 33 > REMOVE EXISTING SPLICE CABINET INSTALL CABINET FOUNDATION INSTALL CCTV CAMERA POLE MOUNTED CABINET INSTALL CCTV CAMERA ASSEMBLY INSTALL CCTV CAMERA WOOD POLE INSTALL CCTV CAMERA METAL POLE AND FOUNDATION INSTALL STANDARD JUNCTION BOX INSTALL OVERSIZED JUNCTION BOX INSTALL SPECIAL OVERSIZED JUNCTION BOX $(36" \times 36" \times 24")$ REMOVE EXISTING JUNCTION BOX INSTALL WOOD POLE REMOVE EXISTING WOOD POLE INSTALL AERIAL GUY ASSEMBLY INSTALL STANDARD GUY ASSEMBLY INSTALL SIDEWALK GUY ASSEMBLY INSTALL MESSENGER CABLE REMOVE EXISTING MESSENGER AND COMMUNICATIONS CABLE REMOVE EXISTING COMMUNICATIONS CABLE REMOVE EXISTING MESSENGER CABLE REMOVE EXISTING COMMUNICATIONS CABLE MOUNTING HARDWARE FROM WOOD POLE INSTALL CELLULAR MODEM AND ANTENNA INSTALL CABLE STORAGE RACK(S) [SNOW SHOE(S)] AND STORE 100 FEET OF CABLE INSTALL DELINEATOR MARKER INSTALL JUNCTION BOX MARKER STORE 20 FEET OF COMMUNICATIONS

LASH CABLE(S) TO EXISTING

SIGNAL/COMMUNICATIONS CABLE

LASH CABLE(S) TO EXISTING MESSENGER **CABLE** LASH CABLE(S) TO NEW MESSENGER MODIFY EXISTING ELECTRICAL SERVICE INSTALL NEW ELECTRICAL SERVICE INSTALL NEW POLE MOUNTED DMS **CABINET** INSTALL NEW POLE MOUNTED EQUIPMENT CABINET INSTALL DISCONNECT ON DMS STRUCTURE INSTALL PEDESTAL-TYPE SIGN STRUCTURE, FOUNDATION, AND DMS ASSEMBLY BOND TRACER WIRE TO EQUIPMENT GROUND BUS DO NOT BOND TRACER WIRE TO **EQUIPMENT GROUND BUS** BOND RISER AND MESSENGER CABLE TO POLE GROUND BOND RISER TO POLE GROUND BOND MESSENGER TO POLE GROUND INSTALL HEATSHRINK TUBING RETROFIT INSTALL MOLDABLE DUCT SEAL SLACK SPAN


R-3300B CONSTRUCTION NOTE SYMBOLOGY KEY INDICATES NUMBER OF CABLES, LOOPS, ETC. INDICATES NUMBER OF FIBERS PER CABLE, XX TWISTED PAIRS PER CABLE, ETC. $\langle xx \mid$ INDICATES NUMBER OF RISER(S)/CONDUIT(S) INDICATES DIAMETER OF RISER(S)/CONDUIT(S) (INCH) XX NUMBER OF FIBERS/TWISTED PAIRS CABLE(S) (xx)/ $\langle \mathbf{x} \mathbf{x} \rangle$ NEW/EXISTING CABLE XX REMOVE/MODIFY CABLE XX \mathbf{X} CONDUIT/RISER DIAMETER **NUMBER** RISER(S)/CONDUIT(S) (INCH) RISER(S)/CONDUIT(S) ATTACHMENT POINT / XX"/SS \ DISTANCE ABOVE (IN)/ATTACHMENT POINT REFERENCE POINT YYY REFERENCE POINT DISTANCE BELOW (IN)/ATTACHMENT POINT

"SS" REFERENCE LOCATION

FS = FRONT SIDE OF POLE

BS = BACK SIDE OF POLE

CABLE ROUTING LEGEND

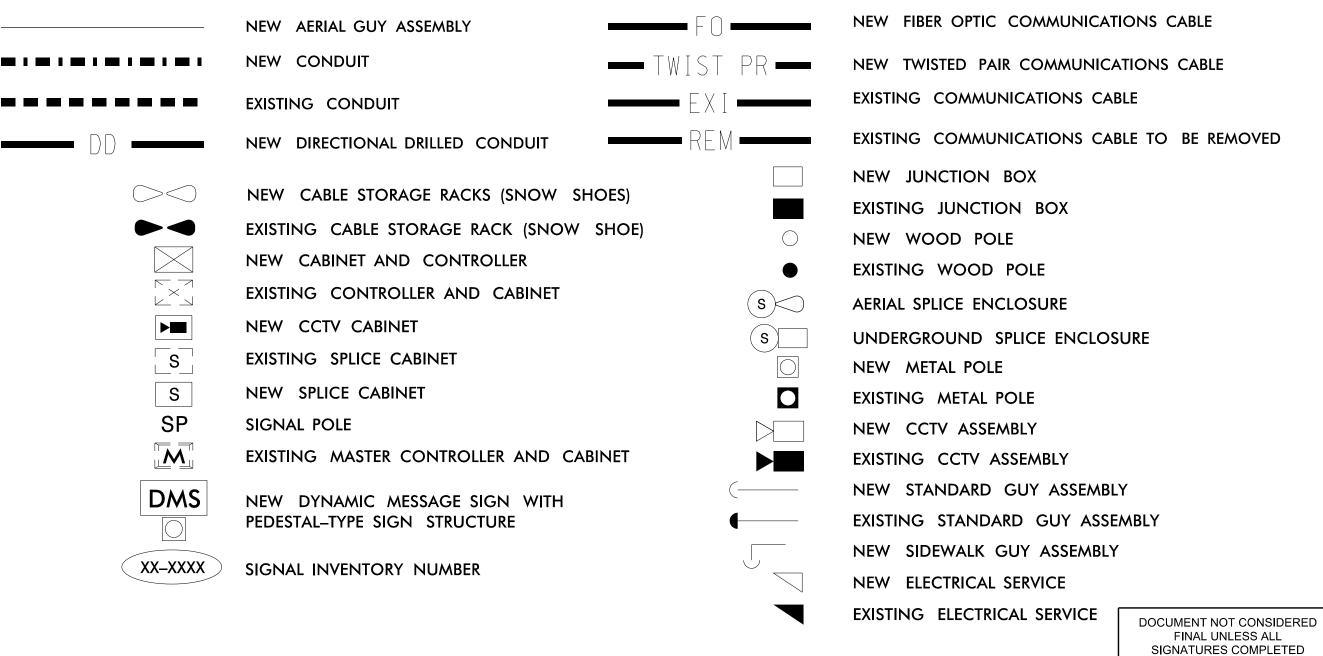



50 N.Greenfield Pkwy,Garner,NC 27

US 17/NC 210 Construction Notes and Legend

Division 3 Pender County Near Topsail Beach PLAN DATE: OCTOBER 2021 REVIEWED BY: E D Harris PREPARED BY: R M Muncev REVIEWED BY: L Overn REVISIONS INIT. DATE

FESS/ON 43239 YCINER Regina M. Municy10/5/2021 CADD Filename:

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PROJECT REFERENCE NO.

SCP-2

REUSE EXISTING CELL MODEM INSTALLED IN SIGNAL CABINET DURING TMP PHASE I, STEP 2 (SEE 03-0413T1).

PROJECT REFERENCE NO. SCP-3 R-3300B

(1 /6 12) (29) SP-01-S US 17/NC 210 SHEET _____ 03-0413 50 53 63 NOTE: 1. FIVE (5) DAYS PRIOR TO BEGINNING WORK ON THE SIGNAL SYSTEM, CONTACT THE NCDOT DIVISION 3 TRAFFIC ENGINEER AT 910–341–2200 TO ARRANGE FOR NCDOT TO PROGRAM THE NEW FIELD ETHERNET SWITCHES WITH THE NECESSARY NETWORK CONFIGURATION DATA, INCLUDING BUT NOT LIMITED TO: THE PROJECT IP ADDRESS, DEFAULT GATEWAY, SUBNET MASK, AND VLAN ID INFORMATION. NOTIFY THE DIVISION 3 TRAFFIC ENGINEER AFTER ALL WORK IS PERFORMED TO ENSURE THAT ALL FIBER CIRCUITS ARE FUNCTIONING PROPERLY.

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US 17/NC 210 Cable Routing Plans


Division 3 Pender County Near Topsail Beach
PLAN DATE: OCTOBER 2021 REVIEWED BY: E D Harris REVIEWED BY: L Overn 750 N.Greenfield Pkwy,Garner,NC 27529 | PREPARED BY: R M Muncey REVISIONS Regina M. Muncey 10/5/2021 CADD Filename:

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PROJECT REFERENCE NO. SHEET NO. R-3300B SCP-4 MATCHLINE

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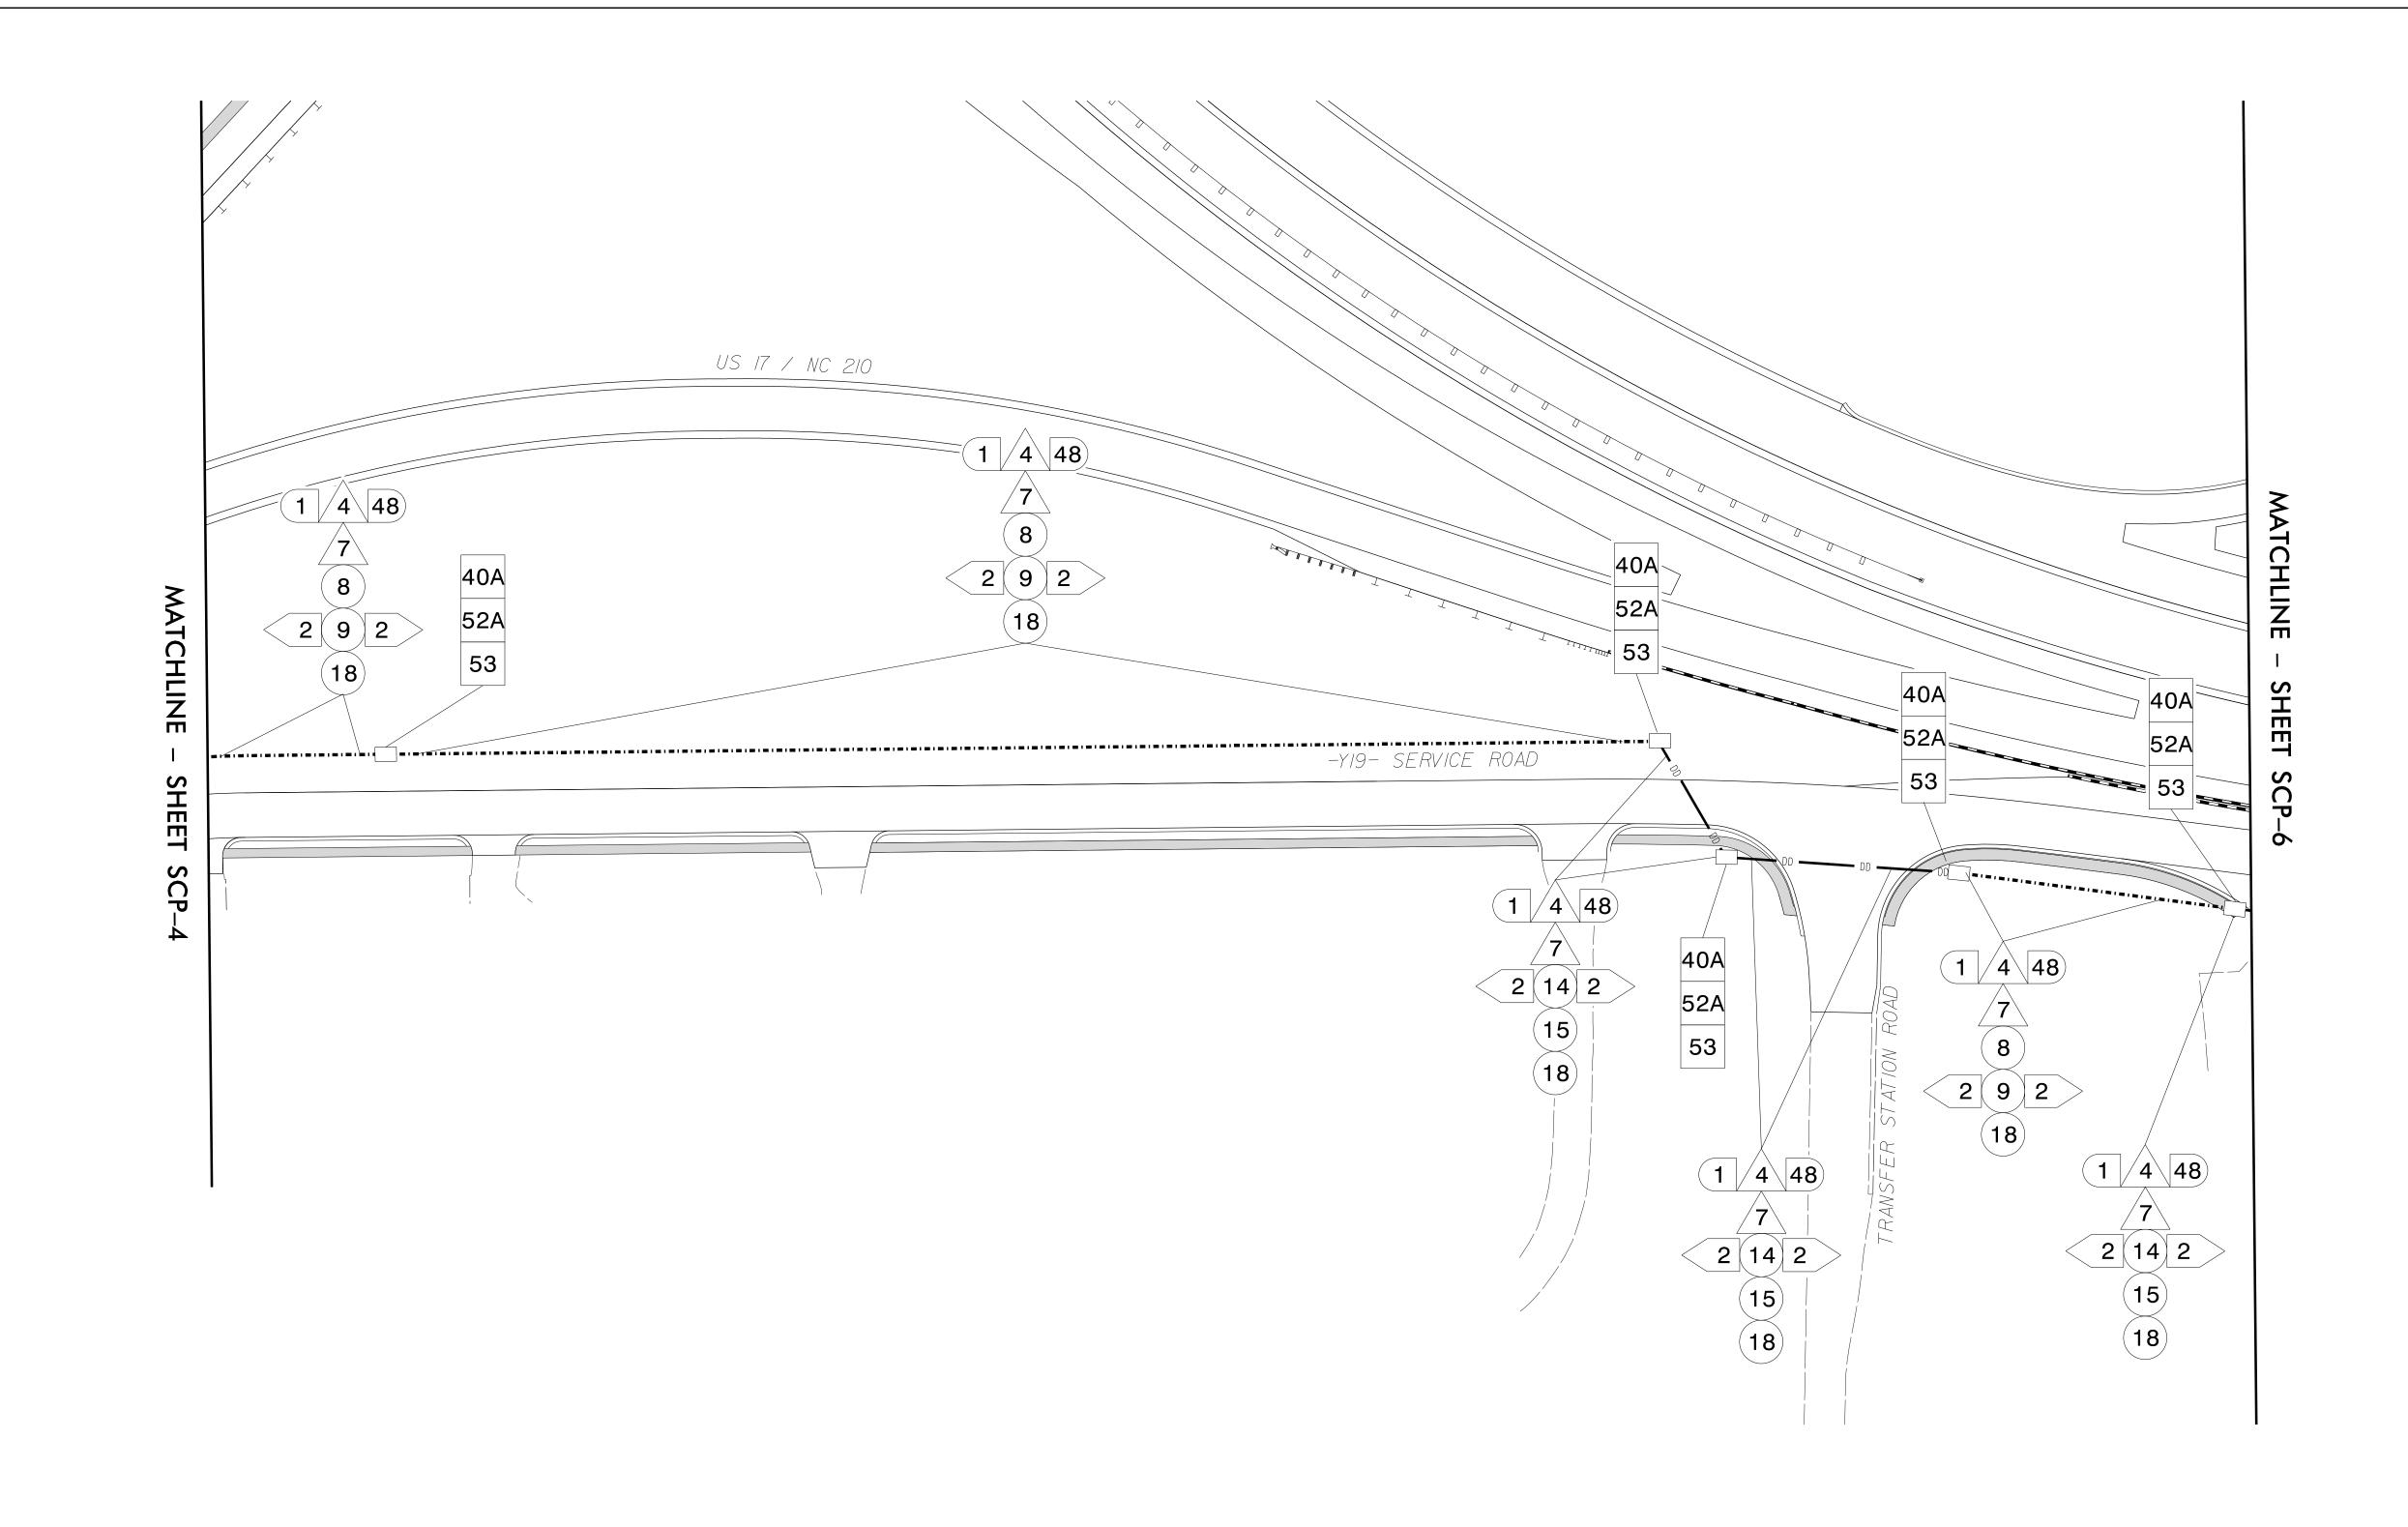


US 17/NC 210 Cable Routing Plans

Division 3 Pender County Near Topsail Beach
PLAN DATE: OCTOBER 2021 REVIEWED BY: E D Harris REVIEWED BY: L Overn 750 N.Greenfield Pkwy,Garner.NC 27529 PREPARED BY: R M Muncey REVISIONS 1"=50' CADD Filename:
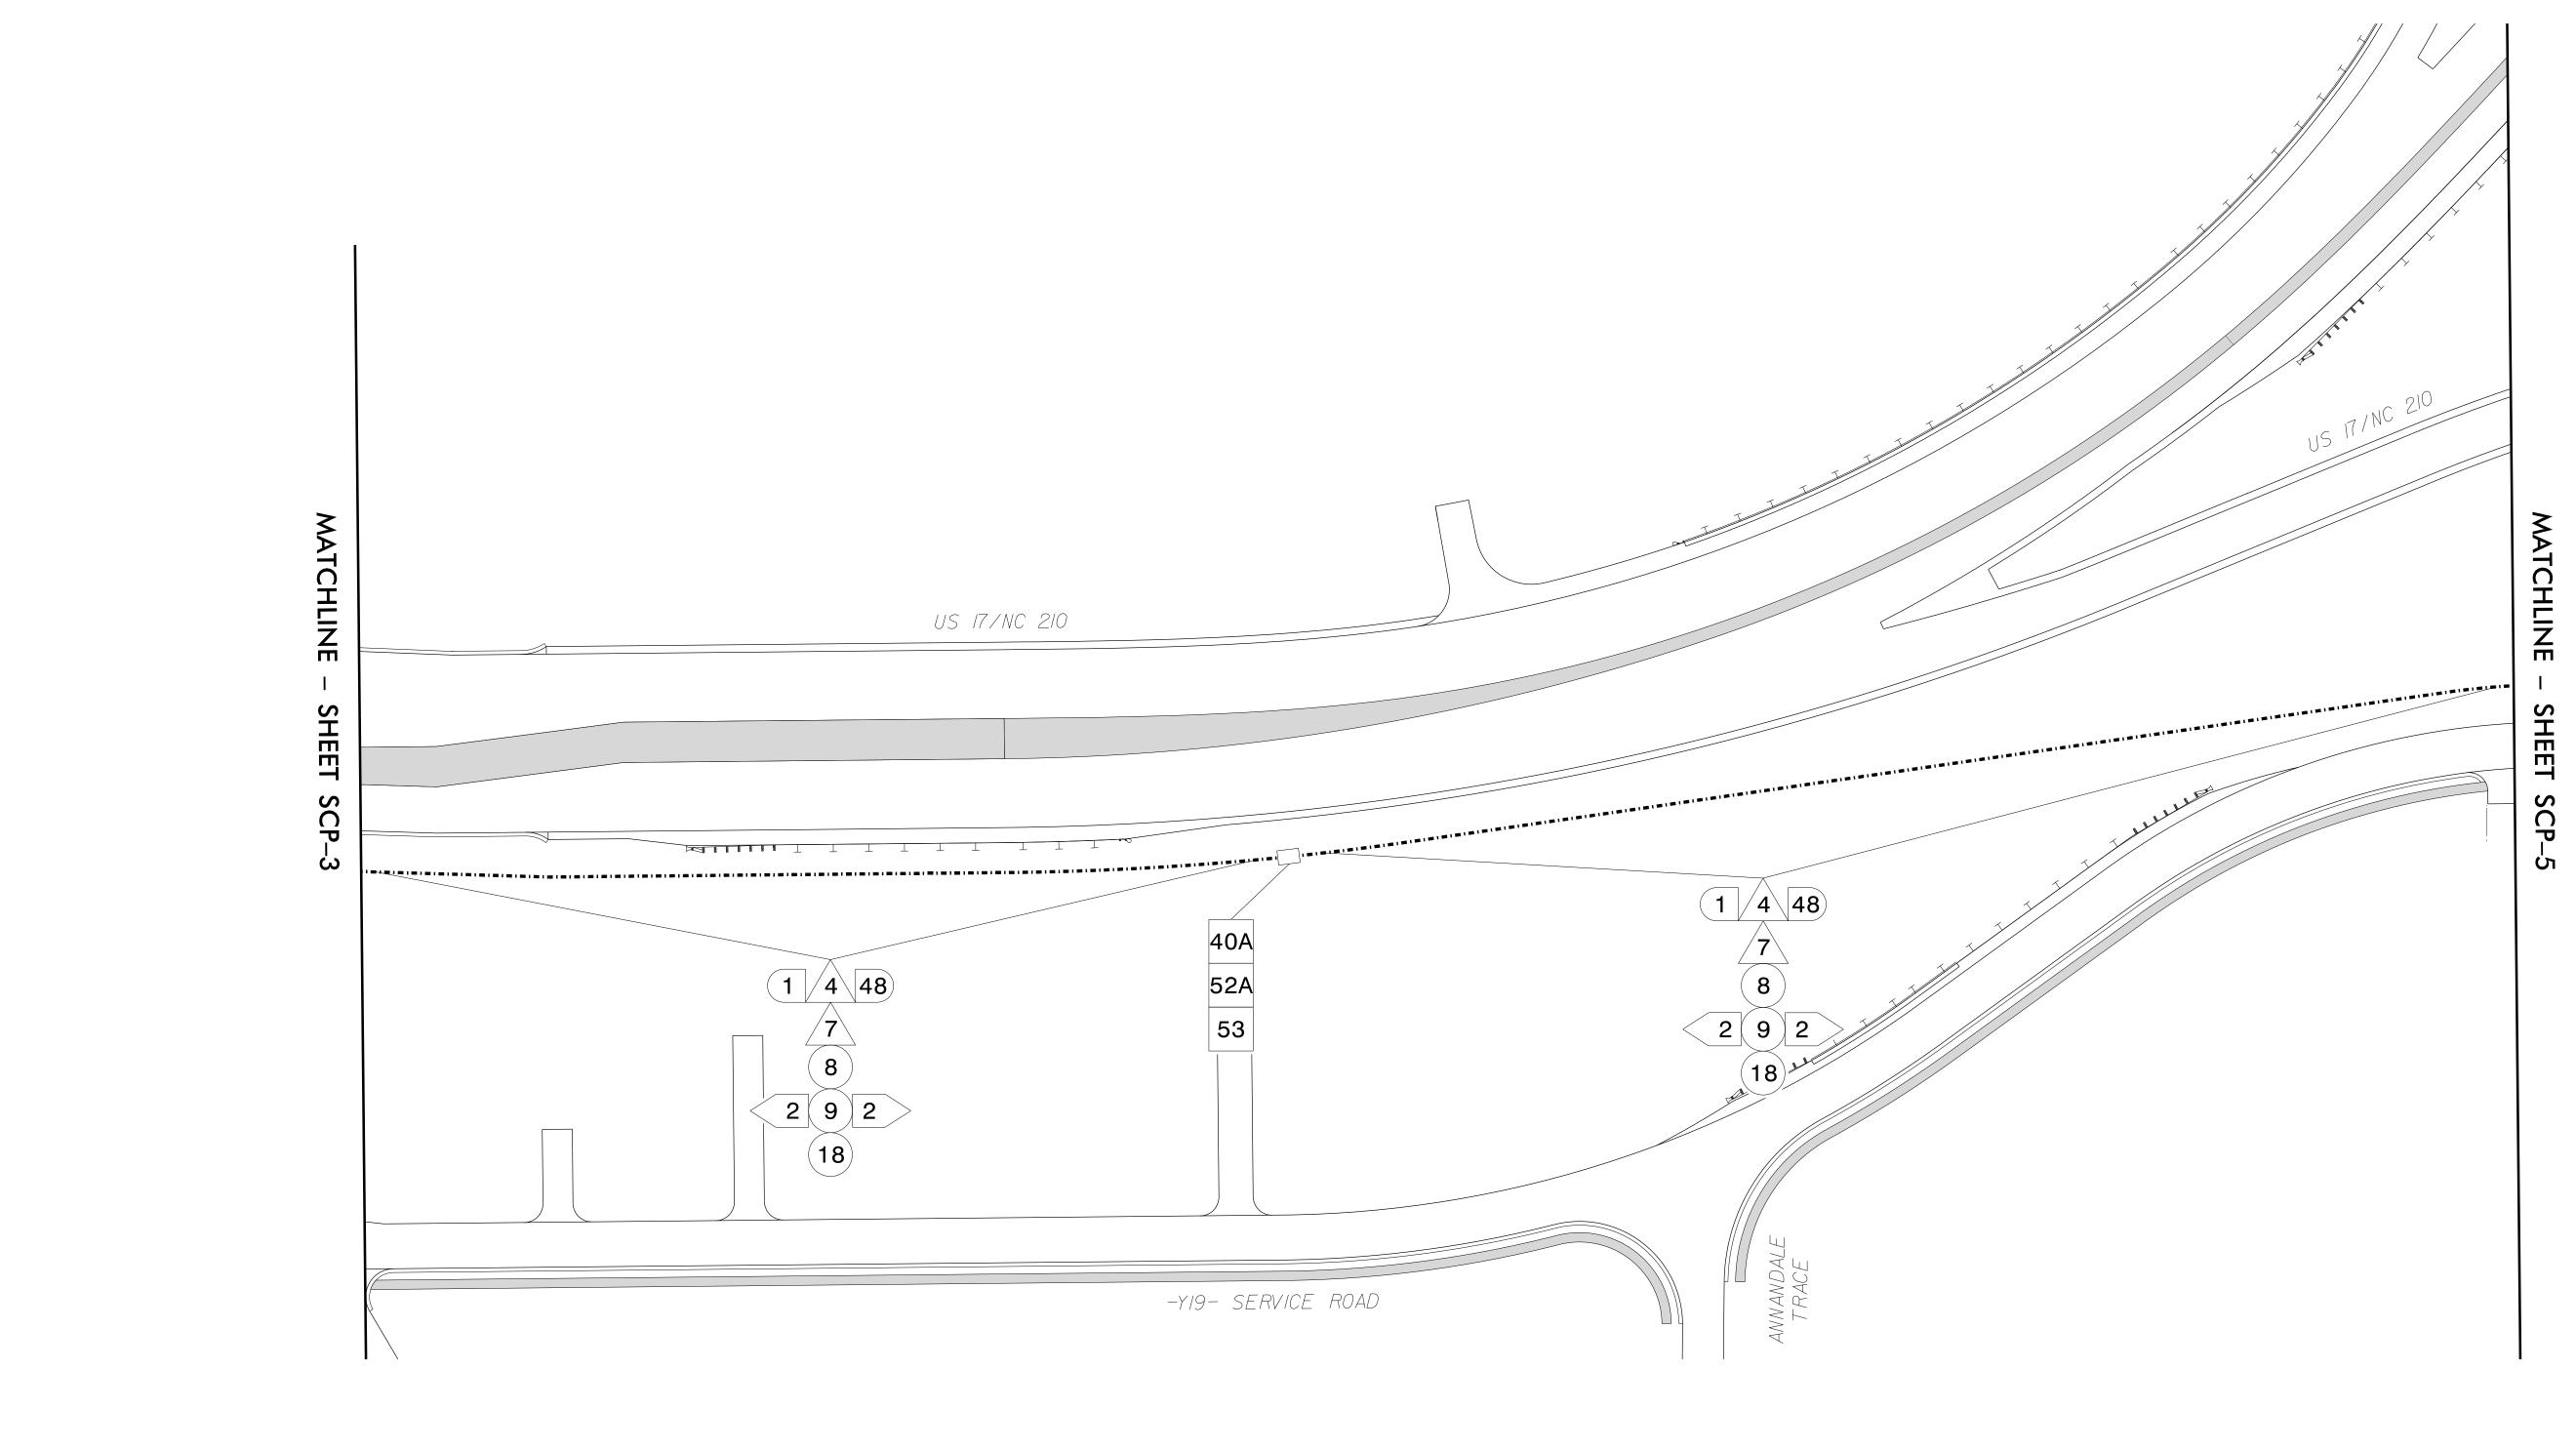
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PROJECT REFERENCE NO. SHEET NO. R-3300B SCP-5





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1"=50'


US 17/NC 210 Cable Routing Plans

Division 3 Pender County Near Topsail Beach
PLAN DATE: OCTOBER 2021 REVIEWED BY: E D Harris REVIEWED BY: L Overn 750 N.Greenfield Pkwy,Garner,NC 27529 PREPARED BY: R M Muncey REVISIONS CADD Filename:

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PROJECT REFERENCE NO. R-3300B SCP-6



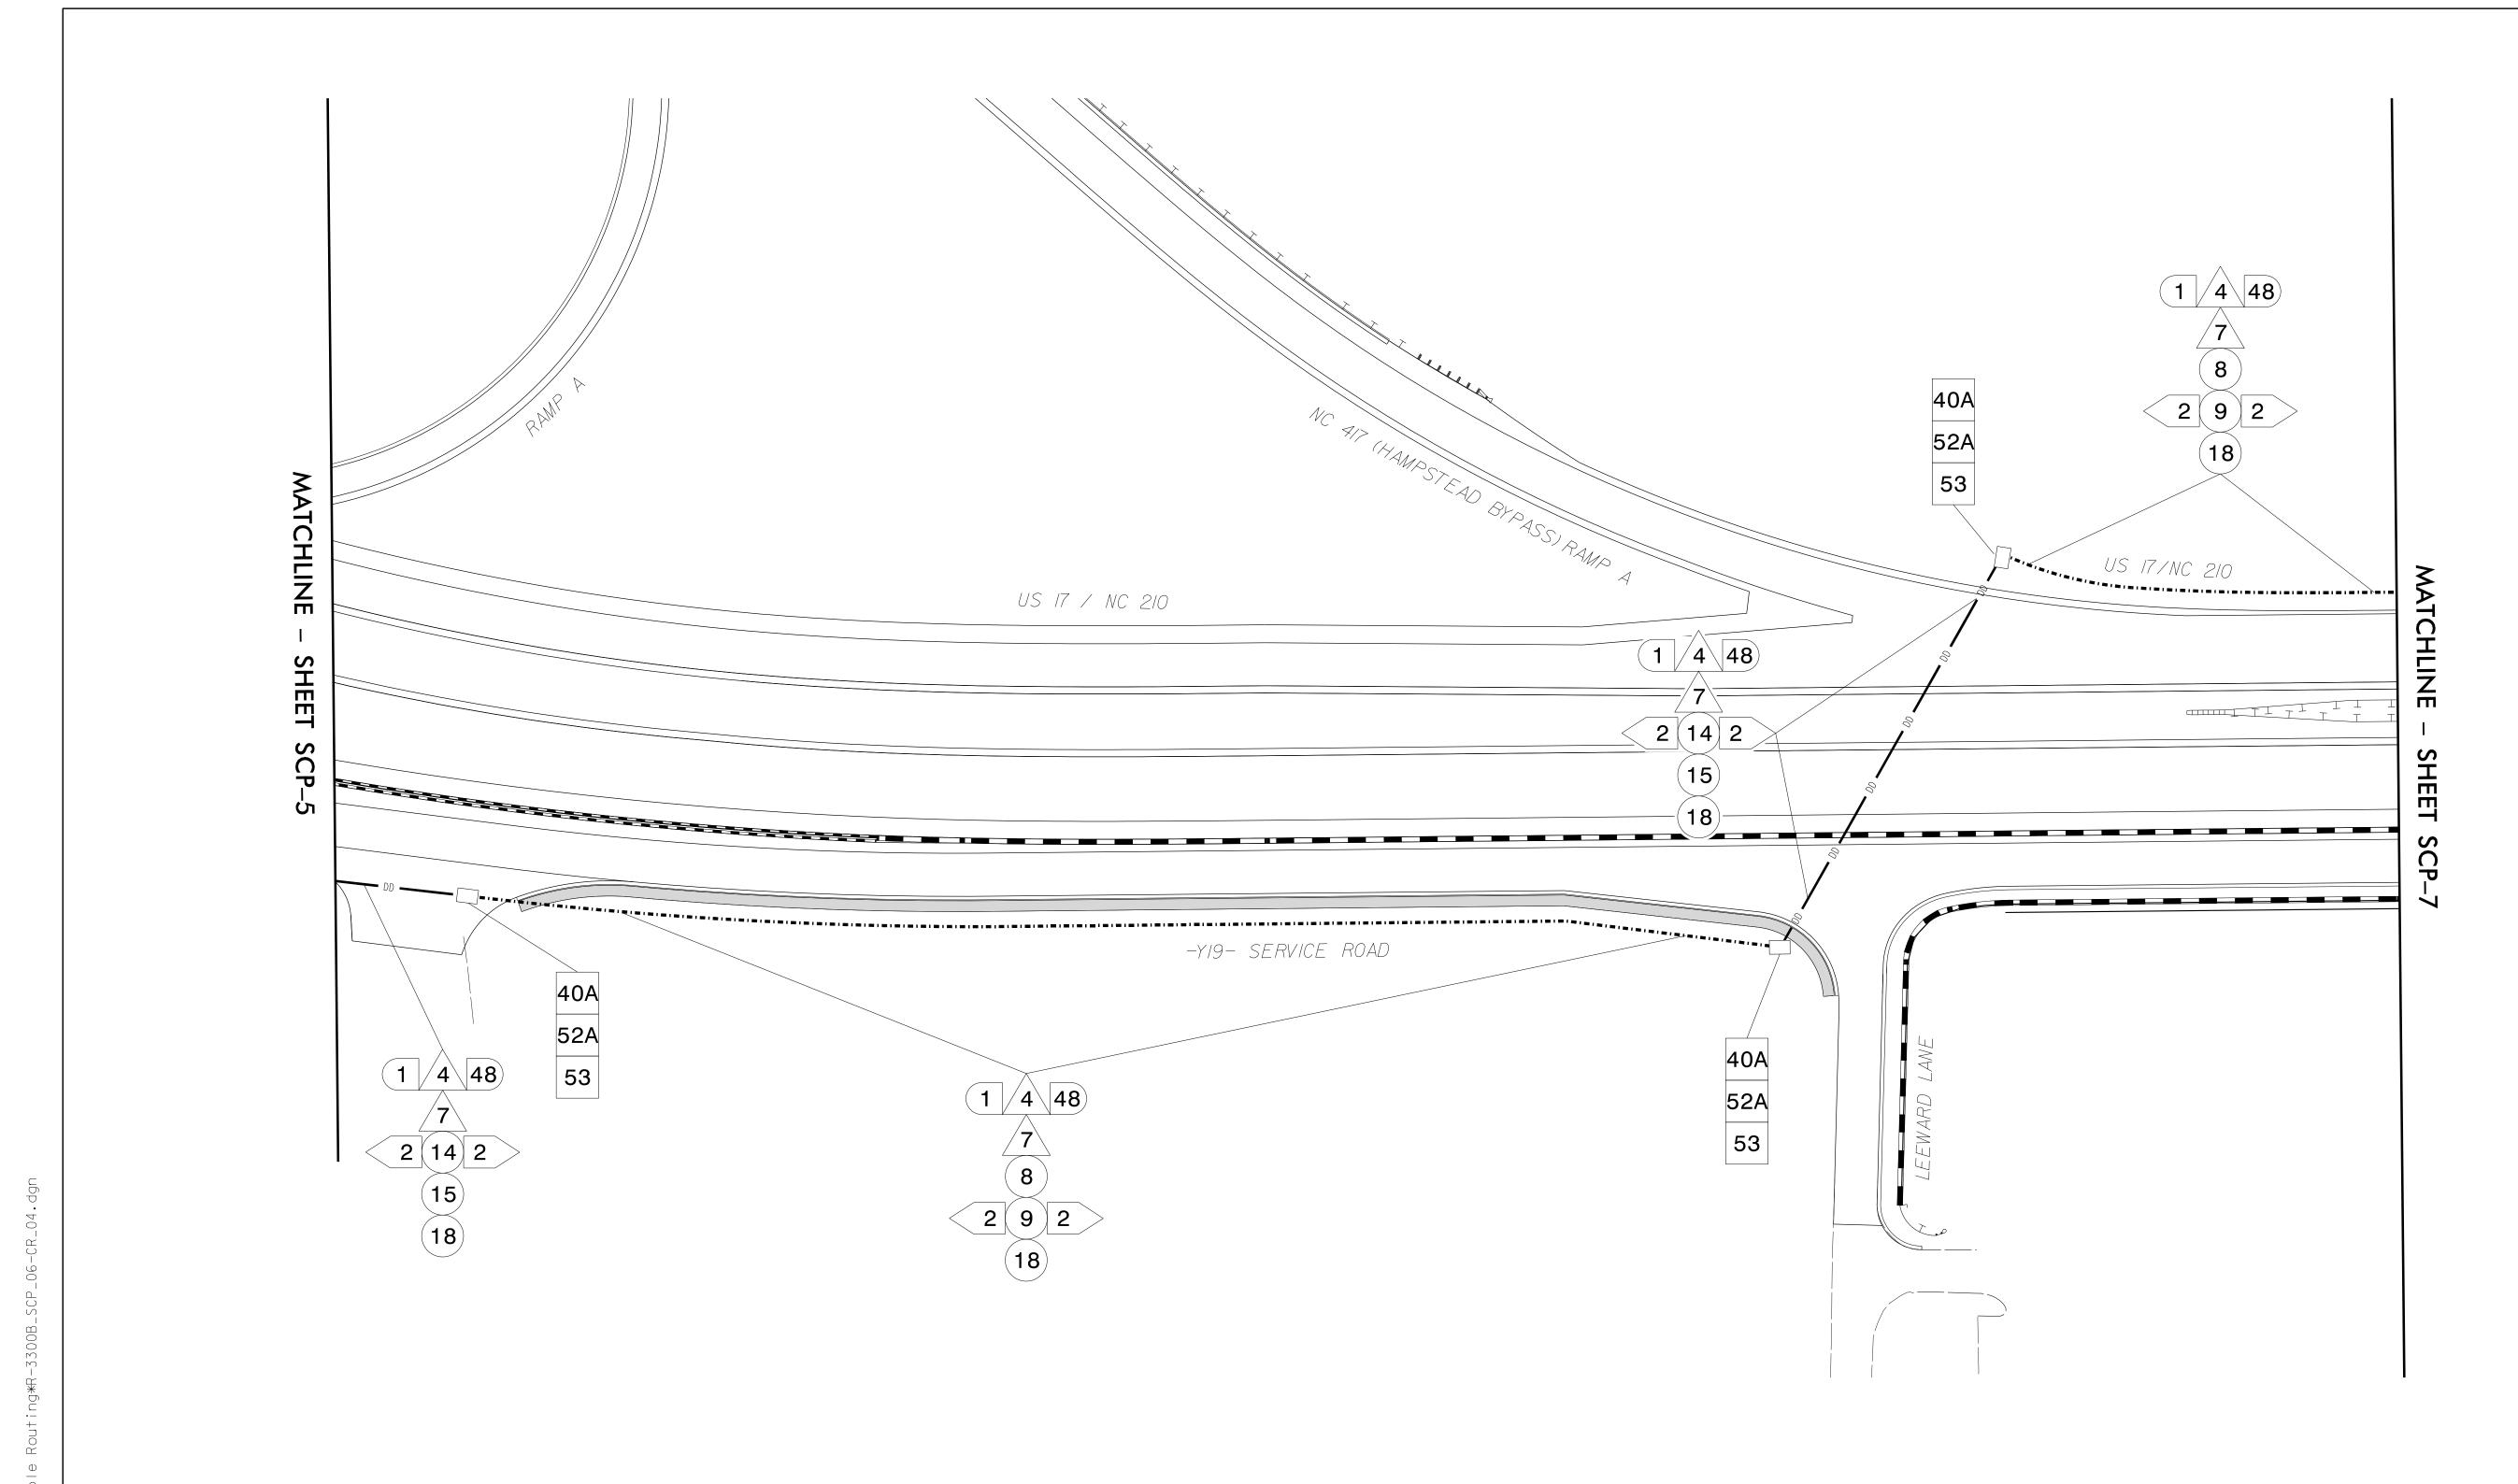

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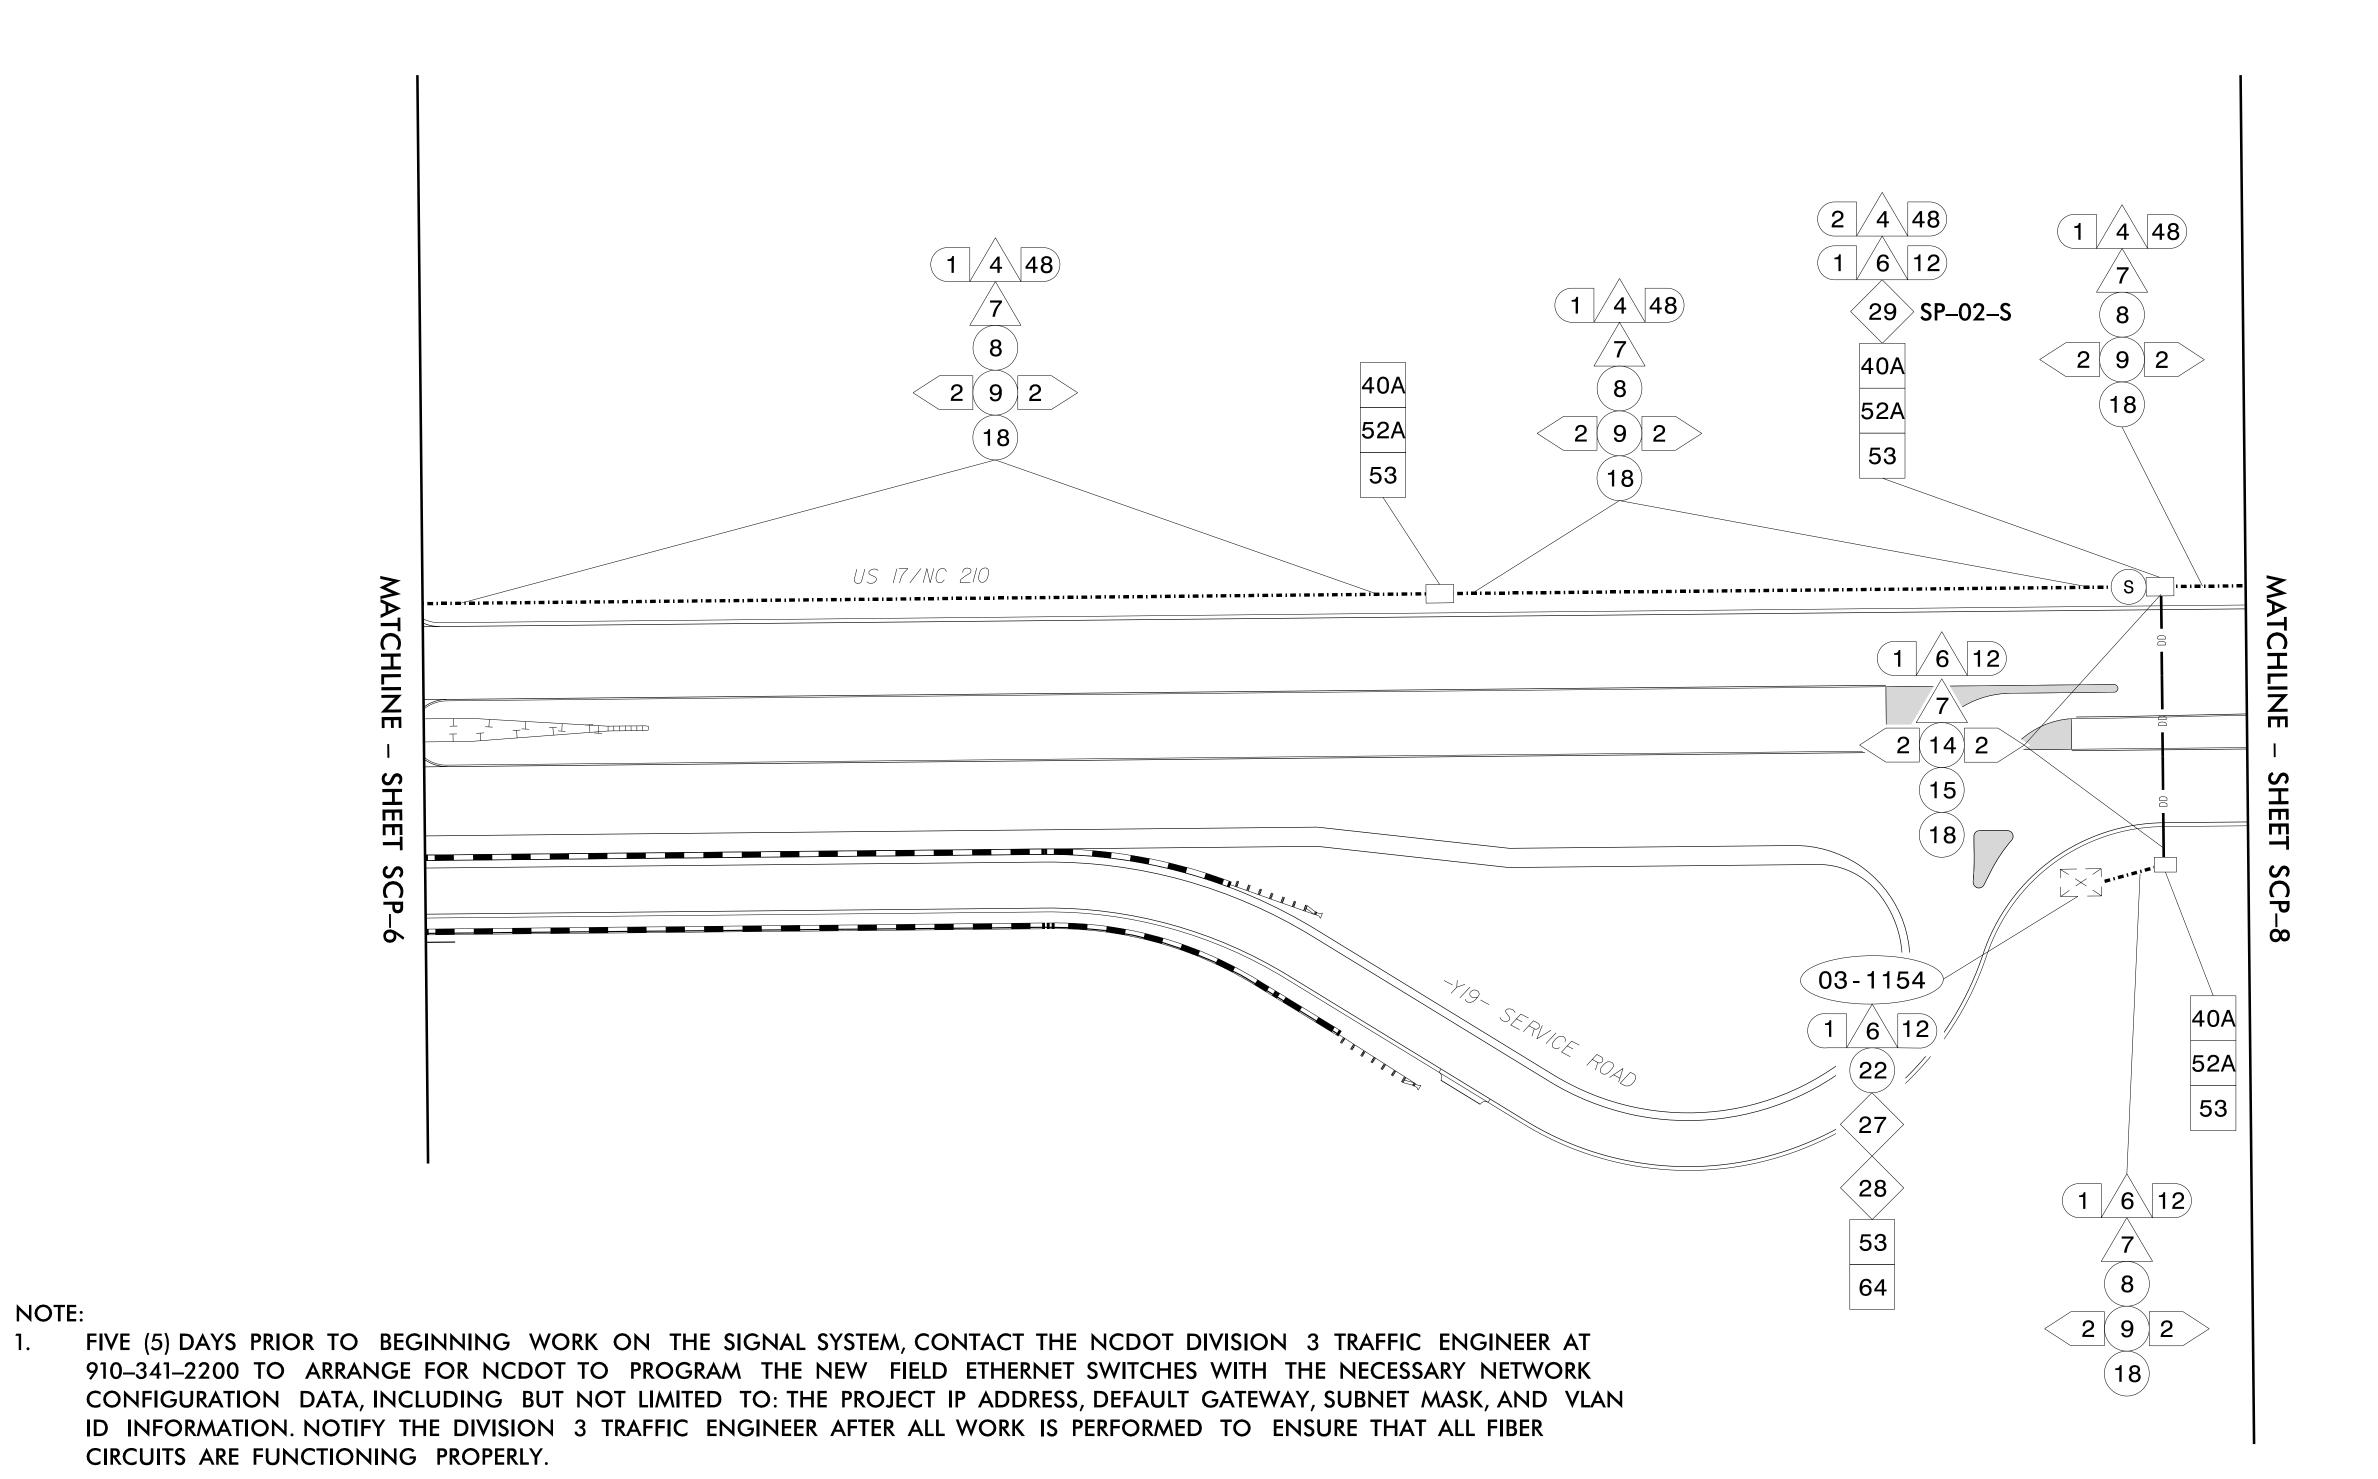
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US 17/NC 210 Cable Routing Plans

	Division 3 Pender County Ne	ar Topsail	. Beach
	PLAN DATE: OCTOBER 2021 REVIEWED BY:	E D Har	ris
27529	PREPARED BY: R M Muncey REVIEWED BY:	L Ove	rn
	REVISIONS	INIT.	DATE
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R-3300B SCP-7



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1"=50'

US 17/NC 210 Cable Routing Plans

Division 3 Pender County Near Topsail Beach
PLAN DATE: OCTOBER 2021 REVIEWED BY: E D Harris REVIEWED BY: 750 N.Greenfield Pkwy,Garner,NC 27529 | PREPARED BY: R M Muncey L Overn REVISIONS

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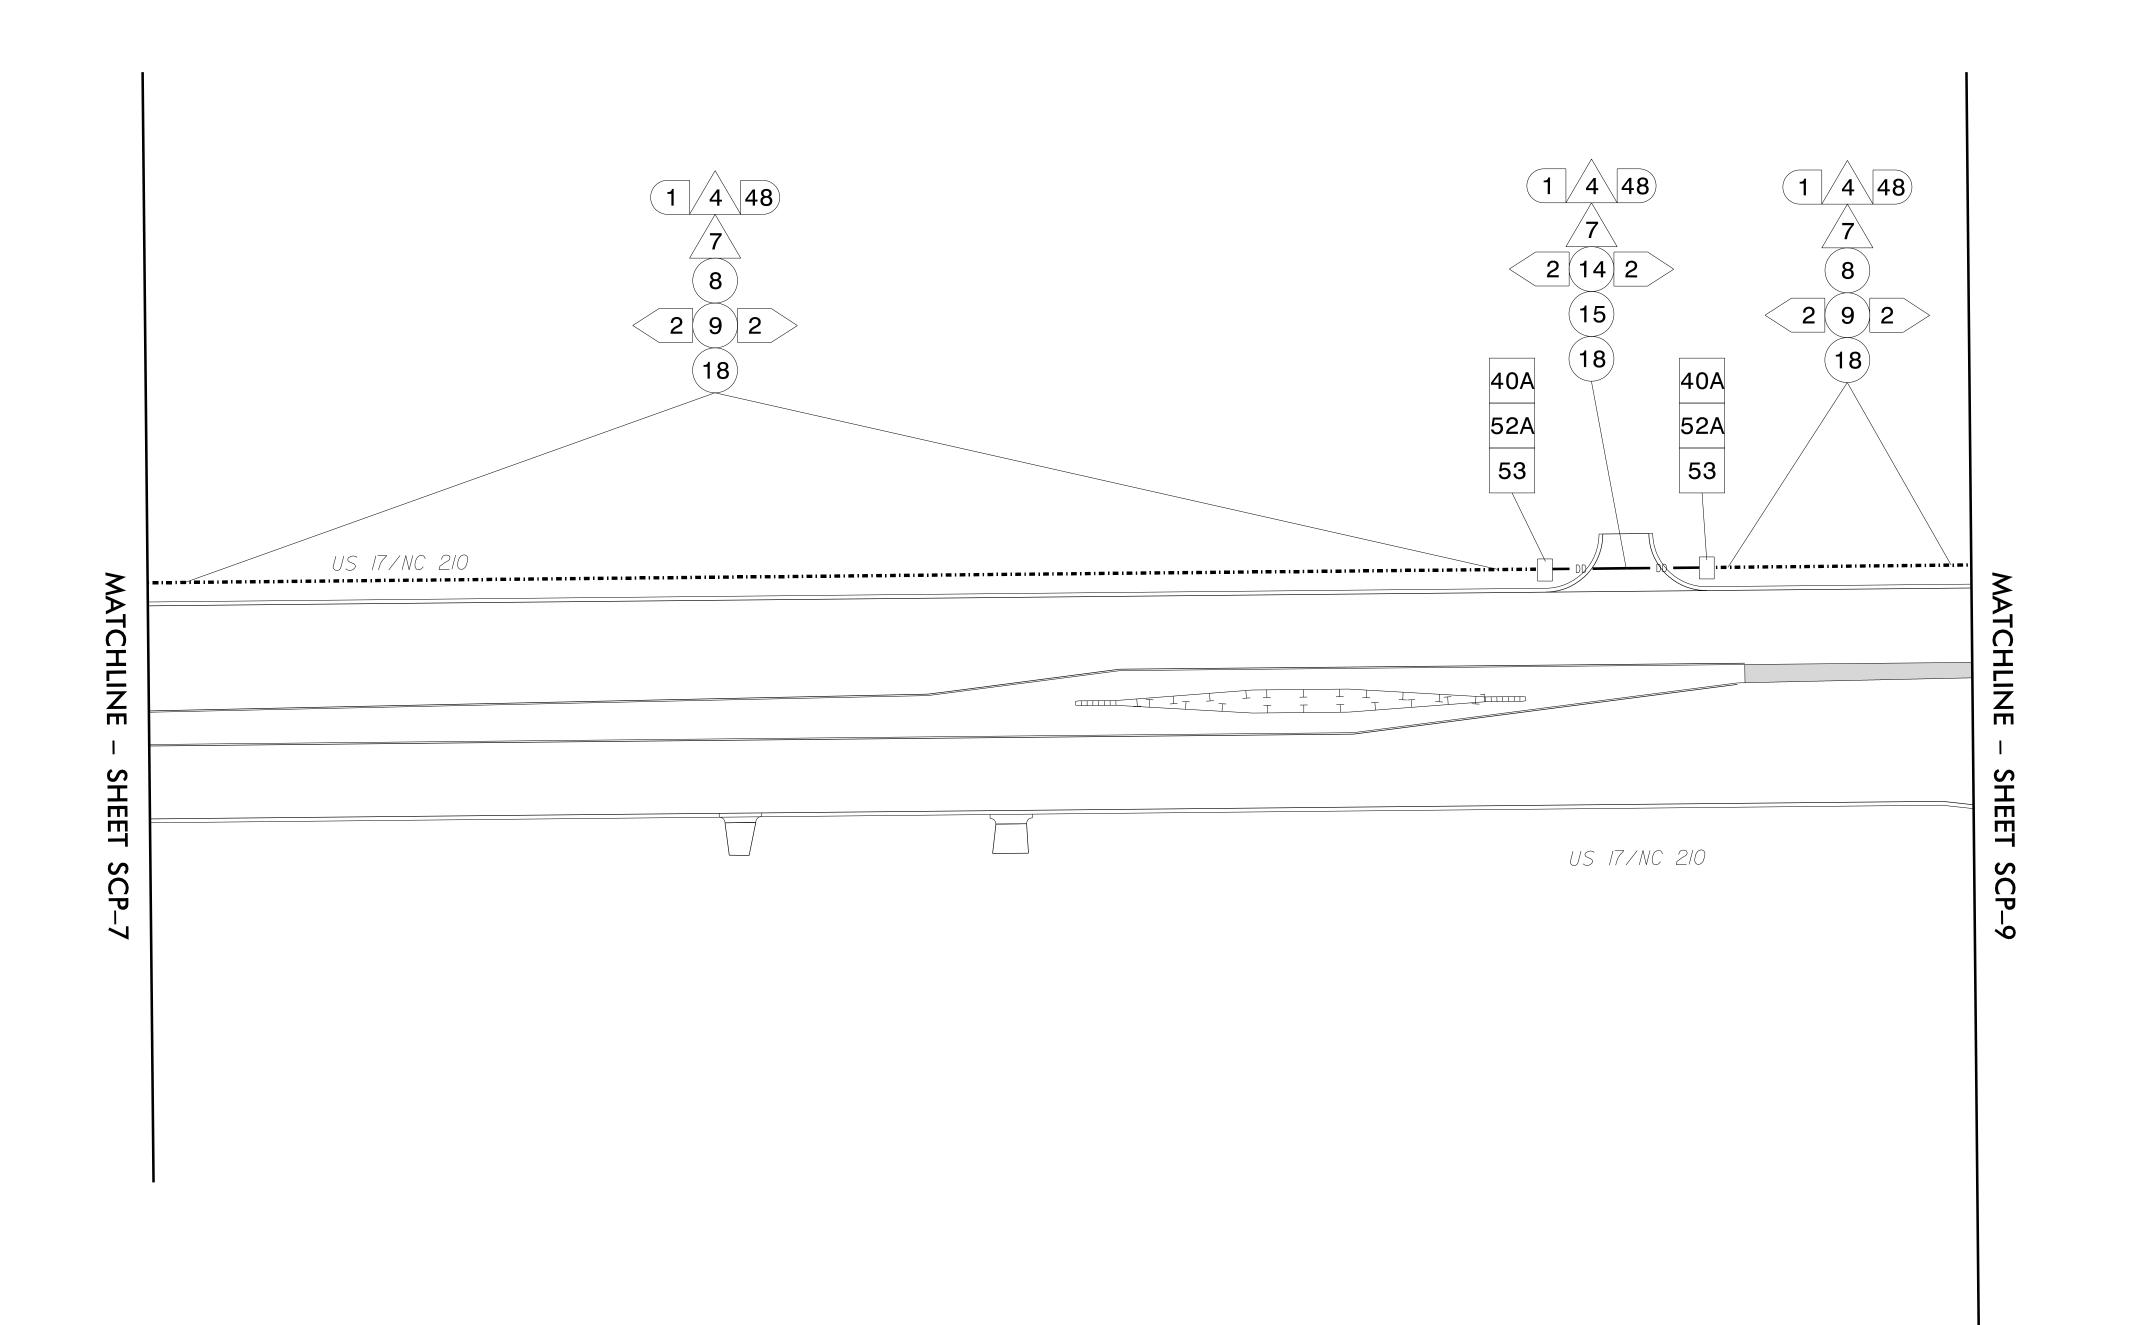
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PROJECT REFERENCE NO. SHEET NO. R-3300B SCP-8





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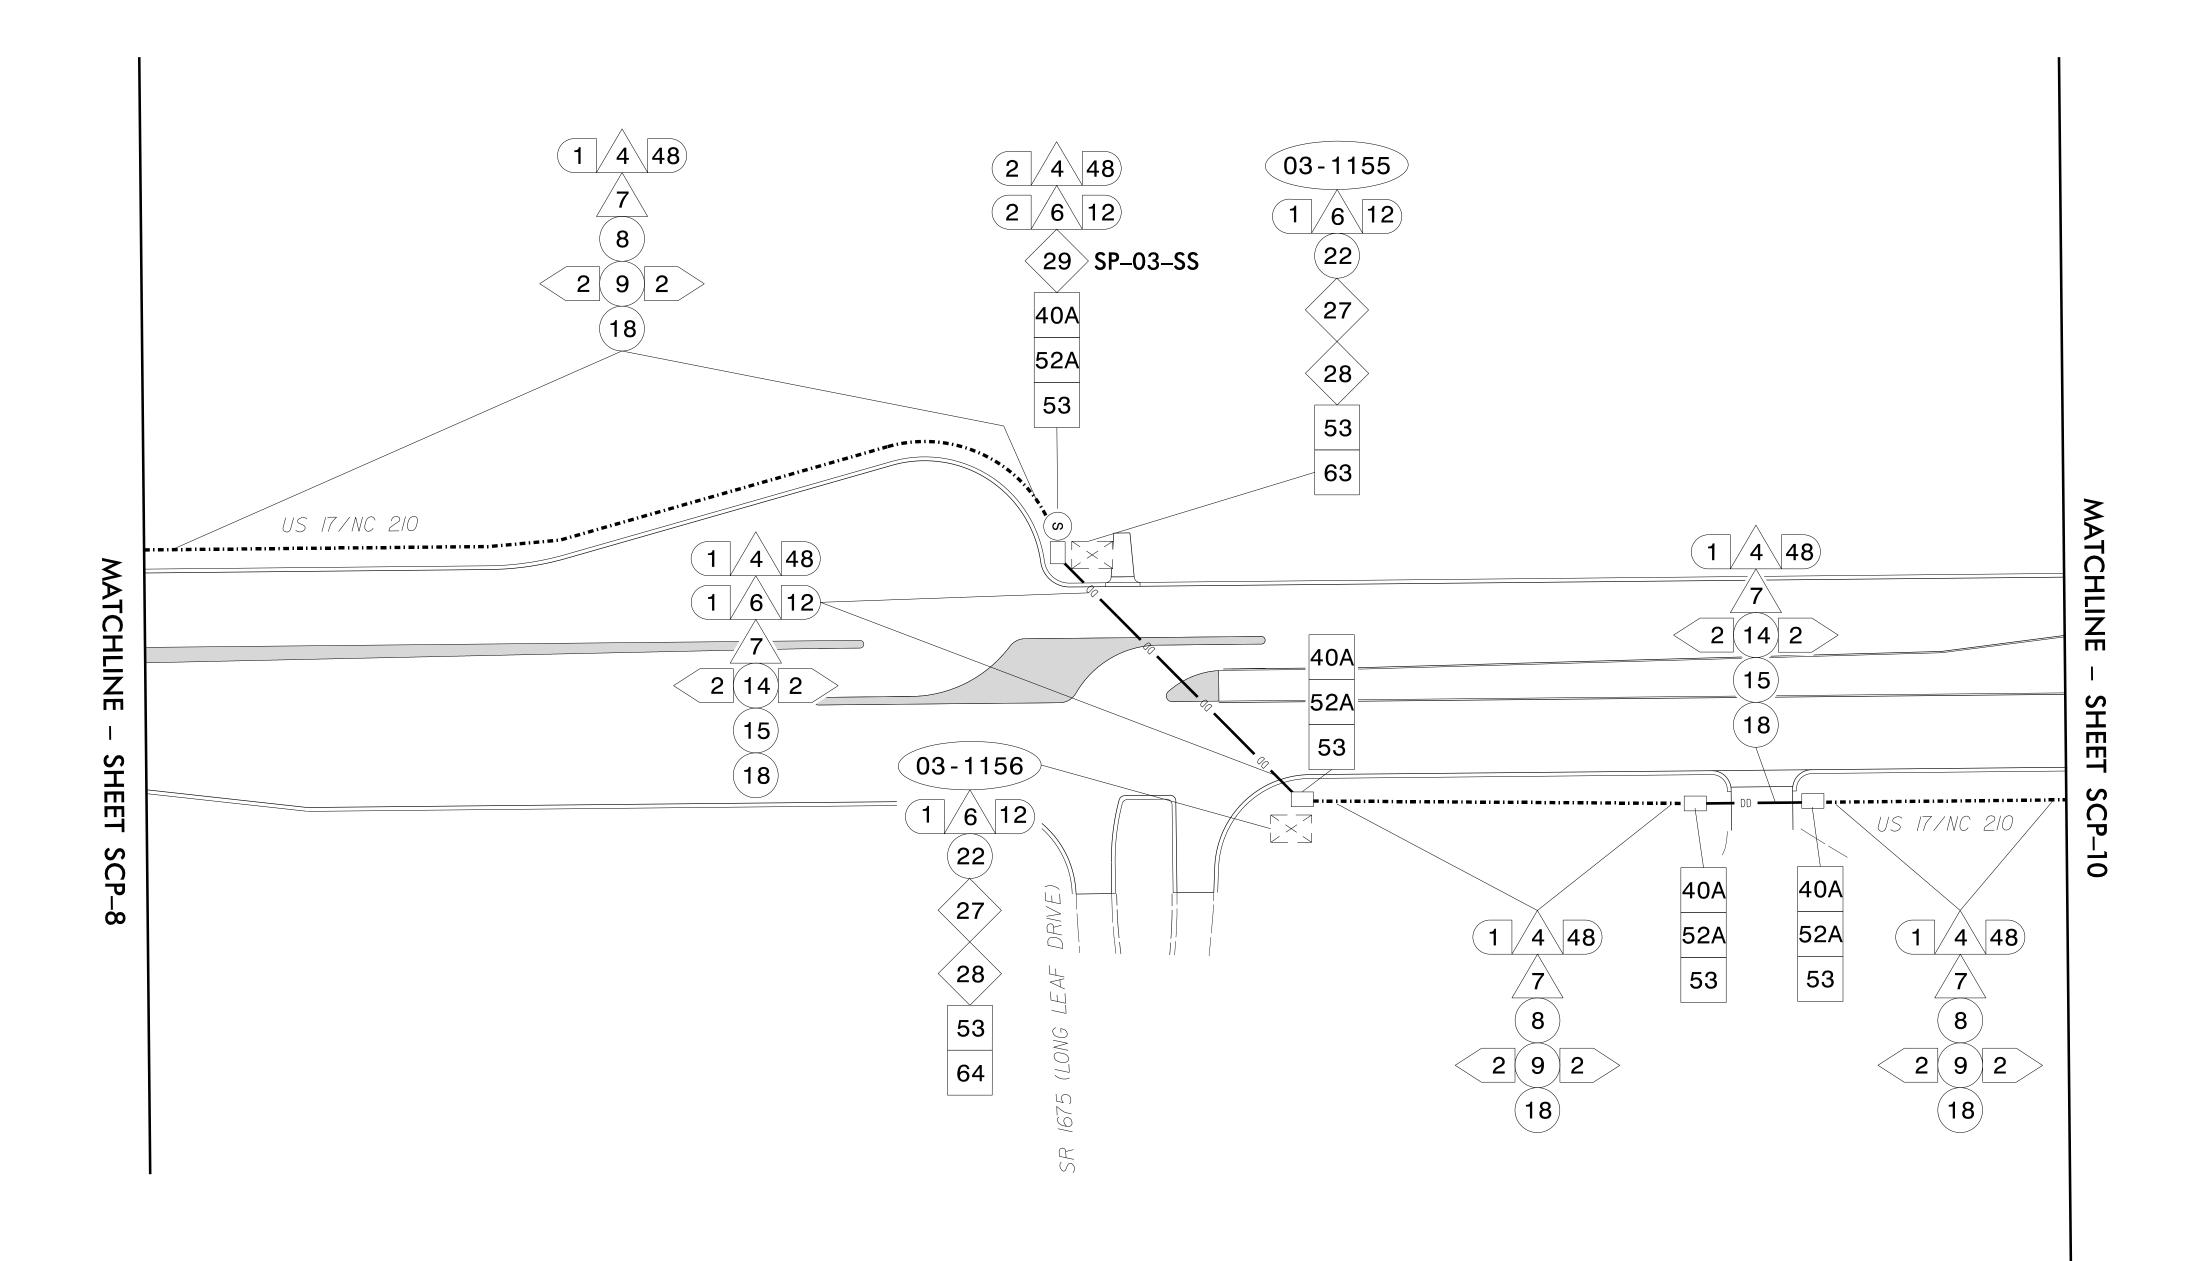
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US 17/NC 210 Cable Routing Plans

Section 1	Division 3 Pender County Nea	r Topsai.	l Beach	
	PLAN DATE: OCTOBER 2021 REVIEWED BY:	E D Ha	rris	
,NC 27529	PREPARED BY: R M Muncey REVIEWED BY:	L Ove	rn	
E	REVISIONS	INIT.	DATE	
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PROJECT REFERENCE NO. R-3300B SCP-9




NOTE:

FIVE (5) DAYS PRIOR TO BEGINNING WORK ON THE SIGNAL SYSTEM, CONTACT THE NCDOT DIVISION 3 TRAFFIC ENGINEER AT 910-341-2200 TO ARRANGE FOR NCDOT TO PROGRAM THE NEW FIELD ETHERNET SWITCHES WITH THE NECESSARY NETWORK CONFIGURATION DATA, INCLUDING BUT NOT LIMITED TO: THE PROJECT IP ADDRESS, DEFAULT GATEWAY, SUBNET MASK, AND VLAN ID INFORMATION. NOTIFY THE DIVISION 3 TRAFFIC ENGINEER AFTER ALL WORK IS PERFORMED TO ENSURE THAT ALL FIBER CIRCUITS ARE FUNCTIONING PROPERLY.



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1"=50'

US 17/NC 210 Cable Routing Plans

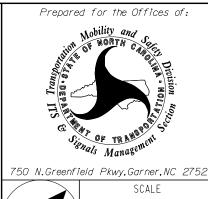Division 3 Pender County Near Topsail Beach
PLAN DATE: OCTOBER 2021 REVIEWED BY: E D Harris REVIEWED BY: L Overn 750 N.Greenfield Pkwy,Garner,NC 27529 | PREPARED BY: R M Muncey REVISIONS


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Regina M. Muncey 10/5/2021 CADD Filename:

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PROJECT REFERENCE NO. | SHEET NO. R-3300B SCP-10





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US 17/NC 210 Cable Routing Plans

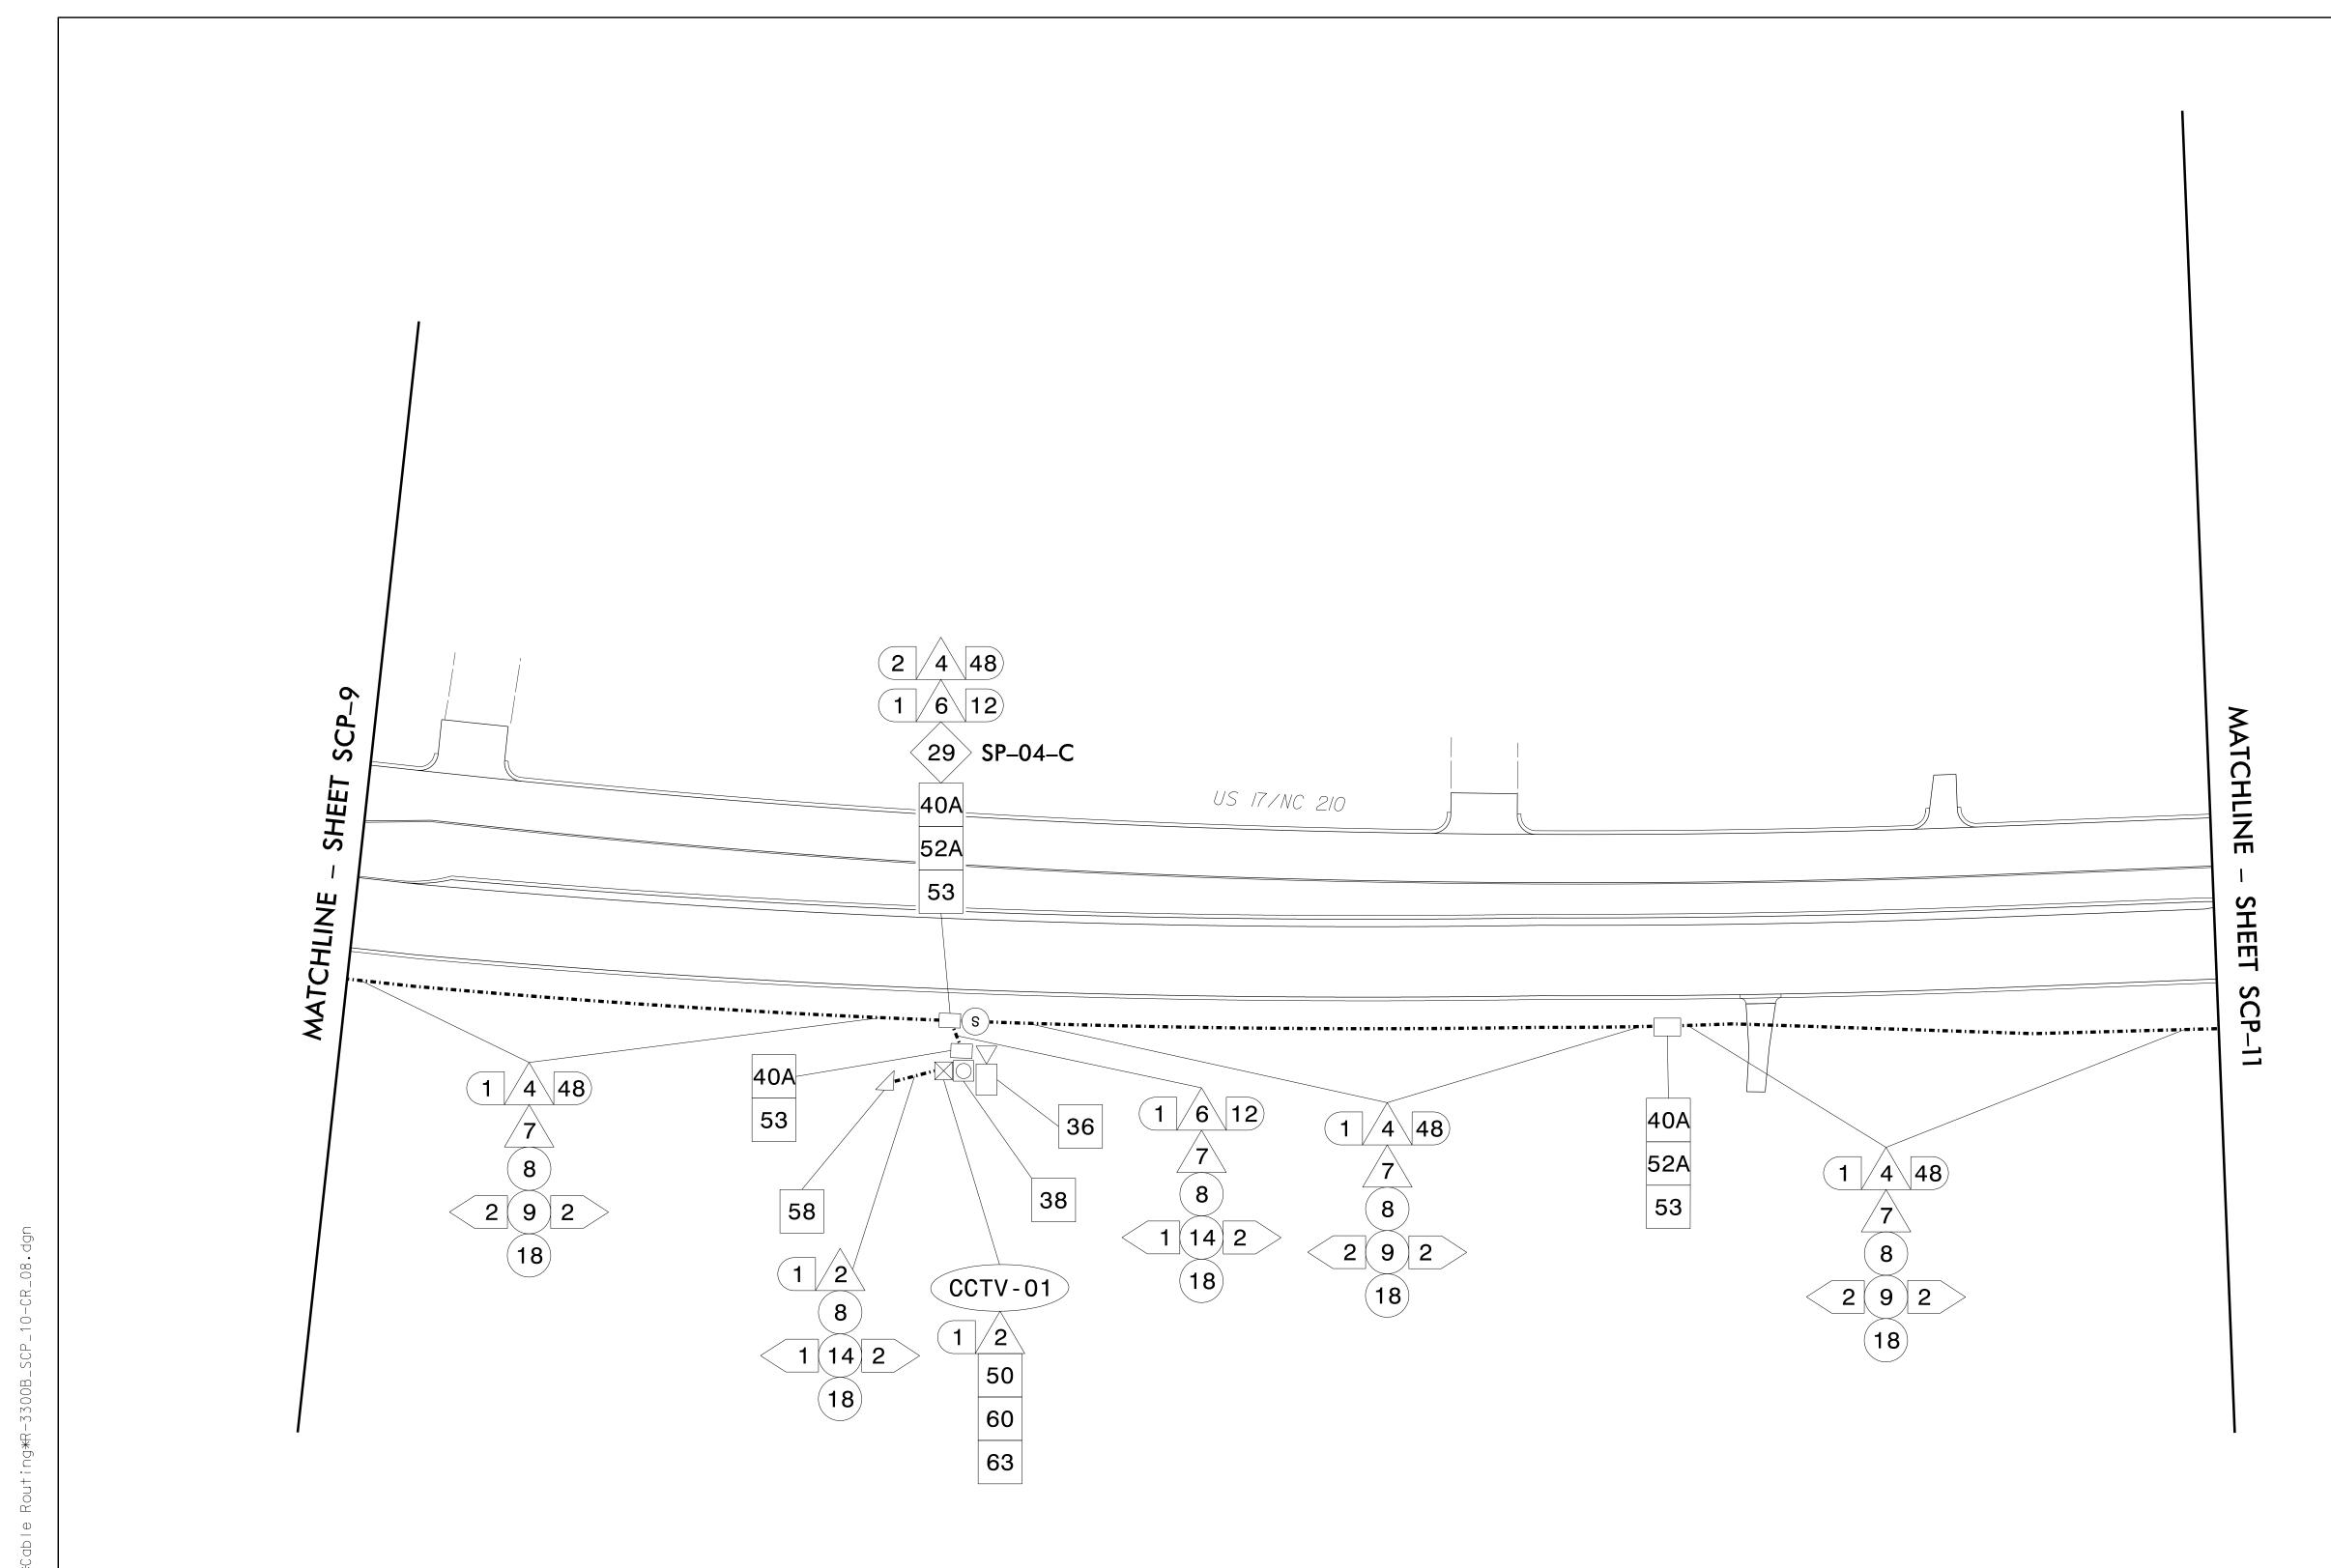Division 3 Pender County Near Topsail Beach
PLAN DATE: OCTOBER 2021 REVIEWED BY: E D Harris REVIEWED BY: L Overn 750 N.Greenfield Pkwy,Garner.NC 27529 PREPARED BY: R M Muncey REVISIONS CADD Filename:

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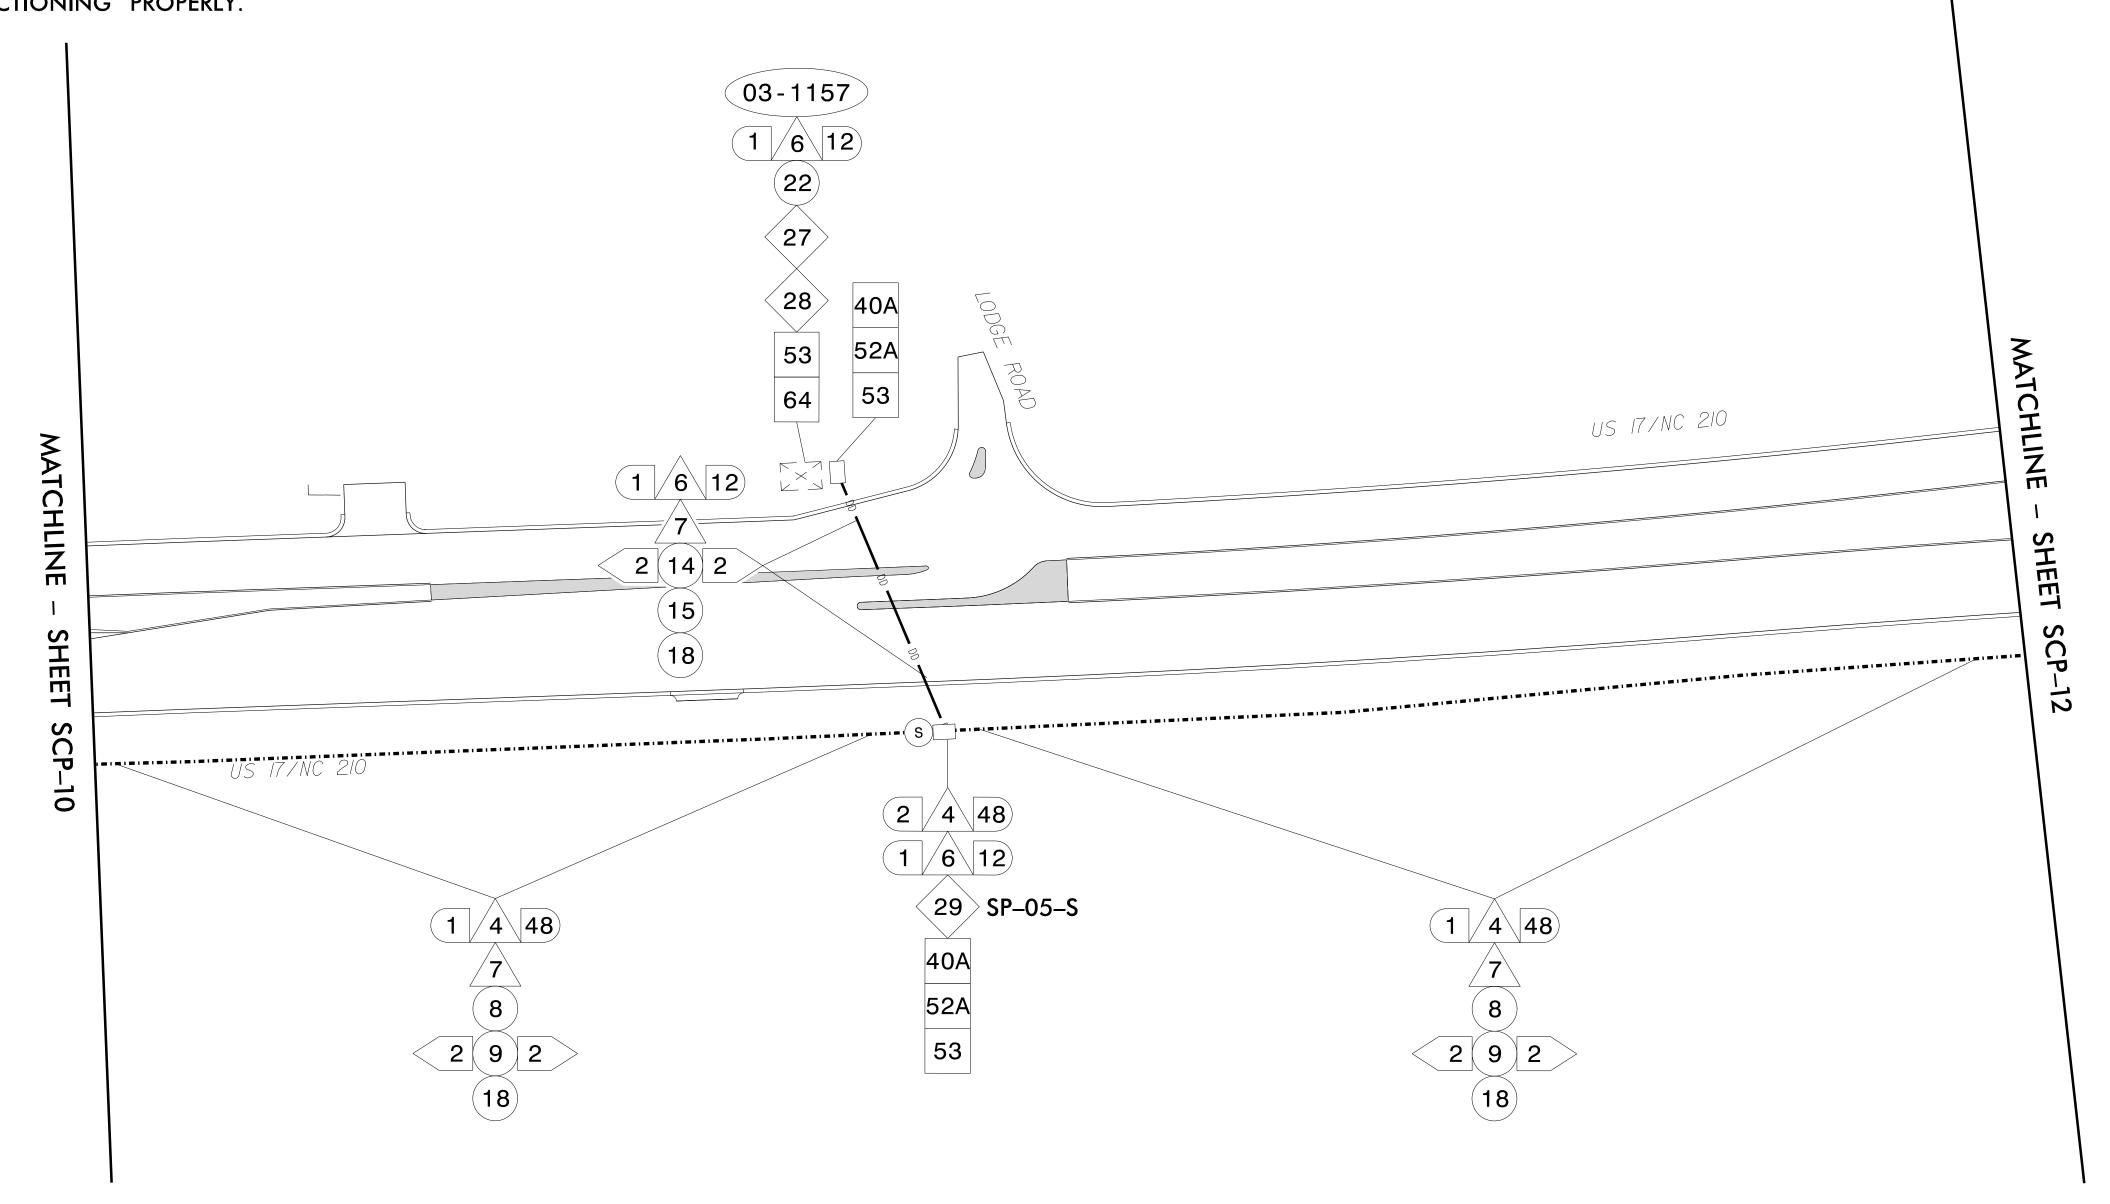
SIGNATURE

DATE

R-3300B SCP-11

NOTE:

1. FIVE (5) DAYS PRIOR TO BEGINNING WORK ON THE SIGNAL SYSTEM, CONTACT THE NCDOT DIVISION 3 TRAFFIC ENGINEER AT 910–341–2200 TO ARRANGE FOR NCDOT TO PROGRAM THE NEW FIELD ETHERNET SWITCHES WITH THE NECESSARY NETWORK CONFIGURATION DATA, INCLUDING BUT NOT LIMITED TO: THE PROJECT IP ADDRESS, DEFAULT GATEWAY, SUBNET MASK, AND VLAN ID INFORMATION. NOTIFY THE DIVISION 3 TRAFFIC ENGINEER AFTER ALL WORK IS PERFORMED TO ENSURE THAT ALL FIBER CIRCUITS ARE FUNCTIONING PROPERLY.





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US 17/NC 210 Cable Routing Plans

ection	Division 3	Pender Cour	nty Near	Topsail	. Beach
	PLAN DATE:	OCTOBER 2021	REVIEWED BY:	E D Har	ris
NC 27529	PREPARED BY:	R M Muncey	REVIEWED BY:	L Ove	rn
		REVISIONS		INIT.	DATE
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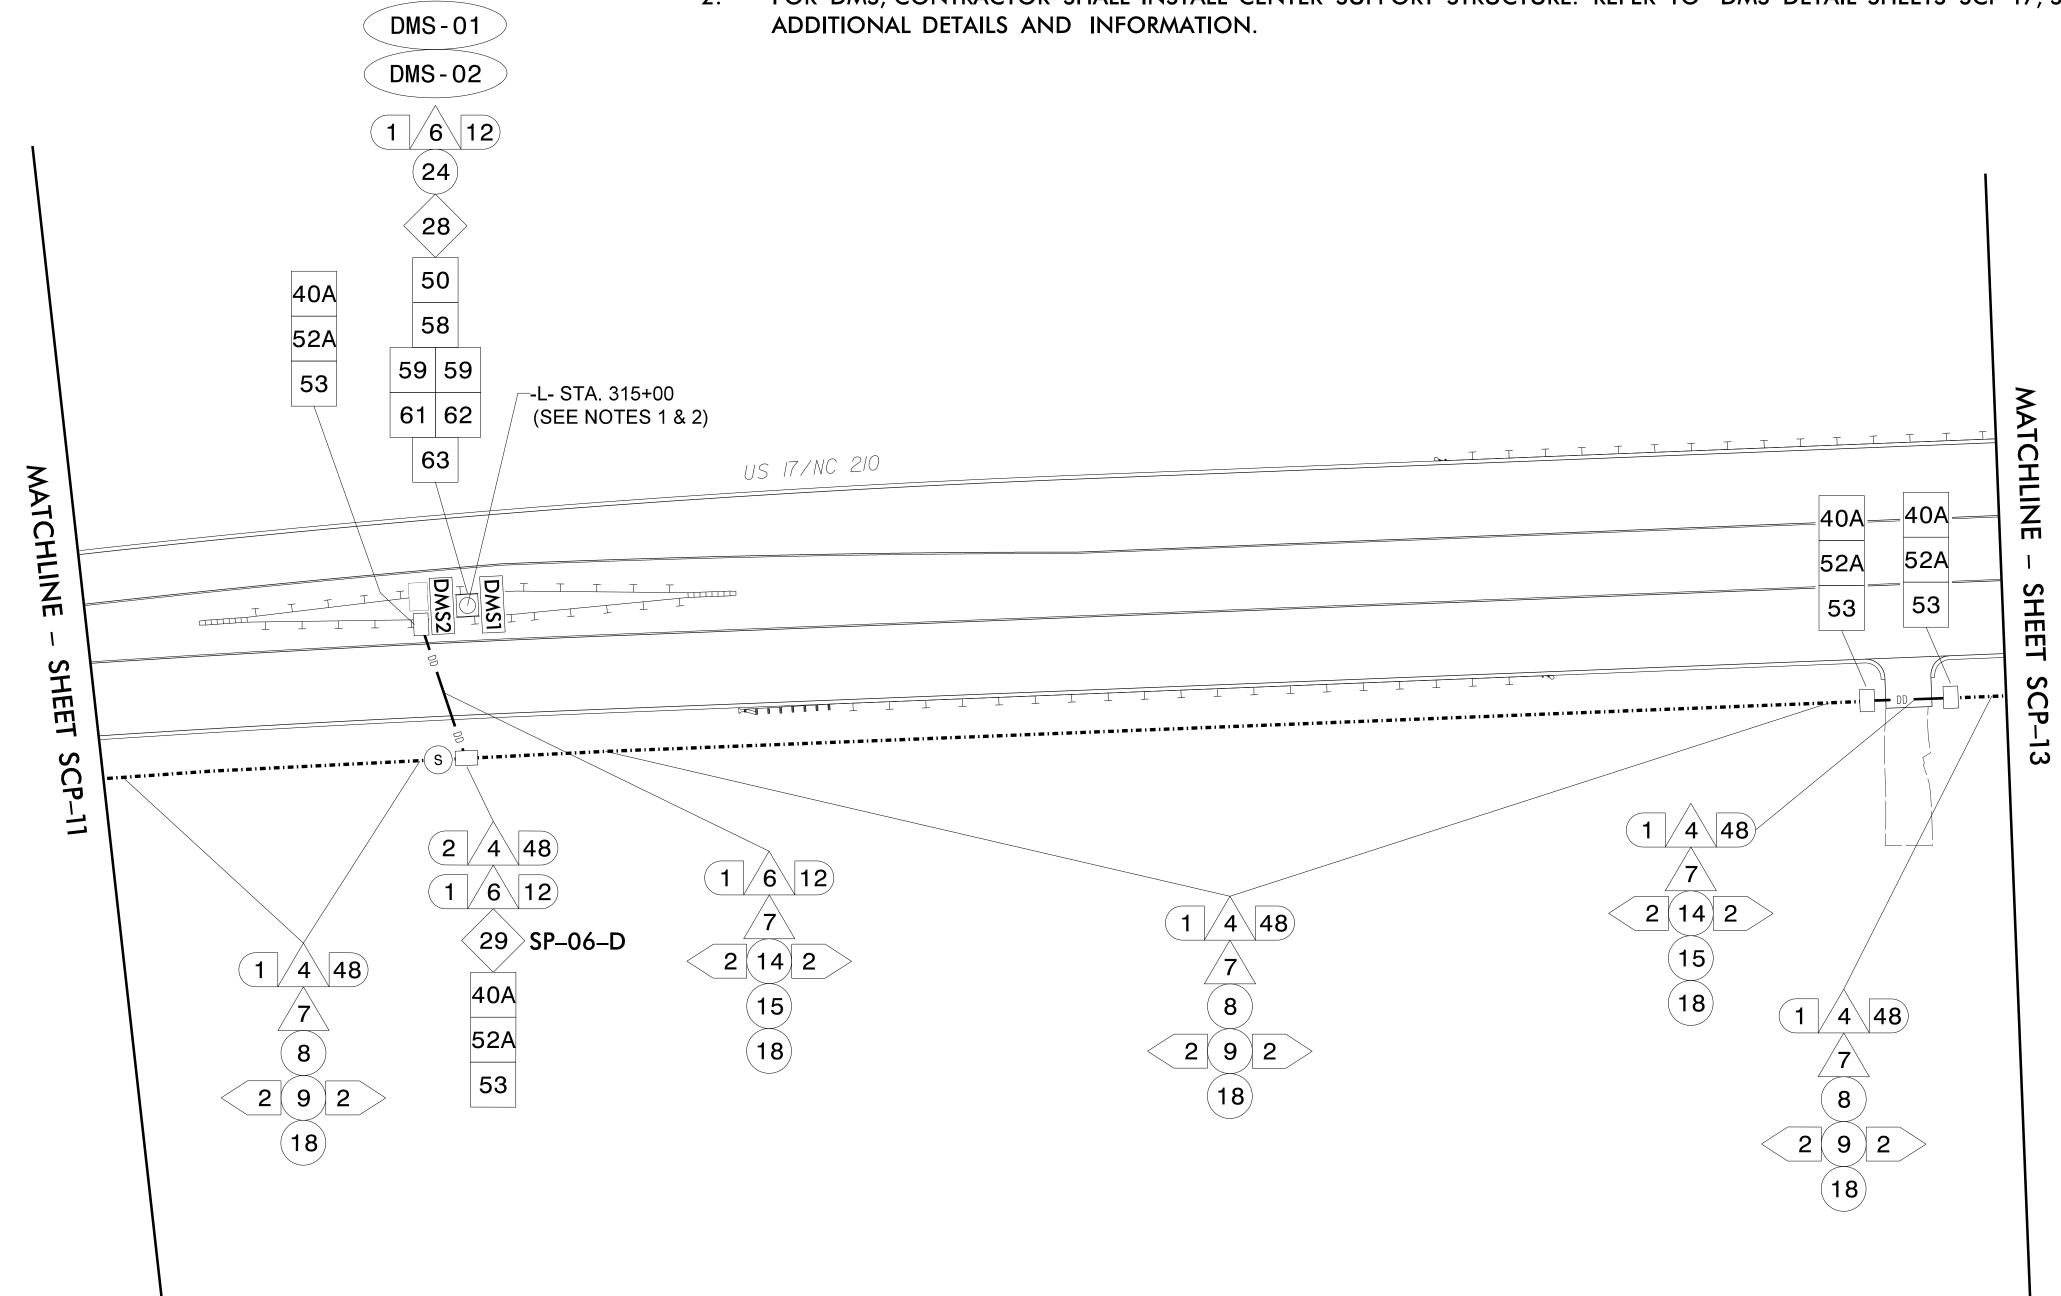
Regina M. Muncey 10/5/2021

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PROJECT REFERENCE NO. SHEET NO. SCP-12

NOTE:

- . CELL MODEM FOR DMS CABINET WILL BE PROVIDED TO CONTRACTOR BY NCDOT. CONTRACTOR MUST CONTACT NCDOT DIVISION 3 TRAFFIC ENGINEER AT 910–341–2200 EIGHT (8) WEEKS PRIOR TO INSTALLATION TO ALLOW LEAD TIME FOR ACQUIRING DEVICES.
- 2. FOR DMS, CONTRACTOR SHALL INSTALL CENTER SUPPORT STRUCTURE. REFER TO DMS DETAIL SHEETS SCP-17, SCP-18, AND SCP-21 FOR





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US 17/NC 210 Cable Routing Plans

Division 3 Pender County Near Topsail Beach
PLAN DATE: OCTOBER 2021 REVIEWED BY: E D Harris
PREPARED BY: R M Muncey REVIEWED BY: L Overn

SCALE
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Docusigned by:

Raina M. Muncuy 10/5/2021


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R-3300B SCP-13

NOTE:

FIVE (5) DAYS PRIOR TO BEGINNING WORK ON THE SIGNAL SYSTEM, CONTACT THE NCDOT DIVISION 3 TRAFFIC ENGINEER AT 910–341–2200 TO ARRANGE FOR NCDOT TO PROGRAM THE NEW FIELD ETHERNET SWITCHES WITH THE NECESSARY NETWORK CONFIGURATION DATA, INCLUDING BUT NOT LIMITED TO: THE PROJECT IP ADDRESS, DEFAULT GATEWAY, SUBNET MASK, AND VLAN ID INFORMATION. NOTIFY THE DIVISION 3 TRAFFIC ENGINEER AFTER ALL WORK IS PERFORMED TO ENSURE THAT ALL FIBER



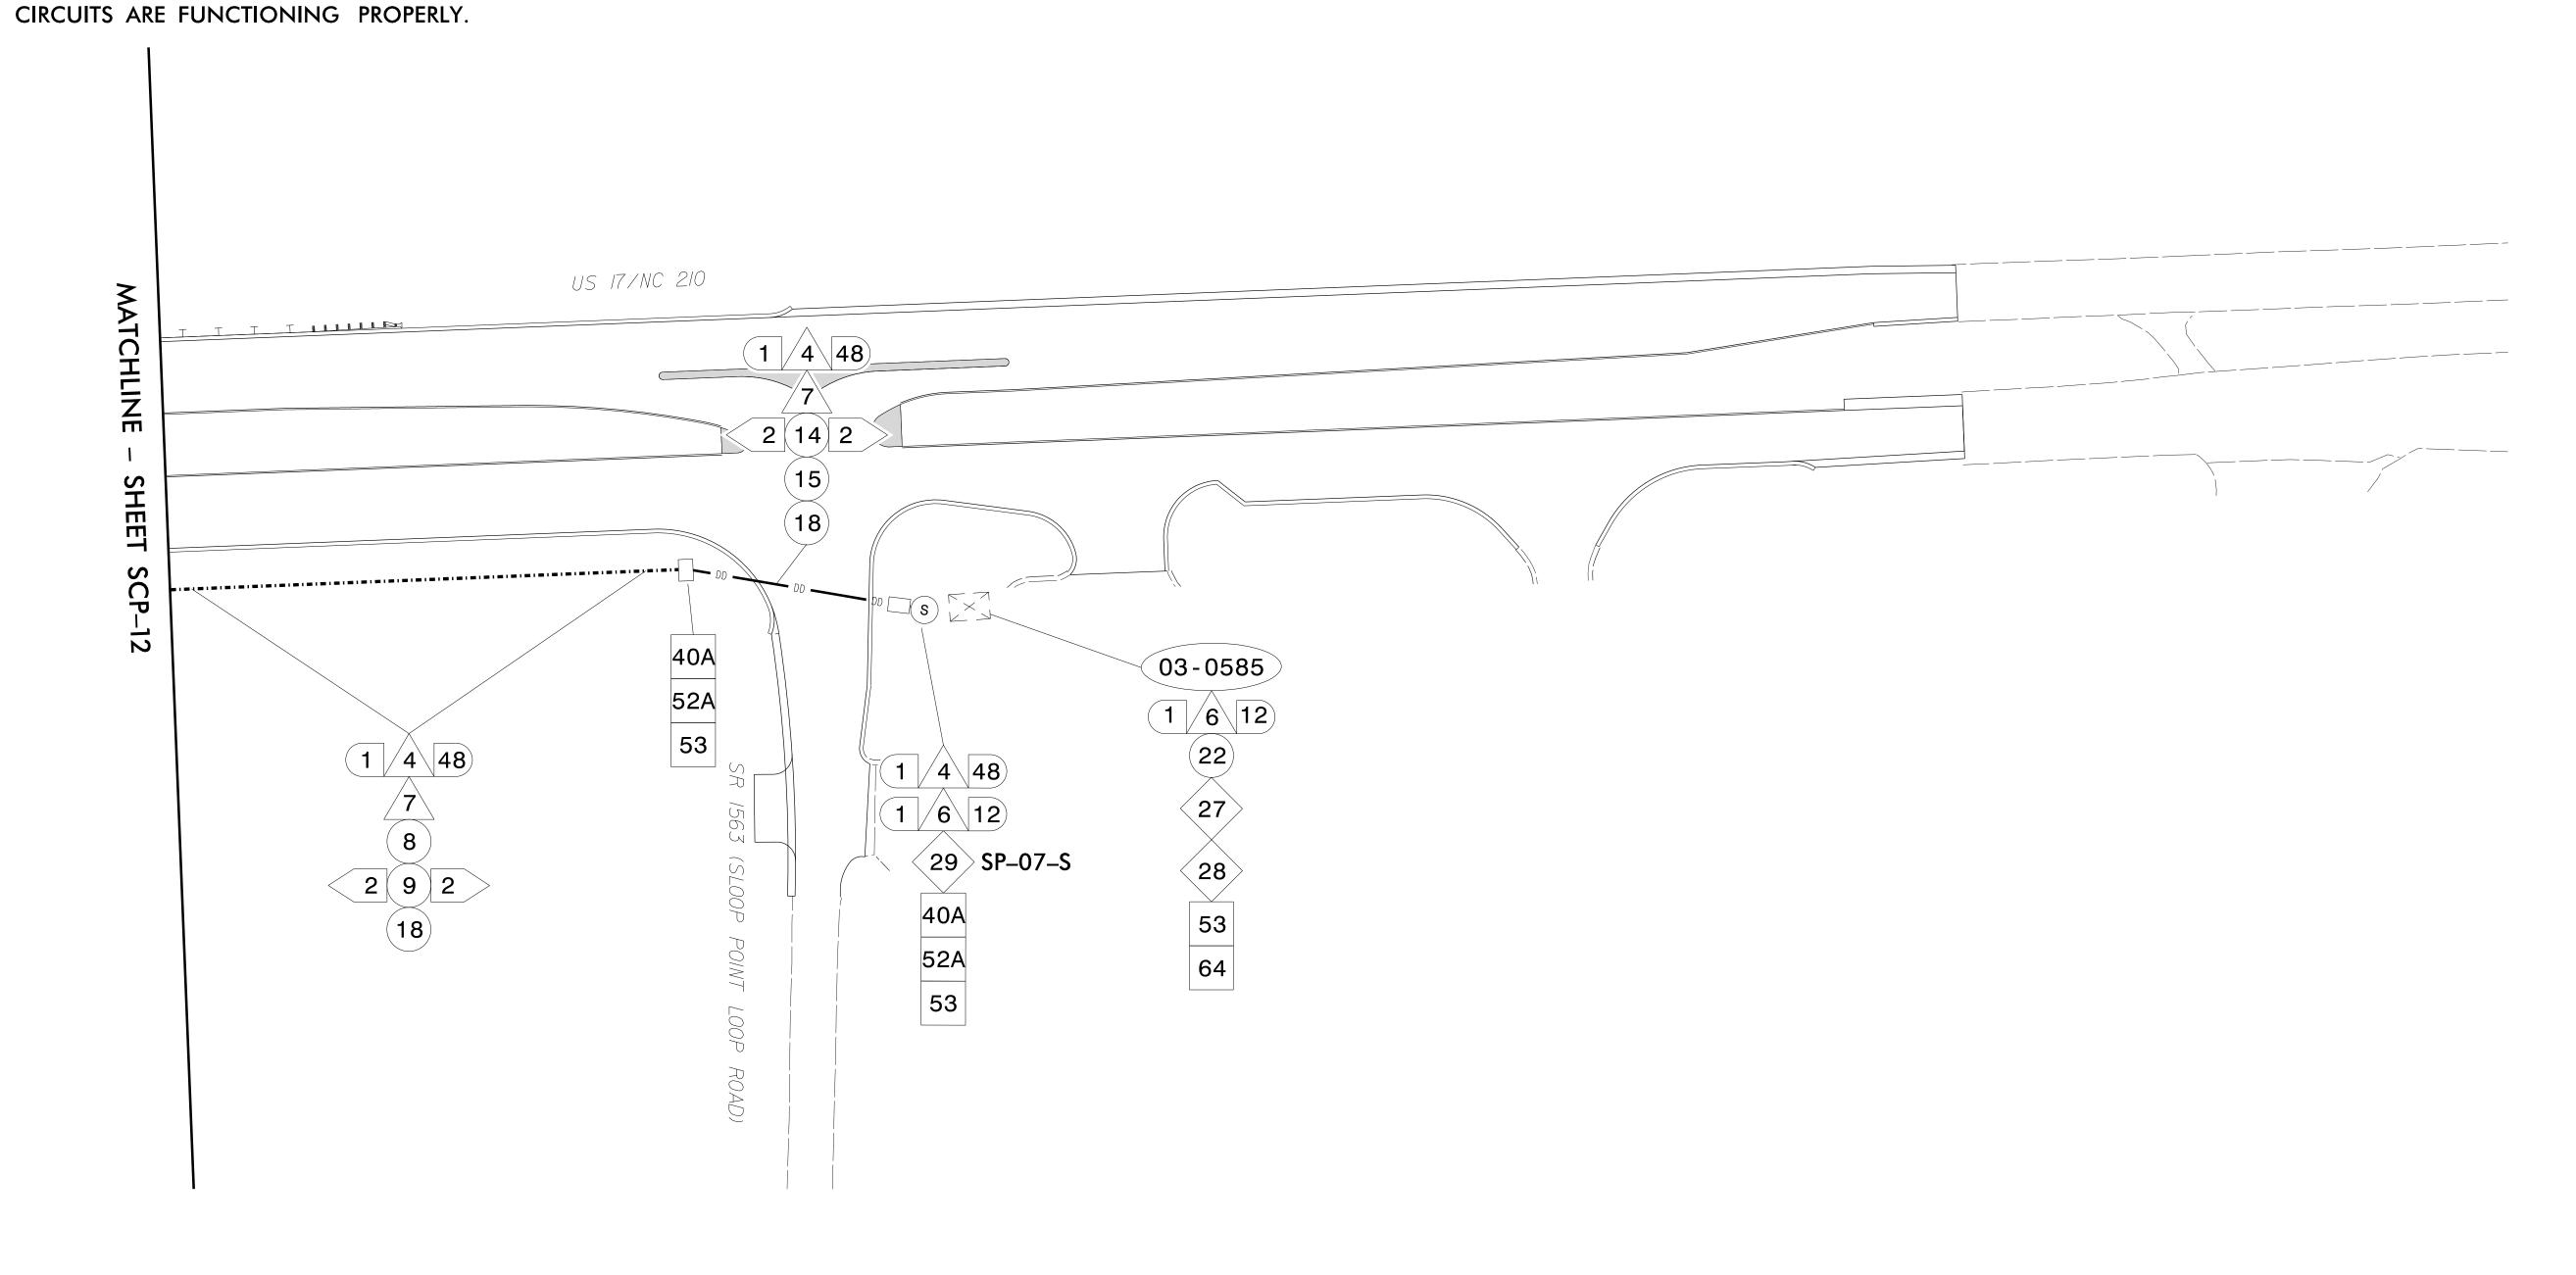

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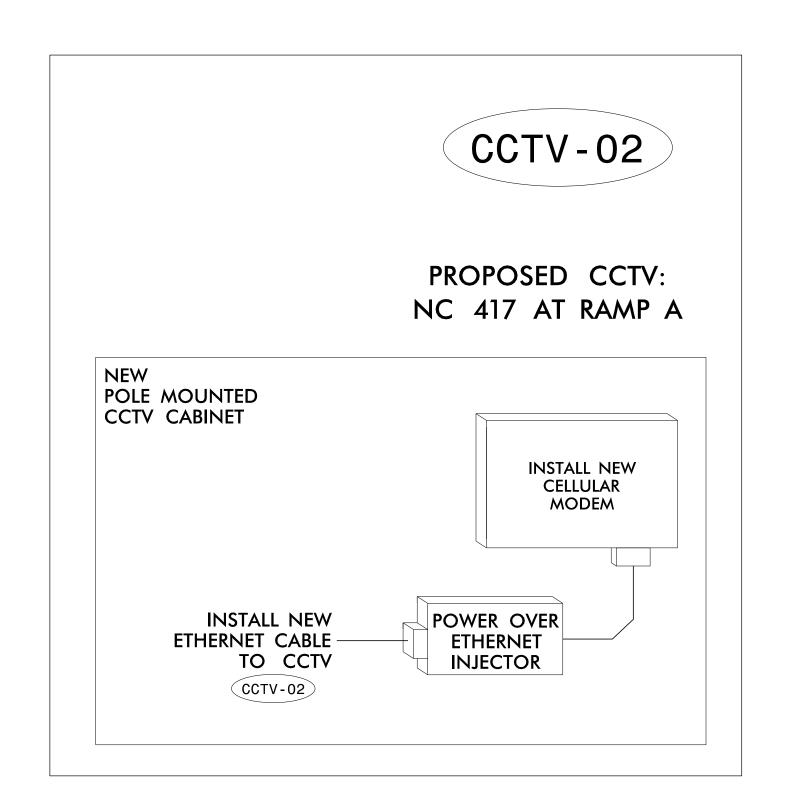
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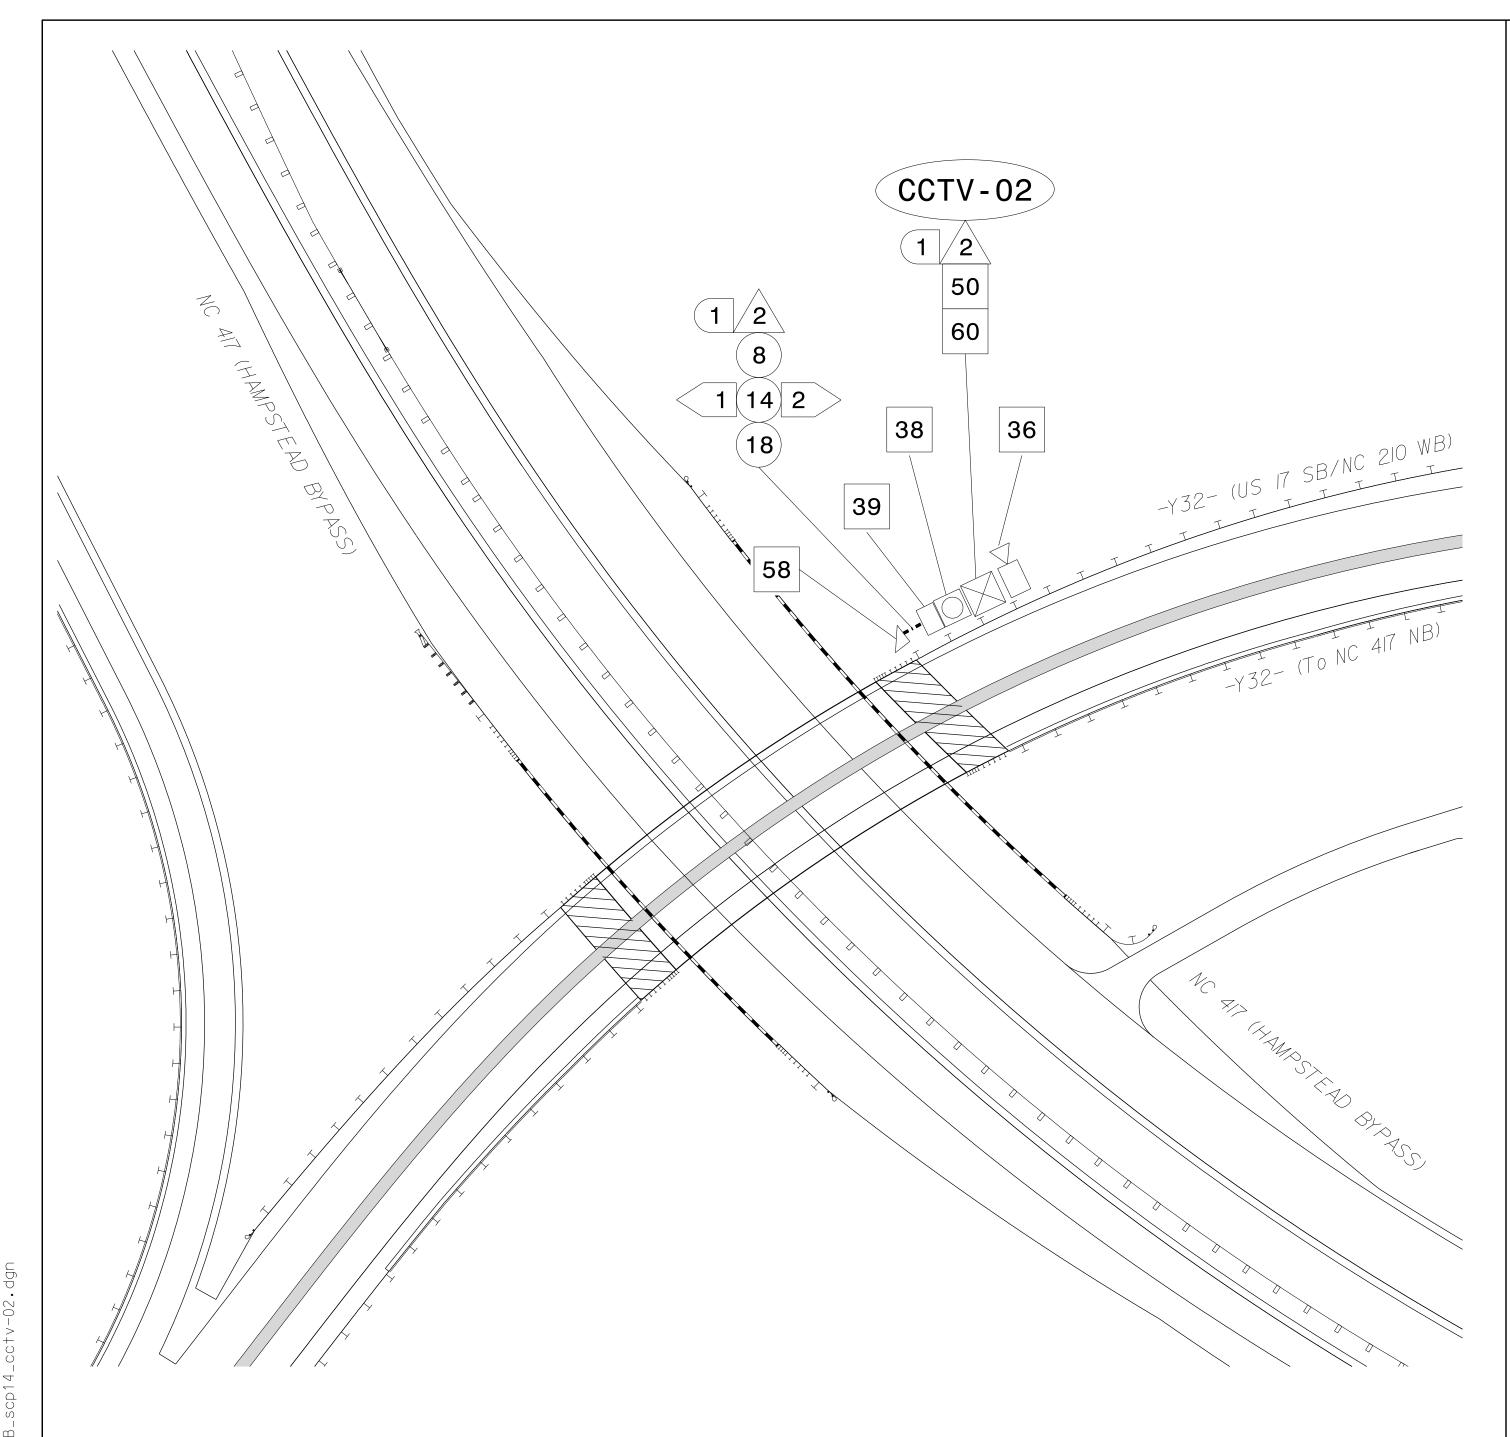


US 17/NC 210 Cable Routing Plans

We constitute of the second	Division 3	Pender	County Near	· Topsai:	l Beach	
gement	PLAN DATE:	OCTOBER 2021	REVIEWED BY:	E D Hai	rris	ĺ
Garner,NC 27529	PREPARED BY:	R M Muncey	REVIEWED BY:	L Ove	rn	_
SCALE		REVISIONS		INIT.	DATE	
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PROJECT REFERENCE NO. R-3300B SCP-14





NOTES:

1. CELL MODEM FOR CCTV CABINET WILL BE PROVIDED TO CONTRACTOR BY NCDOT. CONTRACTOR MUST CONTACT NCDOT DIVISION 3 TRAFFIC ENGINEER AT 910–341–2200 EIGHT (8) WEEKS PRIOR TO INSTALLATION TO ALLOW LEAD TIME FOR ACQUIRING DEVICES.



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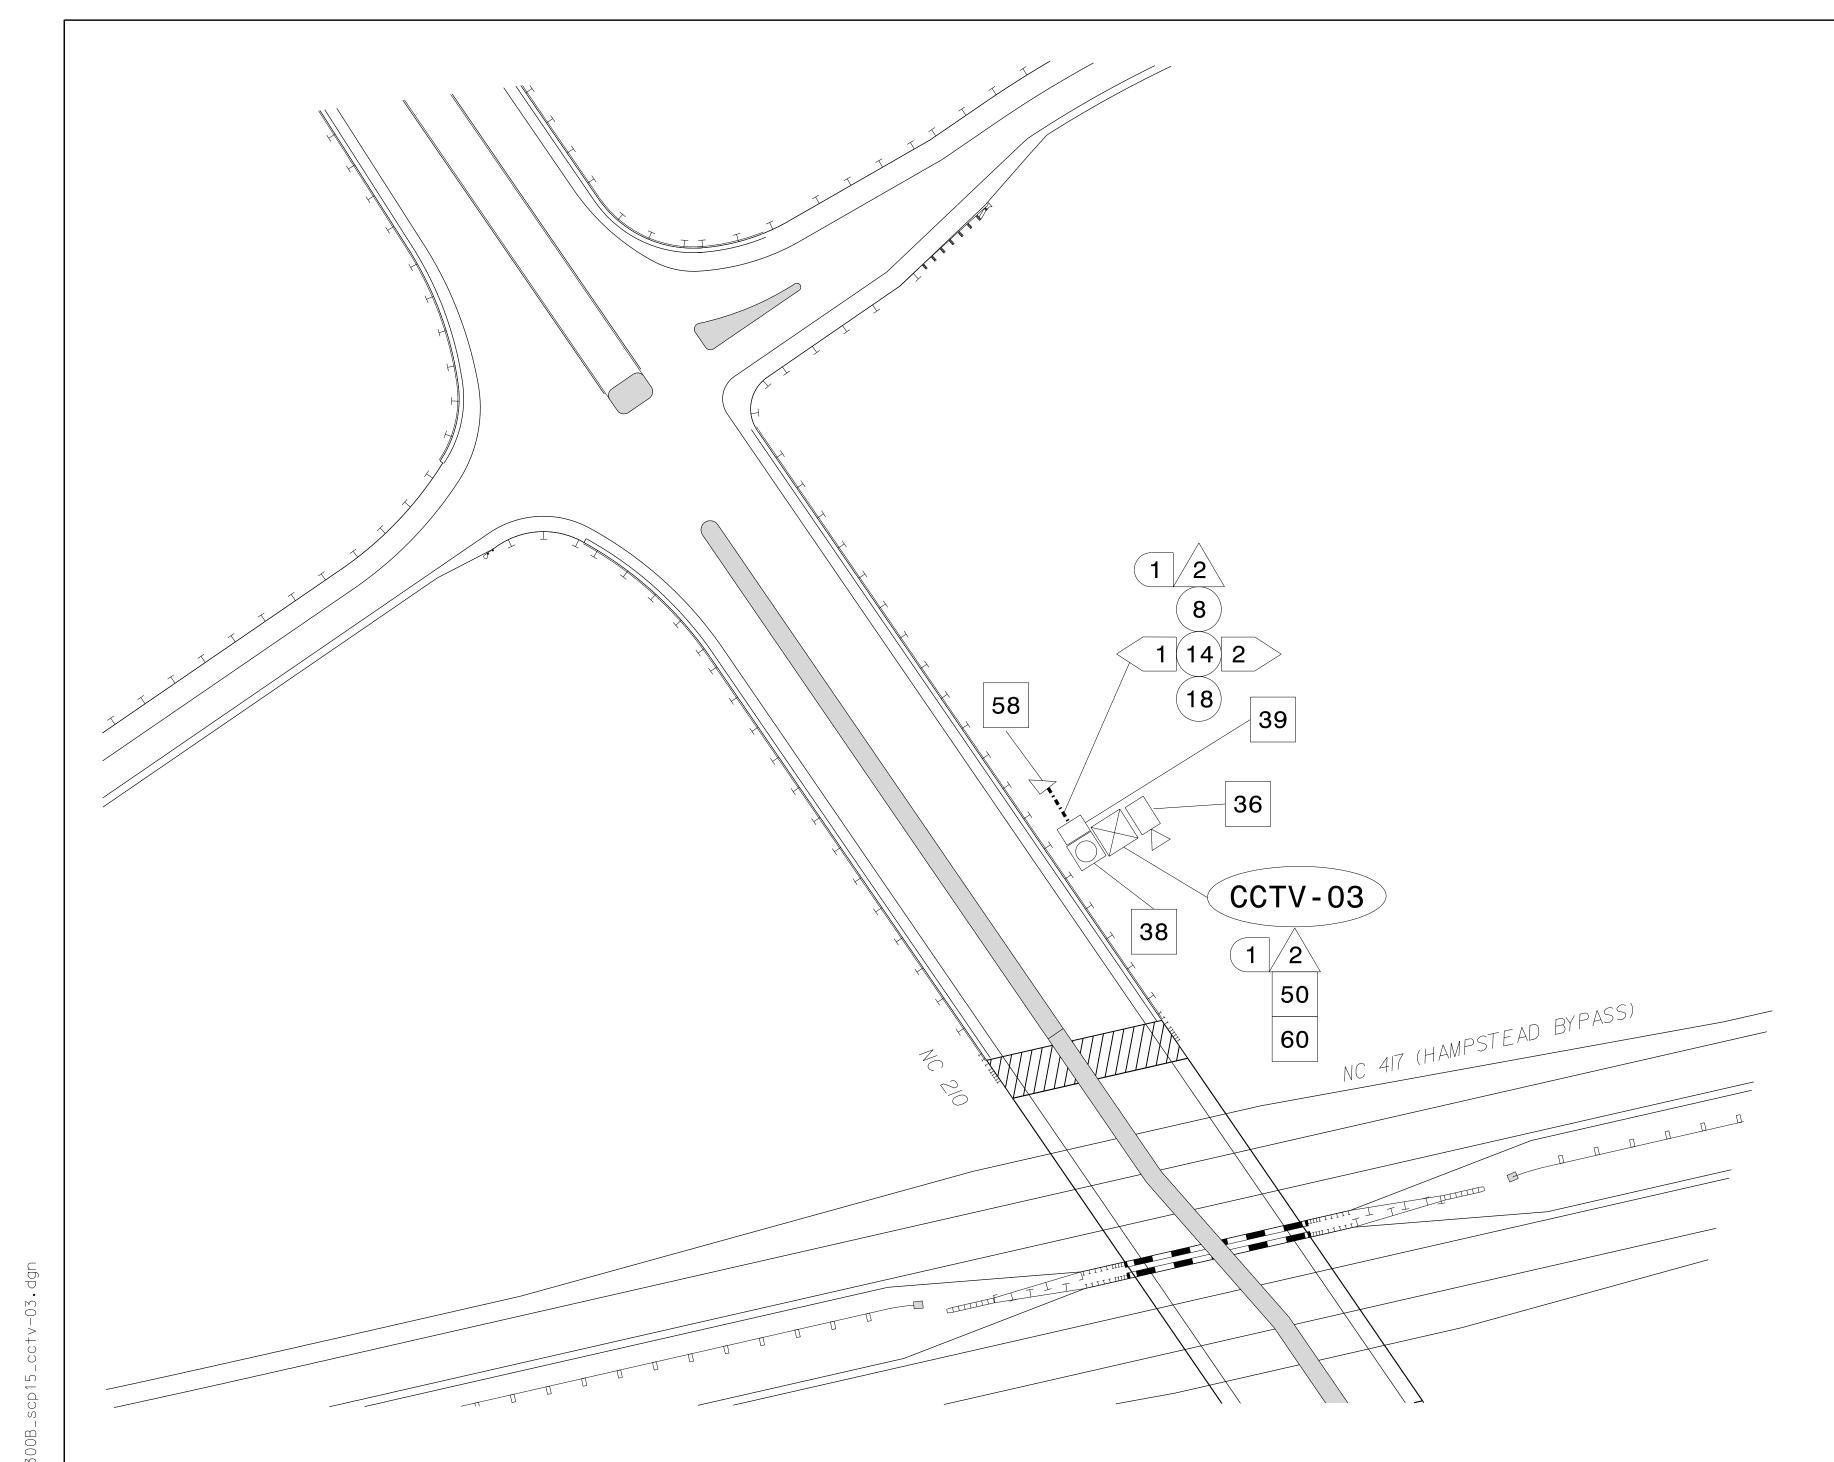



US 17/NC 210 Cable Routing Plans

Division 3 Pender County Near Topsail Beach
PLAN DATE: OCTOBER 2021 REVIEWED BY: E D Harris REVIEWED BY: L Overn 750 N.Greenfield Pkwy,Garner,NC 27529 | PREPARED BY: R M Muncey REVISIONS

Regina M. Muncey 10/5/2021

PROJECT REFERENCE NO. R-3300B SCP-15



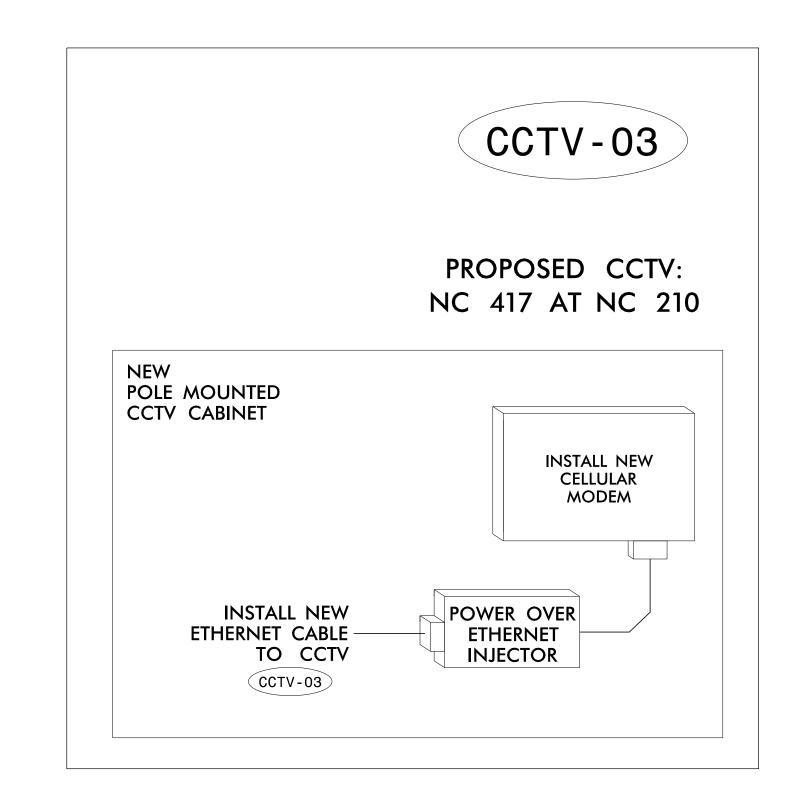

NOTES:

1. CELL MODEM FOR CCTV CABINET WILL BE PROVIDED TO CONTRACTOR BY NCDOT. CONTRACTOR MUST CONTACT NCDOT DIVISION 3 TRAFFIC ENGINEER AT 910–341–2200 EIGHT (8) WEEKS PRIOR TO INSTALLATION TO ALLOW LEAD TIME FOR ACQUIRING DEVICES.



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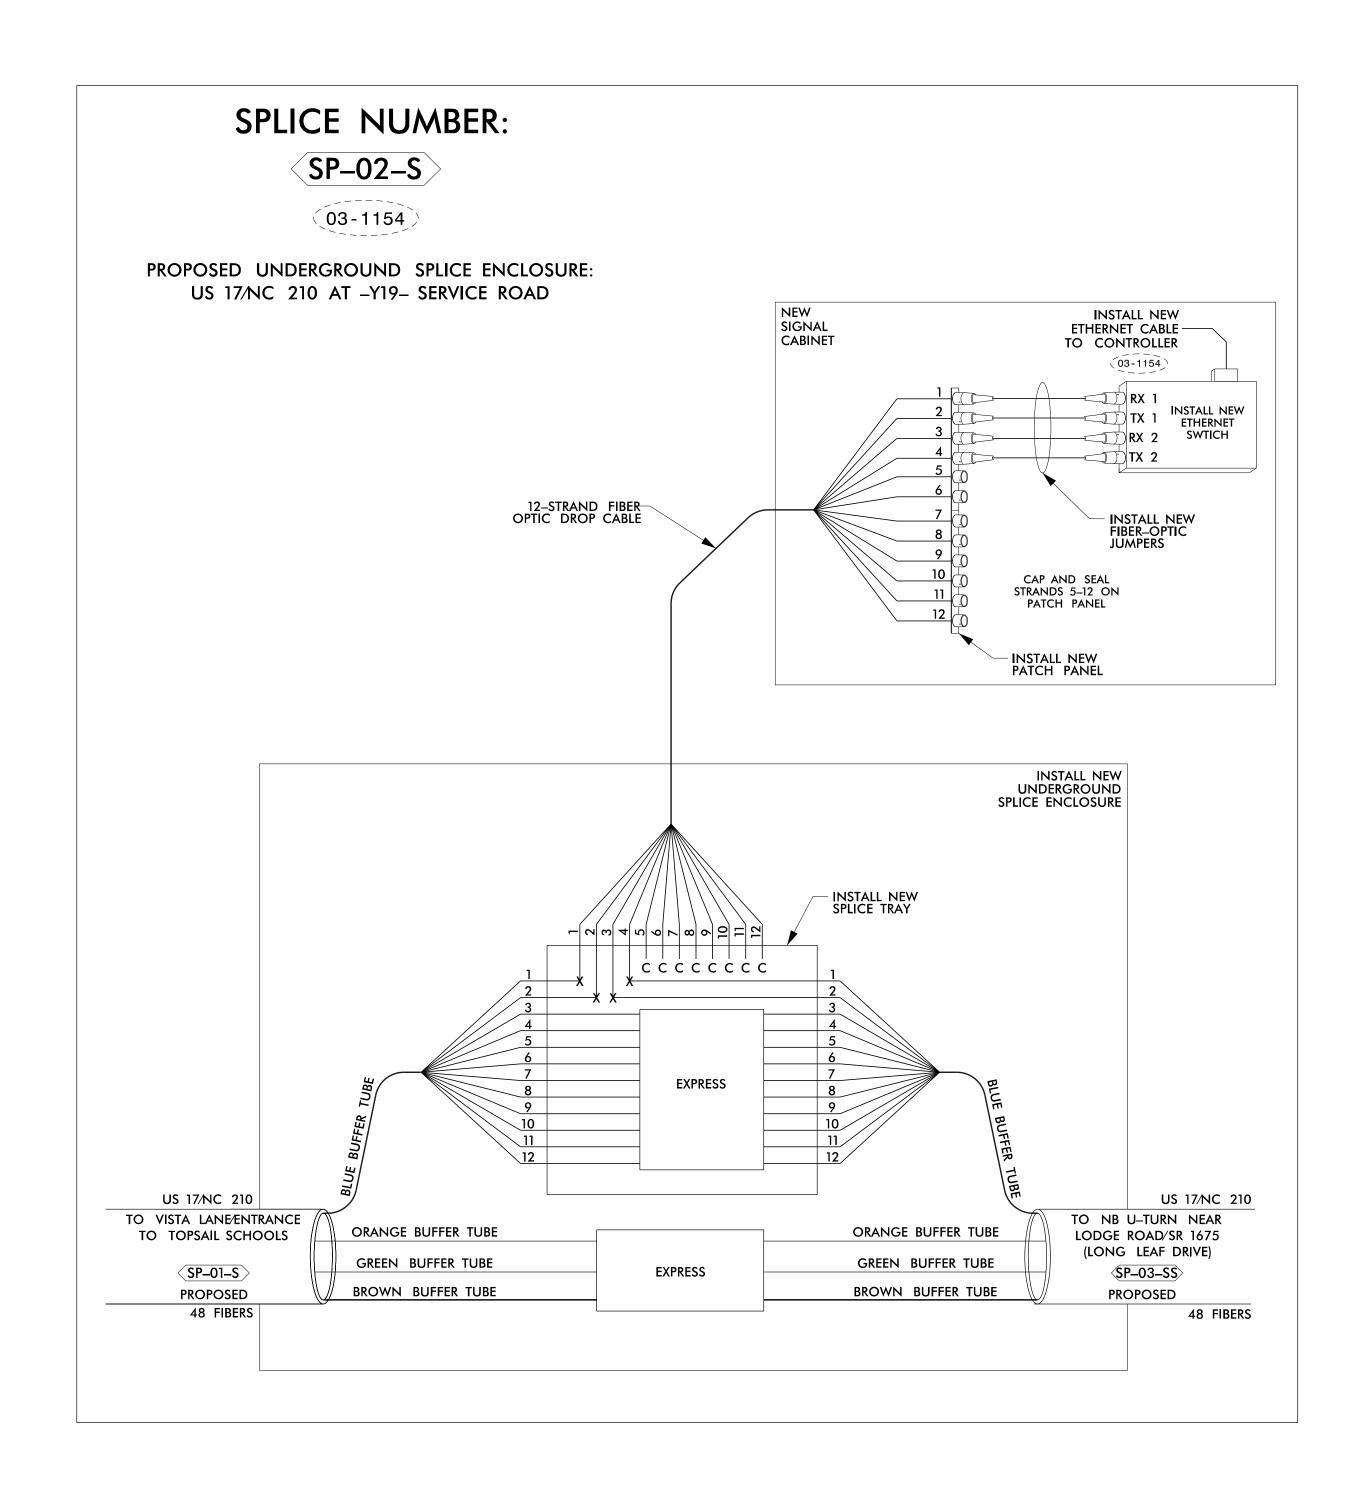


US 17/NC 210 Cable Routing Plans

Division 3 Pender County Near Topsail Beach
PLAN DATE: OCTOBER 2021 REVIEWED BY: E D Harris REVIEWED BY: L Overn 750 N.Greenfield Pkwy,Garner,NC 27529 PREPARED BY: R M Muncey REVISIONS

FINAL UNLESS ALL SIGNATURES COMPLETED Regina M. Muncey 10/5/2021

DOCUMENT NOT CONSIDERED



NOTE:

CELL MODEM FOR MASTER SIGNAL SYSTEM CABINET WILL BE PROVIDED TO CONTRACTOR BY NCDOT. CONTRACTOR MUST CONTACT NCDOT DIVISION 3 TRAFFIC ENGINEER AT 910–341–2200 EIGHT (8) WEEKS PRIOR TO INSTALLATION TO ALLOW LEAD TIME FOR ACQUIRING DEVICES.

		LEGEND			
	COLOR CODE TIA/EIA 5	78–B		NOTES:	[
	(1) BLUE (7) RED	E =	EXISTING FUSION SPLICE INDIVIDUAL	1. UNUSED FIBERS AND/OR BUFFER TUBES LEFT COILED AND STORED IN SPLICE TRAY.	\
	(2) ORANGE (8) BLAC	K	FIBER TO REMAIN	2. ETHERNET SWITCH TERMINATION CONFIGURATIONS ARE GENERIC. CONTRACTOR IS RESPONSIBLE FOR DETERMINING/ENSURING THE PROPER TERMINATIONS.	1 `
	(3) GREEN (9) YELL	OW X =	FUSION SPLICE INDIVIDUAL FIBER	3. FIVE (5) DAYS PRIOR TO BEGINNING WORK ON THE SIGNAL SYSTEM, CONTACT THE NCDOT DIVISION 3 TRAFFIC ENGINEER AT 910-341-2200 TO ARRANGE FOR NCDOT TO	<u> </u>
	(4) BROWN (10) VIO (5) SLATE (11) ROS		CAP AND SEAL	3. FIVE (5) DAYS PRIOR TO BEGINNING WORK ON THE SIGNAL SYSTEM, CONTACT THE NCDOT DIVISION 3 TRAFFIC ENGINEER AT 910–341–2200 TO ARRANGE FOR NCDOT TO PROGRAM THE NEW FIELD ETHERNET SWITCHES WITH THE NECESSARY NETWORK CONFIGURATION DATA, INCLUDING BUT NOT LIMITED TO: THE PROJECT IP ADDRESS, DEFAULT GATEWAY, SUBNET MASK AND VLAN ID INFORMATION. NOTIFY THE NCDOT DIVISION 3 TRAFFIC ENGINEER AFTER ALL WORK IS PERFORMED TO ENSURE THAT ALL FIBER CIRCUITS ARE FUNCTIONING PROPERLY. WORK IS NOT COMPLETE UNTIL THE SIGNAL SYSTEM IS UP AND OPERATIONAL.	
	(6) WHITE (12) AQ	JA EXPRESS =	EXPRESS ENTIRE BUFFER TUBE/FIBERS	4. INCLUDE ON THE COVER OF SPLICE TRAY THE FOLLOWING INFORMTION (REFERENCE STANDARD SPECIFICATIONS SECTION 1731):	
			THROUGH WITHOUT CUTTING	A. SPLICE LOCATION	
5	13-XXXX = PROPOSED	BUFFER SPLICE =	SPLICE ALL FIBERS IN BUFFER TUBE	B. DATE C. COMPANY NAME	
	DEVICE		COLOR TO COLOR	D. NAME OF INDIVIDUAL PERFORMING THE SPLICE	
5	(13-XXXX) = EXISTING DEVICE	=	SM FIBER PATCH CORD WITH CONNECTORS	PRIOR TO INSTALLING THE COVER ON THE SPLICE TRAY, TAKE A DIGITAL PHOTOGRAPH SHOWING THE SPLICE TRAY AND INFORMATION SHOWN ABOVE (ITEMS A–D) AND SUBMIT PHOTOGRAPH ALONG WITH OTDR TEST RESULTS.	



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750 N.Greenfield Pkwy, Garnet

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US 17/NC 210
Fiber Optic Splice Details

Division 3 Pender County Near Topsail Beach
PLAN DATE: OCTOBER 2021 REVIEWED BY: E D Harris
PREPARED BY: R M Muncey REVIEWED BY: L Overn
REVISIONS INIT. DATE

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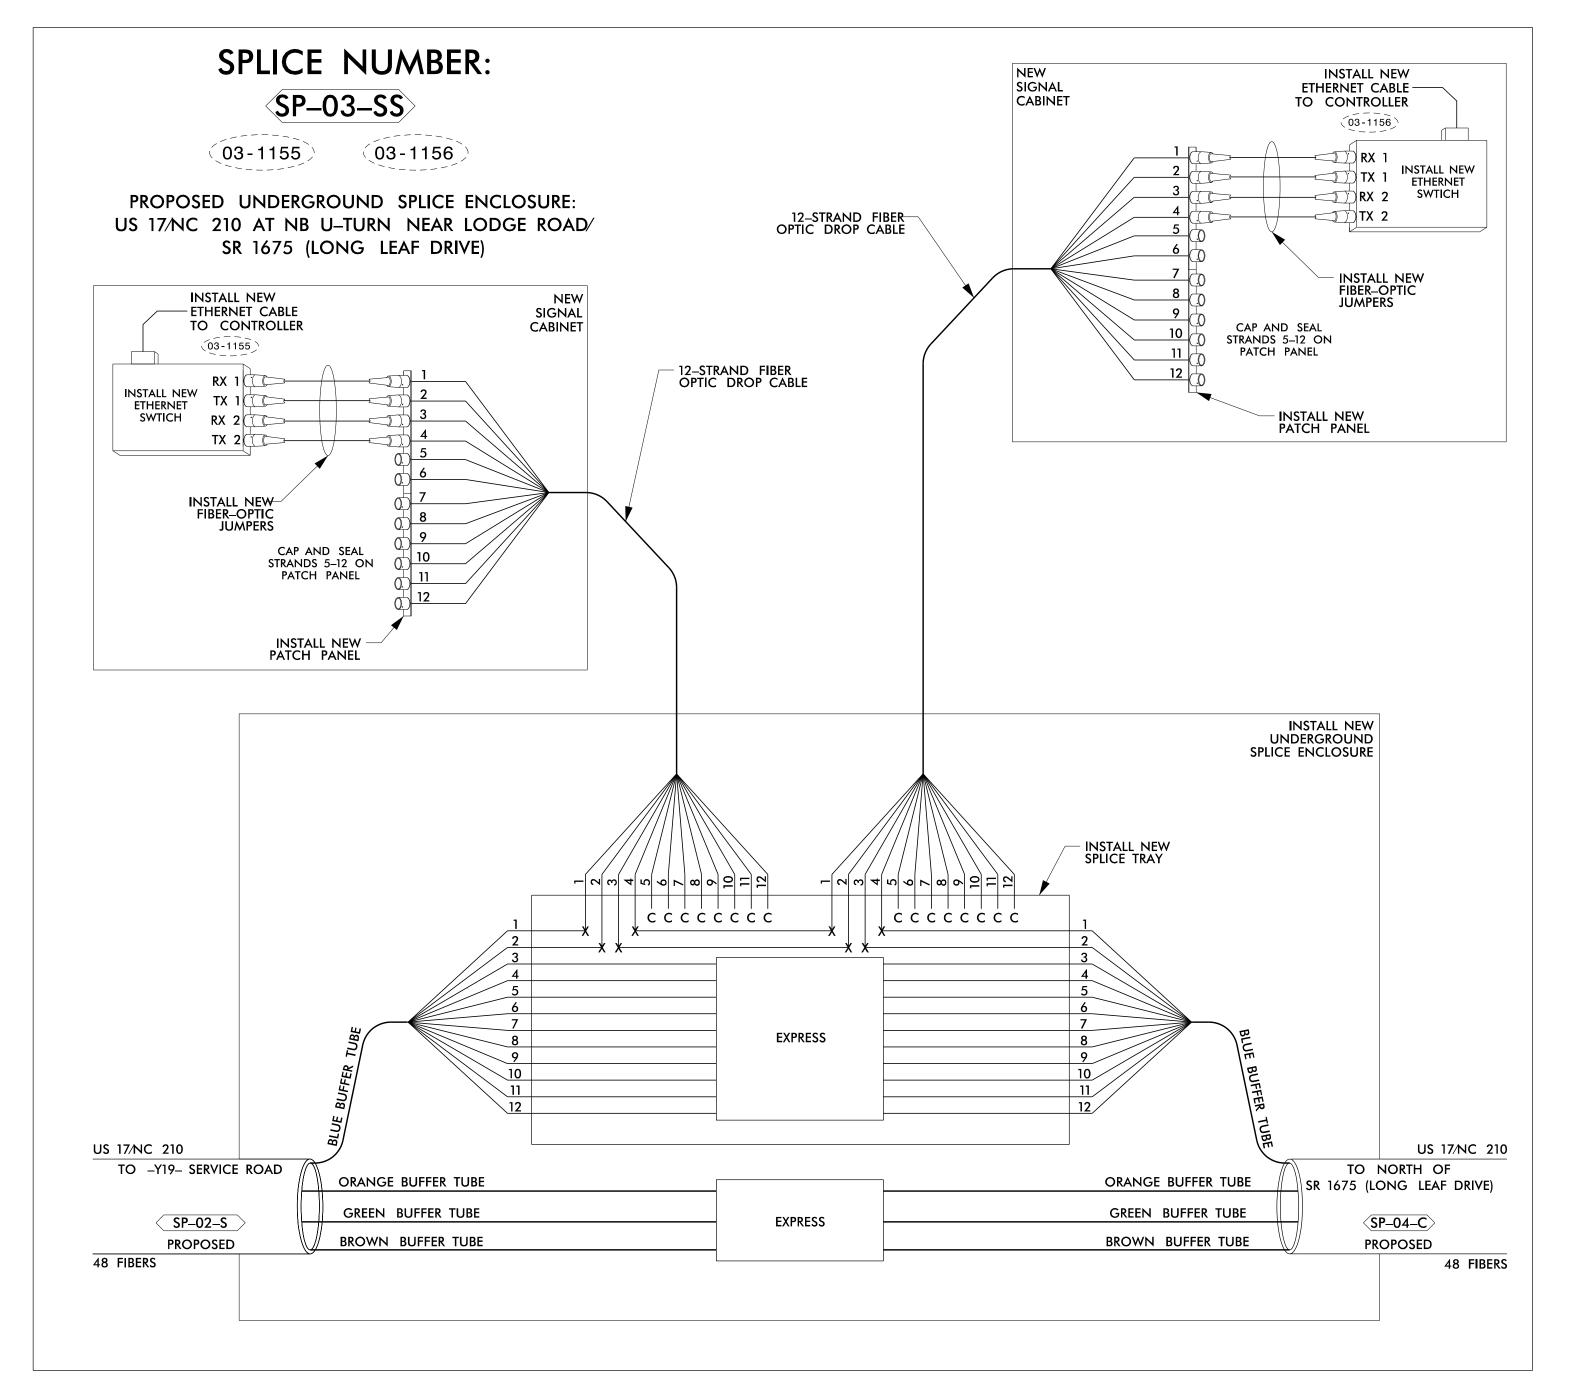
Regina M. Munuy10/5/2021


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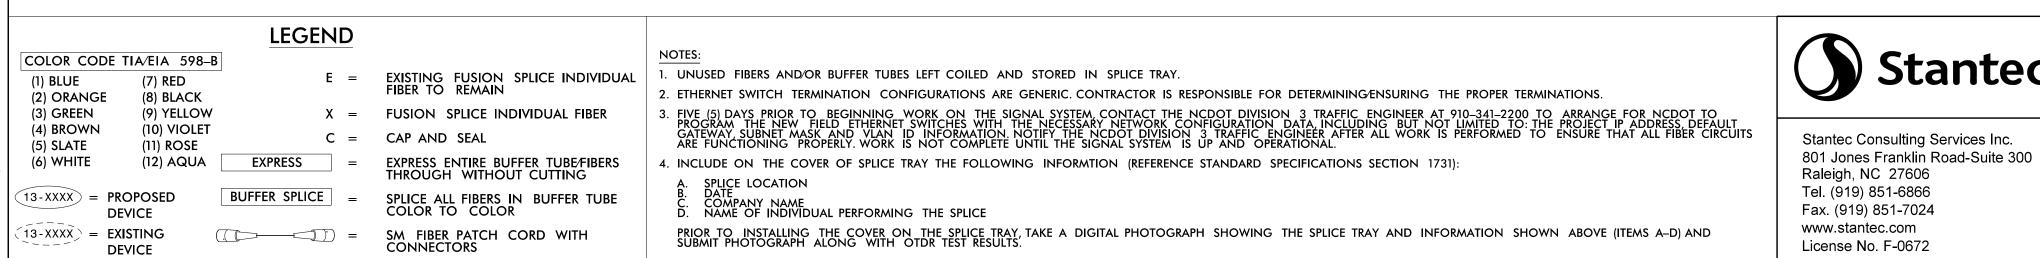
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US 17/NC 210 Fiber Optic Splice Details

Division 3 Pender County Near Topsail Beach
PLAN DATE: OCTOBER 2021 REVIEWED BY: E D Harris L Overn 750 N.Greenfield Pkwy,Garner,NC 27529 | PREPARED BY: R M Muncey REVIEWED BY:

Regina M. Muncey 10/5/2021


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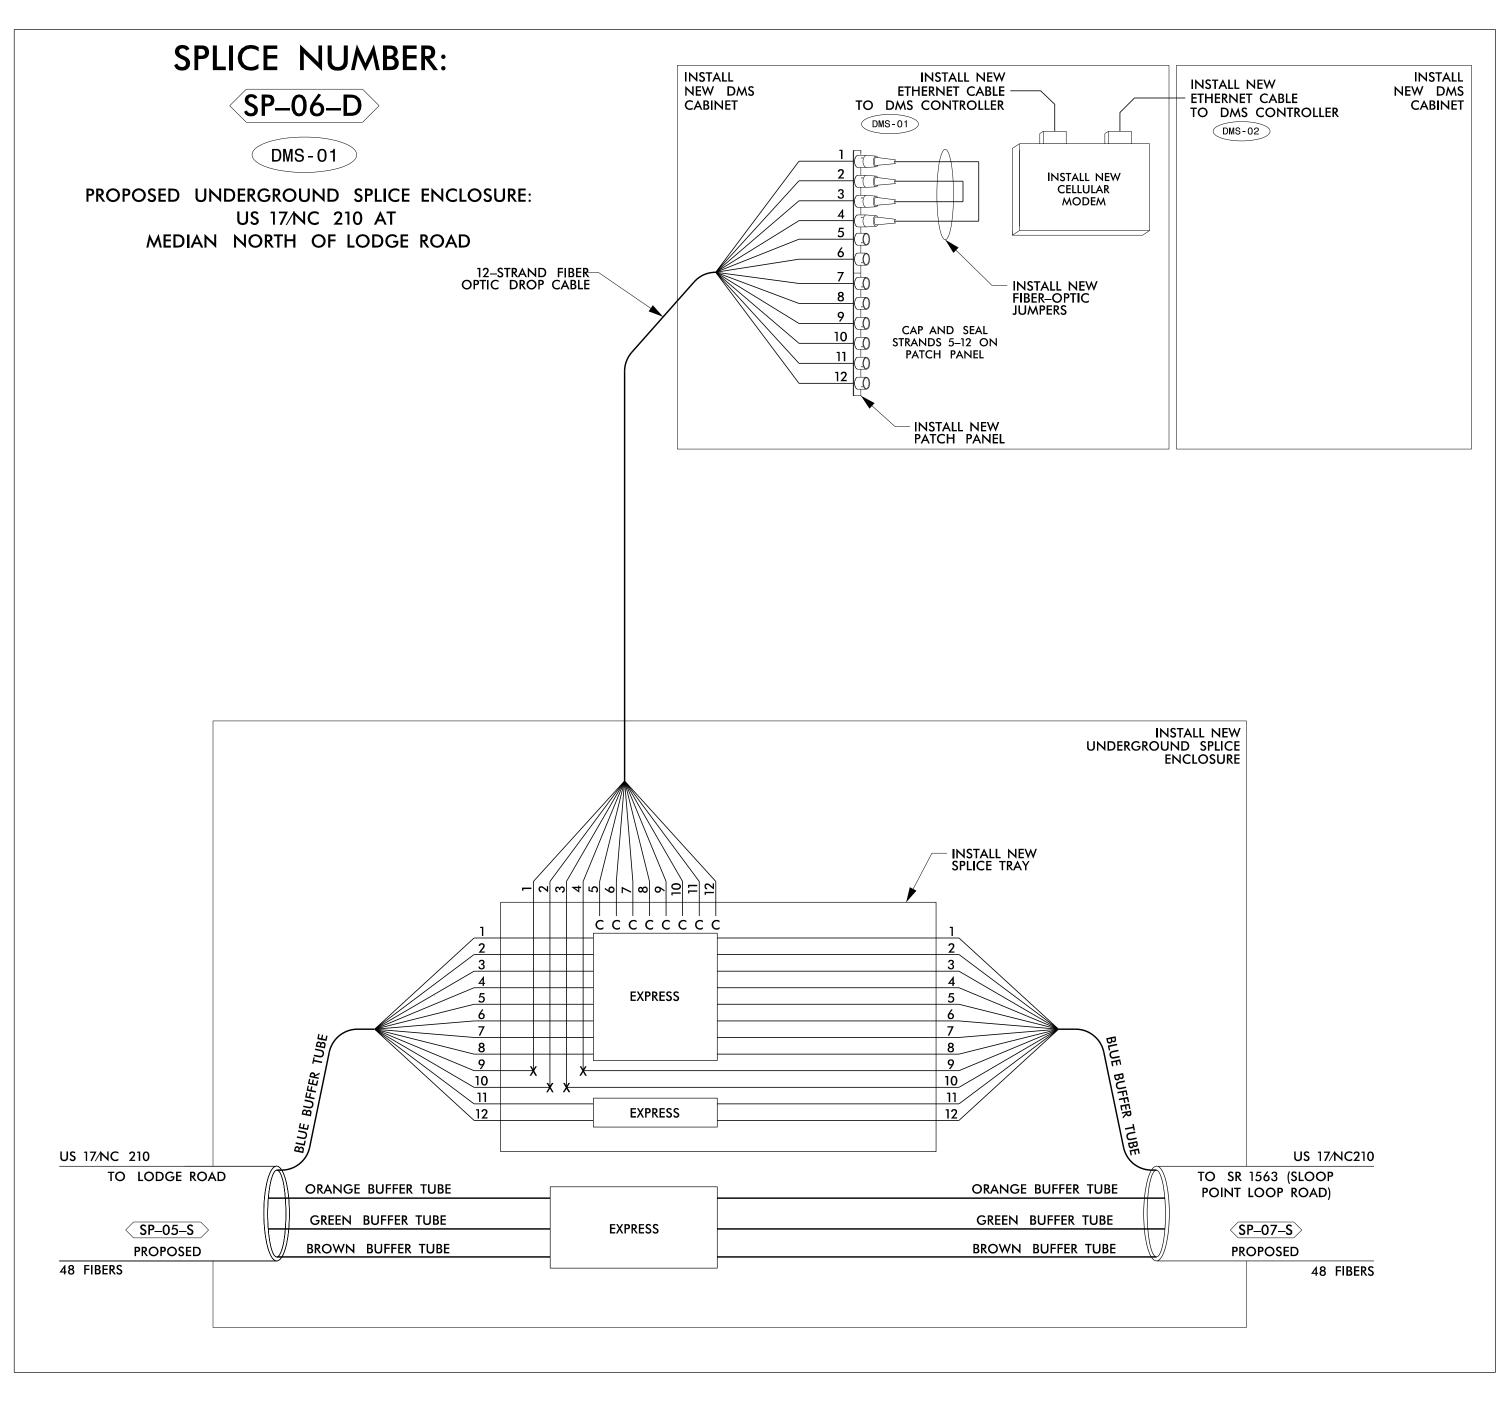
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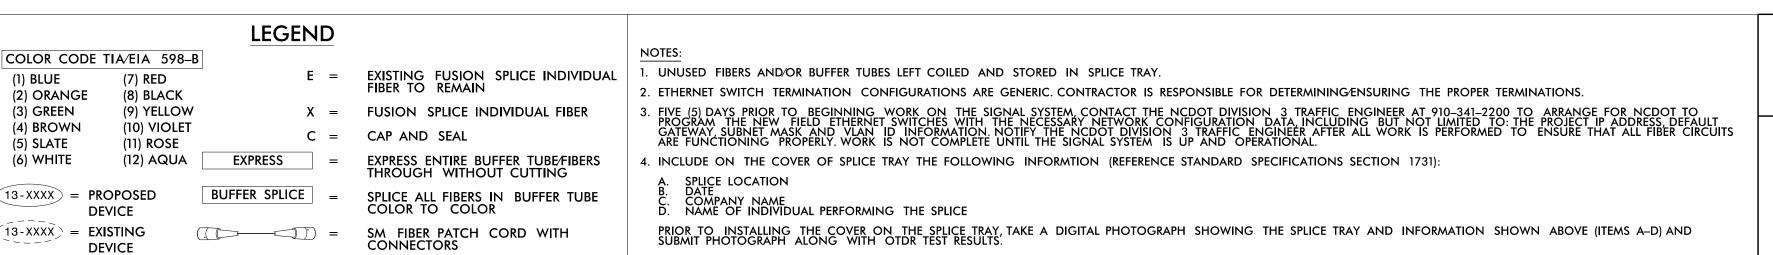
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PROJECT REFERENCE NO.

SHEET NO. R-3300B SCP-18

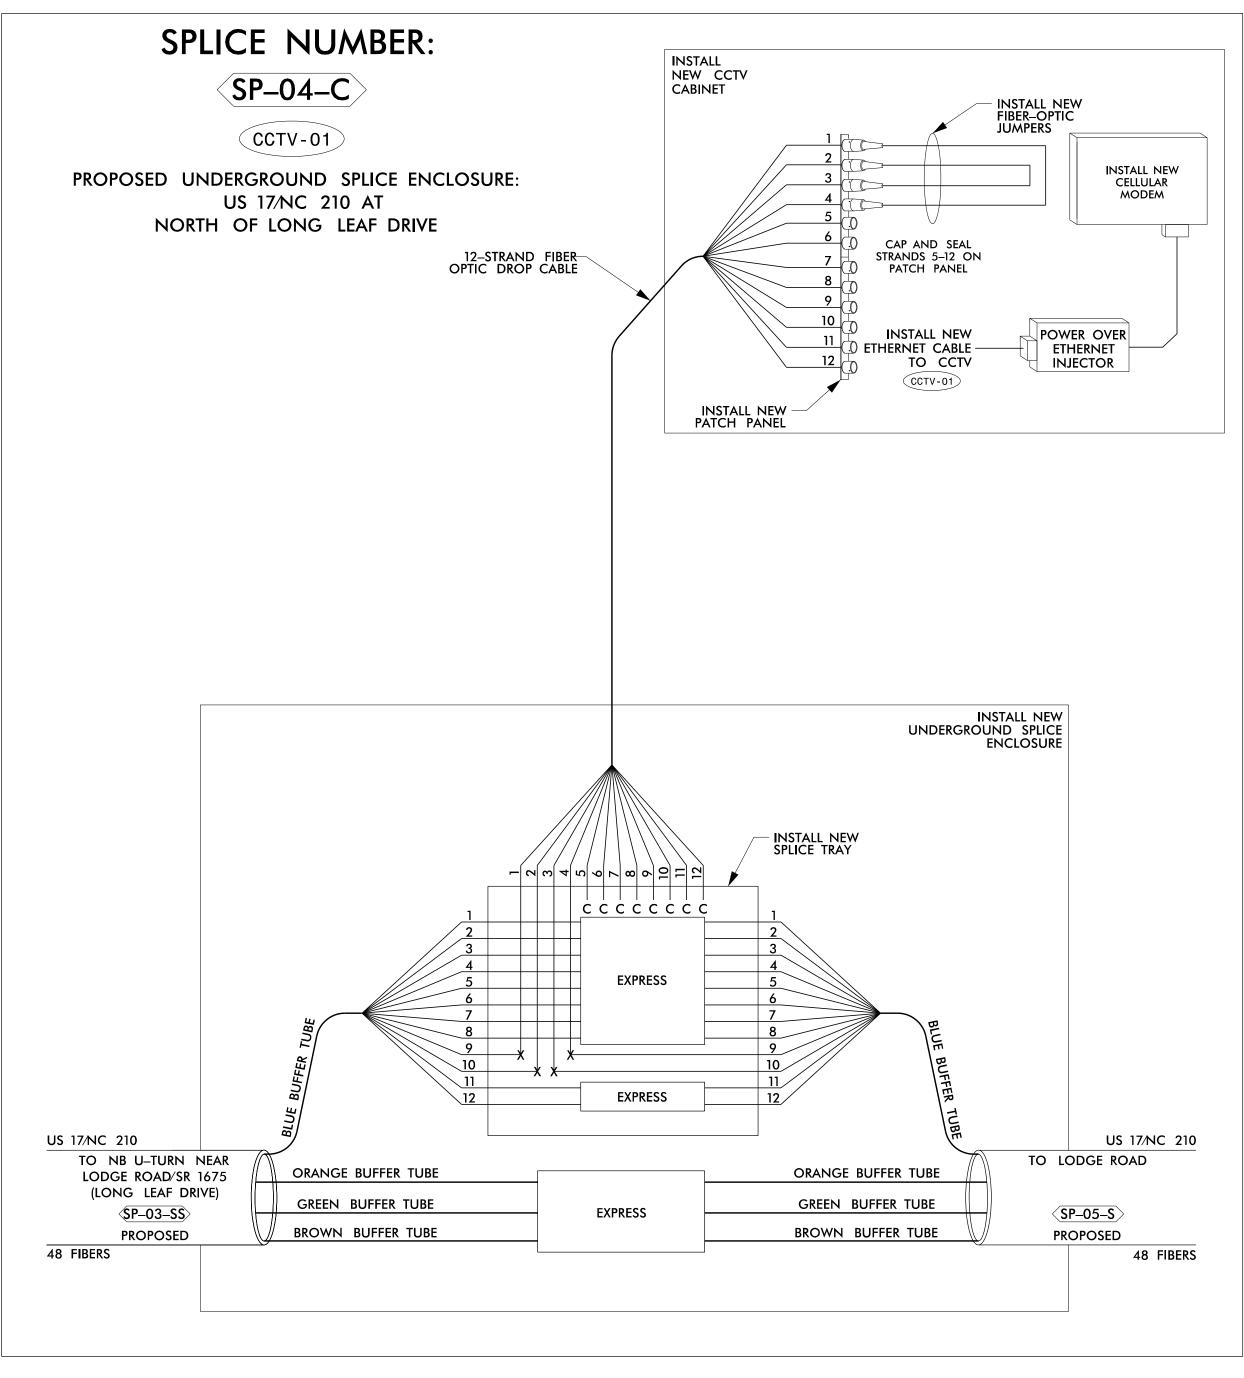





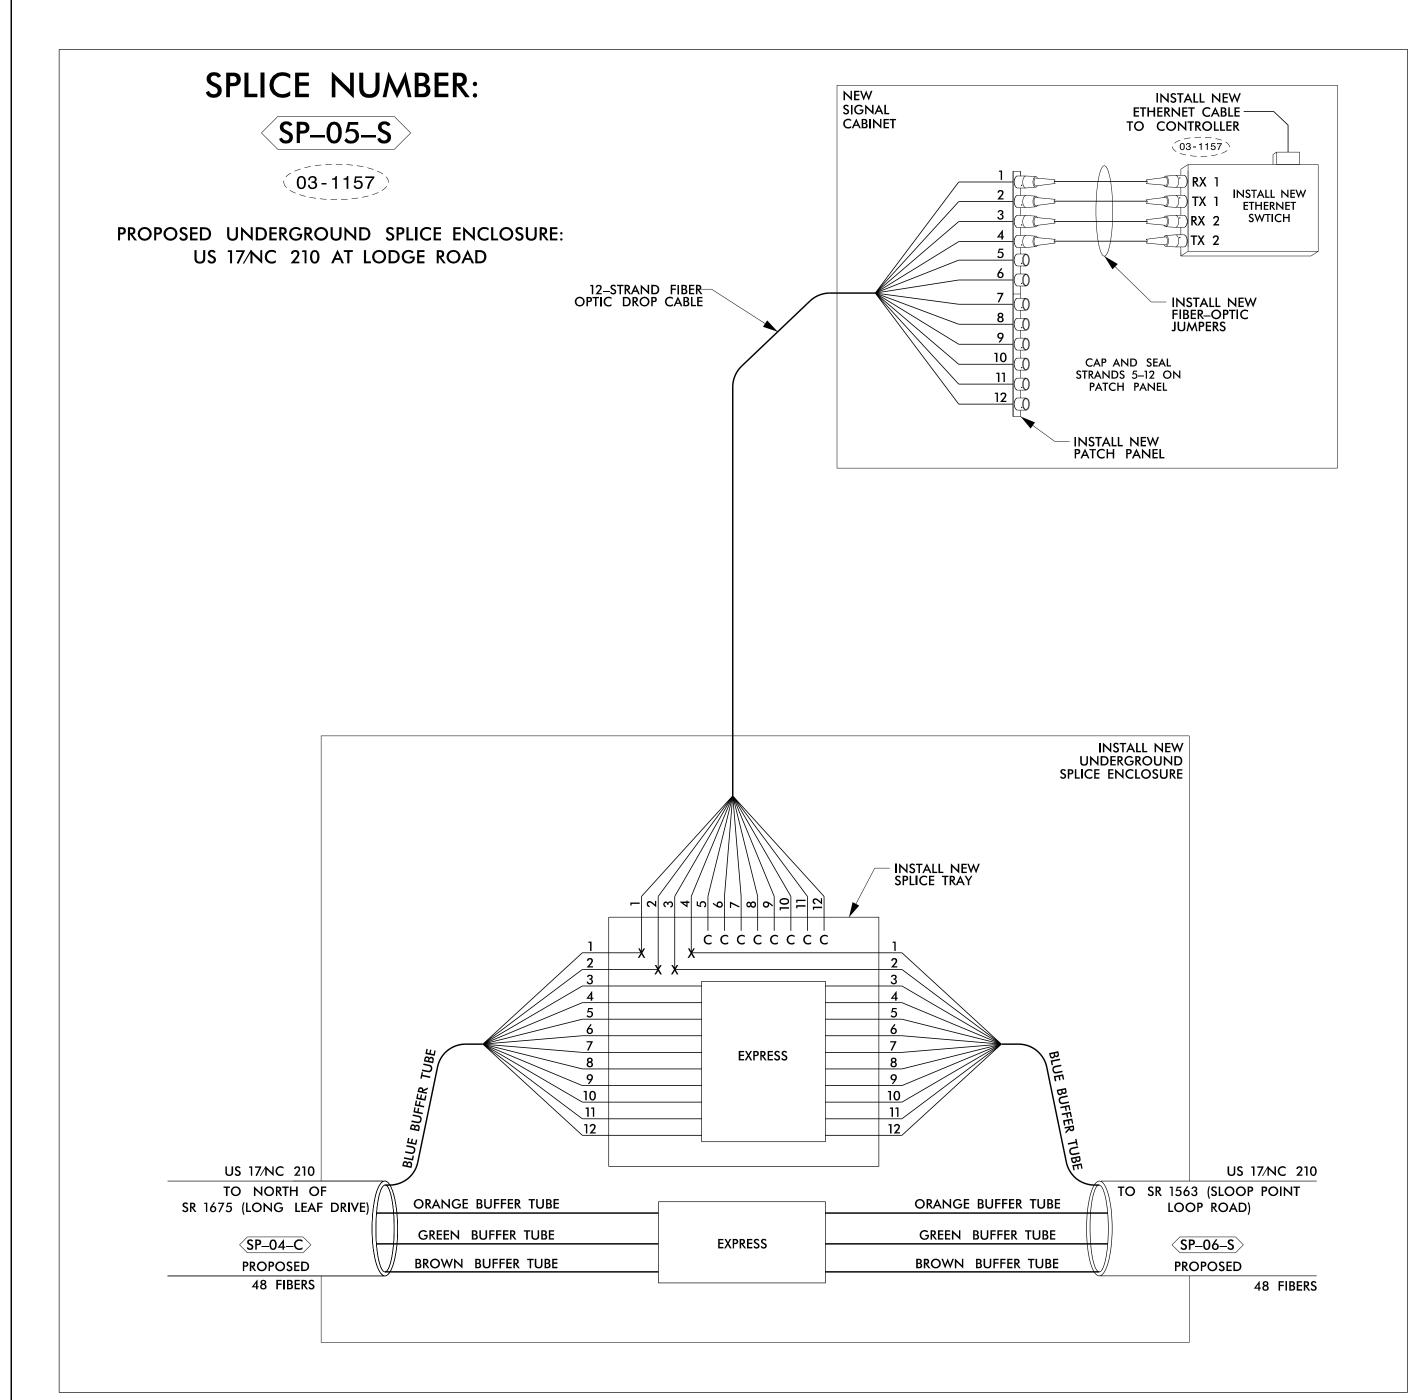

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US 17/NC 210 Fiber Optic Splice Details

Division 3 Pender County Near Topsail Beach
PLAN DATE: OCTOBER 2021 REVIEWED BY: E D Harris REVIEWED BY: L Overn 750 N.Greenfield Pkwy,Garner,NC 27529 | PREPARED BY: R M Muncey

SIGNATURES COMPLETED SEAL 43239

DOCUMENT NOT CONSIDERED FINAL UNLESS ALL

Regina M. Muncey 10/5/2021


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R-3300B SCP-19

DMS-01 and DMS-02

34° 24′41.40″N 77° 39′18.68″W



NOTES:

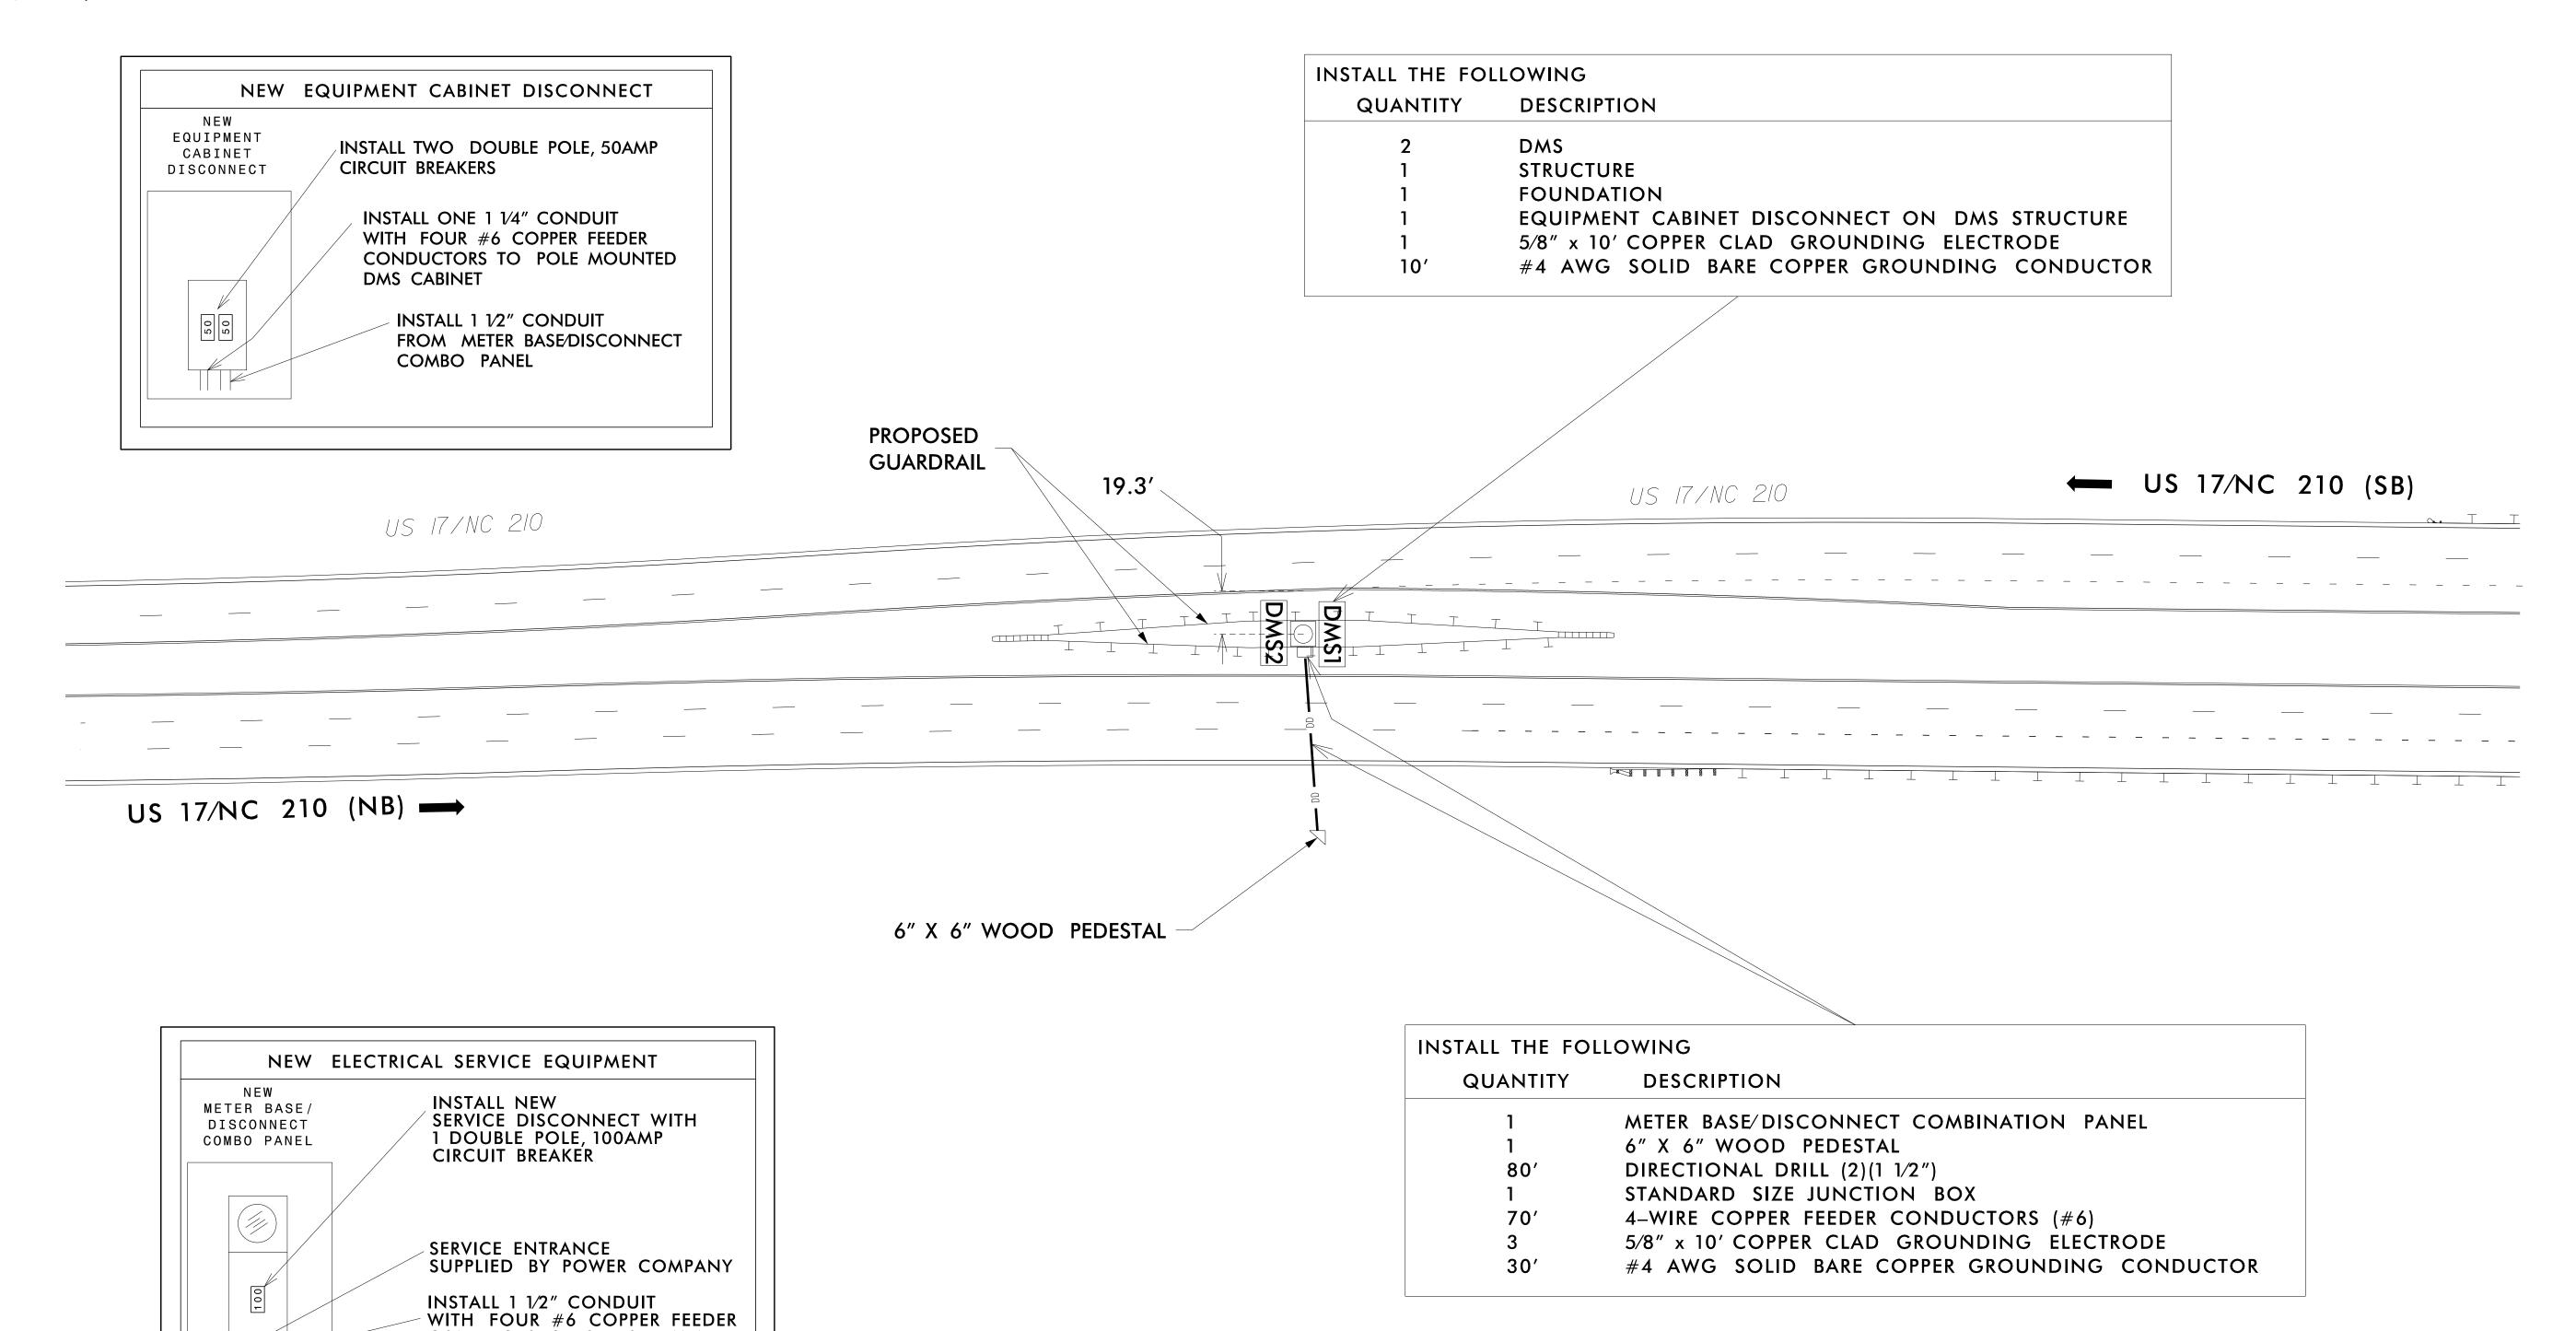1. INSTALL NEW DMS POLE MOUNTED CABINETS (2) ON NEW DMS STRUCTURE.

CONDUCTORS TO EQUIPMENT

CABINET DISCONNECT

2. INSTALL NEW GROUNDING SYSTEM AS SHOWN ON SHEET SCP-21 AND AS DESCRIBED IN THE PROJECT SPECIAL PROVISIONS.

NORTH OF LODGE ROAD

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DMS-01 and DMS-02 INSTALLATION (DUAL-MOUNTED on SINGLE

POLE PEDESTAL) Division 3 Pender County Near Topsail Beach
PLAN DATE: OCTOBER 2021 REVIEWED BY: E D Harris

REVIEWED BY: PREPARED BY: R M Muncey L Overn REVISIONS INIT. DATE N.T.S.

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DOCUMENT NOT CONSIDERED

PROJECT REFERENCE NO.


R-3300B SCP-20

ESTIMATED DIMENSION: 15' X 8' (EACH)

MAXIMUM DEADLOAD OF 1500 LBS (EACH)

NOTES:

- 1. USE THE ACTUAL DIMENSIONS AND WEIGHT OF THE DMS PROVIDED BY THE DMS FABRICATOR TO COMPLETE THE DESIGN OF THE DMS STRUCTURE.
- 2. FIELD VERIFY ALL FOOTING ELEVATIONS AND GROUND SLOPES AT THE FOOTINGS USING THE LATEST NCDOT STANDARD SPECIFICATIONS FOR ROADS AND STRUCTURES.
- 3. ENSURE THAT THE TOP OF THE FOOTING EXTENDS AT LEAST 6 INCHES AND NOT MORE THAN 24 INCHES ABOVE THE HIGHEST POINT OF THE GROUND SURFACE AT THE FOOTING.
- 4. DESIGN AND CONSTRUCT THE PEDESTAL STRUCTURE AND DMS ENCLOSURE TO WITHSTAND WIND VELOCITIES OF 130 MPH.
- 5. VERIFY ALL UNDERGROUND UTILITY LOCATIONS BEFORE BEGINNING ANY UNDERGROUND WORK. DO NOT DAMAGE ANY EXISTING UTILITIES OR NCDOT COMMUNICATIONS CABLE DURING CONSTRUCTION.
- 6. INSTALLATION SHALL BE BACK TO BACK, FRONT ACCESS DMS ON SINGLE PEDESTAL POLE, PER NCDOT SPECIFICATIONS.

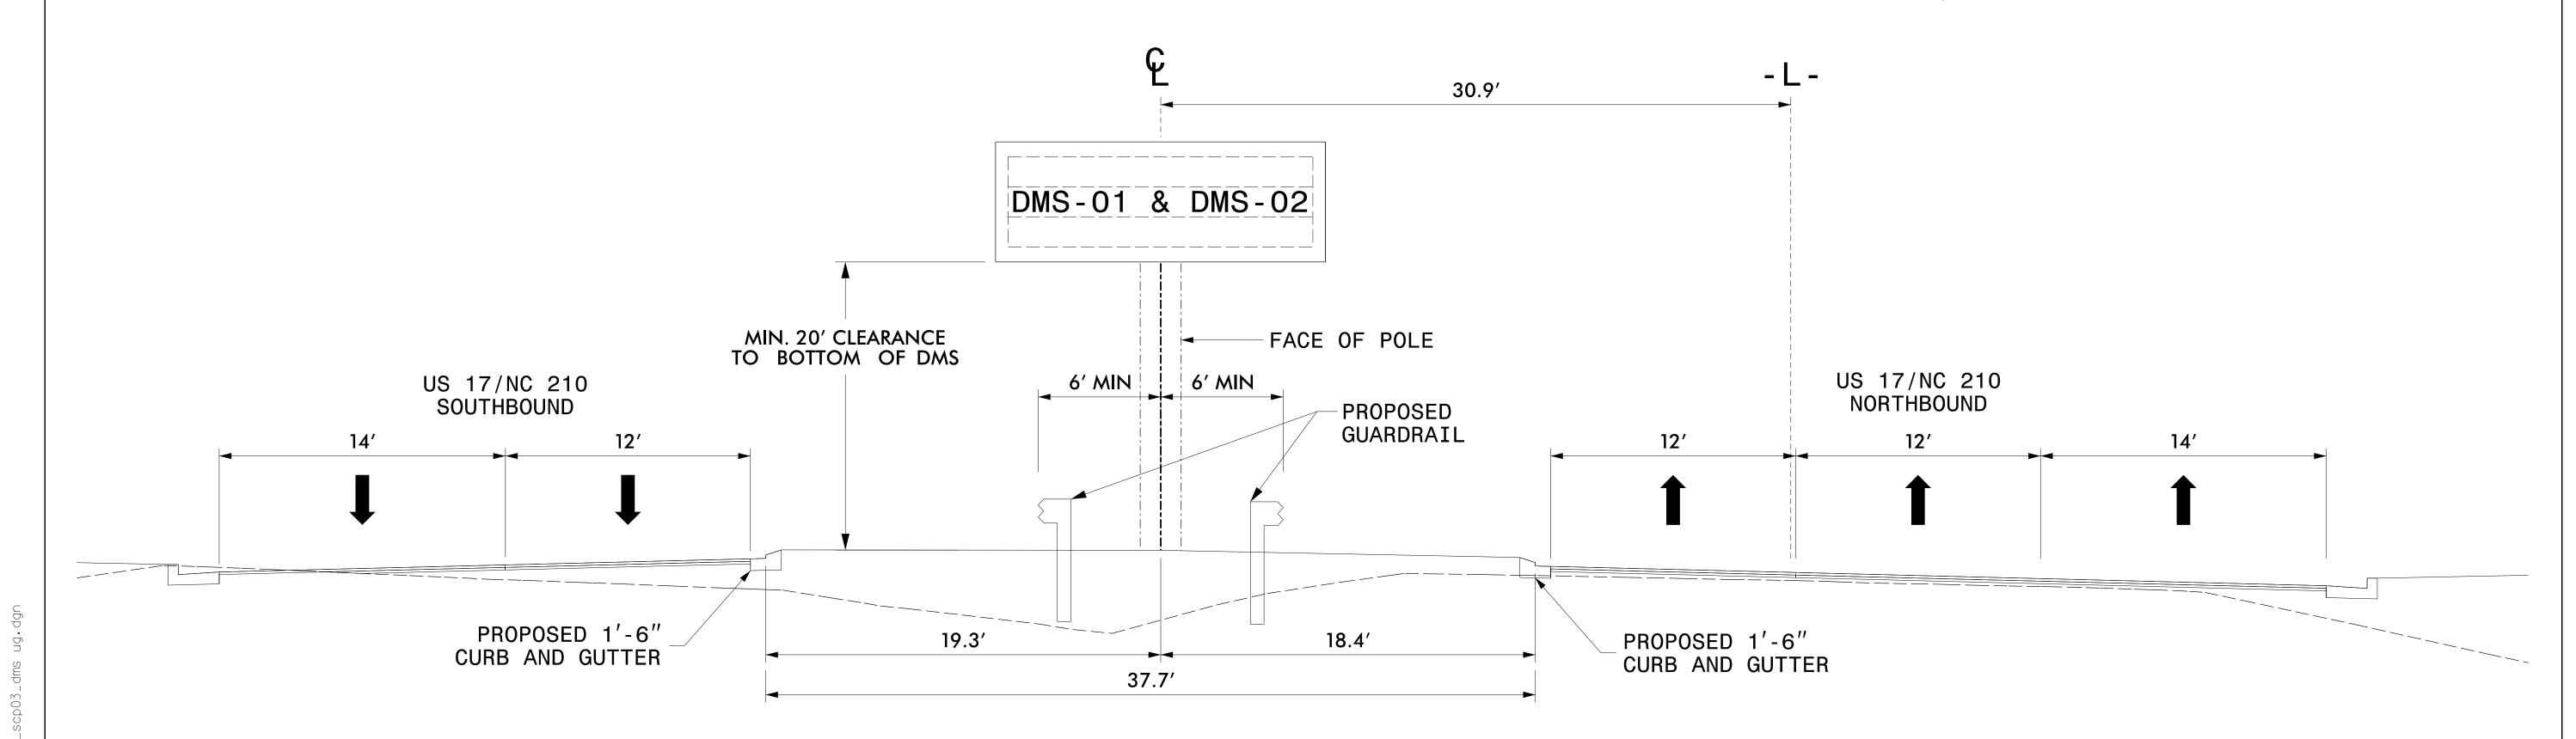

DMS-01 & DMS-02 US 17/NC 210 -L- Sta. 315+00



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350 N.Greenfield Pkwy,Garner,NC 275

DMS-01 and DMS-02 INSTALLATION (DUAL-MOUNTED on SINGLE POLE PEDESTAL)

Division 3 Pender County Near Topsail Beach PLAN DATE: OCTOBER 2021 REVIEWED BY: E D Harris REVIEWED BY: PREPARED BY: R M Muncey L Overn

REVISIONS

SIGNATURES COMPLETED INIT. DATE

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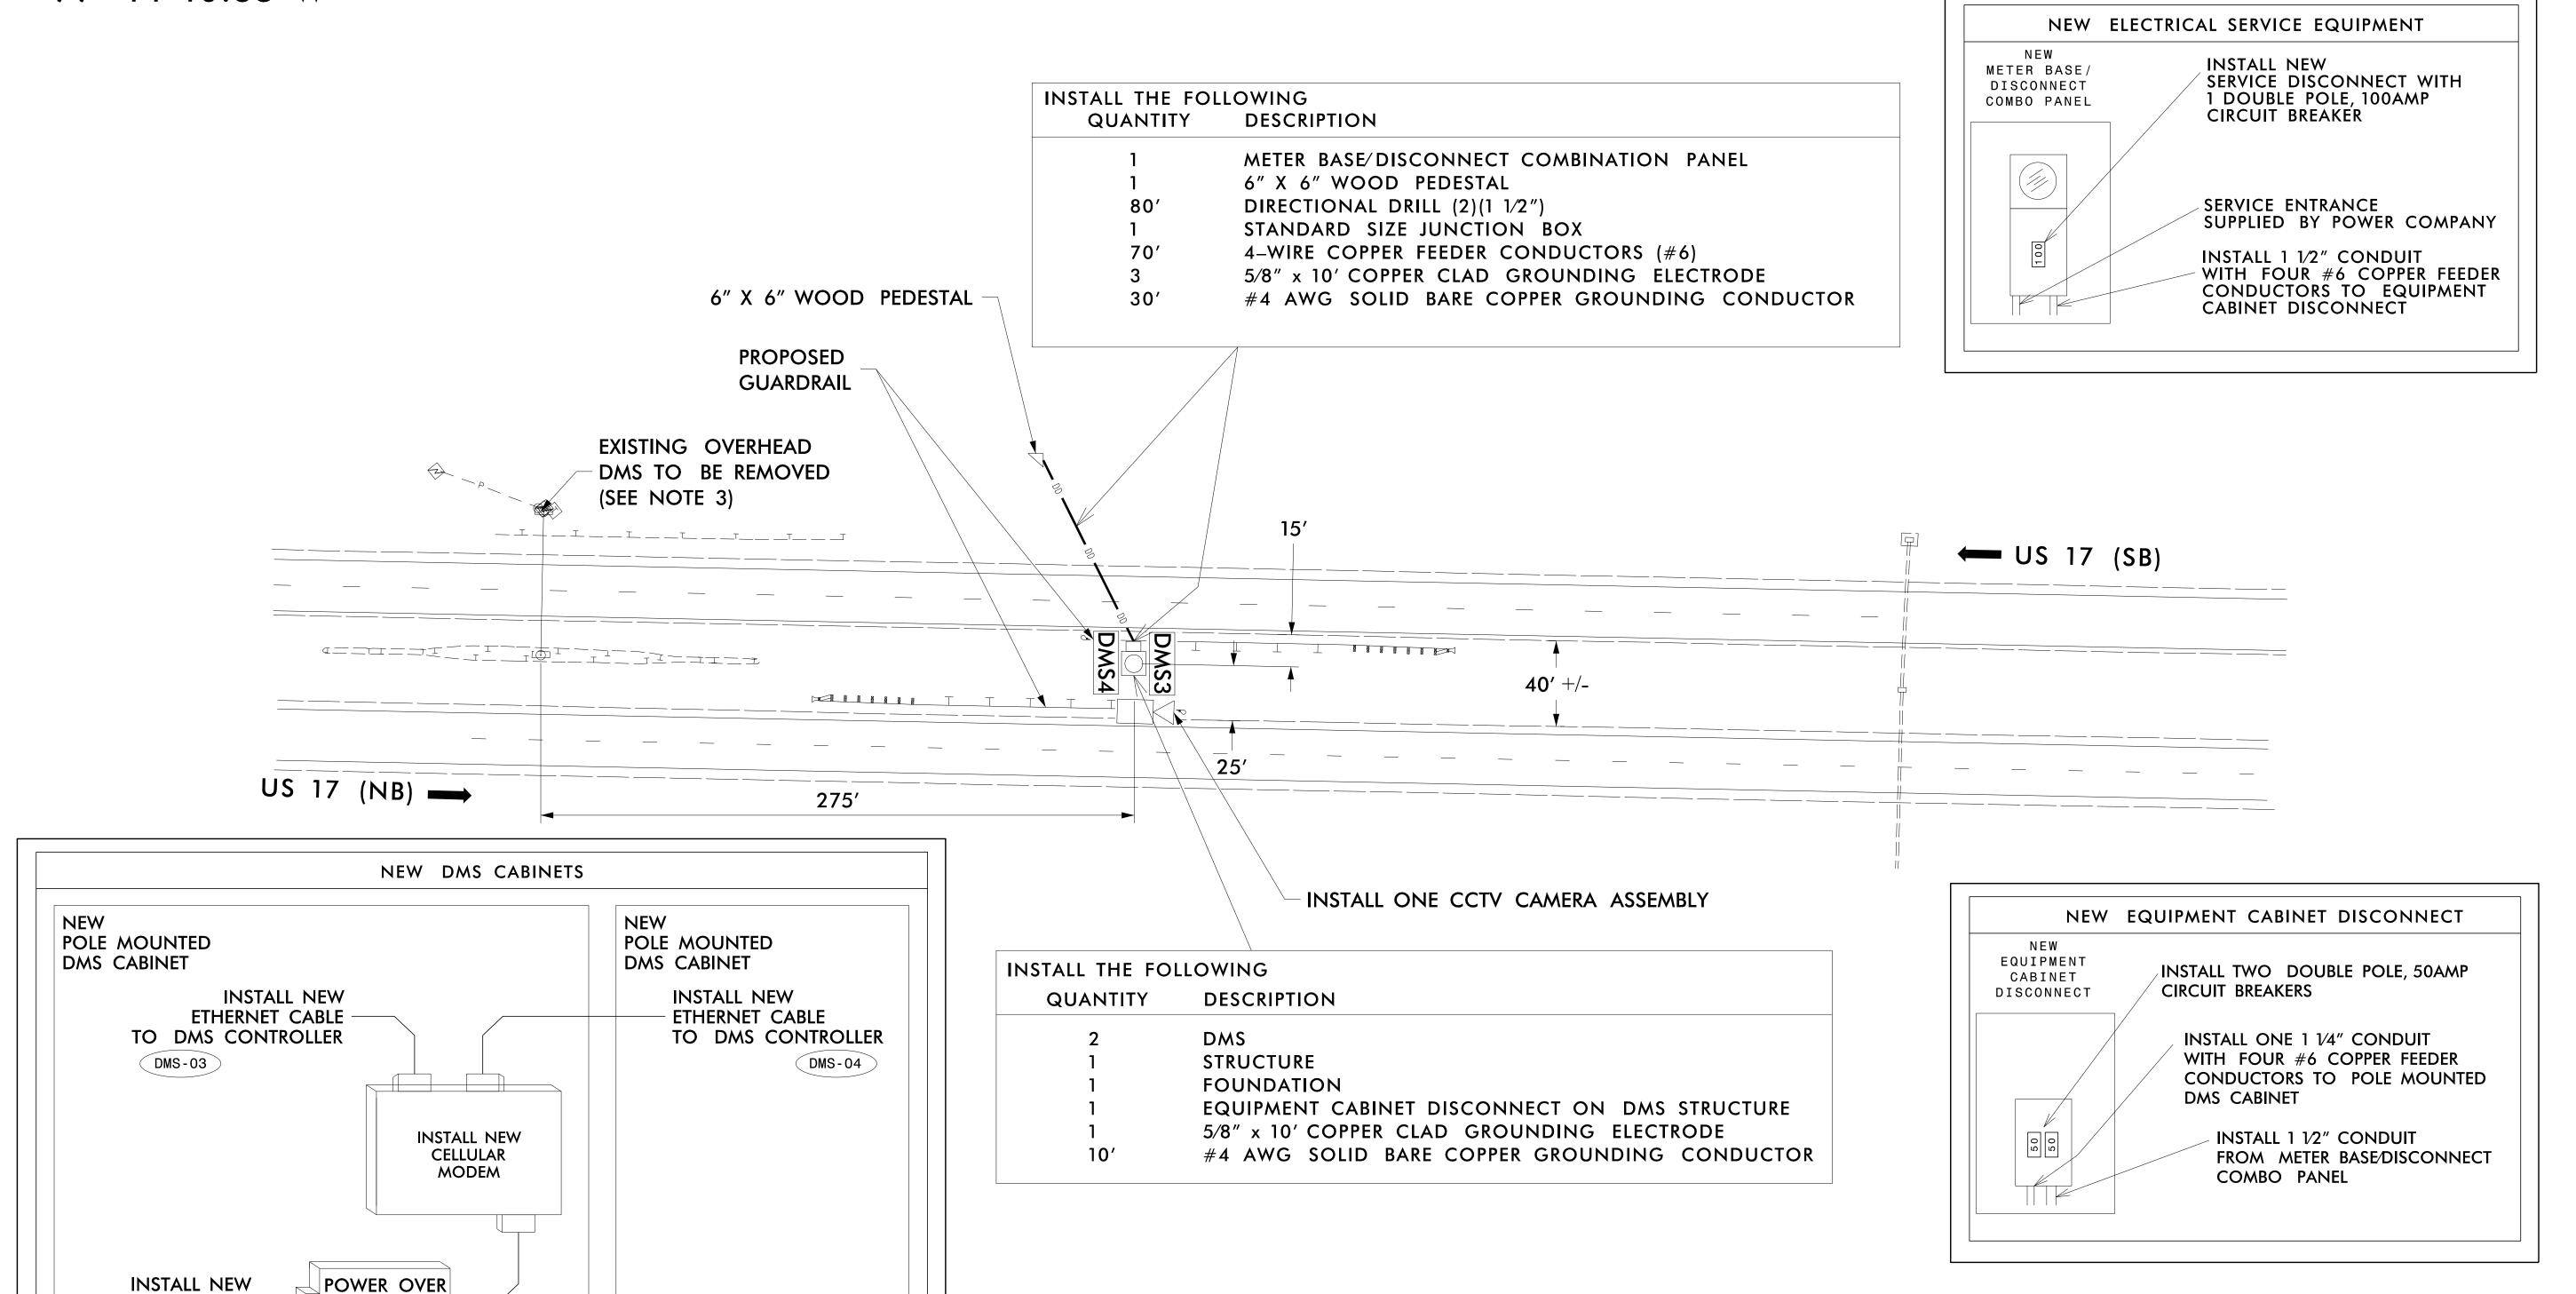
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R-3300B

SCP-21

DMS-03, DMS-04, & CCTV-04

34°20′12.46″N 77°44′40.35″W



NOTES:

ETHERNET CABLE

TO CCTV

(CCTV-04)

ETHERNET

INJECTOR

- 1. INSTALL NEW DMS POLE MOUNTED CABINETS (2) ON NEW DMS STRUCTURE.
- 2. INSTALL NEW GROUNDING SYSTEM AS SHOWN ON SHEET SCP-21 AND AS DESCRIBED IN THE PROJECT SPECIAL PROVISIONS.
- 3. REMOVE AND DISPOSE OF EXISTING DMS, DMS STRUCTURES AND FOUNDATIONS, AND EXISTING ELECTRICAL SERVICE.



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DMS-03, DMS-04, & CCTV-04 ÍNSTALLÁTION (DUAL-MOUNTED DMS on SINGLE

POLE PEDESTAL) REVIEWED BY: L Overn

Division 3 Pender County Near Topsail Beach PLAN DATE: OCTOBER 2021 REVIEWED BY: E D Harris PREPARED BY: R M Muncey REVISIONS INIT. DATE N.T.S.


PROJECT REFERENCE NO. SCP-22

R-3300B

ESTIMATED DIMENSION: 15' X 8' (EACH) MAXIMUM DEADLOAD OF 1500 LBS (EACH)

NOTES:

- 1. USE THE ACTUAL DIMENSIONS AND WEIGHT OF THE DMS PROVIDED BY THE DMS FABRICATOR TO COMPLETE THE DESIGN OF THE DMS STRUCTURE.
- 2. FIELD VERIFY ALL FOOTING ELEVATIONS AND GROUND SLOPES AT THE FOOTINGS USING THE LATEST NCDOT STANDARD SPECIFICATIONS FOR ROADS AND STRUCTURES.
- 3. ENSURE THAT THE TOP OF THE FOOTING EXTENDS AT LEAST 6 INCHES AND NOT MORE THAN 24 INCHES ABOVE THE HIGHEST POINT OF THE GROUND SURFACE AT THE FOOTING.
- 4. DESIGN AND CONSTRUCT THE PEDESTAL STRUCTURE AND DMS ENCLOSURE TO WITHSTAND WIND VELOCITIES OF 130 MPH.

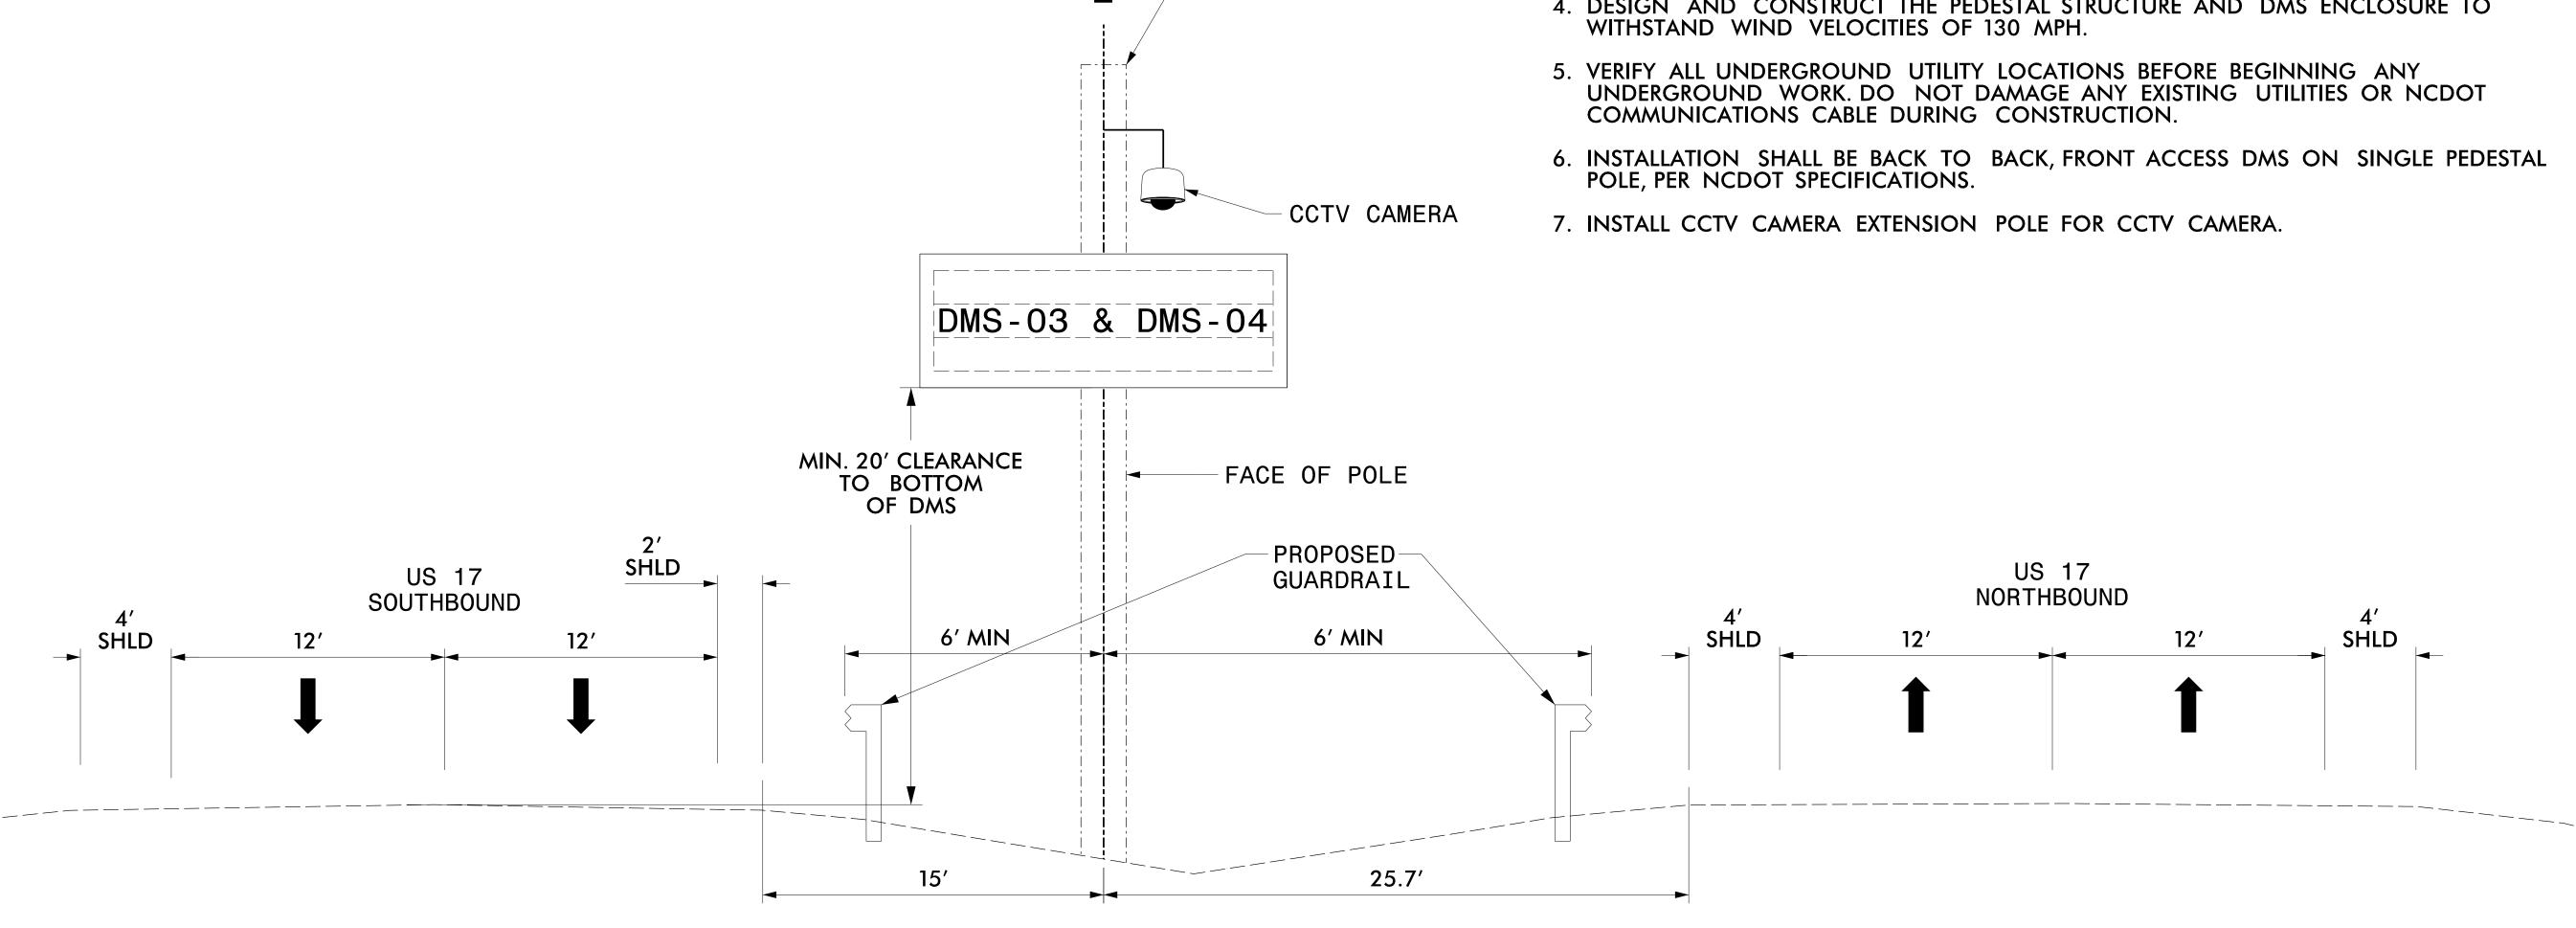

CCTV CAMERA

EXTENSION POLE

DMS-03, DMS-04 & CCTV-04 AT US 17



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N.T.S.

DMS-03, DMS-04, & CCTV-04 INSTALLATION (DUAL-MOUNTED DMS on SINGLE POLE PEDESTAL)


Division 3 Pender County Near Topsail Beach PLAN DATE: OCTOBER 2021 REVIEWED BY: E D Harris REVIEWED BY: PREPARED BY: R M Muncey L Overn REVISIONS INIT. DATE


R-3300B SCP-23

DMS-05 & DMS-06


-L1-Sta.671+75

34°23′0.45″N 77°43′38.71″W

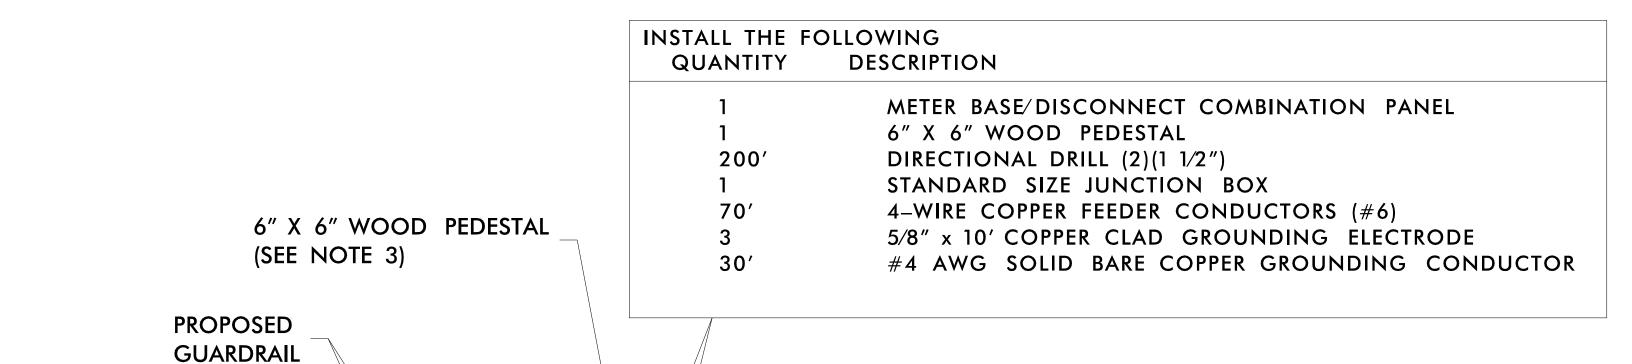

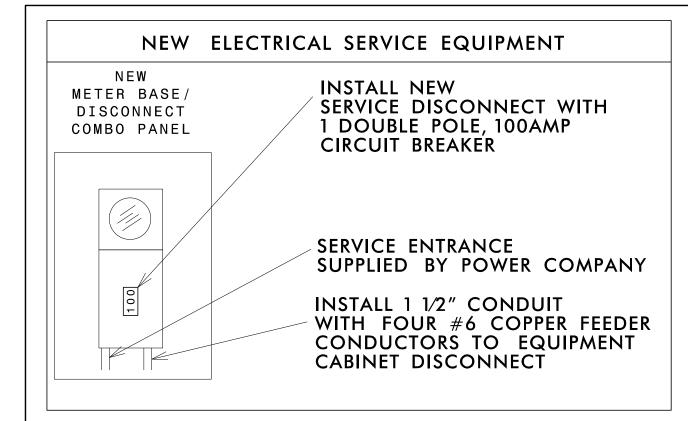


NC 417 (HAMPSTEAD BYPASS) SB

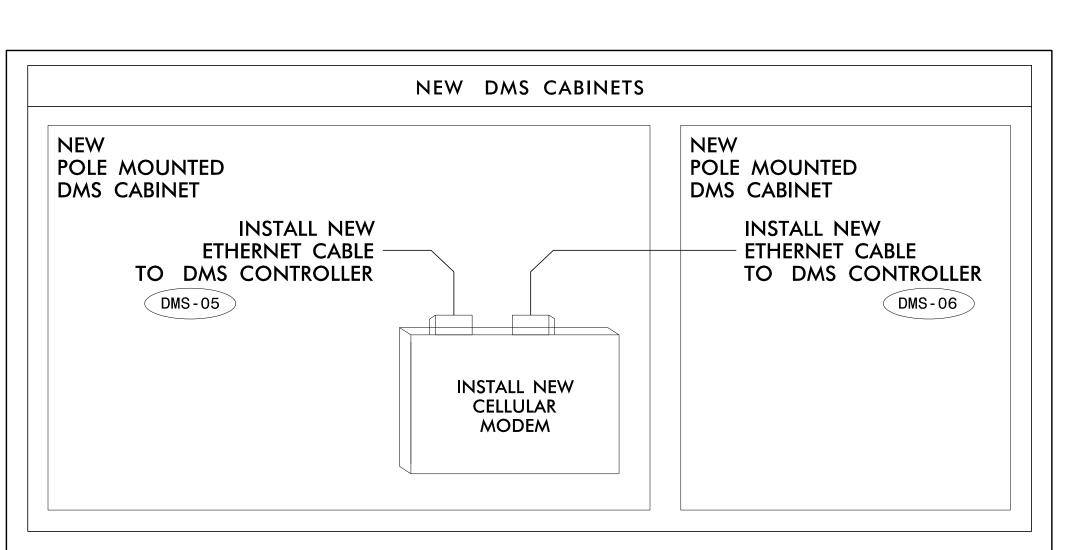

NC 417 (HAMPSTEAD BYPASS) NB

INSTALL THE FOLLOWING DESCRIPTION QUANTITY DMS STRUCTURE FOUNDATION EQUIPMENT CABINET DISCONNECT ON DMS STRUCTURE 5/8" x 10' COPPER CLAD GROUNDING ELECTRODE #4 AWG SOLID BARE COPPER GROUNDING CONDUCTOR

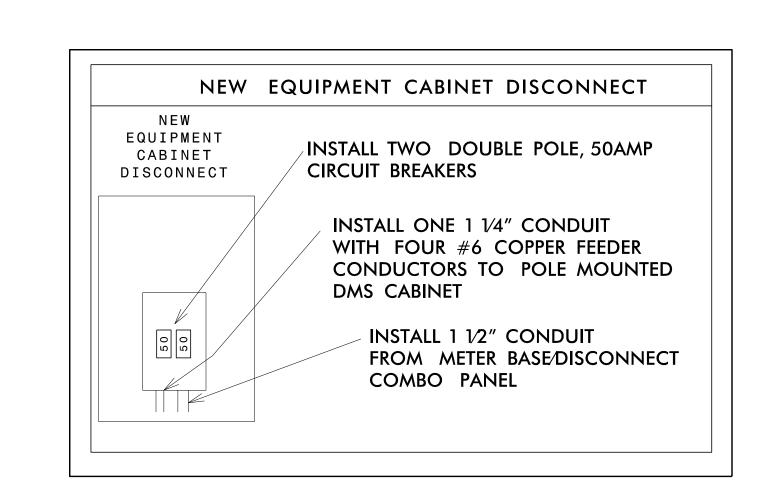

NOTES:

- 1. INSTALL NEW DMS POLE MOUNTED CABINETS (2) ON NEW DMS STRUCTURE.
- 2. INSTALL NEW GROUNDING SYSTEM AS SHOWN ON SHEET SCP-25 AND AS DESCRIBED IN THE PROJECT SPECIAL PROVISIONS.
- 3. INSTALL POWER METER OUTSIDE OF THE PROPOSED NC 417 CONTROL-OF-ACCESS BUT REMAIN WITHING THE EXISTING RIGHT OF WAY OF ONE MILE ROAD.



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N.T.S.

DMS-05 & DMS-06 INSTALLATION (DUAL-MOUNTED DMS on SINGLE

Division 3 Pender County Near Topsail Beach PLAN DATE: OCTOBER 2021 REVIEWED BY: E D Harris REVIEWED BY: PREPARED BY: R M Muncey L Overn REVISIONS

POLE PEDESTAL) INIT. DATE CADD Filename:

SIGNATURES COMPLETED Regina M. Muncey 10/5/2021

DOCUMENT NOT CONSIDERED

FINAL UNLESS ALL


PROJECT REFERENCE NO.

R-3300B SCP-24

ESTIMATED DIMENSION: 15' X 8' (EACH) MAXIMUM DEADLOAD OF 1500 LBS (EACH)

NOTES:

- 1. USE THE ACTUAL DIMENSIONS AND WEIGHT OF THE DMS PROVIDED BY THE DMS FABRICATOR TO COMPLETE THE DESIGN OF THE DMS STRUCTURE.
- 2. FIELD VERIFY ALL FOOTING ELEVATIONS AND GROUND SLOPES AT THE FOOTINGS USING THE LATEST NCDOT STANDARD SPECIFICATIONS FOR ROADS AND STRUCTURES.
- 3. ENSURE THAT THE TOP OF THE FOOTING EXTENDS AT LEAST 6 INCHES AND NOT MORE THAN 24 INCHES ABOVE THE HIGHEST POINT OF THE GROUND SURFACE AT THE FOOTING.
- 4. DESIGN AND CONSTRUCT THE PEDESTAL STRUCTURE AND DMS ENCLOSURE TO WITHSTAND WIND VELOCITIES OF 130 MPH.
- 5. VERIFY ALL UNDERGROUND UTILITY LOCATIONS BEFORE BEGINNING ANY UNDERGROUND WORK. DO NOT DAMAGE ANY EXISTING UTILITIES OR NCDOT COMMUNICATIONS CABLE DURING CONSTRUCTION.
- 6. INSTALLATION SHALL BE BACK TO BACK, FRONT ACCESS DMS

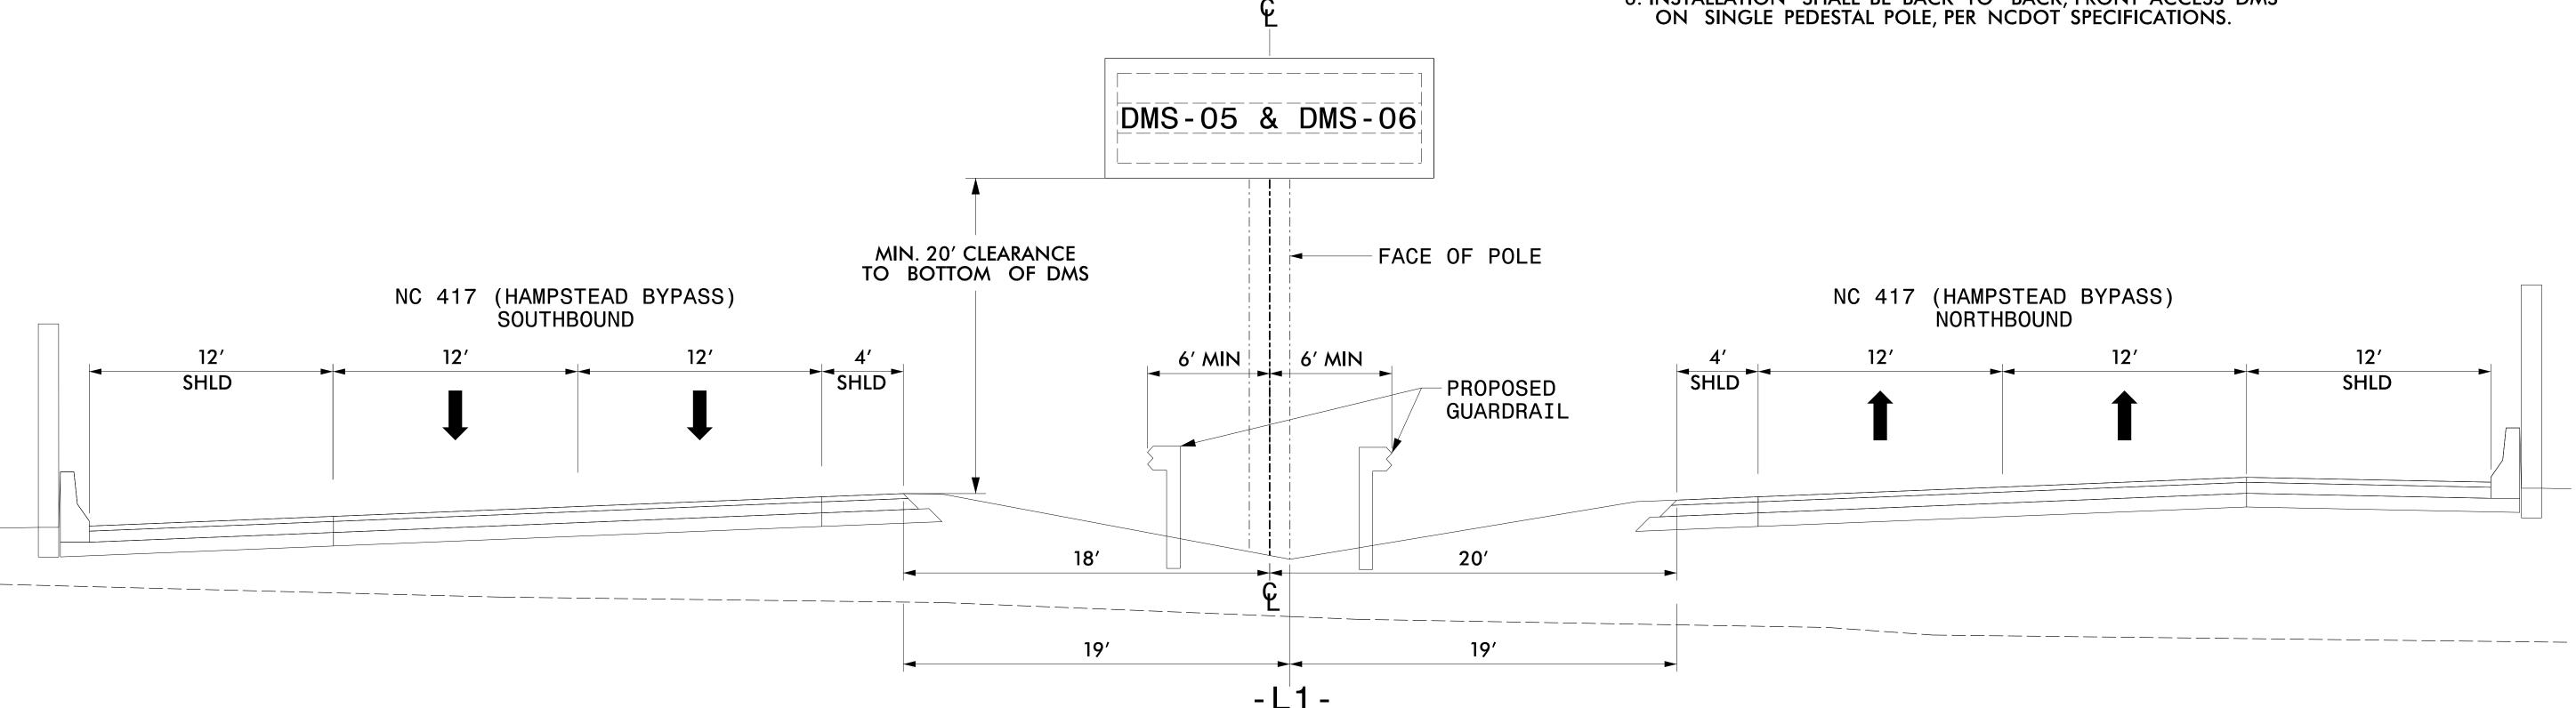

DMS-05 & DMS-06 NC 417 (HAMPSTEAD BYPASS) -L1- 671+75 (Cross Section at -L1- Sta. 671+50)



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DMS-05 and DMS-06 INSTALLATION (DUAL-MOUNTED on SINGLE POLE PEDESTAL)

Division 3 Pender County Near Topsail Beach

PLAN DATE: OCTOBER 2021 REVIEWED BY: E D Harris PREPARED BY: R M Muncey REVIEWED BY: L Overn REVISIONS INIT. DATE N.T.S.


SIGNATURES COMPLETED

DOCUMENT NOT CONSIDERED FINAL UNLESS ALL

R-3300B	SCP-25
PROJECT REFERENCE NO.	SHEET NO.

NOTES

- INSTALL A MINIMUM OF THREE (3) GROUNDING ELECTRODES SPACED A MINIMUM OF 10 FEET APART. ENSURE THAT EXISTING UNDERGROUND FACILITIES ARE NOT DAMAGED DURING INSTALLATION.
- 2. TEST GROUNDING SYSTEM USING AN APPROVED METHOD. SYSTEM SHOULD MEASURE TWENTY (20) OHMS OR LESS. ADDITIONAL GROUNDING ELECTRODES SHALL BE INSTALLED AS DIRECTED BY THE ENGINEER TO MEET THIS REQUIREMENT.
- IRREVERSIBLE MECHANICALLY CRIMP ALL CONNECTIONS TO GROUND RODS.
- INSTALL MARKER TAPE DIRECTLY ABOVE ALL GROUNDING ELECTRODES AND CONDUCTORS AT A DEPTH OF 12 INCHES.
- REMOVE BONDING JUMPER IN EQUIPMENT CABINET IF INSTALLED BETWEEN AC NEUTRAL AND EQUIPMENT GROUND.
- BOND ALL RIGID GALVANIZED STEEL CONDUITS ENTERING THE CABINET TO EQUIPMENT GROUND.
- ENSURE EQUIPMENT GROUND IS ELECTRICALLY BONDED TO CABINET.
- IRREVERSIBLE MECHANICALLY CRIMP THE SERVICE POLE GROUND WIRE TO THE GROUND ROD SYSTEM.

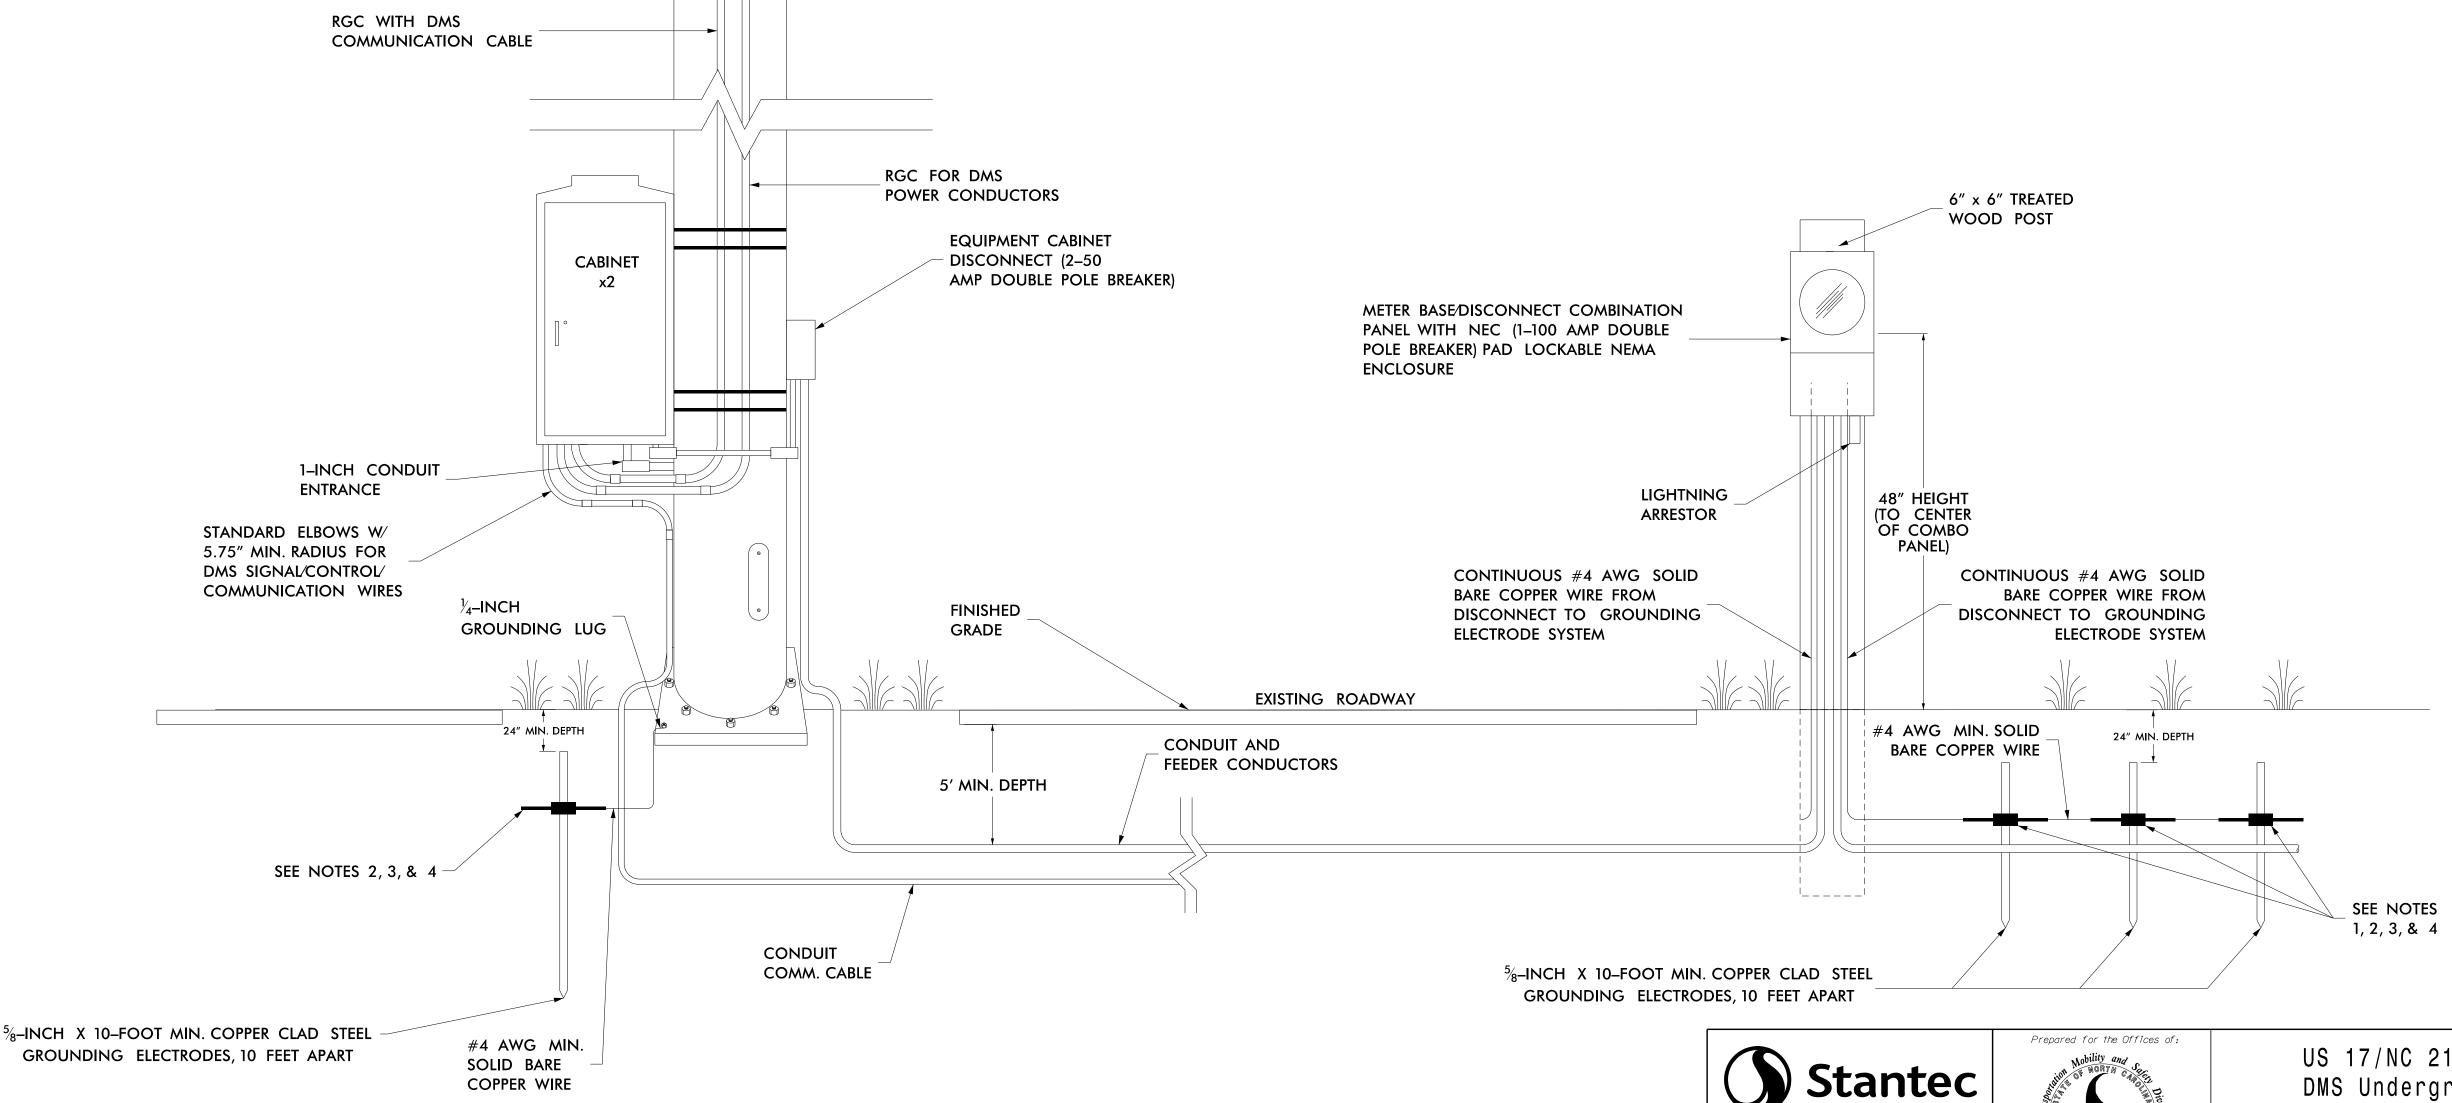

9:01:52 U:*Trdf-

N.T.S.

350 N.Greenfield Pkwy,Garner,NC 275

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License No. F-0672

801 Jones Franklin Road-Suite 300

US 17/NC 210/NC 417 DMS Underground Fed Electrical Service Detail

> Division 3 Pender County Near Topsail Beach PLAN DATE: OCTOBER 2021 REVIEWED BY: E D Harris PREPARED BY: R M Muncey REVIEWED BY: L Overn

REVISIONS INIT. DATE

Regina M. Municy 10/5/2021 CADD Filename:

DOCUMENT NOT CONSIDERED

FINAL UNLESS ALL SIGNATURES COMPLETED

43239

