

INDEX OF SHEETS

SHEET NO.: **DESCRIPTION:**

UC-1 TITLE SHEET *UC-2* UTILITY SYMBOLOGY **NOTES**

UC-3A THRU UC-3C DETAILS

UTILITY CONSTRUCTION SHEETS UC-4 THRU UC-8 PROFILE SHEET *UC-9*


WATER AND SEWER OWNERS ON PROJECT

(A) WATER - TOWN OF MOUNT PLEASANT (B) SANITARY SEWER - WATER AND SEWER AUTHORITY OF CABARRUS COUNTY PREPARED IN THE OFFICE OF



(704) 372–1885 FAX: (704) 372–3393

JASON GRISCOM, PE CONSULTANT CONTACT #1 ANDREW VANE, PE_ CONSULTANT CONTACT #2 CONSULTANT CONTACT #3

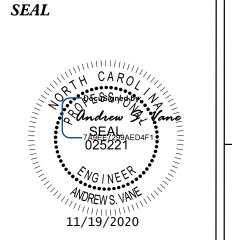



DIVISION OF HIGHWAYS UTILITIES UNIT 1555 MAIL SERVICES CENTER RALEIGH NC 27699–1555 PHONE (919) 707–6690 FAX (919) 250-4151

MICHAEL BRIGHT UTILITIES REGIONAL ENGINEER DONALD HAMPTON UTILITIES ENGINEER

AMY DUPREE YORK UTILITIES AREA COORDINATOR STEVE TREXLER UTILITIES COORDINATOR

DocuSign Envelope ID: 721B6CCE-736F-4F29-B83B-6B09838BD323

STATE OF NORTH CAROLINA DIVISION OF HIGHWAYS



PROJECT REFERENCE NO. SHEET NO. UC-2

UTILITIES PLAN SHEET SYMBOLS

PROPOSED WATER SYMBOLS

Water Line (Sized as Shown) 11½ Degree Bend 22½ Degree Bend 45 Degree Bend 90 Degree Bend Plug Cross-Reducer Gate Valve Butterfly Valve Tapping Valve Line Stop Line Stop with Bypass Blow Off Fire Hydrant ···· Relocate Fire Hydrant Remove Fire Hydrant Water Meter Relocate Water Meter Remove Water Meter Water Pump Station RPZ Backflow Preventer DCV Backflow Preventer Relocate RPZ Backflow Preventer Relocate DCV Backflow Preventer

PROPOSED SEWER SYMBOLS

Gravity Sewer Line	12" SS———
Force Main Sewer Line (Sized as Shown)	12" FSS-
Manhole (Sized per Note)	
Sewer Pump StationPS(SS)	

PROPOSED MISCELLANEOUS UTILITIES SYMBOLS

Power Pole	6	Thrust Block
elephone Pole	-0-	Air Release Valve
Joint Use Pole	-	Utility Vault
elephone Pedestal	O PED	Concrete Pier
Jtility Line by Others Type as Shown)	PROP O/H POW LINES	Steel Pier
renchless Installation ————————————————————————————————————	12" TL INSTALL	Plan Note
Encasement by Open Cut⊏	24" ENCAS BY OC	Pay Item Note
Encasement ⊏	24" ENCASEMENT	

EXISTING UTILITIES SYMBOLS

Power Pole	•
Telephone Pole	-
Joint Use Pole	-
Jtility Pole	•
Jtility Pole with Base	⊡
H-Frame Pole	•—•
Power Transmission Line Tower	
Water Manhole	W
Power Manhole	P
Telephone Manhole	1
Sanitary Sewer Manhole	(
Hand Hole for Cable	H _H
Power Transformer	M
Telephone Pedestal	Ī
CATV Pedestal	C
Gas Valve	\Diamond
Gas Meter	\rightarrow
Located Miscellaneous Utility Object	⊙
Abandoned According to Utility Records	AATUR
End of Information	E.O.I.

Underground Power Line	
Underground Telephone Cable	
Underground Telephone Conduit	
Underground Fiber Optics Telephone Cable	
Underground TV Cable	
Underground Fiber Optics TV Cable	
Underground Gas Pipeline	
Aboveground Gas Pipeline	A/G Gas
Underground Water Line	
Aboveground Water Line	A/G Water
Underground Gravity Sanitary Sewer Line	ss
Aboveground Gravity Sanitary Sewer Line	A/G Sanitary Sewer
Underground SS Forced Main Line	
Underground Unknown Utility Line	
SUE Test Hole	•
Water Meter	\odot
Water Valve	\otimes
Fire Hydrant	❖
Sanitary Sewer Cleanout	\oplus

*For Existing Utilities	
Utility Line Drawn from Record	
Designated Utility Line	

DocuSign Envelope ID: 721B6CCE-736F-4F29-B83B-6B09838BD323

UTILITY CONSTRUCTION



DOCUMENT NOT CONSIDERED FINAL UNLESS ALL SIGNATURES COMPLETED

UC-3 B-5813 DESIGNED BY: VHM VHMRAWN BY: andrew & Vane CHECKED BY: ASV APPROVED BY: XMD REVISED: NORTH CAROLINA DEPARTMENT OF TRANSPORTATION 11/19/2020 JTILITIES ENGINEERING SEC ILITY CONSTRUCTION PLANS ONLY

PROJECT REFERENCE NO.

PHONE:(919)707-6690 FAX:(919)250-4151

SHEET NO.

UTILITY CONSTRUCTION

- 1. THE PROPOSED UTILITY CONSTRUCTION SHALL MEET THE APPLICABLE REQUIREMENTS OF THE NC DEPARTMENT OF TRANSPORTATION'S "STANDARD SPECIFICATIONS FOR ROADS AND STRUCTURES" DATED JANUARY 2018.
- 2. THE EXISTING UTILITIES BELONG TO THE WATER AND SEWER AUTHORITY OF CABARRUS COUNTY AND THE TOWN OF MOUNT PLEASANT.
- 3. ALL WATER LINES TO BE INSTALLED WITHIN COMPLIANCE OF THE RULES AND REGULATIONS OF THE NORTH CAROLINA DEPARTMENT OF ENVIRONMENTAL QUALITY. DIVISION OF WATER RESOURCES. PUBLIC WATER SUPPLY SECTION. ALL SEWER LINES TO BE INSTALLED WITHIN COMPLIANCE OF THE RULES AND REGULATIONS OF THE NORTH CAROLINA DEPARTMENT OF ENVIRONMENT QUALITY, DIVISION OF WATER RESOURCES, WATER QUALITY SECTION. PERFORM ALL WORK IN ACCORDANCE WITH THE APPLICABLE PLUMBING CODES.
- 4. THE UTILITY OWNER OWNS THE EXISTING UTILITY FACILITIES AND WILL OWN THE NEW UTILITY FACILITIES AFTER ACCEPTANCE BY THE DEPARTMENT. THE DEPARTMENT OWNS THE CONSTRUCTION CONTRACT AND HAS ADMINISTRATIVE AUTHORITY. COMMUNICATIONS AND DECISIONS BETWEEN THE CONTRACTOR AND UTILITY OWNER ARE NOT BINDING UPON THE DEPARTMENT OR THIS CONTRACT UNLESS AUTHORIZED BY THE ENGINEER. AGREEMENTS BETWEEN THE UTILITY OWNER AND CONTRACTOR FOR THE WORK THAT IS NOT PART OF THIS CONTRACT OR IS SECONDARY TO THIS CONTRACT ARE ALLOWED, BUT ARE NOT BINDING UPON THE DEPARTMENT.
- 5. PROVIDE ACCESS FOR THE DEPARTMENT PERSONNEL AND THE OWNER'S REPRESENTATIVES TO ALL PHASES OF CONSTRUCTION. NOTIFY DEPARTMENT PERSONNEL AND THE UTILITY OWNER TWO WEEKS PRIOR TO COMMENCEMENT OF ANY WORK AND ONE WEEK PRIOR TO SERVICE INTERRUPTION. KEEP UTILITY OWNERS' REPRESENTATIVES INFORMED OF WORK PROGRESS AND PROVIDE OPPORTUNITY FOR INSPECTION OF CONSTRUCTION AND TESTING.

- 6. THE PLANS DEPICT THE BEST AVAILABLE INFORMATION FOR THE LOCATION, SIZE, AND TYPE OF MATERIAL FOR ALL EXISTING UTILITIES. MAKE INVESTIGATIONS FOR DETERMINING THE EXACT LOCATION, SIZE, AND TYPE MATERIAL OF THE EXISTING FACILITIES AS NECESSARY FOR THE CONSTRUCTION OF THE PROPOSED UTILITIES AND FOR AVOIDING DAMAGE TO EXISTING FACILITIES. REPAIR ANY DAMAGE INCURRED TO EXISTING FACILITIES TO THE ORIGINAL OR BETTER CONDITION AT NO ADDITIONAL COST TO THE DEPARTMENT.
- 7. MAKE FINAL CONNECTIONS OF THE NEW WORK TO THE EXISTING SYSTEM WHERE INDICATED ON THE PLANS, AS REQUIRED TO FIT THE ACTUAL CONDITIONS, OR AS DIRECTED.
- 8. MAKE CONNECTIONS BETWEEN EXISTING AND PROPOSED UTILITIES AT TIMES MOST CONVENIENT TO THE PUBLIC, WITHOUT ENDANGERING THE UTILITY SERVICE, AND IN ACCORDANCE WITH THE UTILITY OWNER'S REQUIREMENTS. MAKE CONNECTIONS ON WEEKENDS, AT NIGHT, AND ON HOLIDAYS IF NECESSARY.
- 9. ALL UTILITY MATERIALS SHALL BE APPROVED PRIOR TO DELIVERY TO THE PROJECT. SEE 1500-7. "SUBMITTALS AND RECORDS" IN SECTION 1500 OF THE STANDARD SPECIFICATIONS.

PROJECT SPECIFIC NOTES:

- 1. SEE DRAWING UC-3C FOR AERIAL SEWER SUPPORT DETAILS.
- 2. PROVIDE TEMPORARY COFFERDAM OR SHEETING AS NECESSARY TO INSTALL AERIAL SEWER PIPE AND AERIAL SEWER SUPPORTS.
- 3. ENGINEER SHALL INSPECT ALL MATERIALS ONSITE PRIOR TO INSTALLATION, DAMAGED MATERIALS SHALL BE REPLACED OR REPAIRED IN ACCORDANCE WITH MANUFACTURER'S RECOMMENDATIONS.

- 4. WATER MAINS OR SEWER LINES CROSSING UNDER STORM DRAIN PIPE SHALL HAVE 24" MIN VERTICAL CLEARANCE UNLESS SPECIFIED ON THE PLAN/PROFILE.
- 5. ALL SEWER MATERIALS, EQUIPMENT, LABOR, AND WORKMANSHIP SHALL BE IN ACCORDANCE WITH THE WATER AND SEWER AUTHORITY OF CABARRUS COUNTY'S STANDARD SPECIFICATIONS.
- 6. PROVIDE APPROPRIATELY SIZED FULLY FUNCTIONAL REDUNDANT BYPASS PUMPS (I.E., PUMPS, SUCTION AND DISCHARGE PIPING) AND TEST PRIOR TO PUTTING IN TO OPERATION. COORDINATE WITH WSACC TO DETERMINE ANTICIPATED FLOW RATES.
- 7. PROVIDE AUTO-START SYSTEM, WITH HIGH-LEVEL ALARM AND TELEMETRY DIAL-OUT CAPABILITIES (TO NOTIFY CONTRACTOR OF ANY POTENTIAL PROBLEMS WITH THE PUMPS 24/7). CONTRACTOR MUST RESPOND TO ALARMS IMMEDIATELY.
- 8. CONTRACTOR IS RESPONSIBLE FOR ANY COSTS (CLEAN-UP, FINES, ADDITIONAL EQUIPMENT RENTAL, ETC.) AS ASSOCIATED WITH ANY OPERATIONAL PROBLEMS AND/OR SPILLS WITH THE BYPASS PUMPING OPERATION.
- 9. CONTRACTOR SHALL IMMEDIATELY NOTIFY THE DEPARTMENT AND WSACC IN THE EVENT A SURCHARGE OCCURS THAT RESULTS IN AN OVERFLOW OF SEWAGE.

DocuSign Envelope ID: 721B6CCE-736F-4F29-B83B-6B09838BD323

STV Engineers, Inc.
900 West Trade St., Suite 718
Charlotte, NC 28202
NC License Number F-0991

DOCUMENT NOT CONSIDERED FINAL UNLESS ALL SIGNATURES COMPLETED

PROJECT REFERENCE NO. SHEET NO. UC-3A B-5813 DESIGNED BY: VHM H CARO VHMDRAWN BY: CHECKED BY: ASV APPROVED BY: XMD REVISED: NORTH CAROLINA DEPARTMENT OF ANDREWS. VAN TRANSPORTATION 11/19/2020

UTILITIES ENGINEERING SEC


FAX: (919)250-4151


UTILITY CONSTRUCTION


PHONE: (919)707-6690 UTILITY CONSTRUCTION


PLANS ONLY


PROJECT TYPICAL DETAILS

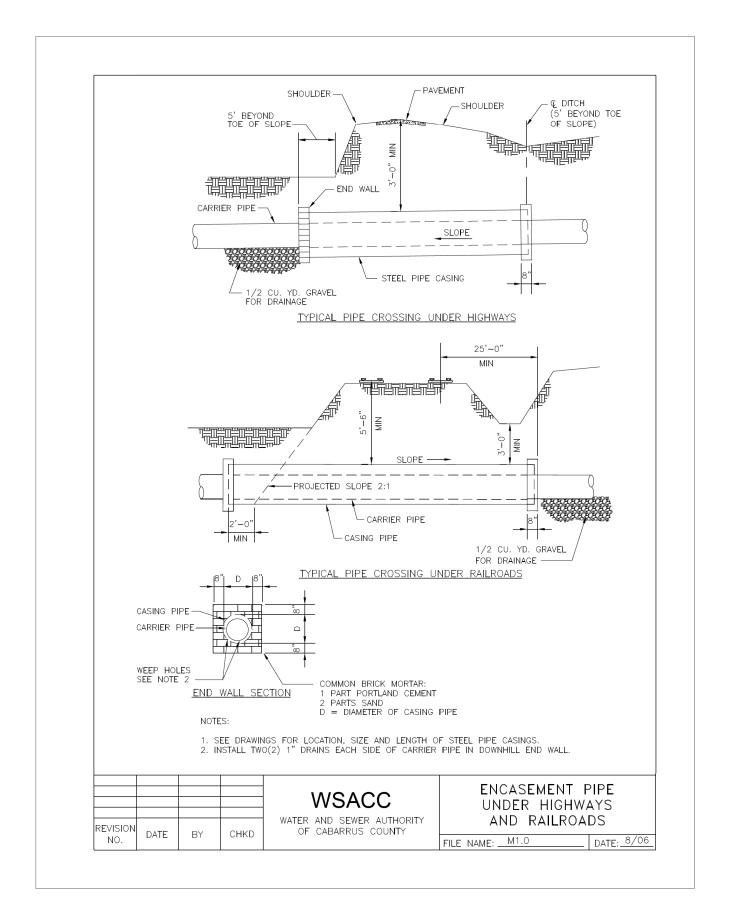

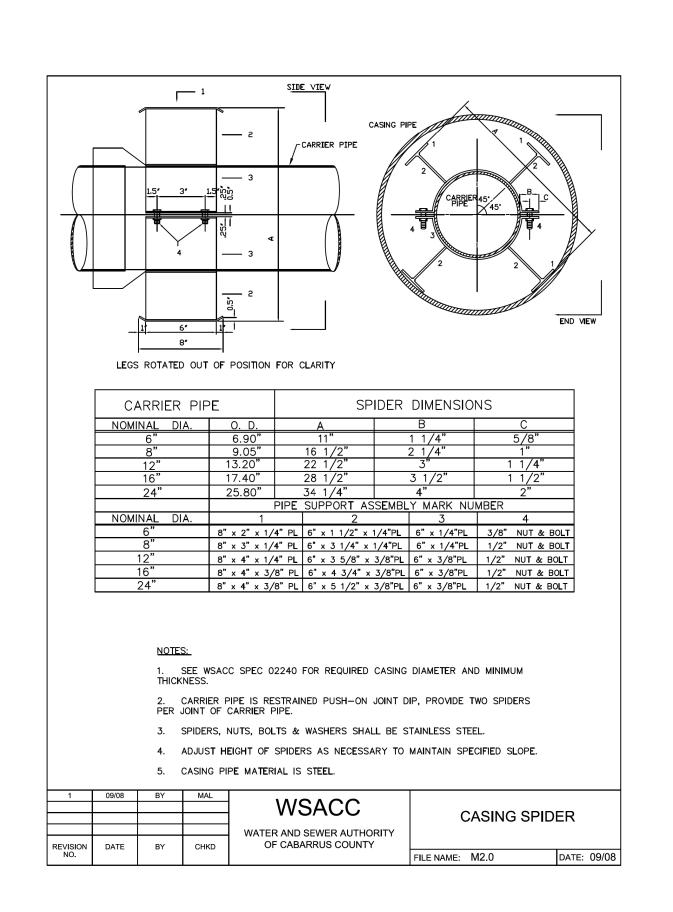

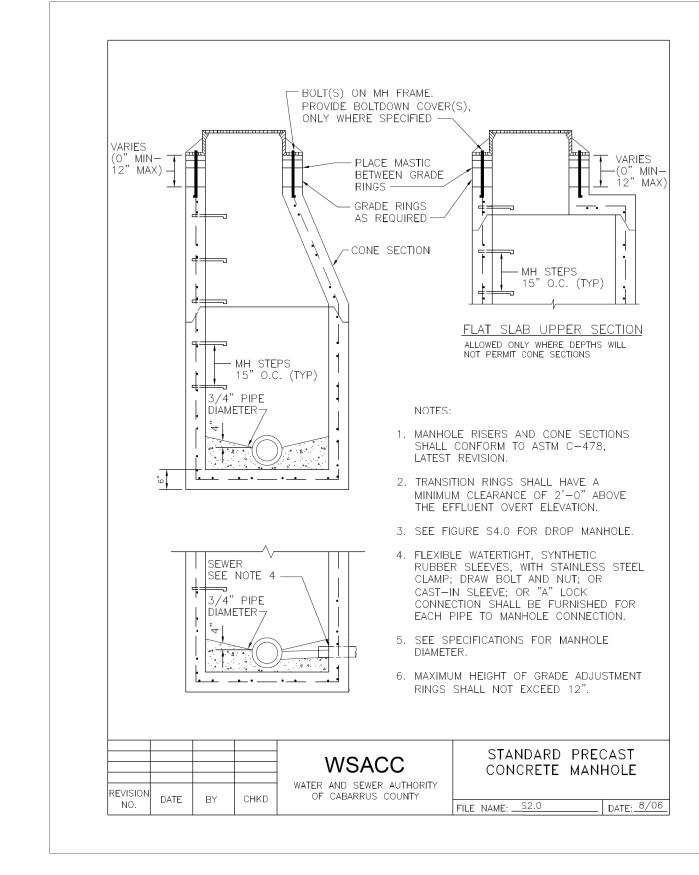

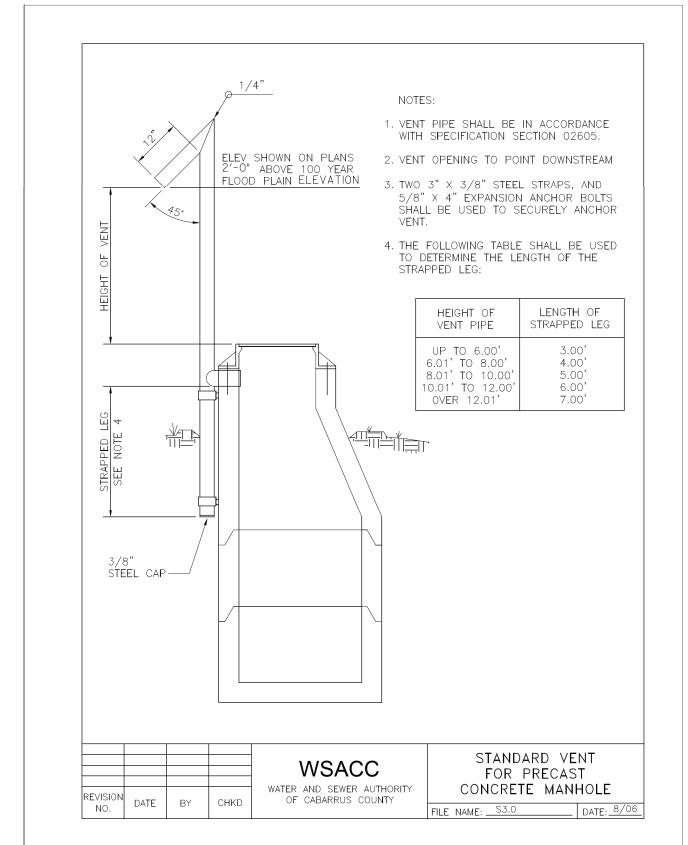

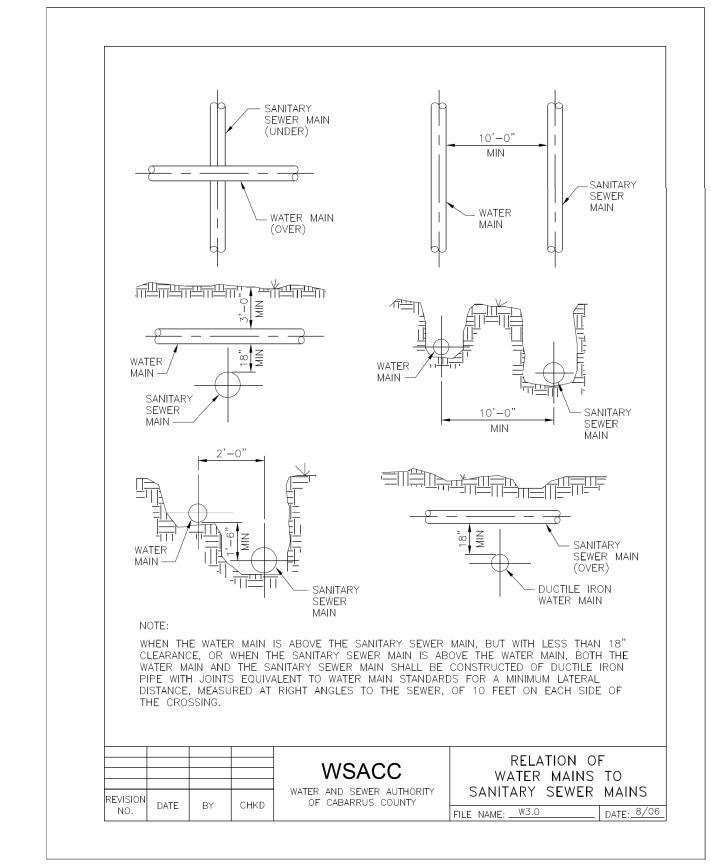

DOCUMENT NOT CONSIDERED FINAL UNLESS ALL SIGNATURES COMPLETED

UC-3B B-5813 DESIGNED BY: VHM CARO VHMDRAWN BY: CHECKED BY: ASV APPROVED BY: XMD REVISED: NORTH CAROLINA DEPARTMENT OF ANDREW S. VAN TRANSPORTATION 11/19/2020 UTILITIES ENGINEERING SEC

SHEET NO.


PLANS ONLY


PROJECT REFERENCE NO.

FAX: (919)250-4151


UTILITY CONSTRUCTION

PHONE: (919)707-6690 UTILITY CONSTRUCTION

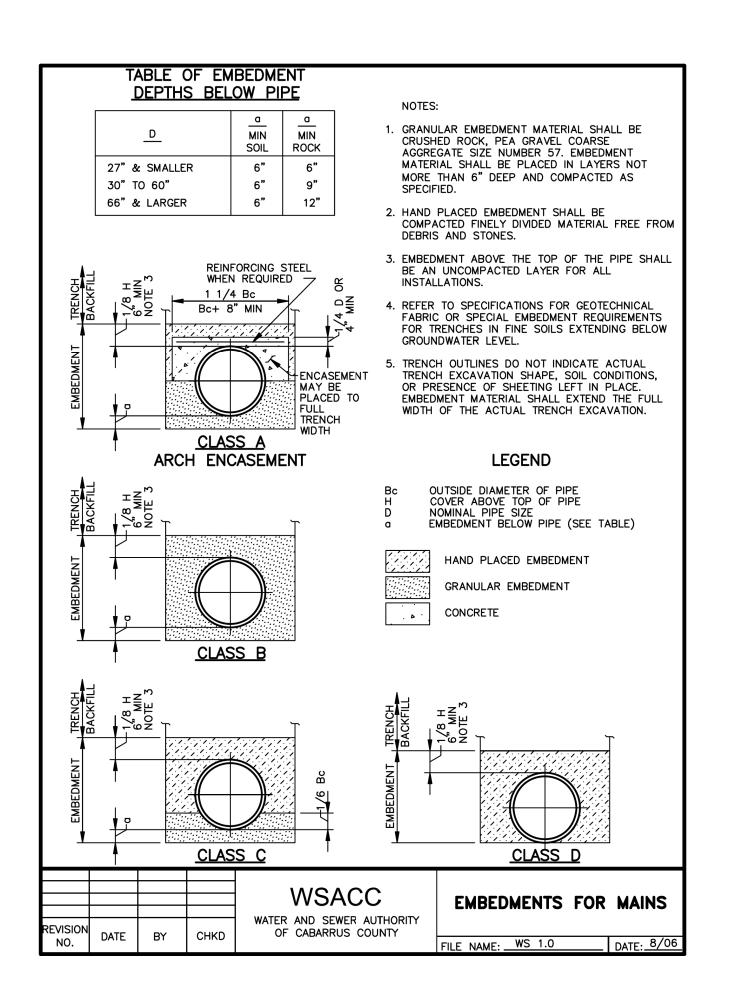


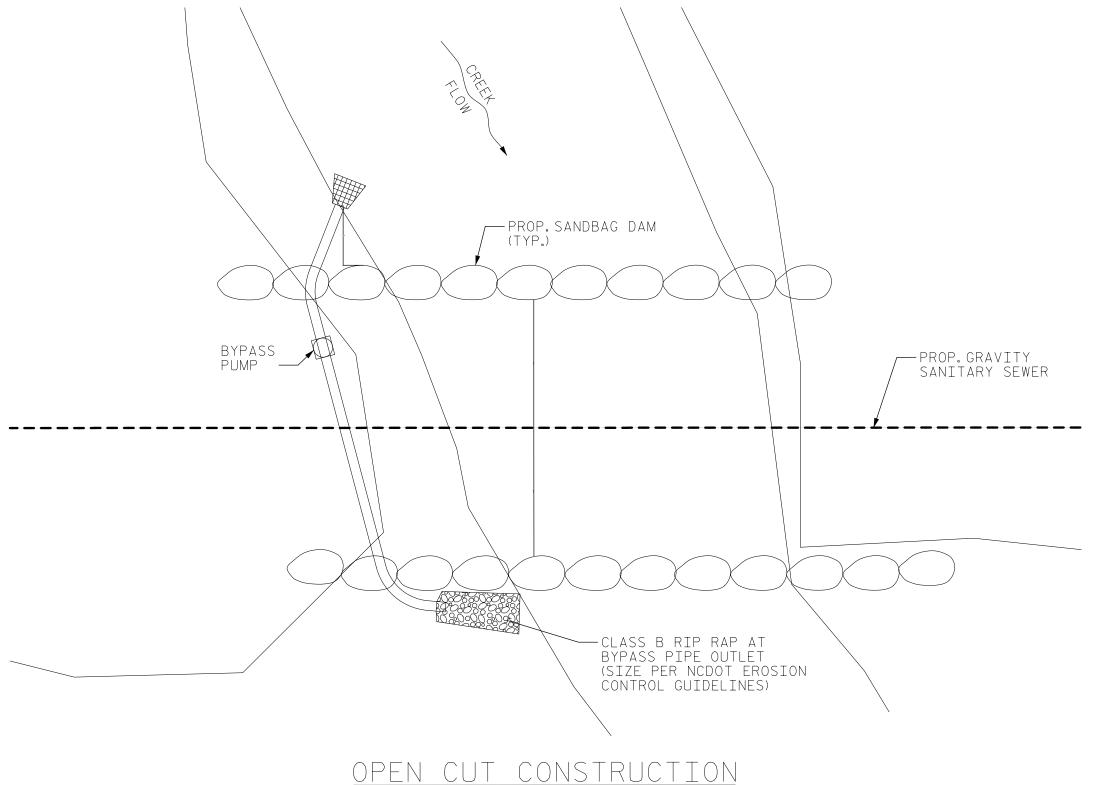

NOT TO SCALE

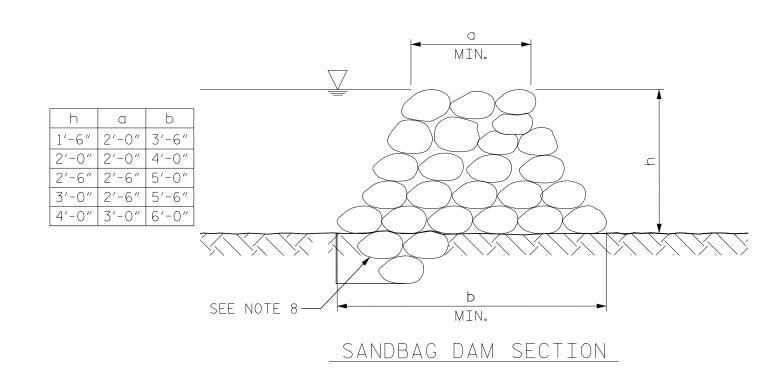

NOTE: SANDBAG DAM HEIGHT SHALL BE A MINIMUM OF 2'-6"UPSTREAM AND 1'-6"DOWNSTREAM. ADJUST FOR SITE CONDITIONS PRESENT DURING CONSTRUCTION.

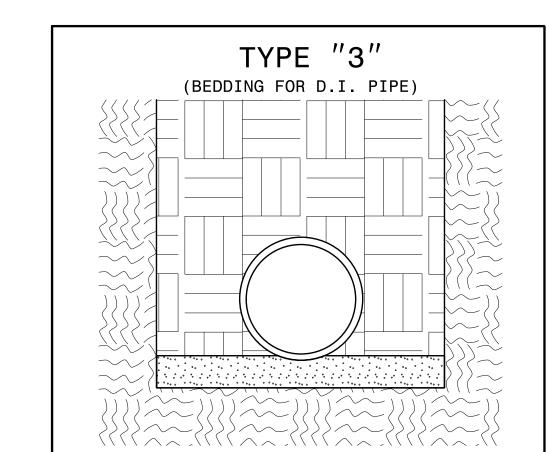

PIPE BEDDED IN 4" MINIMUM LOOSE SOIL. TRENCH BACKFILLED IN LOOSE 6" LAYERS COMPACTED TO TOP OF TRENCH USING LOCAL EXCAVATED MATERIAL, IF APPROVED BY THE ENGINEER, OR SELECT MATERIAL. ALL MATERIAL SHALL BE FREE OF ROCKS, FOREIGN MATERIAL, AND FROZEN EARTH. COMPACTION SHALL BE TO APPROX. 95% DENSITY IN ACCORDANCE WITH AASHTO T-99 AS MODIFIED BY THE DEPARTMENT OF TRANSPORTATION.

NOTES:


- 1. BASE FLOW OF STREAM WILL BE PUMPED AROUND WORK AREA AND RELEASED BACK INTO EXISTING STREAM BELOW THE WORK AREA ONTO CLASS B RIP RAP PAD. BYPASS PUMP SHALL UTILIZE A FLOATING INTAKE.
- 2. PUMP AROUND SYSTEM SHALL BE SUFFICIENT SIZE TO CARRY BASE STREAM FLOW.
- 3. SANDBAG MATERIAL: SANDBAG SHALL BE WOVEN POLYPROPYLENE, POLYETHYLENE OR POLYAMIDE FABRIC, MINIMUM UNIT WEIGHT FOUR OUNCES PER SQUARE YARD, MULLEN BURST STRENGTH EXCEEDING 300 PSI IN CONFORMANCE WITH THE REQUIREMENTS IN ASTM DESIGNATION D3786, AND ULTRAVIOLET STABILITY EXCEEDING 70% IN CONFORMANCE WITH THE REQUIREMENTS IN ASTM DESIGNATION D4355. USE OF BURLAP IS NOT ACCEPTABLE.
- 4. SAND FOR SANDBAGS SHALL BE A MINIMUM 110LB/CU.FT MATERIAL.
- 5. THE CONTRACTOR SHALL TAKE WHATEVER PRECAUTIONS NECESSARY TO PROTECT THE EXISTING WATERLINE FROM LEAKS OR DAMAGE DURING THE EXCAVATION AND CONSTRUCTION OF THE PROPOSED WATERLINE.
- 6. IT IS THE CONTRACTORS RESPONSIBILITY TO FOLLOW ALL OSHA AND STATE SAFETY REQUIREMENTS PERTAINING TO THIS EXCAVATION.
- 7. ADDITIONAL EROSION CONTROL DEVICES MAY NEED TO BE INSTALLED AS DIRECTED BY THE
- 8. FOR NON-ROCK CREEK BOTTOMS, KEY SANDBAGS ON UPSTREAM SIDE 1' INTO SOIL.
- 9. PERFORM CROSSING DURING ANTICIPATED DRY WEATHER ONLY. INSTALL PROPOSED UTILITY IN A DRY TRENCH.

DOCUMENT NOT CONSIDERED FINAL UNLESS ALL SIGNATURES COMPLETED

SHEET NO. PROJECT REFERENCE NO. UC-3C B-5813 DESIGNED BY: VHM Hand of Macon

E4AGDE421FZ44BA... VHMDRAWN BY: CHECKED BY: ASV APPROVED BY: XMD 029429 REVISED: NORTH CAROLINA DEPARTMENT OF TRANSPORTATION 2/26/2021 UTILITIES ENGINEERING SEC PHONE: (919)707-6690 UTILITY CONSTRUCTION FAX: (919)250-4151 PLANS ONLY

UTILITY CONSTRUCTION

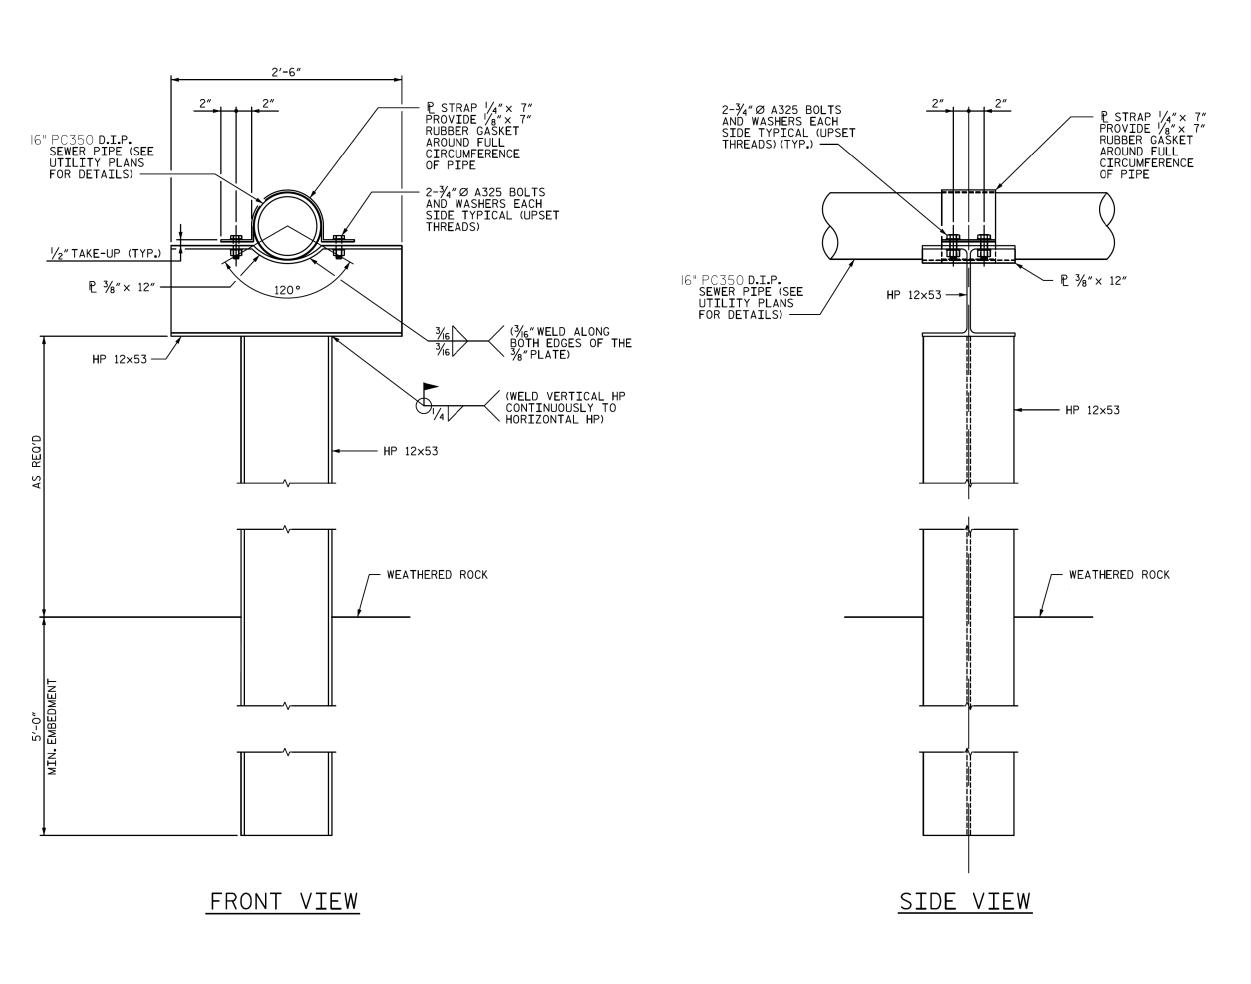

AERIAL SEWER SUPPORT

NOTES:

1. FOR AERIAL SEWER SUPPORT LOCATIONS, SEE SHEET UC-9.

2. STEEL H-PILES SHALL CONFORM TO THE REQUIREMENTS OF ASTM A992 GRADE 50.

3. ALL PILE LOCATIONS SHALL BE STAKED IN THE FIELD.

4. ALL WELDS SHALL BE IN ACCORDANCE WITH THE CURRENT AWS AND BE PREFORMED BY A CERTIFIED WELDER.

5. ALL STEEL MEMBERS AND STRAPS SHALL BE POWER TOOL CLEANED TO A MIN. OF SSPC-SP3 AND HOT-DIP GALVANIZED PER ASTM A123.

6.BOLTS AND WASHERS WILL BE HOT-DIP GALVANIZED PER ASTM A153.ALL WELDS SHALL BE GROUND AND COATED WITH 2 COATS OF A COLD APPLIED GALVANIZING PAINT.

7.BOLTS SHALL BE ASTM A325 WITH CORRESPONDING NUTS AND WASHERS.

8.ALL WELDS SHALL BE GROUND AND COATED WITH 2 COATS OF A COLD APPLIED GALVANIZING PAINT.

9. HOLES IN THE HP MEMBER FOR THE BOLTS AND POST-INSTALLED ANCHORS SHALL BE SIZED 1/16" LARGER THAT THE DIAMETER OF THE ITEM GOING THROUGH THE ITEM.

10. THE CONTRACTOR SHALL VERIFY THE SEWER PIPE ELEVATION AND ADJUST AERIAL SEWER SUPPORT ELEVATION AS NECESSARY TO MATCH SEWER PIPE ELEVATION.

FOUNDATION NOTES:

1. DRILLED-IN PILES ARE REQUIRED FOR THE AERIAL SEWER SUPPORTS.


2. EXCAVATE HOLES AT PILE LOCATIONS WITH A MINIMUM OF 5 FEET INTO WEATHERED ROCK.


3. FILL THE BOTTOM 5 FT OF THE HOLE WITH CONCRETE AND THE REST OF THE HOLE WITH CLASS II OR CLASS III SELECT MATERIAL THAT MEETS SECTION 1016 OF THE STANDARD SPECIFICATIONS.

4. FOR PILE EXCAVATION, SEE SECTION 450 OF THE STANDARD SPECIFICATIONS.

5. CONCRETE SHALL BE CLASS A CONCRETE PER THE NCDOT STANDARD SPECIFICATION FOR ROADS AND STRUCTURES.

ılıtıes\Engıneerıng\UC\Proj\Sheets\B5813_UC_UC3C.dgn aA

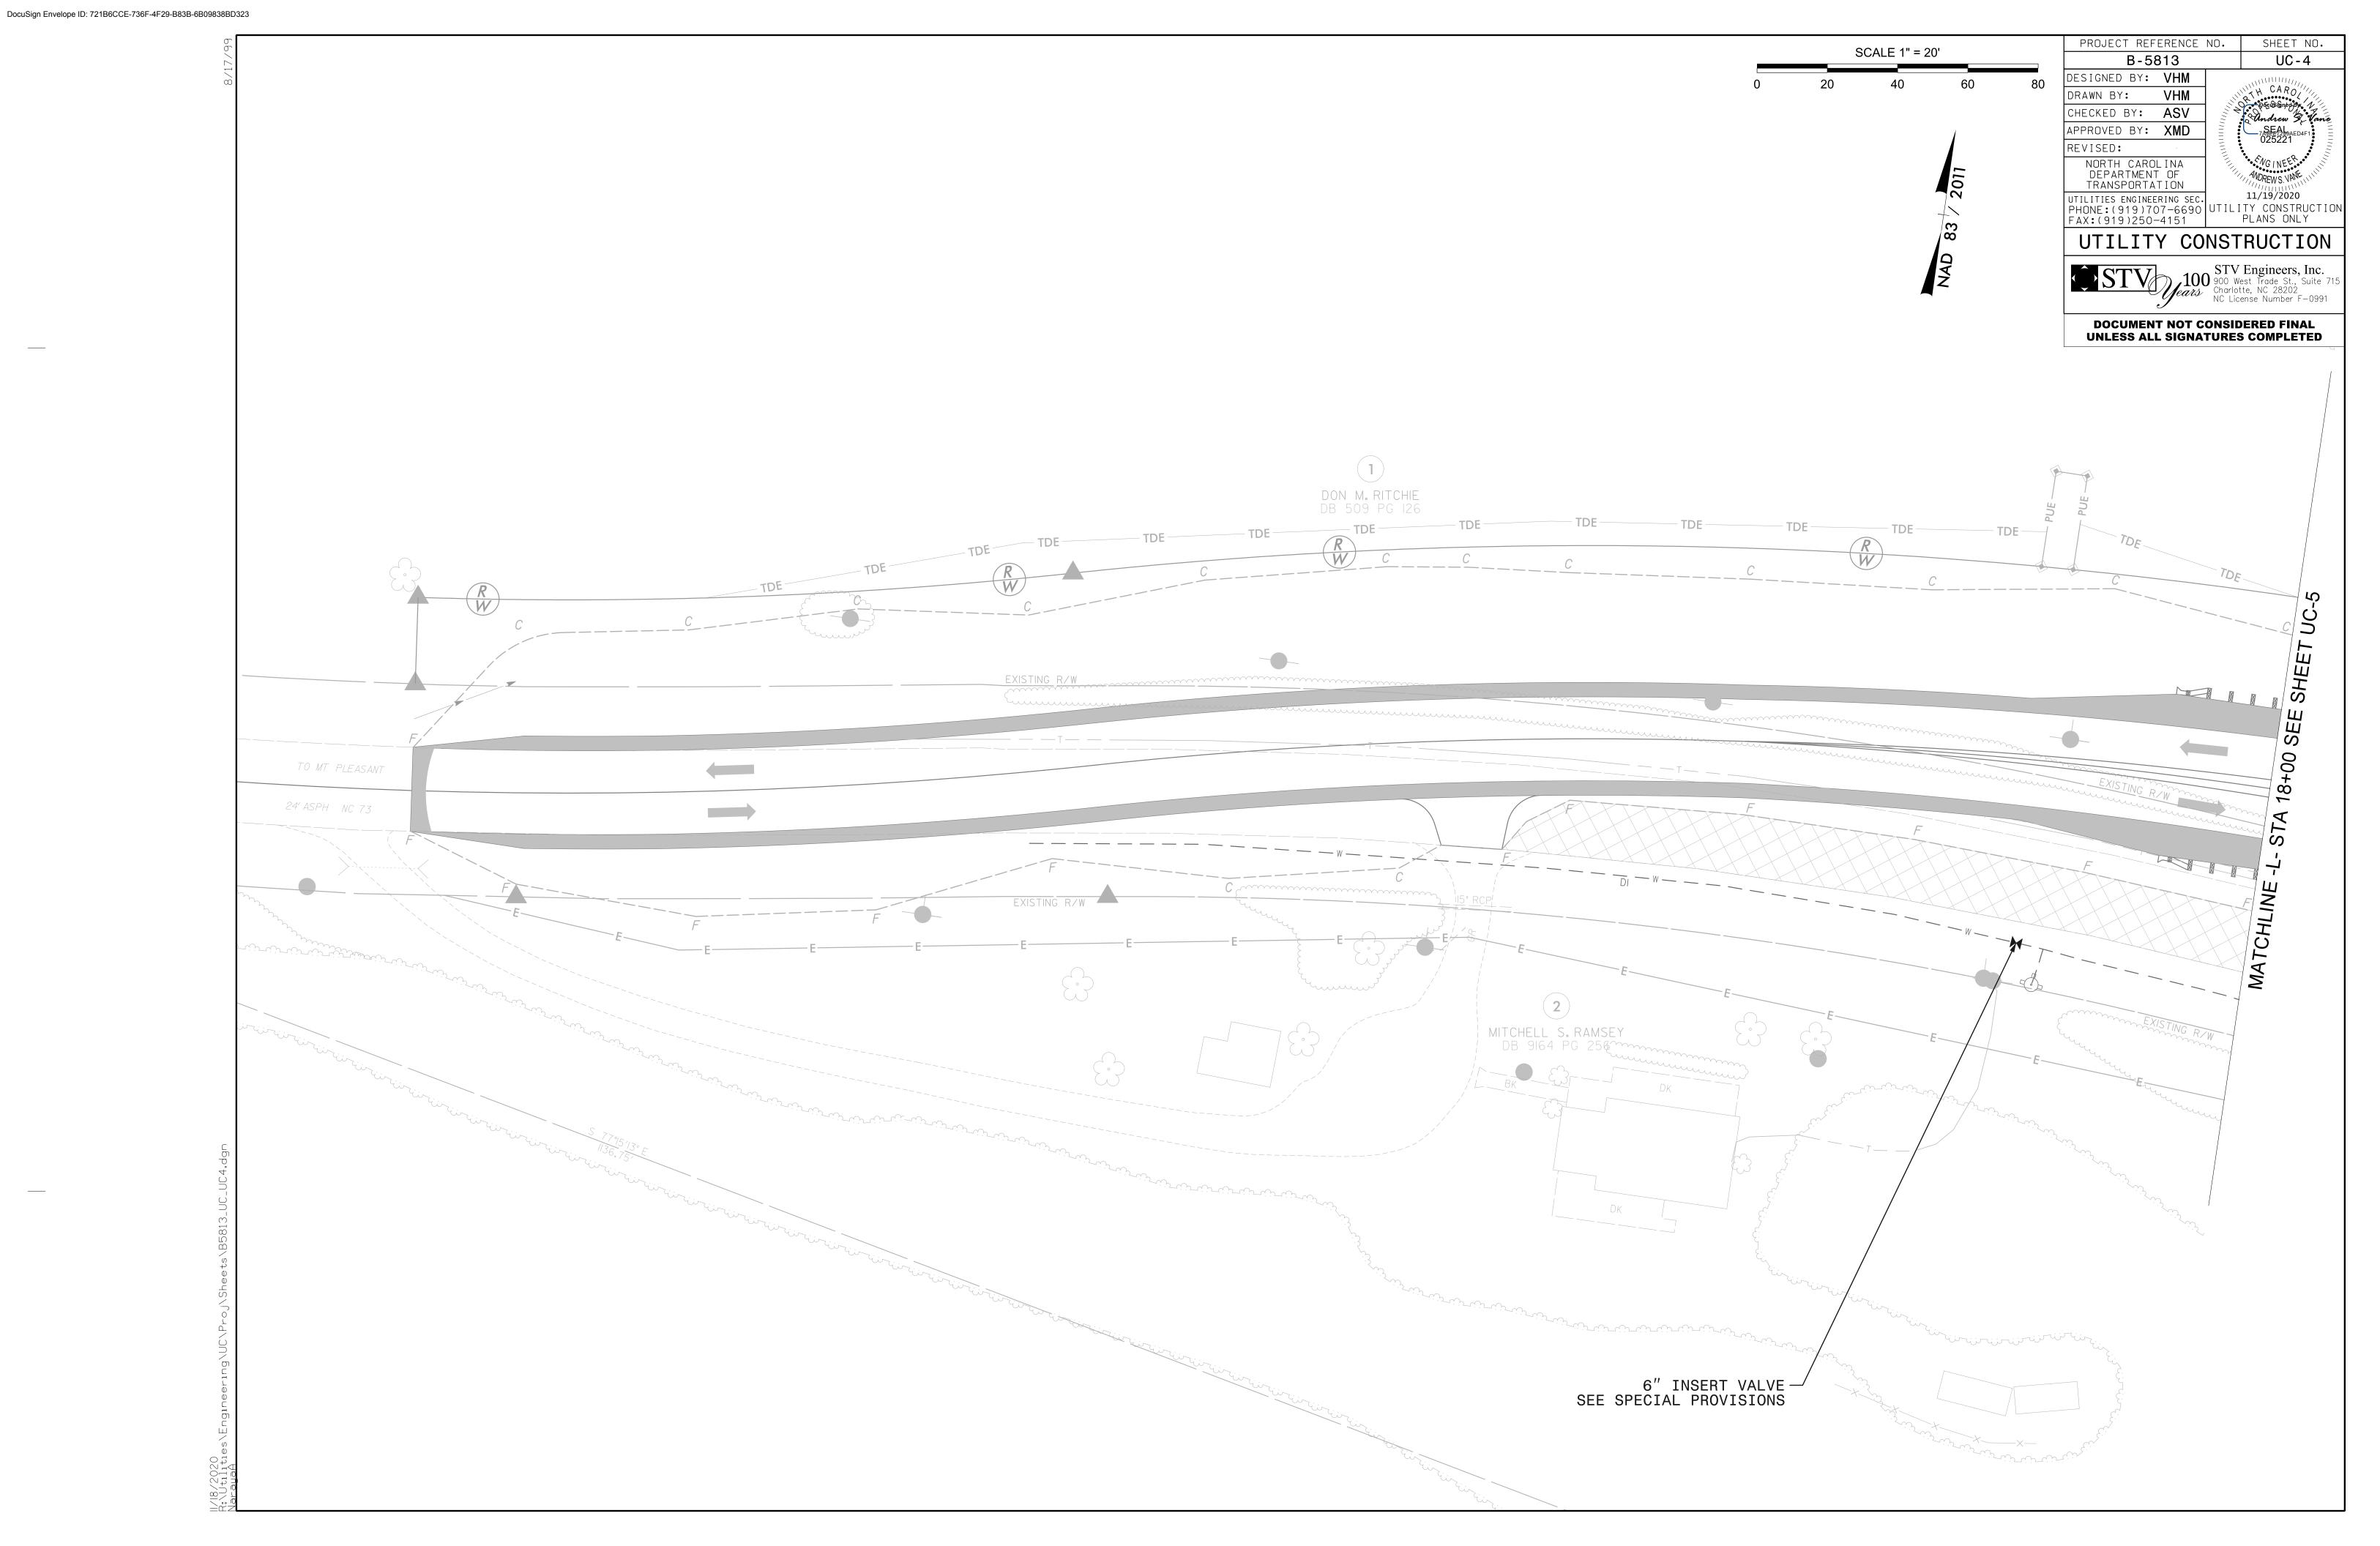

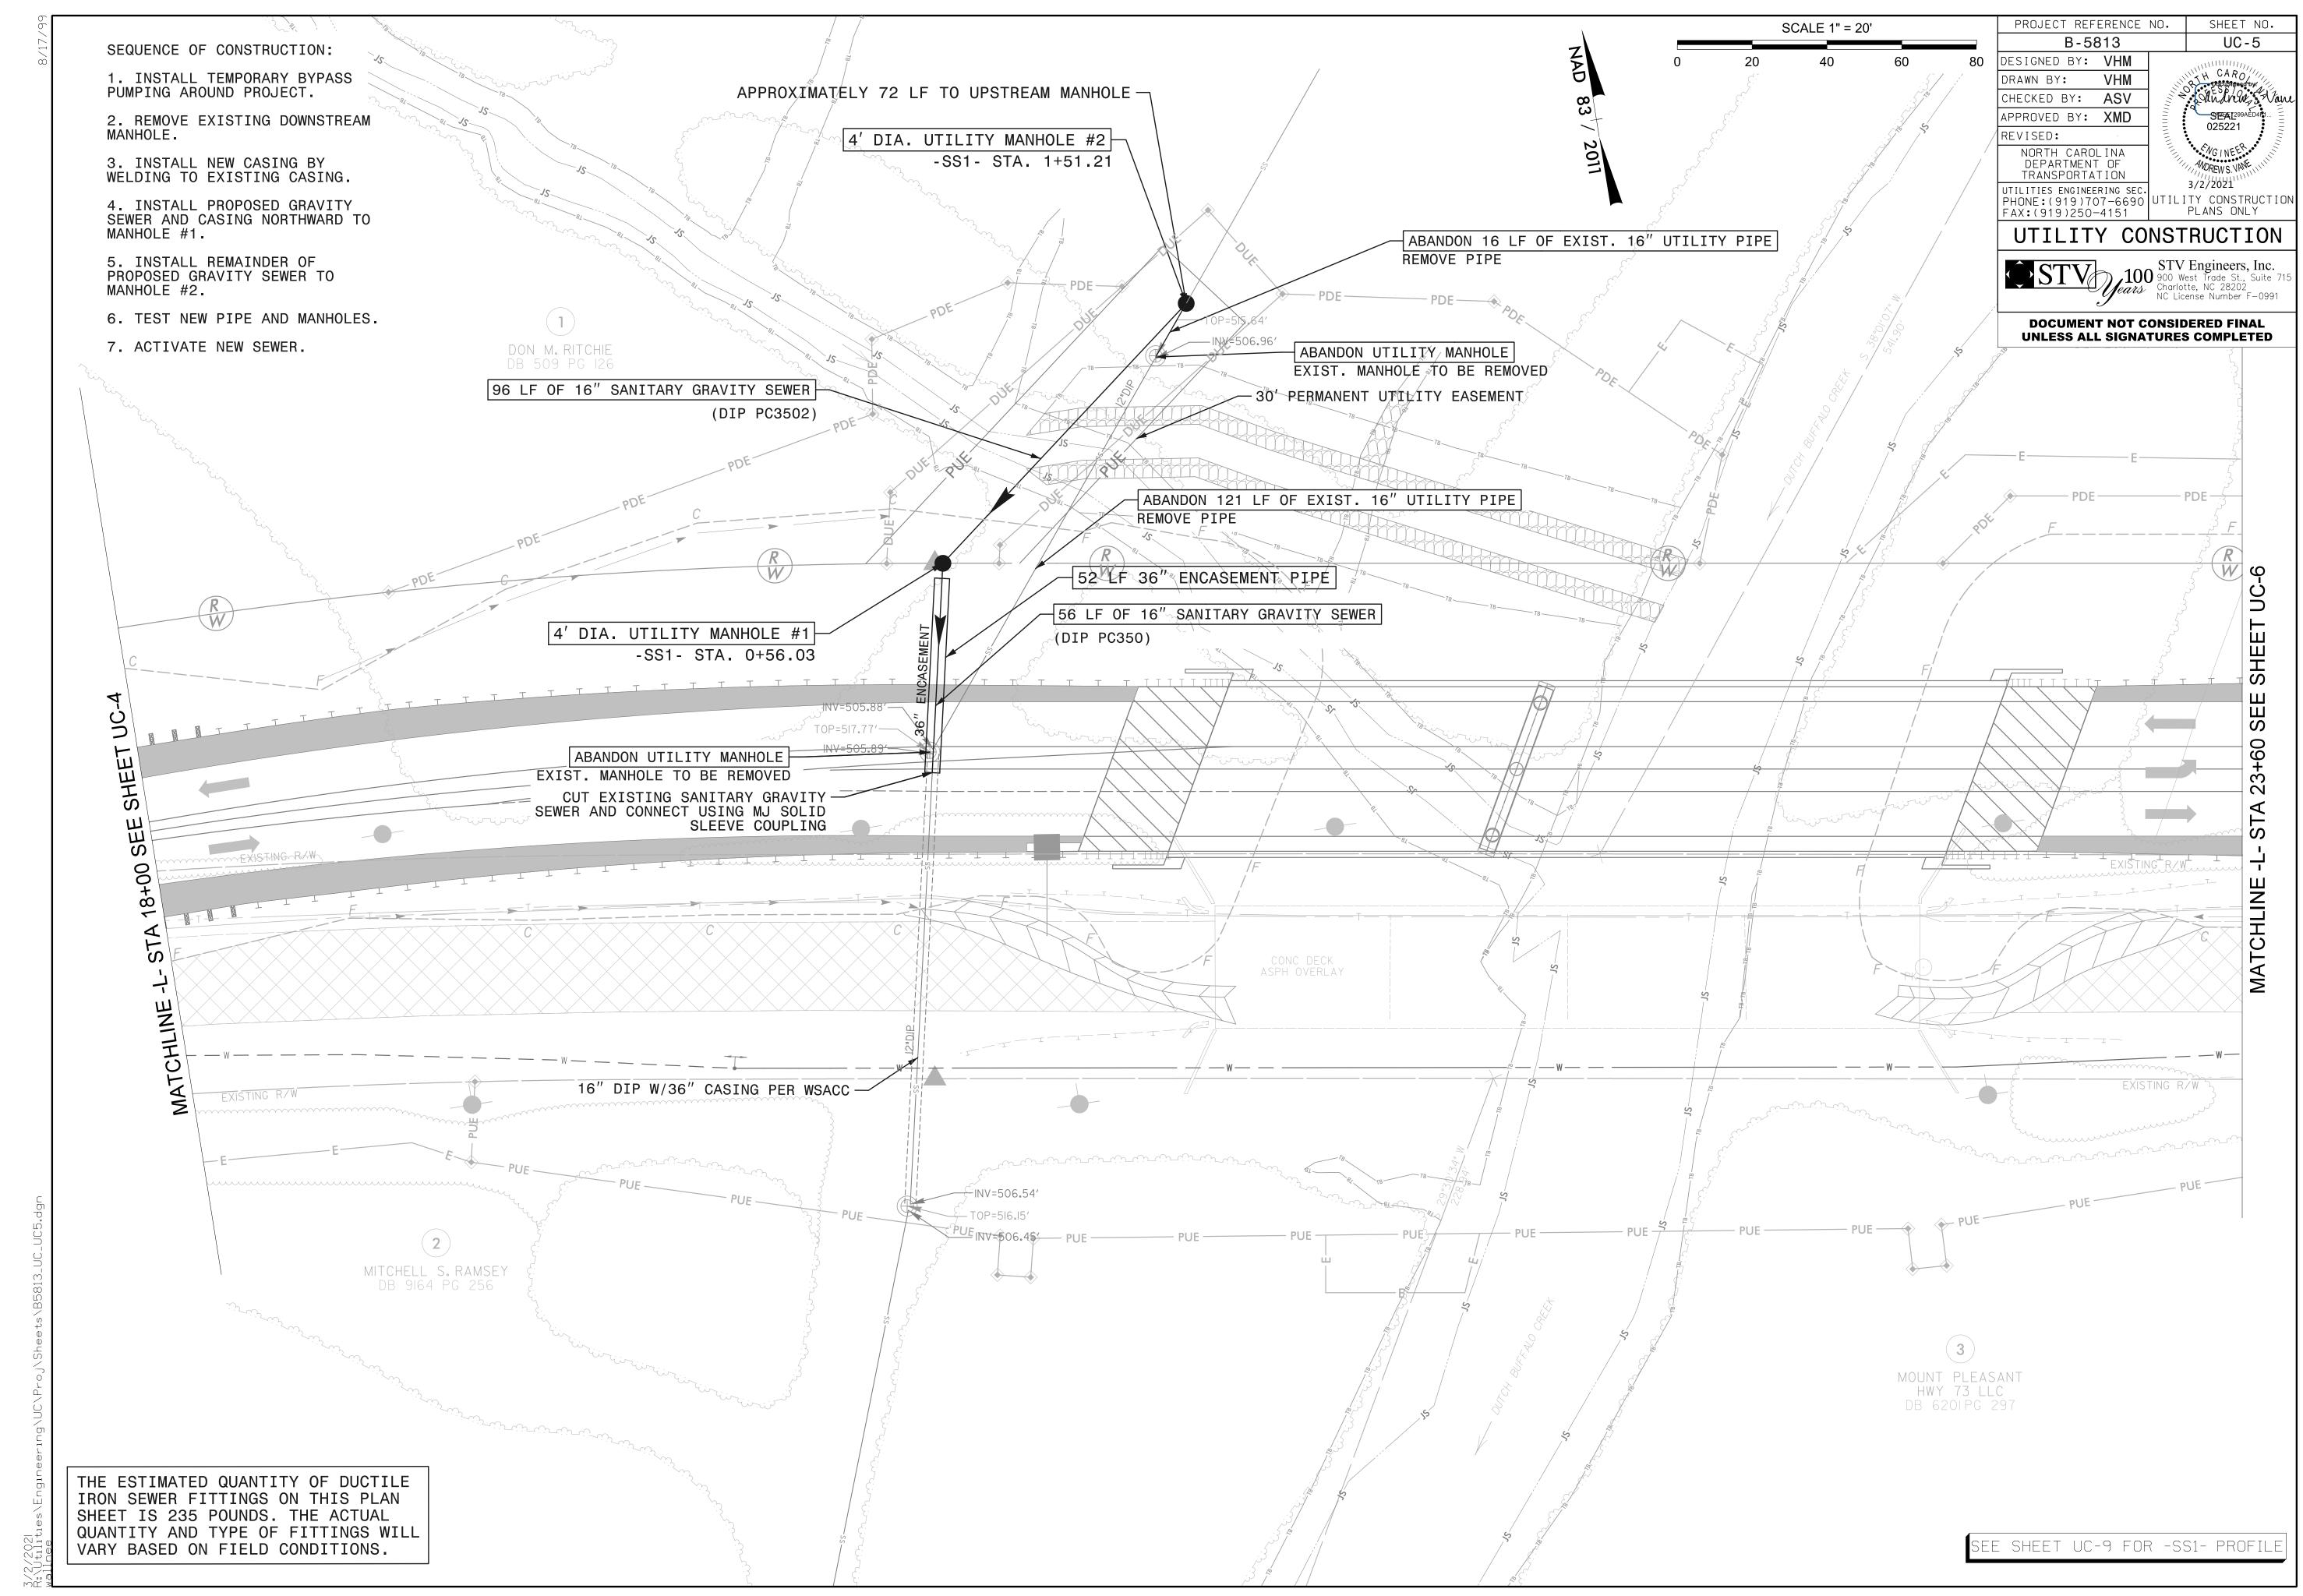

DocuSign Envelope ID: 721B6CCE-736F-4F29-B83B-6B09838BD323 PROJECT REFERENCE NO. SHEET NO. SCALE 1" = 20' UC-7 B-5813 NO WATER OR SEWER WORK ON THIS SHEET DESIGNED BY: VHM VHMDRAWN BY: CHECKED BY: ASV APPROVED BY: XMD REVISED: NORTH CAROLINA DEPARTMENT OF TRANSPORTATION UTILITIES ENGINEERING SEC. PHONE: (919)707-6690 UTILITY CONSTRUCTION FAX: (919)250-4151 PLANS ONLY UTILITY CONSTRUCTION STV Engineers, Inc. 900 West Trade St., Suite 71 Charlotte, NC 28202 NC License Number F-0991 DOCUMENT NOT CONSIDERED FINAL UNLESS ALL SIGNATURES COMPLETED ITAC 359 LLC DB 12023 PG 109 9 BARBRA H HARTLEY DB 7100 PG 291 FRANK A JAMES DB 497 PG 161

DocuSign Envelope ID: 721B6CCE-736F-4F29-B83B-6B09838BD323 PROJECT REFERENCE NO. SHEET NO. SCALE 1" = 20' UC-8 B-5813 DESIGNED BY: VHM NO WATER OR SEWER WORK ON THIS SHEET VHMDRAWN BY: CHECKED BY: ASV APPROVED BY: XMD REVISED: NORTH CAROLINA DEPARTMENT OF TRANSPORTATION UTILITIES ENGINEERING SEC. PHONE: (919)707-6690 UTILITY CONSTRUCTION FAX: (919)250-4151 PLANS ONLY UTILITY CONSTRUCTION STV Engineers, Inc.
900 West Trade St., Suite 71t
Charlotte, NC 28202
NC License Number F-0991 DOCUMENT NOT CONSIDERED FINAL UNLESS ALL SIGNATURES COMPLETED ITAC 359 LLC DB 12023 PG 109 APPROXIMATE LOCATION — EXISTING R/W 22' ASPH SR 2604 (DUTCH RD) EXISTING R/W N.C. STATE HIGHWAY COMMISSION DB 130 PG 165 DARIN H.BURNS DB 12881 PG 143

