# This electronic collection of documents is provided for the convenience of the user and is Not a Certified Document –

The documents contained herein were originally issued and sealed by the individuals whose names and license numbers appear on each page, on the dates appearing with their signature on that page.

This file or an individual page shall not be considered a certified document.

VICINITY MAP


# STATE OF NORTH CAROLINA DIVISION OF HIGHWAYS

| T.I.P. NO. | SHEET UC. |            |
|------------|-----------|------------|
| U-5745     |           | <b>-</b> I |

# UTILITIES CONSTRUCTION PLANS DURHAM COUNTY

LOCATION: ROUNDABOUT AT NC 751 (HOPE VALLEY ROAD) AND SR 1183 (UNIVERSITY DRIVE) IN DURHAM

TYPE OF WORK: WATER & SEWER RELOCATION

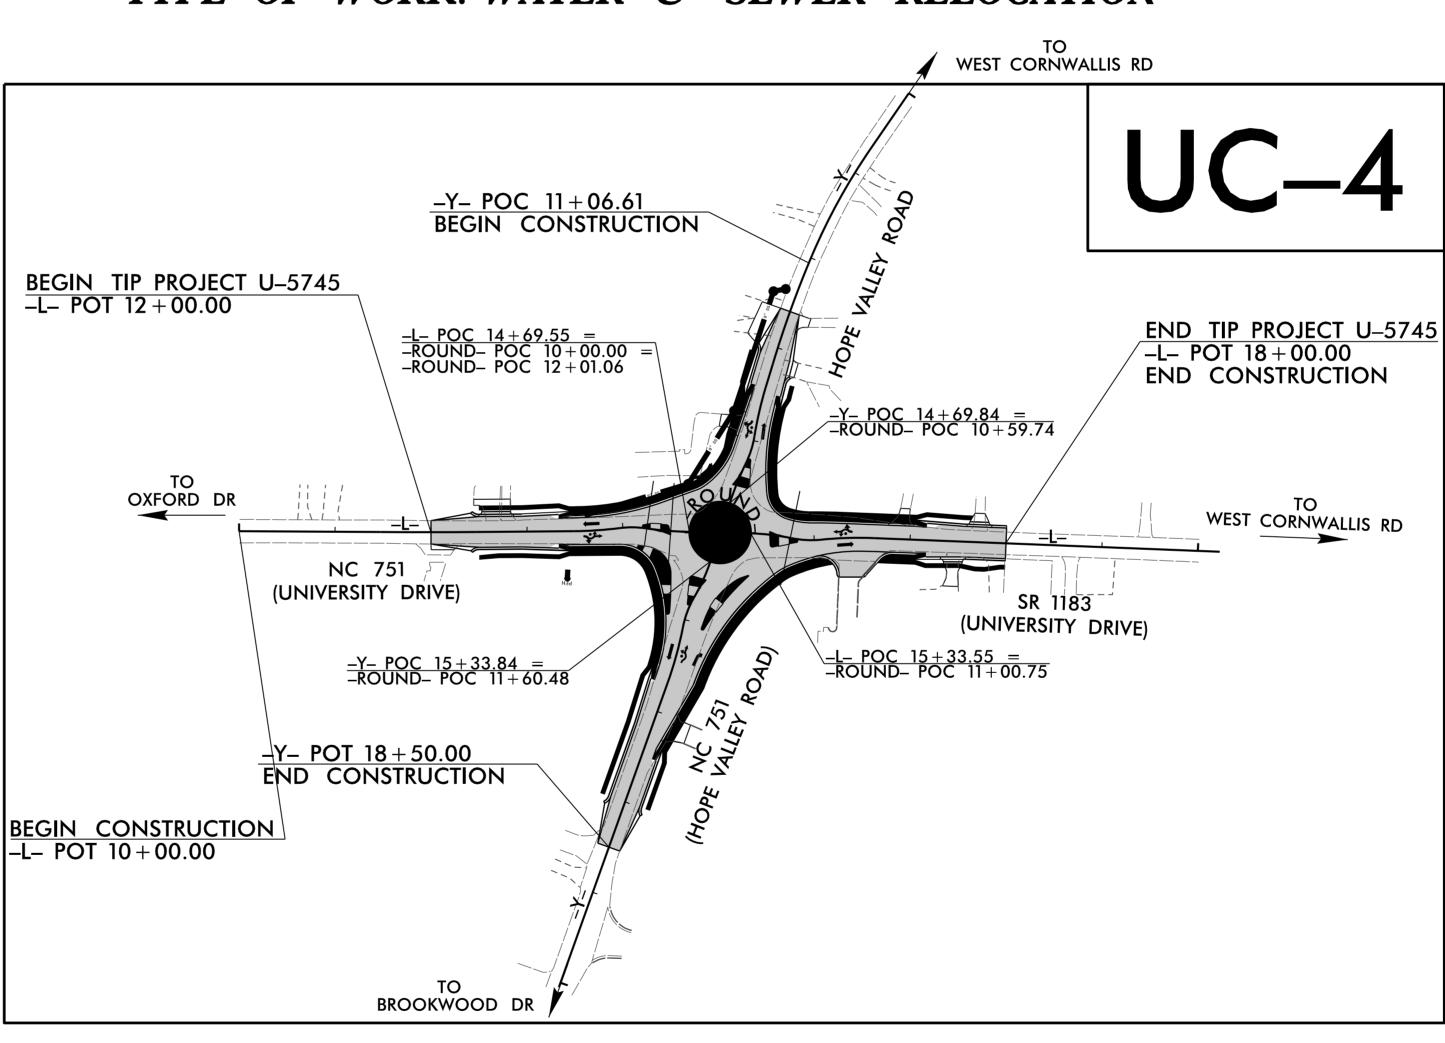



DOCUMENT NOT CONSIDERED FINAL UNTIL ALL SIGNATURES ARE COMPLETED

#### GRAPHIC SCALES **PLANS** *UC-2* 50 25 0 *UC-3 UC-3A* PROFILE (HORIZONTAL) *UC-4 UC-4A* **UC-**5 PROFILE (VERTICAL)

#### INDEX OF SHEETS

PROFILE SHEET

SHEET NO.: **DESCRIPTION:** TITLE SHEET **SYMBOLOGY** WATER DETAILS SEWER DETAILS WATER PLAN SHEET SEWER PLAN SHEET


#### WATER AND SEWER OWNER ON PROJECT

(A) WATER: CITY OF DURHAM (B) SANITARY SEWER: CITY OF DURHAM

# PREPARED IN THE OFFICE OF **ENGINEERING**

3220 GLEN ROYAL RD. RALEIGH, NC 27617 TELE 919.788.0224 FAX 919.788.0232 NC LICENSE #P-0189

ERIC TWEED, PE DESIGN ENGINEER MARY JO LEE, PE PROJECT ENGINEER BRIAN WILES, PE PROJECT MANAGER

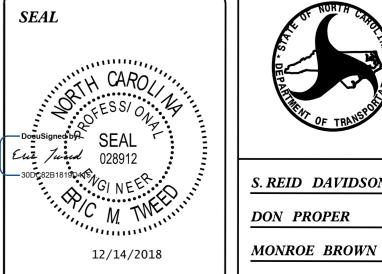



**DIVISION OF HIGHWAYS DIVISION** 5

2612 N. DUKE STREET DURHAM, NC 27704

S. REID DAVIDSON, PE DDC ENGINEER DON PROPER

**DIVISION UTILITY ENGINEER** DIVISION UTILITY COORDINATOR

## STATE OF NORTH CAROLINA DIVISION OF HIGHWAYS

# UTILITIES PLAN SHEET SYMBOLS

Permanent Utility Easement

#### PROPOSED WATER SYMBOLS

# Water Line (Sized as Shown) 11½ Degree Bend 22½ Degree Bend 45 Degree Bend 90 Degree Bend Reducer Gate Valve Butterfly Valve Tapping Valve Line Stop Line Stop with Bypass Blow Off Fire Hydrant Relocate Fire Hydrant Remove Fire Hydrant Water Meter Relocate Water Meter Remove Water Meter Water Pump Station RPZ Backflow Preventer DCV Backflow Preventer Relocate RPZ Backflow Preventer Relocate DCV Backflow Preventer

### PROPOSED SEWER SYMBOLS

| Gravity Sewer Line        | <b>1</b> 2″ | 22    |  |
|---------------------------|-------------|-------|--|
| (Sized as Shown)          | 12          | 33    |  |
| Force Main Sewer Line     | <b>1</b> 2″ | FSS - |  |
| (Sized as Shown)          |             |       |  |
| Manhole                   |             |       |  |
| (Sized per Note)          |             |       |  |
| Sewer Pump Station PS(SS) |             |       |  |

#### PROPOSED MISCELLANOUS UTILITIES SYMBOLS

| Power Pole ···································· | Thrust Block      |
|---|-------------------|
| Telephone Pole                                  | Air Release Valve |
| Joint Use Pole ───── <del>-</del>               | Utility Vault     |
| Telephone Pedestal                              | Concrete Pier     |
| Utility Line by Others(Type as Shown)           | Steel Pier        |
| Trenchless Installation                         | Plan Note         |
| Encasement by Open Cut                          | Pay Item Note     |
| Encasement                                      | PAY ITEM          |
|   |                   |

#### EXISTING UTILITIES SYMBOLS

| Power Pole ····································          | *Underground Power Line                                    |
|--|--|
| Telephone Pole   | *Underground Telephone Cable                               |
| Joint Use Pole   | *Underground Telephone Conduit                             |
| Utility Pole   | *Underground Fiber Optics Telephone Cable                  |
| Utility Pole with Base                                   | *Underground TV Cable                                      |
| H-Frame Pole   | *Underground Fiber Optics TV Cable                         |
| Power Transmission Line Tower                            | *Underground Gas Pipeline                                  |
| Water Manhole ····································       | Aboveground Gas Pipeline                                   |
| Power Manhole ····· ®                                    | *Underground Water Line                                    |
| Telephone Manhole ····································   | Aboveground Water Line                                     |
| Sanitary Sewer Manhole ®                                 | *Underground Gravity Sanitary Sewer Line ——ss———           |
| Hand Hole for Cable ···································· | Aboveground Gravity Sanitary Sewer Line A/G Sanitary Sewer |
| Power Transformer  | *Underground SS Forced Main Line                           |
| Telephone Pedestal                                       | Underground Unknown Utility Line                           |
| CATV Pedestal  | SUE Test Hole  |
| Gas Valve ····································           | Water Meter  |
| Gas Meter 🖖  | Water Valve ····································           |
| ocated Miscellaneous Utility Object o                    | Fire Hydrant   |
| Abandoned According to Utility Records AATUR             | Sanitary Sewer Cleanout ⊕                                  |
| End of Information E.O.I.                                |  |
|  | *For Existing Utilities                                    |
| Temporary Construction Easement                          | Utility Line Drawn from Record                             |
| Permanent Utility Fasement                               | (Type as Shown)  |

Designated Utility Line (Type as Shown)

# PROJECT TYPICAL DETAILS

**ELEVATION** 

"Y" BAR

12

SCALE:

NTS

DETAIL NO.

W-8.1

THRUST COLLAR REINFORCING "X" BAR

BAR LENGTH

REBAR SIZE

NUMBER REQ'D

DEPARTMENT OF PUBLIC WORKS

**ENGINEERING** 

3220 GLEN ROYAL RD. RALEIGH, NC 27617 TELE 919.788.0224 FAX 919.788.0232 NC LICENSE #P-0189

PROJECT REFERENCE NO. SHEET NO. U-5745 ESIGNED BY: RAWN BY: HECKED BY: PPROVED BY: Tiered 028912 REVISED: NORTH CAROLINA DEPARTMENT OF TRANSPORTATION ITILITIES ENGINEERING SEC PHONE: (919)707-6690 UTILITY CONSTRUCTION

PLANS ONLY

ABC STONE COMPACTED TO
100% STD. PROCTOR OR HB
BASE COMPACTED TO 100%
STD. PROCTOR. OR AS
DIRECTED BY THE ENGINEER.


SCALE: NTS

DETAIL NO.

SS-8.0

UNTIL ALL SIGNATURES ARE COMPLETED FAX: (919)250-4151

UTILITY CONSTRUCTION

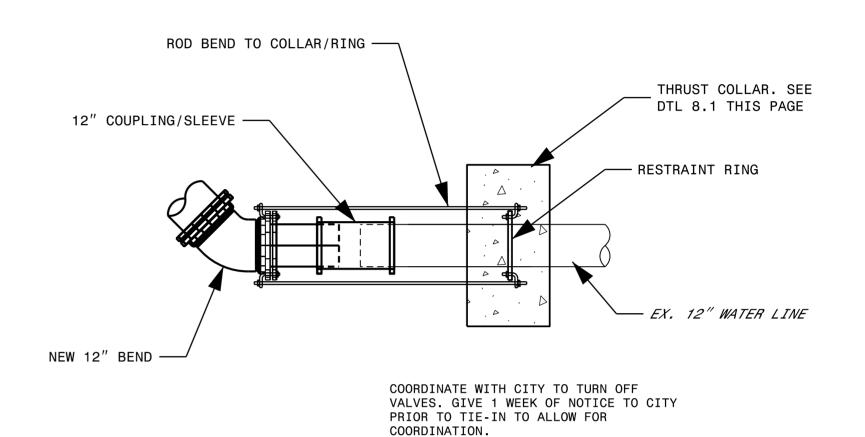

DOCUMENT NOT CONSIDERED FINAL

CONCRETE THRUST COLLAR SHALL HAVE 24 HRS TO SET UP BEFORE CUTTING THE EXISTING LINE FOR THE TIE-IN.

SEE CITY OF DURHAM STANDARD CONSTRUCTION DETAILS FOR TRENCHES AND PIPE BEDDING.

BACKFILL COMPACTED IN 6" LIFTS TO 95% — STD. PROCTOR, OR

#57 STONE ABOVE-AND UNDER PIPE

REVISION DATE

FLOWABLE FILL TRENCH-CUT

STREET, WATER, SEWER AND


STORMWATER

TRENCH CUT INSTALLATION


CITY OF DURHAM, NORTH CAROLINA DEPARTMENT OF PUBLIC WORKS


FLOWABLE FILL AS DIRECTED.


TYPICAL TIE-IN DETAIL ON 12" WL NO SCALE

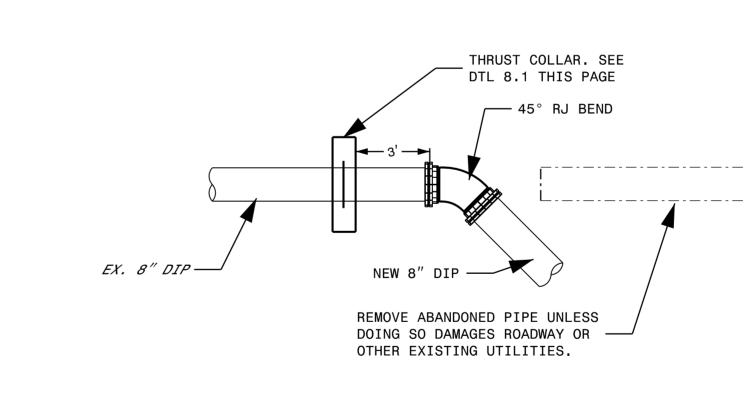


TIE-IN DETAIL STA 40+50 NO SCALE

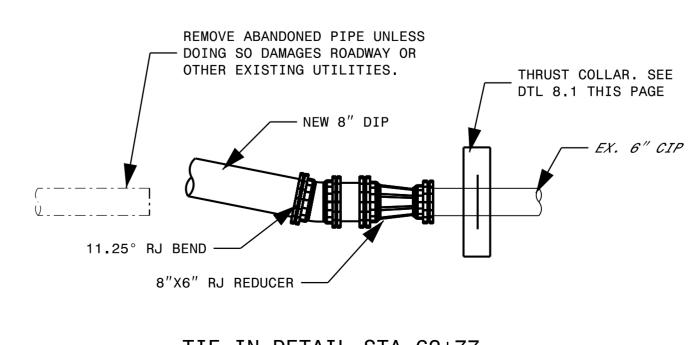

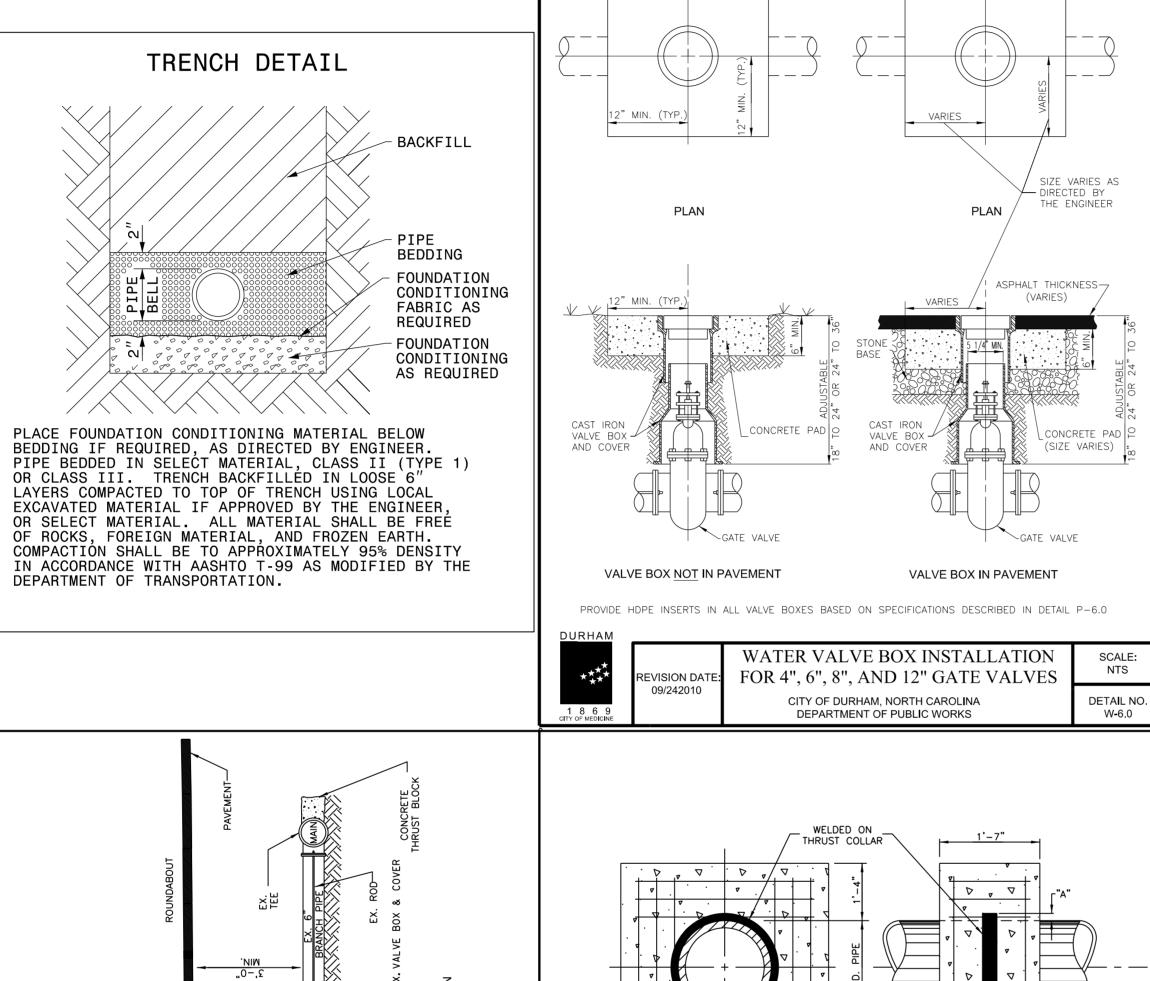

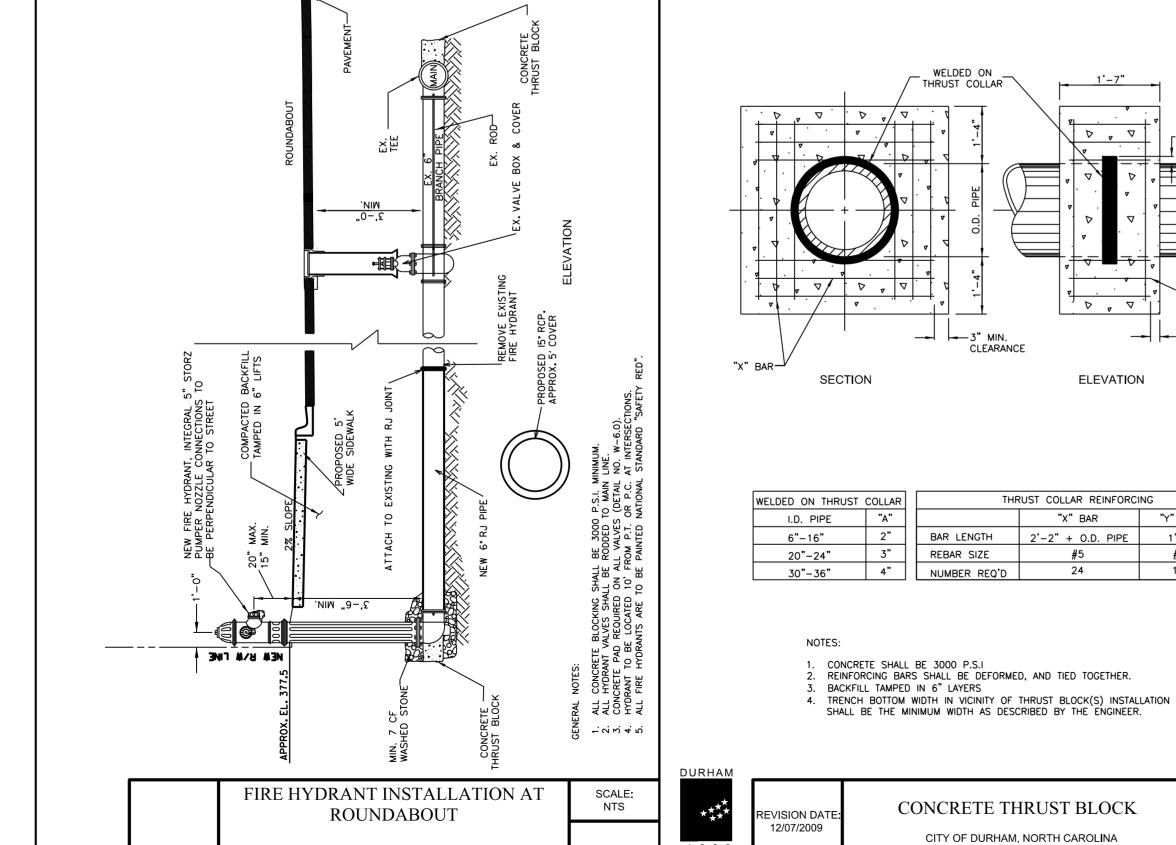

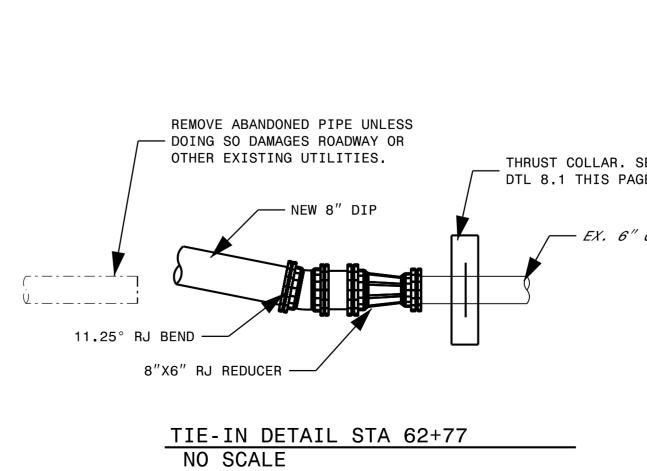

- 1. All precast concrete manholes shall conform to the latest revision of ASTM C478.
- 2. Concrete shall be 4000 psi at 28 days minimum. 3. Steel reinforcement shall be grade 60 billet steel conforming ot the latest revision of ASTM A185 for wall reinforcement, and the latest revision of ASTM A615 for the base reinforcement.
- 4. Standard joints shall be sealed with putty type plastic cement per Fed. Spec SS C153 or an O-ring type joint conforming to the latest revision of ASTM C443.
- 5. Manhole inlets and outlets shall be cast in place flexible rubber sleeve and boots with stainless steel expanding rings per the latest revision of ASTM C923.
- 6. Inverts to be constructed of precast concrete or brick witha a concrete bench (Detail 732.02)
- 7. All services entering manhole shall tie into the manhole at the bench.
- 8. Pipes entering MH will be grouted inside and out. 9. See detail 732.01 for typical invert shaping.
- 10. Lubricate the following: Pipe exterior, boot interior, boot exterior. s.s. bands (Top and bottom).

## SEWER DETAILS



DOCUMENT NOT CONSIDERED FINAL UNTIL ALL SIGNATURES ARE COMPLETED

TRANSPORTATION TILITIES ENGINEERING SEG PHONE: (919)707-6690 UTILITY CONSTRUCTION PLANS ONLY FAX: (919)250-4151

#### UTILITY CONSTRUCTION

