

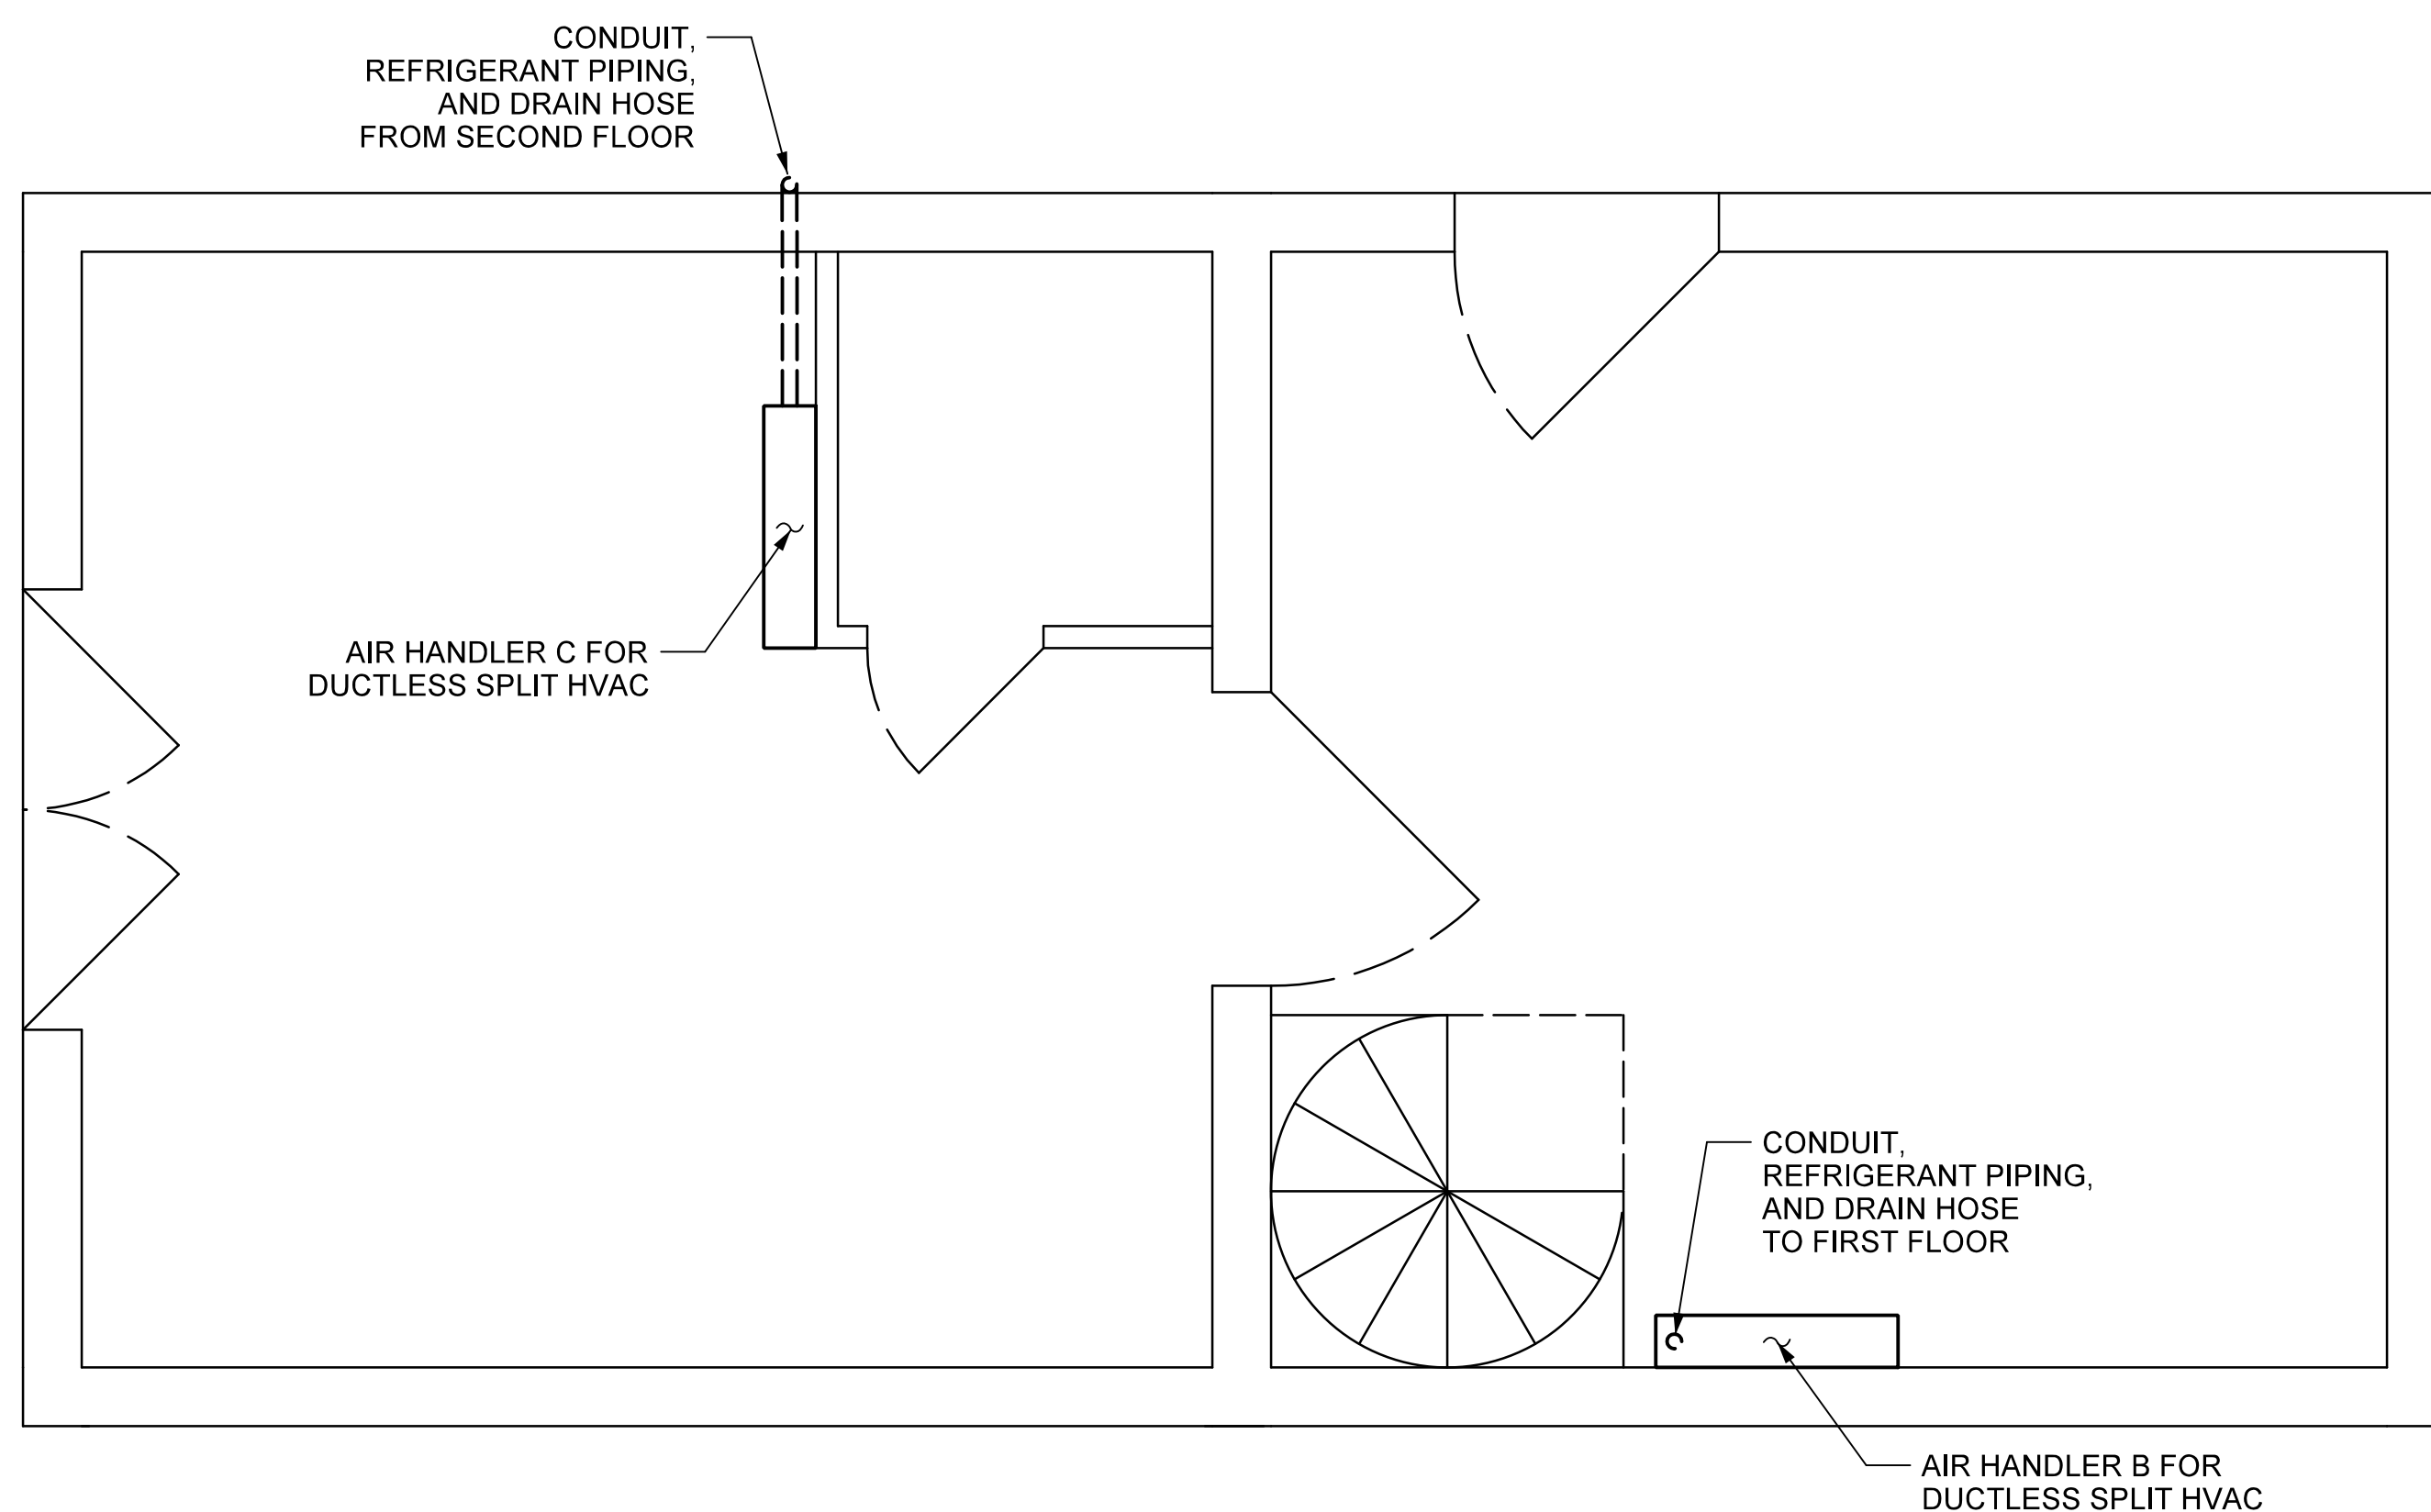


SECOND FLOOR LAYOUT
SCALE: 1/2" = 1'-0"

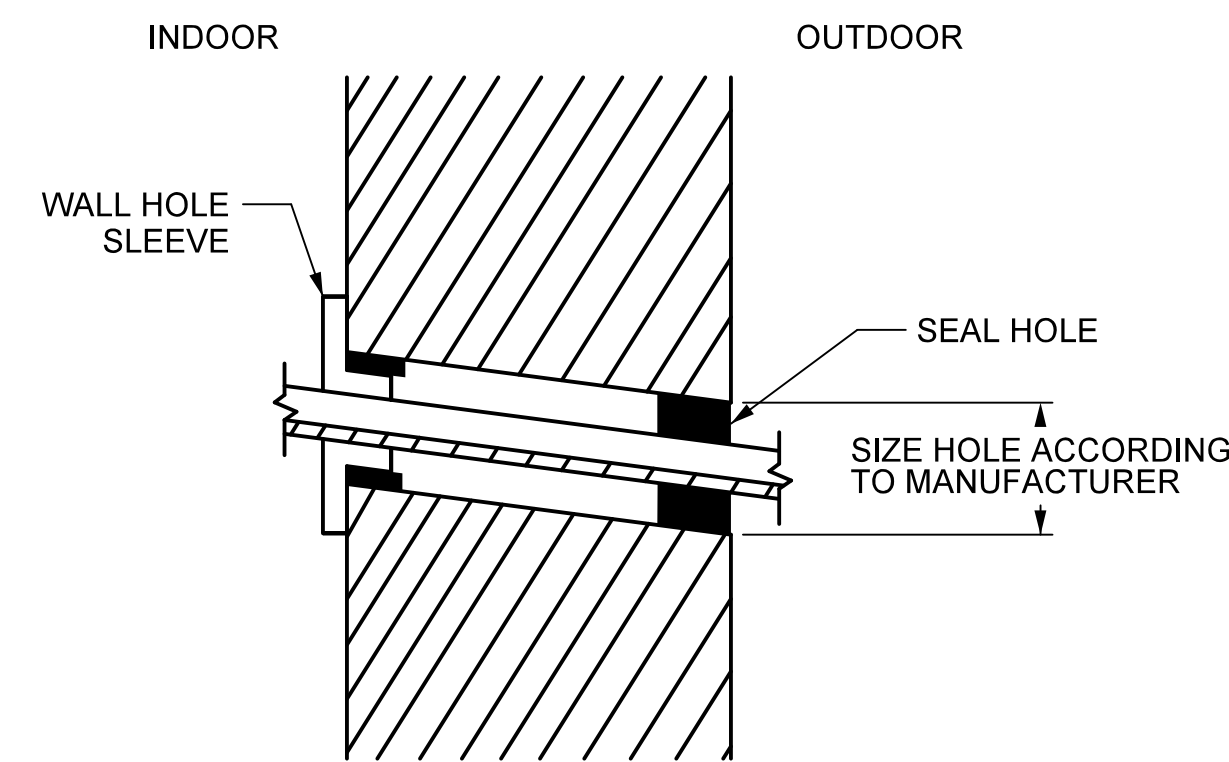

FIRST FLOOR LAYOUT
SCALE: 1/2" = 1'-0"

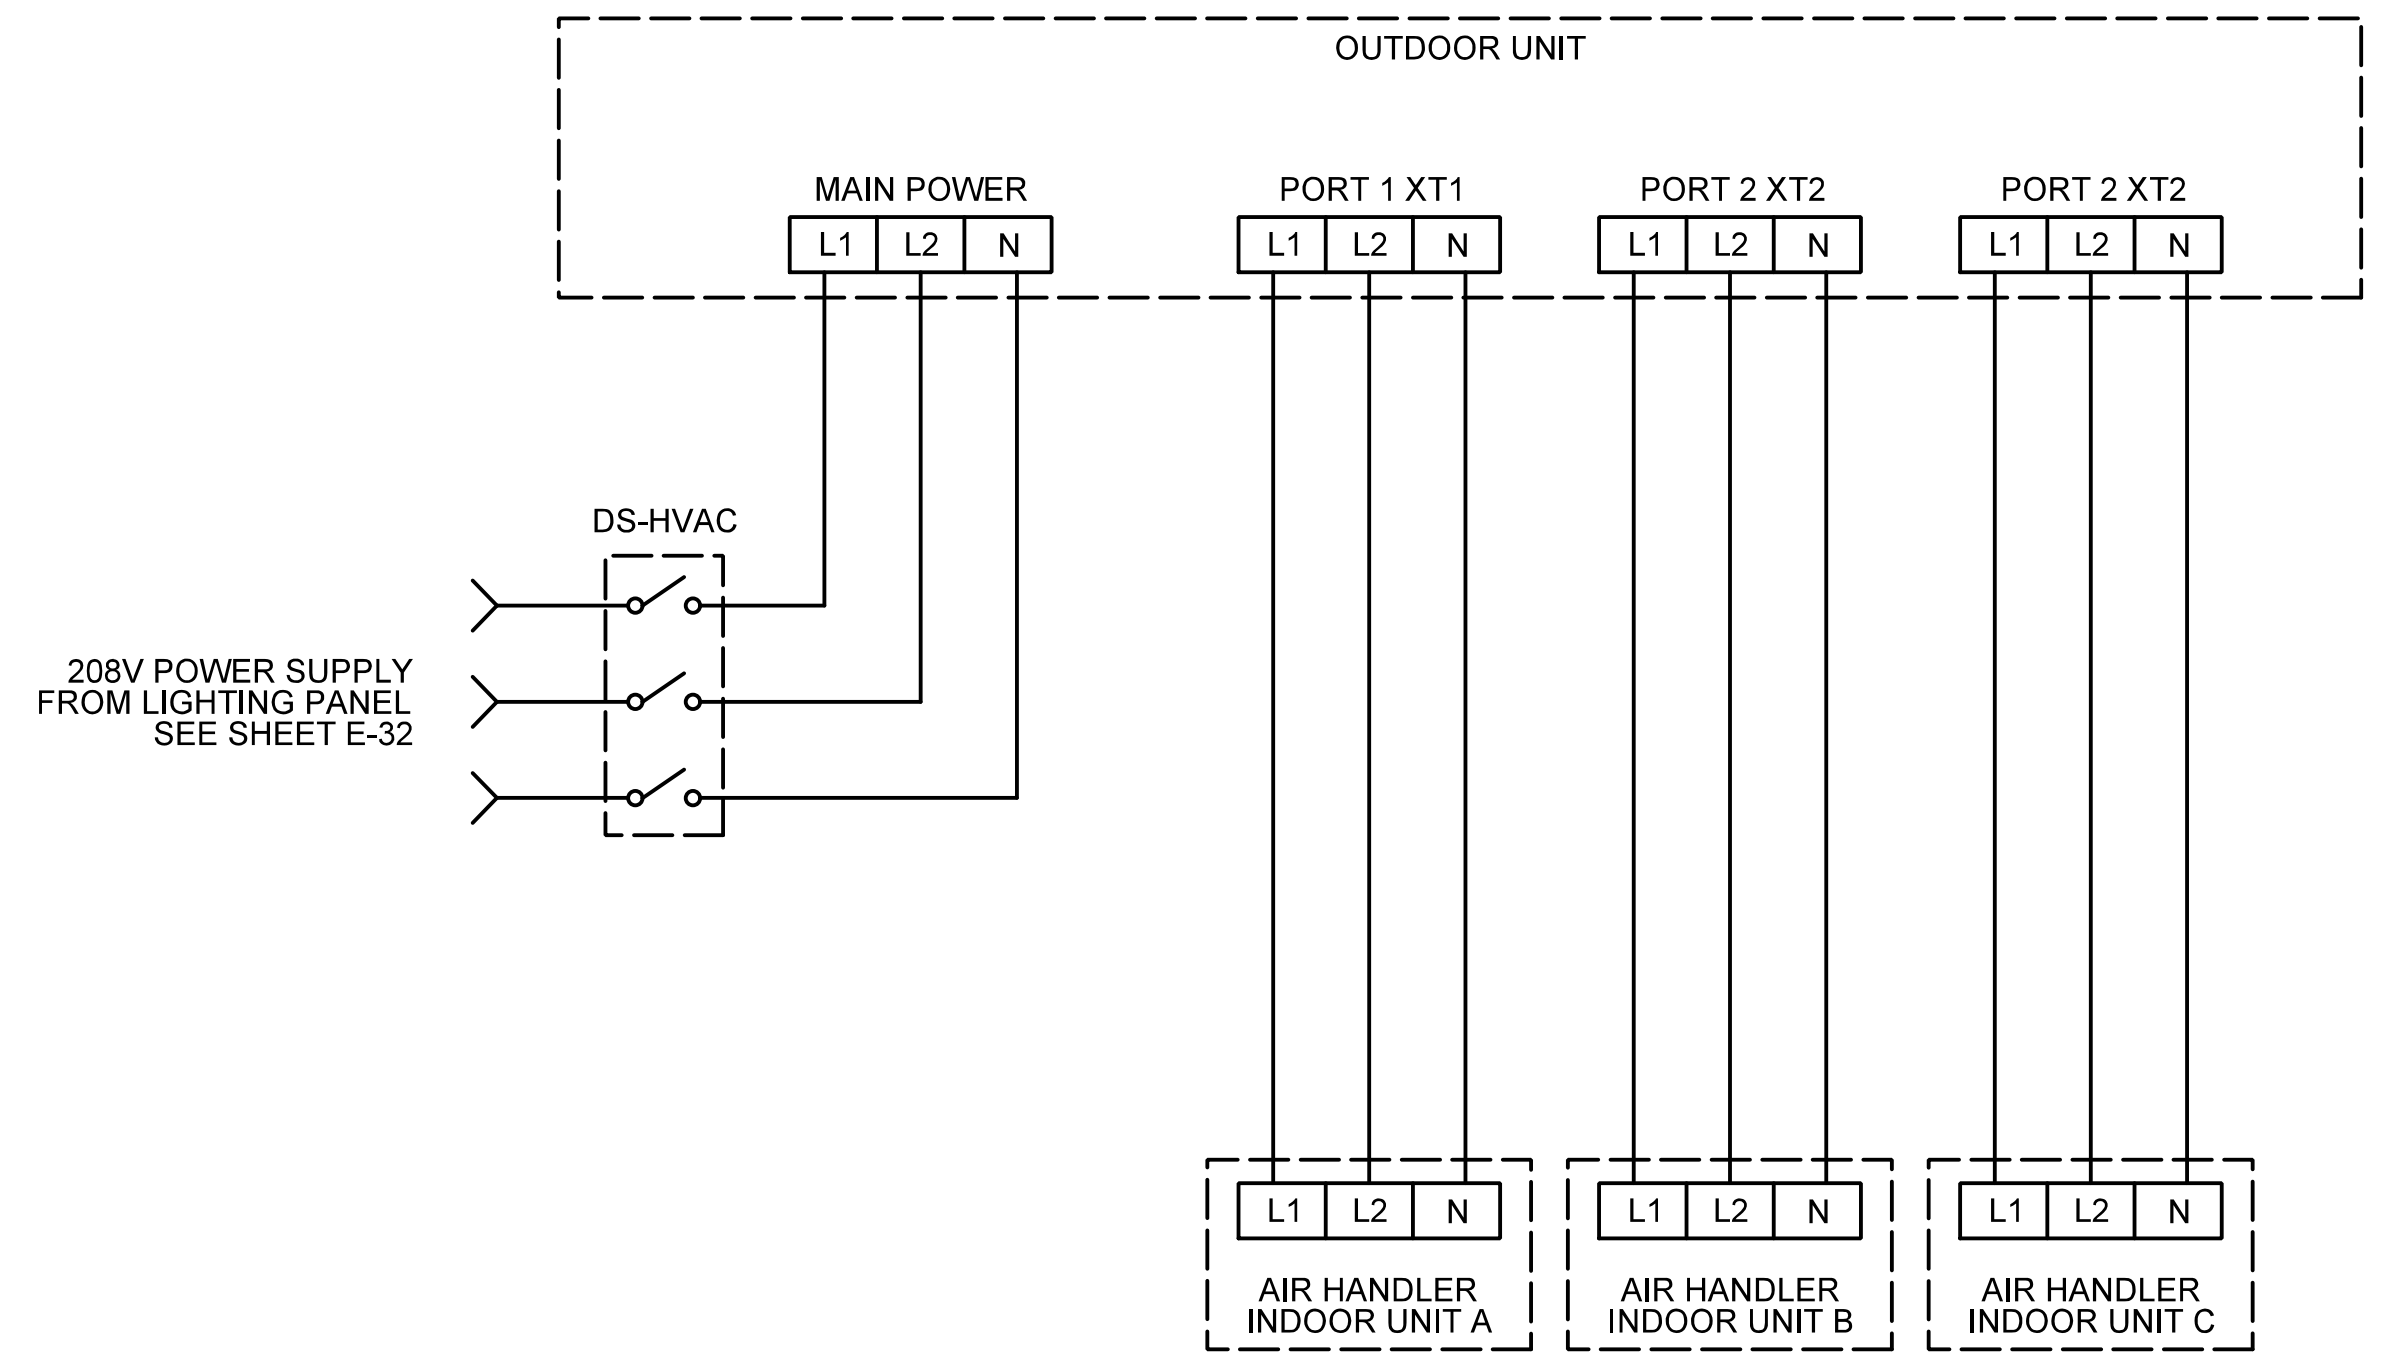

WALL HOLE DIAGRAM
SCALE: 3" = 1'-0"

NOTES:

1. THE HVAC SYSTEM SHALL BE A GREE+MULTIZONE 24,000 BTU 2 TON MINI SPLIT AIR CONDITIONER OR AN APPROVED EQUAL.
2. INSTALLATION SHALL BE PERFORMED BY A STATE LICENSED OR CERTIFIED HVAC CONTRACTOR IN ORDER FOR THE MANUFACTURER'S WARRANTY TO APPLY.
3. CONTRACTOR SHALL MODIFY LOCATION OF EQUIPMENT SHOWN AS REQUIRED FOR PROPER INSTALLATION.
4. COORDINATE ALL HOLES AND PENETRATIONS SHOWN WITH SHEET A-4 FOR ARCHITECTURAL RENOVATIONS.
5. PENETRATE WALL AT THE LOCATIONS SHOWN ON THE PLANS FOLLOWING THE TYPICAL WALL HOLE DIAGRAM. PROPERLY ADJUST THE HOLE LOCATION TO ACCOMMODATE THE AIR HANDLER UNITS. THE WALL SHALL BE CUT WITH A 5° TO 10° DOWNWARD SLANT TOWARDS THE OUTDOORS.

PROJECT NO. B-5936
TYRRELL COUNTY
BRIDGE NO: 7

STATE OF NORTH CAROLINA
DEPARTMENT OF TRANSPORTATION
RALEIGH

**CONTROL HOUSE
HVAC LAYOUT**

**ALLIGATOR RIVER
SWING SPAN**

REVISIONS

NO	BY	DATE	NO	BY	DATE
1			3		
2			4		

SHEET NO.
E-42

TOTAL SHEETS
51

DRAWN BY: _QIV DATE: 8/8/2016
CHECKED BY: _MJT DATE: 8/8/2016
DESIGN ENGINEER OF RECORD: _CHS DATE: 8/8/2016

DWG NUMBER 58	TOTAL DWGS 90	DOCUMENT NOT CONSIDERED FINAL UNLESS ALL SIGNATURES COMPLETED
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