


# TEST SITE PLAN

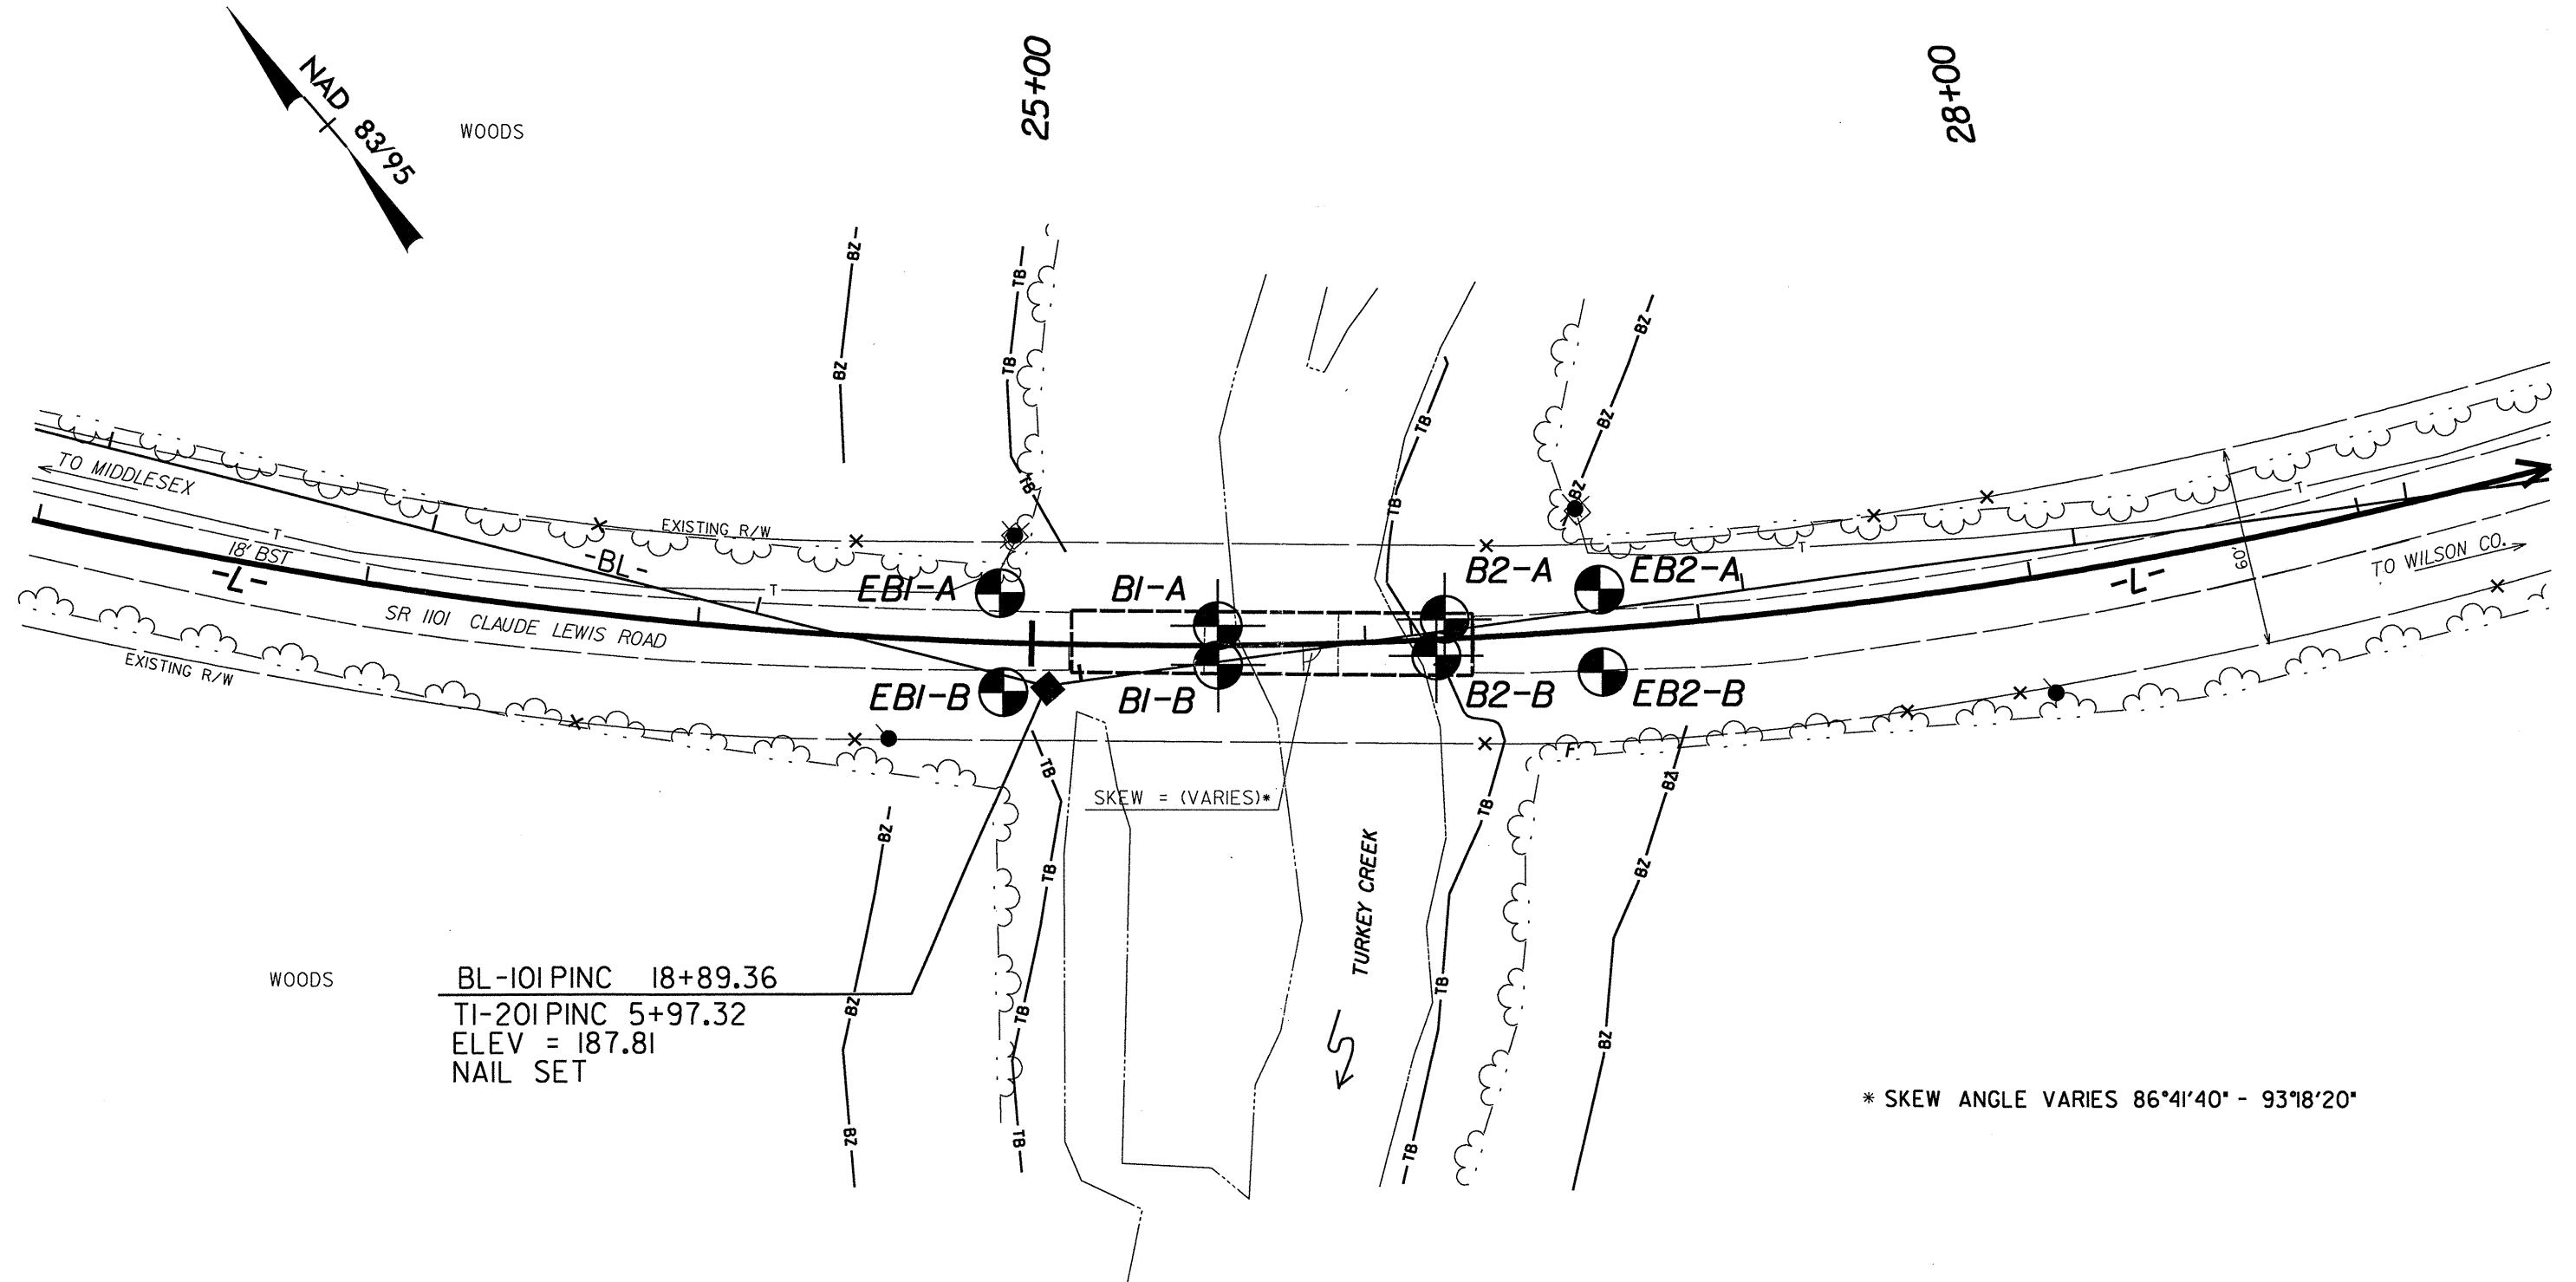



WOODS

BL-101 PINC 18+89.36  
 TI-201 PINC 5+97.32  
 ELEV = 187.81  
 NAIL SET

SKEW = (VARIES)\*

\* SKEW ANGLE VARIES 86°41'40" - 93°18'20"

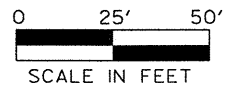

 <p>SINCE 1881</p> <p><b>FROEHLING &amp; ROBERTSON, INC.</b>                  GEOTECHNICAL • ENVIRONMENTAL • MATERIALS                  ENGINEERS • LABORATORIES                  "OVER ONE HUNDRED YEARS OF SERVICE"                  310 Hubert Street Raleigh, NC 27603                  (919) 828-3441; Fax: (919) 828-5751                  www.FandR.com</p>	CLIENT: N.C. Department of Transportation		
	PROJECT: Bridge No. 52 over Turkey Creek on SR 1101		
	STATE PROJ. No.: 33321.1.1	COUNTY: Nash	
	TIP No.: B-3877	FA No.: BRZ-110(7)	
	DATE: 10/2004	SCALE: 1"=50'	DRAWING No.: 1