



Pre-Construction Notification (PCN) Form

For Nationwide Permits and Regional General Permits (along with corresponding Water Quality Certifications) April 4, 2021 Ver 4

Please note: fields marked with a red asterisk * below are required. You will not be able to submit the form until all mandatory questions are answered.

Also, if at any point you wish to print a copy of the E-PCN, all you need to do is right-click on the document and you can print a copy of the form.

Below is a link to the online help file.

https://edocs.deq.nc.gov/WaterResources/0/edoc/624704/PCN%20Help%20File%202018-1-30.pdf

A. Processing Information County (or Counties) where the project is located:* Bitminetick Is this a NCDMS Project C Yes R No Cd Yes C No The two public transportation project?* 6 Yes C No Yes C No Yes C No (NCDOT only) T.I.P. or state project number: 8-4024 40579.1.1 (IV XEDT wave) 1a. Type(s) of approval sought from the Corps:* 7 Section 624 Permit (verticals, streams and vastes, Clean Water Act) Section 10 Permit (regisple water, study water, Nova and Hurborn Act) Has the PCN previously been submitted?* Yes C No 1b. What type(s) of permit(s) do you wish to seek authorization?* Nationable Permit (NOV) P. Rogonal General Permit (ROP) 1c. Has the NOVP or GP number been verified by the Corps?* C Yes C No Regional General Permit (ROP) 1c. Has the NOVP or GP number been verified by the Corps?* C Yes C No Regional General Permit (ROP) 1d. Has the NOVP or GP number been verified by the Corps?* C Yes C No Regional General Permit (ROP) 1d. Has the NOVP or GP number been verified by the Corps?* C Yes C No Regional General Permit (ROP) 1d. Has the NovP or GP number been verified by the Corps?* C Yes C No Regional General Permit (ROP) 1d. Has the NovP or GP number been verified by the Corps?* C Yes C No Regional General Permit (ROP) 1d. Has the NovP or GP number been verified by the Corps?* Roy Coulting Certification - Register 1d. Type(s) of approval sought from the DWR.* 1d. Type(s) of approval sought from the DWR.*		
County (or Counties) where the project is located:*		
Brunswick		
Is this a NCDMS Project *		
Is this project a public transportation project?*		
	port transportation project.	
· · · · · · · · · · · · · · · · · · ·		
1a. Type(s) of approval sought from the Corps:*		
	,	
Has this PCN previously been submitted?*		
1b. What type(s) of permit(s) do you wish to seek auth	norization?*	
, ,		
_ , ,		
1c. Has the NWP or GP number been verified by the C	Corps?*	
○ Yes ⊙ No		
Regional General Permit (RGP) Number:		
☑ 401 Water Quality Certification - Regular		
	Riparian Buffer Authorization	

Pre-Filing Meeting Information

Is this a courtesy copy notification? * ○ Yes ⊙ No		
ID# 20201511	Version 1	
Pre-fling Meeting or Request Date * 9/28/2020		
Attach documentation of Pre-Filing Meeting Request here: * Click the upload button or drag and drop files here to attach document DWR response Pre Filing Notification List of Projects from 12 MLL Through Sept 21 File type must be FDF	1 to NCDWR.pdf 141.27KB	
1e. Is this notification solely for the record because written approval is not	t required?	
,	*	
For the record only for DWR 401 Certification:	C Yes € No	
For the record only for Corps Permit:	C Yes € No	
1f. Is this an after-the-fact permit application?*		
C Yes		
1g. Is payment into a mitigation bank or in-lieu fee program proposed for m If so, attach the acceptance letter from tigation bank or in-lieu fee program © Yes C No	ultigation of impacts?	
Acceptance Letter Attachment		
Click the upload button or drag and drop files here to attach document B-5624_DMS Acceptance_ RW_LU 06.pdf FLETYFEMUST BEPDF	355.49KB	
1h. Is the project located in any of NC's twenty coastal counties?*		
© Yes C No		
1i. Is the project located within a NC DCM Area of Environmental Concern (a C Yes © No	AEC)?* © Unknown	
1j. Is the project located in a designated trout watershed?* C Yes ⓒ No		
Link to trout information: http://www.saw.usace.army.mil/Missions/Regulatory-Permit-	t-Program/Agency-Coordination/Trout.aspx	
B. Applicant Information		<u>^</u>
1a. Who is the Primary Contact?* Gordon Cashin		
	1c. Primary Contact Phone:*	
1b. Primary Contact Email: * gcashin@ncdot.gov	(919)749-0442	
1d. Who is applying for the permit?*		
✓ Owner (Check all that apply)	☐ Applicant (other than owner)	
1e. Is there an Agent/Consultant for this project?* C Yes ⊙ No		
2. Owner Information		
2a. Name(s) on recorded deed:* Multiple properties		
2b. Deed book and page no.:		
2c. Contact Person: (for Corporations)		
2d. Address*		

Street Address 1000 Birch Ridge Road Address Line 2 Raleigh North Carolina Postal / Zip Code 27610 USA 2e. Telephone Number: (xxx)xxx-xxxx (919)749-0442 2f. Fax Number: 2g. Email Address:* pharris@ncdot.gov C. Project Information and Prior Project History 1. Project Information 1a. Name of project:* Bridge No. 57 on NC 211 (Green Swamp Road) over Driving/Juniper Creek, B-5624 1b. Subdivision name: (if appropriate) 1c. Nearest municipality / town:* Supply 2. Project Identification 2a. Property Identification Number: 2b. Property size: (tax PIN or parcel ID) (in acres) 2c. Project Address Street Address Address Line 2 State / Province / Region Postal / Zip Code Country 2d. Site coordinates in decimal degrees Please collect site coordinates in decimal degrees. Use between 4-6 digits (unless you are using a survey-grade GPS device) after the decimal place as appropriate, based on how the location was determined. (For example, most mobile phones with GPS provide locational precision in decimal degrees to map coordinates to 5 or 6 digits after the decimal place.) Latitude:* Longitude:* 34.1021128426057 -78.3066391958156 ex: 34.208504 -77.796371 3. Surface Waters 3a. Name of the nearest body of water to proposed project:* Driving Creek / Juniper Creek 3b. Water Resources Classification of nearest receiving water:* C-Sw Surface Water Lookup 3c. What river basin(s) is your project located in?*

Lumber

3d. Please provide the 12-digit HUC in which the project is located.*

030402060403

River Basin Lookup

4. Project Description and History

4a. Describe the existing conditions on the site and the general land use in the vicinity of the project at the time of this application:

4b. Have Corps permits or DWR certification ○ Yes ○ No ○ Unknown	ons been obtained for this project (includ	ding all prior phases) in the past?*							
4d. Attach an 8 1/2 X 11 excerpt from the m Click the upload button or drag and drop files here to attach File type must be pdf		phic map indicating the location of the project site. (for DWR)							
4e. Attach an 8 1/2 X 11 excerpt from the m Click the uplead button or drag and drop files here to attach File type must be pdf	•	nty NRCS Soil Survey map depicting the project site. (for DWR)							
4f. List the total estimated acreage of all e 10.5	xisting wetlands on the property:								
4g. List the total estimated linear feet of al (intermittent and perennial) 1,500	ll existing streams on the property:								
4h. Explain the purpose of the proposed p Replace the existing NC 211 bridge over the st	•	ig utilities.							
replacement bridge will approximately 75 feet lo	et long, 23-foot wide 3-span structure that is fo ong and 40-feet wide. Project construction will uring construction. The shortest off-site detour	unctionally obsolete due to deck, superstructure and substructure conditions. The I extend along the bridge approaches approximately 664 feet from the north and south ends r is approximately 23 miles, with 3 miles being an unpaved gravel/dirt road. This length of							
Standard roadbuilding equipment will be used. Fiber optic cables will also be adjusted along the project.									
4j. Please upload project drawings for the Click the upload button or drag and drop files here to attach									
B-5624_Permit Drawings_20210311.pdf		3.39MB							
B-5624 Utilities.pdf File type must be pdf		1.44MB							
5. Jurisdictional Determination	ns								
5a. Have the wetlands or streams been de	elineated on the property or proposed im	pact areas?*							
⊙ Yes	○ No	© Unknown							
Comments:									
5b. If the Corps made a jurisdictional dete		s made?*							
	Unknown C N/A								
Corps AID Number: Example: SAW-2017-99999 SAW-2016-02148									
5c. If 5a is yes, who delineated the jurisdic	ctional areas?								
Name (if known):	Brian Dustin								
Agency/Consultant Company:	Calyx								
Other:									
5d. List the dates of the Corp jurisdiction o PJD signed 10/26/2016 by Brad Shaver, site vi		determination was made by the Corps or DWR.							
5d1. Jurisdictional determination upload									
Click the upload button or drag and drop files here to attach B-5624 final counter signed PJD.pdf File type must be PDF	document	286.95KB							
6. Future Project Plans									
6a. Is this a phased project?*									
O Yes	⊙ No								

Are any other NWP(s), regional general permit(s), or individual permits(s) used, or intended to be used, to authorize any part of the proposed project or related activity? This includes other separate and distant crossing for linear projects that require Department of the Army authorization but don't require pre-construction notification.

D. Proposed Impacts Inventory



1. Impacts Summary

Wetlands		☐ Buffers
✓ Open Waters	Pond Construction	

2. Wetland Impacts

If there are wetland impacts proposed on the site, then complete this question for each wetland area impacted.

"W." will be used in the table below to represent the word "wetland".

2a. Site #*(?)	2a1 Reason * (?)	2b. Impact type * (?)	2c. Type of W.*	2d. W. name *			2g. Impact area *
1	Roadway fill	Р	Riverine Swamp Forest	WA	Yes	Both	0.055 (acres)
2	Bridge	Р	Riverine Swamp Forest	WA	Yes	Both	0.004 (acres)
3	Roadway fill	Р	Riverine Swamp Forest	WA	Yes	Both	0.110 (acres)
3	Roadway fill	Т	Riverine Swamp Forest	WA	Yes	Both	0.274 (acres)
4	Roadway fill	Р	Riverine Swamp Forest	WA	Yes	Both	0.140 (acres)
5	Roadway fill	Р	Riverine Swamp Forest	WA	Yes	Both	0.085 (acres)

2g. Total Temporary Wetland Impact

0.274

2g. Total Permanent Wetland Impact

0.394

2g. Total Wetland Impact

0.668

2i. Comments:

There will be 0.08 acre of hand clearing in wetlands. 0.03 acre of temporary fill will be needed in the hand clearing areas for erosion control measures.

3. Stream Impacts

If there are perennial or intermittent stream impacts (including temporary impacts) proposed on the site, then complete this question for all stream sites impacted.

"S." will be used in the table below to represent the word "stream".

	3a. Reason for impact *(?)	3b.Impact type *	3c. Type of impact *	3d. S. name *		3f. Type of Jurisdiction *	- 3	3h. Impact length*
S1	Roadway fill	Permanent	Fill	Site 2 - Driving Creek	Perennial	Both	30 Average (feet)	25 (linear feet)
S2	Roadway fill	Temporary	Fill	Site 2 Driving Creek	Perennial	Both	30 Average (feet)	31 (linear feet)
S3	Bank stabilization	Permanent	Bank Stabilization	Site 2 Driving Creek	Perennial	Both	30 Average (feet)	43 (linear feet)
S4	Bridge	Temporary	Other	Site 2 Driving Creek	Perennial	Both	30 Average (feet)	85 (linear feet)

^{**} All Perennial or Intermittent streams must be verified by DWR or delegated local government.

3i. Total jurisdictional ditch impact in square feet:

0

3i. Total permanent stream impacts:

68

3i. Total temporary stream impacts:

116

3i. Total stream and ditch impacts:

184

3j. Comments:

Site 1 (Stream SA) is being relocated; it is considered JS - non-mitigable based on agency site visits.

4. Open Water Impacts

If there are proposed impacts to lakes, ponds, estuaries, tributaries, sounds, the Atlantic Ocean, or any other open water of the U.S. then individually list all open water impacts below.

4a. Site #*(?)	4a1. Impact Reason	4b. Impact type * (?)	4c. Name of waterbody (?)	4d. Activity type *	, .,,,,	4f. Impact area *
1	Roadway fill	Р	SA (JS - non-mit)	Fill	Tributary	0.18 (acres)
2	Roadway fill, bridge	Р	Driving Creek	Fill	Tributary	0.01 (acres)
2	Roadway fill, bridge	Т	Driving Creek	Fill	Tributary	0.03 (acres)
4	Roadway fill	P	Driving Creek	Fill	Tributary	0.00 (acres)

4g. Total temporary open water Impacts:

0.03

4g. Total permanent open water impacts:

0.19

4g. Total open water impacts:

0.22

4h. Comments

4h. Comments

Site 1 (Stream SA) is being relocated; it is considered JS - non-mitigable based on agency site visits.

Site 4 impact is 0.001 ac

E. Impact Justification and Mitigation

1. Avoidance and Minimization

1a. Specifically describe measures taken to avoid or minimize the proposed impacts in designing the project:*

The bridge will be replaced on the existing alignment. No impacts to waters or wetlands are proposed due to utility relocations.

1b. Specifically describe measures taken to avoid or minimize the proposed impacts through construction techniques: *

Best Management Practices for Construction and Maintenance Activities will be used. The relocated channel will be stabilized with coir fiber matting on the banks and reforested with live stakes prior to completion of project. No deck drains will be used on the proposed or detour structure, reducing adverse stream impacts associated with direct roadway runoff. Additional measures implemented to reduce impacts to stream and surrounding wetlands include; maintaining existing drainage patterns,

utilizing 2:1 fill slopes in areas with guardrail, utilizing 3:1 fill slopes in areas without guardrail, discharging stormwater as far away from the stream and wetlands as practicable. Further, rip rap is used at drainage outlets to dissipate energy and reduce erosion.

2. Compensatory Mitigation for Impacts to Waters of the U.S. or Waters of the State

2a. Does the project	require Compensatory	Mitigation for impacts to Waters of	the U.S. or Waters of the State?
Yes		O No	
2c. If yes, mitigation	is required by (check a	ill that apply):	
☐ DWR		☑ Corps	
2d. If yes, which miti	gation option(s) will be	used for this project?	
	Payment to in-lieu fee program	Permittee Responsible Mitigation	
4. Complete if	Making a Paym	ent to In-lieu Fee Prograr	n
4a. Approval letter f	rom in-lieu fee progran	is attached.	
⊙ Yes ○ No			
4b. Stream mitigatio (linear feet)	n requested:		4c. If using stream mitigation, what is the stream temperature:
NC Stream Temperatu	re Classification Maps ca	n be found under the Mitigation Concep	ts tab on the Wilmington District's RIBITS website.
			4e. Riparian wetland mitigation requested:
4d. Buffer mitigation	requested (DWR only)	:	(acres)
(square feet)			0.394
4f. Non-riparian wet	land mitigation request	ed:	4g. Coastal (tidal) wetland mitigation requested:
()			(2222)

F. Stormwater Management and Diffuse Flow Plan (required by DWR)



1. Diffuse Flow Plan		
1a. Does the project include or is it adjace O Yes	ent to protected riparian buffers identified wit	hin one of the NC Riparian Buffer Protection Rules?
For a list of options to meet the diffuse flow req	juirements, click here.	
If no, explain why: Buffer rules do not apply to the Lumber River B	3asin.	
2. Stormwater Management F	Plan	
	pliance with NCDOT's Individual NPDES permi	t NCS000250?*
⊙ Yes ○ No Comments:		
Comments.		
G. Supplementary Information	mation	©
1. Environmental Documenta	ition	
1a. Does the project involve an expenditu	re of public (federal/state/local) funds or the	use of public (federal/state) land?*
• Yes	C No	
1b. If you answered "yes" to the above, do Environmental Policy Act (NEPA/SEPA)?*	ses the project require preparation of an env	ronmental document pursuant to the requirements of the National or State (North Carolina)
• Yes	O No	
1c. If you answered "yes" to the above, haYes	as the document review been finalized by the O No	State Clearing House? (If so, attach a copy of the NEPA or SEPA final approval letter.)*
NEPA or SEPA Final Approval Letter Click the upload button or drag and drop files here to attach FLETYFEMUST BEPDF	document	
2. Violations (DWR Requirem	ent)	
2a. Is the site in violation of DWR Water Qu Riparian Buffer Rules (15A NCAC 2B .0200)		Isolated Wetland Rules (15A NCAC 2H .1300), or DWR Surface Water or Wetland Standards or
C Yes	© No	
3. Cumulative Impacts (DWR	Requirement)	
3a. Will this project (based on past and real C Yes	asonably anticipated future impacts) result in © No	additional development, which could impact nearby downstream water quality?*
3b. If you answered "no," provide a short Replacement of the existing bridge will neither	narrative description. influence nearby land uses nor stimulate growth.	
4. Sewage Disposal (DWR Ro	equirement)	
4a. Is sewage disposal required by DWR fo	or this project?*	
5. Endangered Species and I	Designated Critical Habitat (Cor	os Requirement)
5a. Will this project occur in or near an are © Yes	ea with federally protected species or habitat C No	·*
5b. Have you checked with the USFWS cor	ncerning Endangered Species Act impacts?* C No	
5c. If yes, indicate the USFWS Field Office Raleigh	you have contacted.	
5d. Is another Federal agency involved?*		
© Yes	C No.	O Unknown

What Federal Agency is involved? NMFS

5e. Is this a DOT project located within Division's 1-8?* Yes ○ No. 5j. What data sources did you use to determine whether your site would impact Endangered Species or Designated Critical Habitat? * Surveys, USFWS County List, IPaC, coordination with USFWS and NMFS. Remaining surveys will be updated prior to construction. **Consultation Documentation Upload** Olick the upload button or drag and drop files here to attach document 20210603_ltr_USFWS_NCDOT_B-5624.pdf 178.43KB File type must be PDF 6. Essential Fish Habitat (Corps Requirement) 6a. Will this project occur in or near an area designated as an Essential Fish Habitat?* O Yes 6b. What data sources did you use to determine whether your site would impact an Essential Fish Habitat?* Coordination with NMFS during NRTR research, Essential Fish Mapper checked in 2021. 7. Historic or Prehistoric Cultural Resources (Corps Requirement) Link to the State Historic Preservation Office Historic Properties Map (does not include archaeological data: http://gis.ncdcr.gov/hpoweb/ 7a. Will this project occur in or near an area that the state, federal or tribal governments have designated as having historic or cultural preservation status (e.g., National Historic Trust designation or properties significant in North Carolina history and archaeology)?* ⊙ No 7b. What data sources did you use to determine whether your site would impact historic or archeological resources? * Programmatic CE documentation 7c. Historic or Prehistoric Information Upload Click the upload button or drag and drop files here to attach document File must be PDF 8. Flood Zone Designation (Corps Requirement) Link to the FEMA Floodplain Maps: https://msc.fema.gov/portal/search 8a. Will this project occur in a FEMA-designated 100-year floodplain?* 8b. If yes, explain how project meets FEMA requirements: Hydraulics Unit coordination with FEMA 8c. What source(s) did you use to make the floodplain determination?* FEMA mapping (^) Miscellaneous The project crosses The Green Swamp, a designated nature preserve, and most of the surrounding parcels are owned by The Nature Conservancy. Right-of-Way (ROW) acquisition is ongoing and a public hearing is required due to the The Nature Conservancy property. The Department understands that impacts to Waters of the US, even if permitted, cannot occur until ROW is adequately resolved. Miscellaneous attachments not previously requested. Click the upload button or drag and drop files here to attach document File must be PDF or KMZ

Signature



By checking the box and signing below, I certify that:

- The project proponent hereby certifies that all information contained herein is true, accurate, and complete to the best of my knowledge and belief; and
- The project proponent hereby requests that the certifying authority review and take action on this CWA 401 certification request within the applicable reasonable period of time.
- I have given true, accurate, and complete information on this form;
- Lagree that submission of this PCN form is a "transaction" subject to Chapter 66, Article 40 of the NC General Statutes (the "Uniform Electronic Transactions Act");
- l agree to conduct this transaction by electronic means pursuant to Chapter 66. Article 40 of the NC General Statutes (the "Uniform Electronic Transactions Act"):
- I understand that an electronic signature has the same legal effect and can be enforced in the same way as a written signature; AND
- I intend to electronically sign and submit the PCN form.

Mack Christopher Rivenbark III

Hack C Riverbark, III

Date

6/3/2021

Projects Potentially Requiring Notification per New 401 EPA Rule 12 Month Let List SEPT 2020 - SEPT 2021 (from 36 Month Let List)

DWR Rep	NCDOT Contact	Let Date	TIP	Let Type	<u>D</u>	County	Project Description	Type of Previous DWR Correspondence	DWR# V	'ersion # Received I Laserfiche Link
Wanucha	Bill Baret	09/21/2021	B-5728	Raleigh Letting	,	Alamance	REPLACE BRIDGE 113 OVER REEDY FORK CREEK IN OSSIPSE ON N.C. 87	No Files found in Laserfiche	20201505 1	9/28/2020 https://edocs.deq.nc.gov/WiterResources/Browse.uspx?id=1326036&dbid=0&repo=WaterResources
Hood	Erin Cheely	05/18/2021	B-4407	Raleigh Letting	-	Anson, Stanly	SREGG 78 OVER ROCKYRNER ON US 52	No Files found in Laserfiche	20201506 1	9/28/2020 https://edocs.deq.nc.gov/WiterResources/Browse.uspx?id=1326038&dbid=0&repo=WaterResources
Hood	Erin Cheely	03/16/2021	B-5818	Raleigh Letting	-	Anson	REPLACE BRIDGE 11 OVER DEADFALL CREEK ON NO 169	No Files found in Laserfiche	20201507 1	9/28/2020 https://edocs.deq.nc.gov/WaterResources/Browse.uspx?id=1326055&dbid=0&repo=WaterResources
Hood	BillBaret	07/20/2021	BR-0107	Raleigh Letting	-	Iredell	SR 1577 BRIDGE 131 REPLACE BRIDGE 131 OVER TO SNOW CREEK.	No Files found in Laserfiche	20201508 1	9/28/2020 https://edoes.deq.nc.gov/WaterResources/Browse.aspx?id=13260568.dbid=0&repo=WaterResources
Hood	Rail Division	08/17/2021	P-5705A	Raleigh Letting	-	Mecklenburg	CHRILOTTE WIS CONNECTION-RAL	No Files found in Laserfiche	20181692 2	9/28/2020 https://edocs.deq.nc.gov/WaterResources/Browse.aspx?id=1326025&dbid=0&repo=WaterResources
Ridings	Chris Murray	02/16/2021	B-5318	DDRL	4	Wake	REPLACE BRIDGE 910136 OVER SMITHS CREEK SR 2004 (LECHMILLROAD) IN WAVE FOREST	Laverliche Files: Scoping Letter	20201509 1	9/28/2020 https://edocs.deq.nc.gov/WaterResources/Browse.aspx?id=1326057&dbid=0&repo=WaterResources
Steenhuis	Gordon Cashin	07/20/2021	B-5624	Raleigh Letting		Brunswick	SERVICE OF OVER JUNIOR CREEK ON NO. 211	Laserfiche Files: P/JD Package	20201510 1	9/28/2020 https://edocs.doi.g.nc.gon/WitterResources/Hrowso_aspx?id=1326958&dbid=0&repo=WitterResources_
Steenhuis	Gordon Cashin	07/20/2021	B-5642	Raleigh Letting		Brunswick	BRIDGE 65 OVER HOOD CREEK ONING 67	No Files found in Laserfiche	20201511 1	9/28/2020 https://edocs.deq.nc.gov/WaterResources/Browse.aspx?id=1326059&dbid=0&repo=WaterResources
Steenhuis	Chris Rivenbark	05/18/2021	BR-0017	Raleigh Letting		Duplin	BRIDGE 200012 ON NO. 11 OVER LITTLE ROCKPISH CREEK	Laserliche Files: P/JD Package	20201512 1	9/28/2020 https://edocs.deq.nc.gov/WaterResources/Browse.aspx?id=1326060&dbid=0&repo=WaterResources
Steenhuis	Greg Price	07/20/2021	1-5878	DDRL		Hamet	146 AT US 421 (ENT 72) AND SR 1983 (POPE ROAD) (ENT 72) IMPROVE INTERCHANGES, WIDEN TO EIGHT LANES, (COMB MINSBES & N 58669)	No Files found in Laserfiche	20201513 1	9/28/2020 https://edocs.deq.nc.gov/WaterResources/Browse.aspx?id=1326061&dbid=0&repo=WaterResources
Steenhuis	Greg Price	07/20/2021	1-5883	DDRL		Hamet	466 AT SR 1601 (JONESBOOR) ROAD) (SUIT TO) TO MORTH OF SR 1709 (HODGES CHAPEL ROAD) (SUIT 77), IMPROVE INTERCHANGES. WICEN TO EIGHT LANES, (COMB WI-6278 & F-6866).	Laserfiche Files: Scoping Letter and JD Request	20201514 1	9/28/2020 https://edocs.deq.nc.gov/WaterResources/Browse.aspx?id=1326062&dbid=0&repo=WaterResources
Steenhuis	Greg Price	07/20/2021	I-5986B	DDRL		Hamett, Johnston	HAS FROM SR 1709 (ADDIGES CHAPEL ROAD - DOT 77) TO HIS (DOT 81), WIDDIN TO DIGHT LANDS HARNETTUDINGTON COUNTIES. (COMB IN HISBI) & HISBIS.	No Files found in Laserfiche	20190214 3	9/28/2020 https://edocs.deq.nc.gov/WaterResources/Browse.uspx?id=1326029&dbid=0&repo=WaterResources
Steenhuis	Jason Dilday	04/20/2021	R-2561CA	DDRL		Columbus	NO 67 AT NO. 11. CONSTRUCT INTERCHANGE.	Laserliche Files: P/JD Package	20201515 1	9/28/2020 https://edoes.deq.nc.gov/WaterResources/Browse.aspx?id=1326063&dbid=0&repo=WaterResources
Steenhuis	Greg Price	04/20/2021	R-5797	DDRL		Columbus	LIS 74 AT SR 1508 (BOARDINEN ROAD)	Laserliche Files: P/JD Package	20201516 1	9/28/2020 https://edocs.deq.nc.gov/WaterResources/Browse.aspx?id=1326064&dbid=0&repo=WaterResources
Wanucha	Kevin Hining	07/20/2021	17BP.11.R.15	DDRL	-	Wilkes	BRIDGE 419 ON SR 1148 OVER NAVED CREEK.	No Files found in Laserfiche	20201517 1	9/28/2020 https://edocs.deq.nc.gov/WaterResources/Browse.aspx?id=1326065&dbid=0&repo=WaterResources
Wanucha	Erin Cheely	06/15/2021	BR-0048	Raleigh Letting	-	Sury	BREDGE 188 ON NO 268 OVER MECHELL RIMER REPLACE BREDGE.	Laverliche Files: Start of Study Letter	20201518 1	9/28/2020 https://edoes.deq.nc.gov/WaterResources/Browse.aspx?id=1326066&dbid=0&repo=WaterResources
Wanucha	Jeff Hemphill	07/20/2021	BR-0108	Raleigh Letting	-	Wilkes	SR 3419 BRDQE 4 REPLACE BRDQE 4 OVER UTTLE HINTING CREEK.	No Files found in Laserfiche	20201519 1	9/28/2020 https://edocs.deq.nc.gov/WaterResources/Browse.aspx?id=1326067&dbid=0&repo=WaterResources
Ward	Jason Dilday	09/21/2021	B-4926	DDRL	2	Lenoir	NOUSE RINER - REPLACE BRIDGE NO. 20 AND 34 OVER NOUSE RIVERSOVERFLOW ON NO. 55	Laverliche Files: Previous NW 6	20181733 2	9/28/2020 https://edocs.deq.nc.gov/WaterResources/Browse.aspx?id=1326028&dbid=0&repo=WaterResources
Ward	Dearna Riffey	09/21/2021	8-5614	Raleigh Letting	è	Beaufort	REPLACE BRIDGE 9 OVER BLOUNTS CREEK ON SR 1112	No Files found in Laserfiche	20201520 1	9/28/2020 https://edocs.deq.nc.gov/WaterResources/Browse.aspx?id=1326068&dbid=0&repo=WaterResources
Ward	Dearna Riffey	05/18/2021	8-5619	Raleigh Letting	è	Lenoir	GEFLACE BROOK SO OVER NEUSE RIVER AND REPLACE BROOK 107 OVER NEUSE RIVER OVERFLOW ON SR 1389 (WARDY BROOK ROAD)	No Files found in Laserfiche	20201521 1	9/28/2020 https://edocs.deq.nc.gov/WaterResources/Browse.aspx?id=1326069&dbid=0&repo=WaterResources
Ward	Dearma Riffery	09/21/2021	BR-0004	Raleigh Letting		Beaufort	BRIDGE 00008 ON US 384 OVER PLNSO RIVER	No Files found in Laserfiche	20201522 1	9/28/2020 https://edocs.deq.nc.gov/WaterResources/Browse.aspx?id=1326070&dbid=0&repo=WaterResources

ROY COOPER Governor DIONNE DELLI-GATTI Secretary TIM BAUMGARTNER Director



May 6, 2021

Mr. Philip S. Harris, III, P.E. Environmental Analysis Unit North Carolina Department of Transportation 1598 Mail Service Center Raleigh, North Carolina 27699-1598

Dear Mr. Harris:

Subject: Mitigation Acceptance Letter:

B-5624, Replace Bridge 57 on NC 211 over Juniper Creek, Brunswick County

The purpose of this letter is to notify you that the Division of Mitigation Services (DMS) will provide the compensatory wetland mitigation for the subject project. Based on the information supplied by you on May 6, 2021, the impacts are located in CU 03040206 of the Lumber River basin in the Southern Outer Coastal Plain (SOCP) Eco-Region, and are as follows:

Lumber		Stream			Wetlands		Buffer	(Sq. Ft.)
Lumber 03040206 SOCP Impacts (feet/acres)	Cold	Cool	Warm	Riparian	Non- Riparian	Coastal Marsh	Zone 1	Zone 2
1	0	0	0	0.394	0	0	0	0

^{*}Some of the wetland impacts may be proposed to be mitigated at a 1:1 mitigation ratio. See permit application for details.

The impacts and associated mitigation needs were under projected by the NCDOT in the 2021 impact data. DMS will commit to implement sufficient compensatory wetland mitigation credits to offset the impacts associated with this project as determined by the regulatory agencies using the delivery timeline listed in Section F.3.c.iii of the In-Lieu Fee Instrument dated July 28, 2010. If the above referenced impact amounts are revised, then this mitigation acceptance letter will no longer be valid and a new mitigation acceptance letter will be required from DMS.

If you have any questions or need additional information, please contact Beth Harmon at 919-707-8420.

Sincerely,

James B. Stanfill

DMS Asset Management Supervisor

Tizabeth Harmon


cc: Mr. Monte Matthews, USACE – Raleigh Regulatory Field Office


Ms. Amy Chapman, NCDWR


File: B-5624





Submitted 6/3/2021

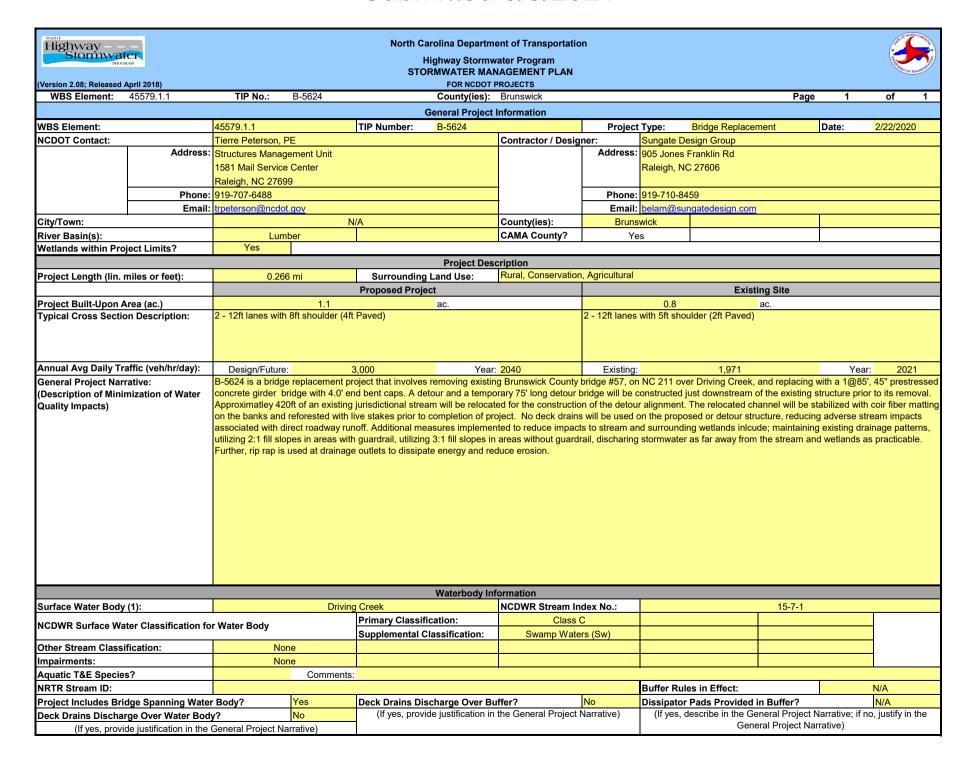


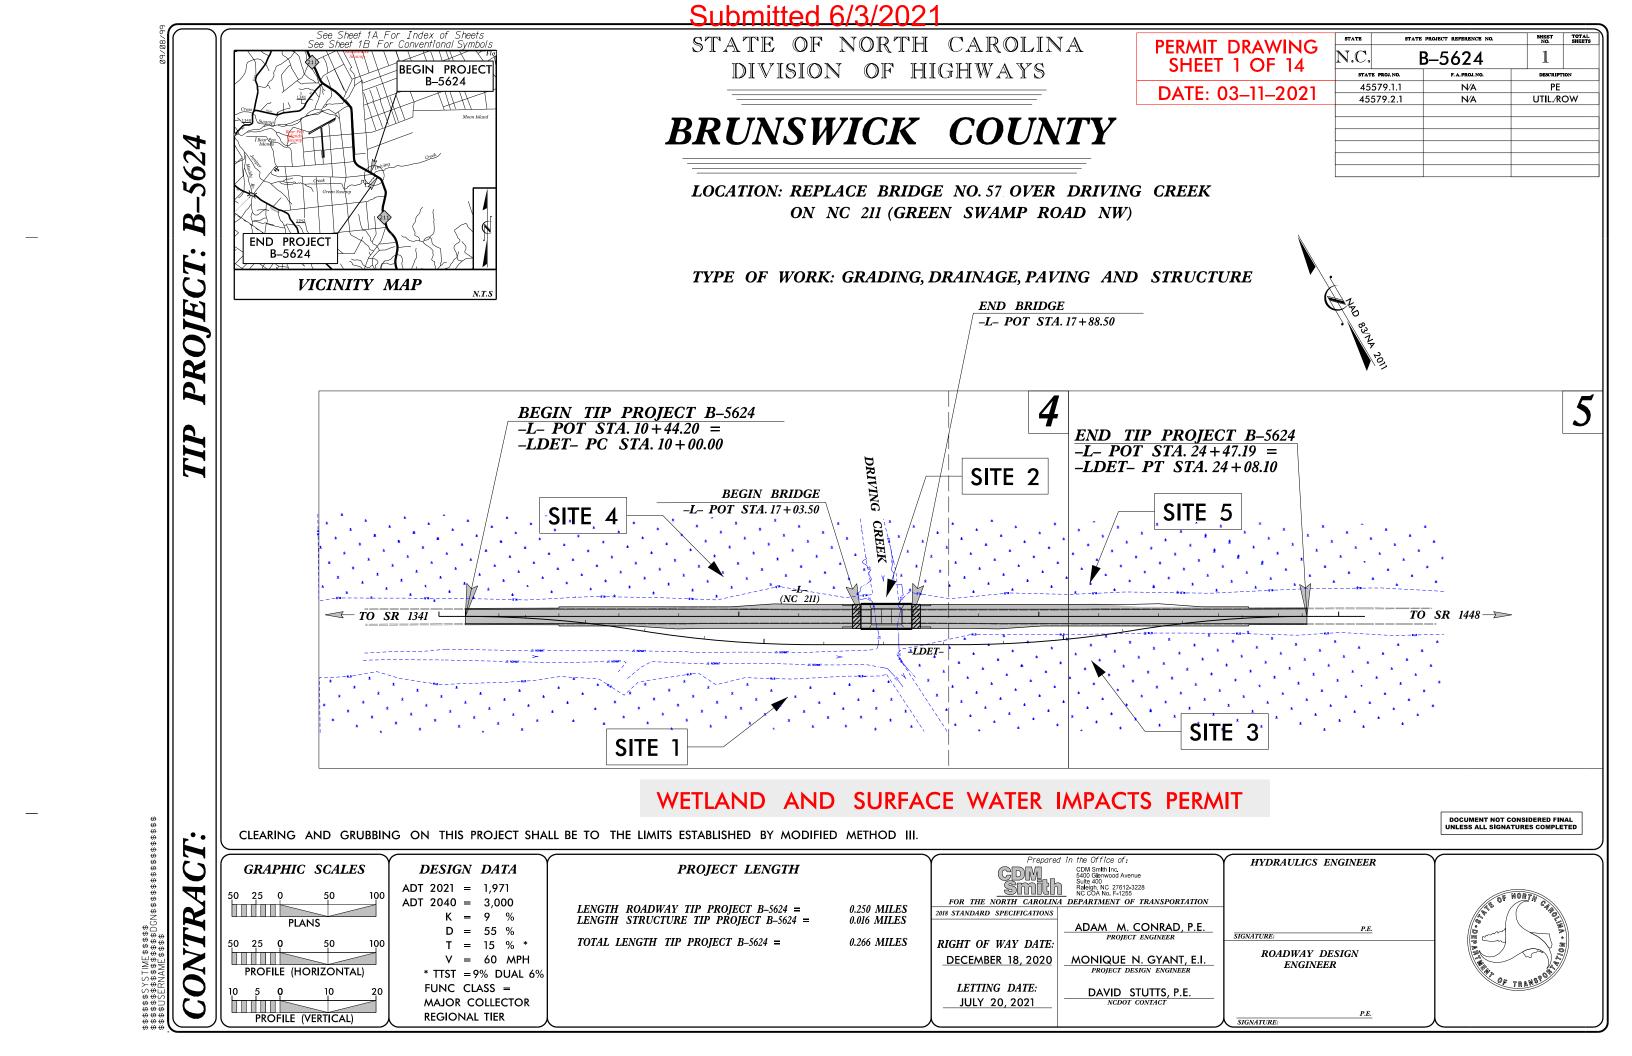


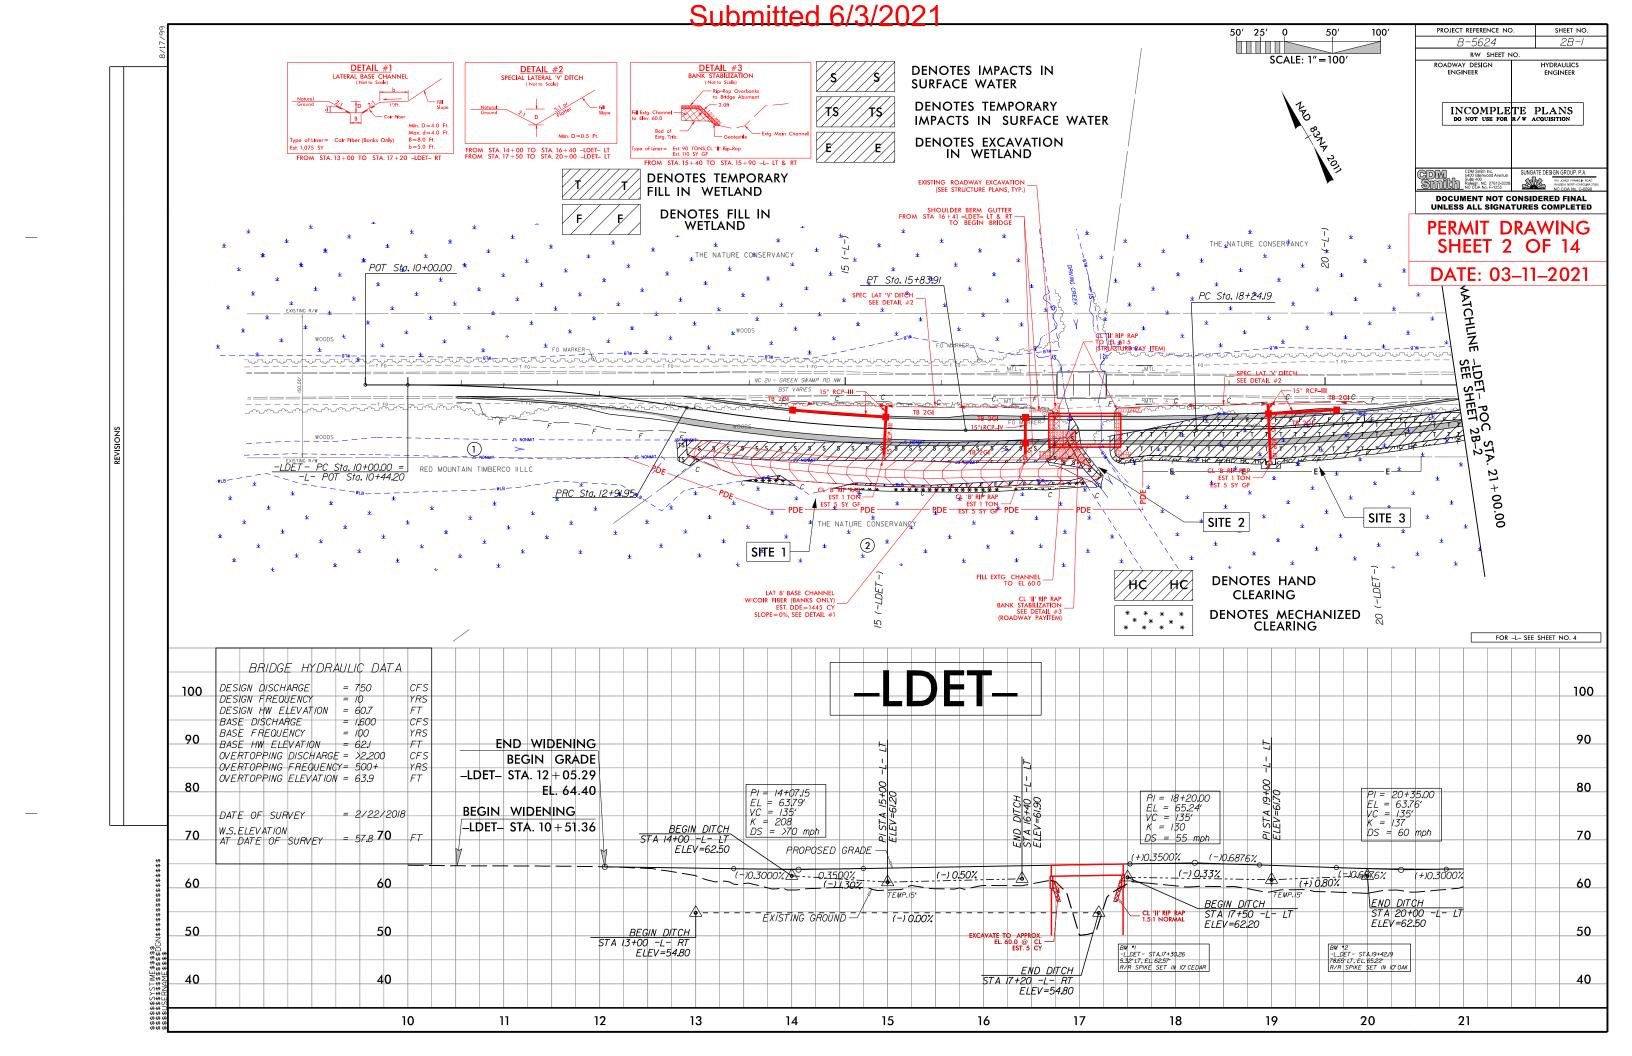


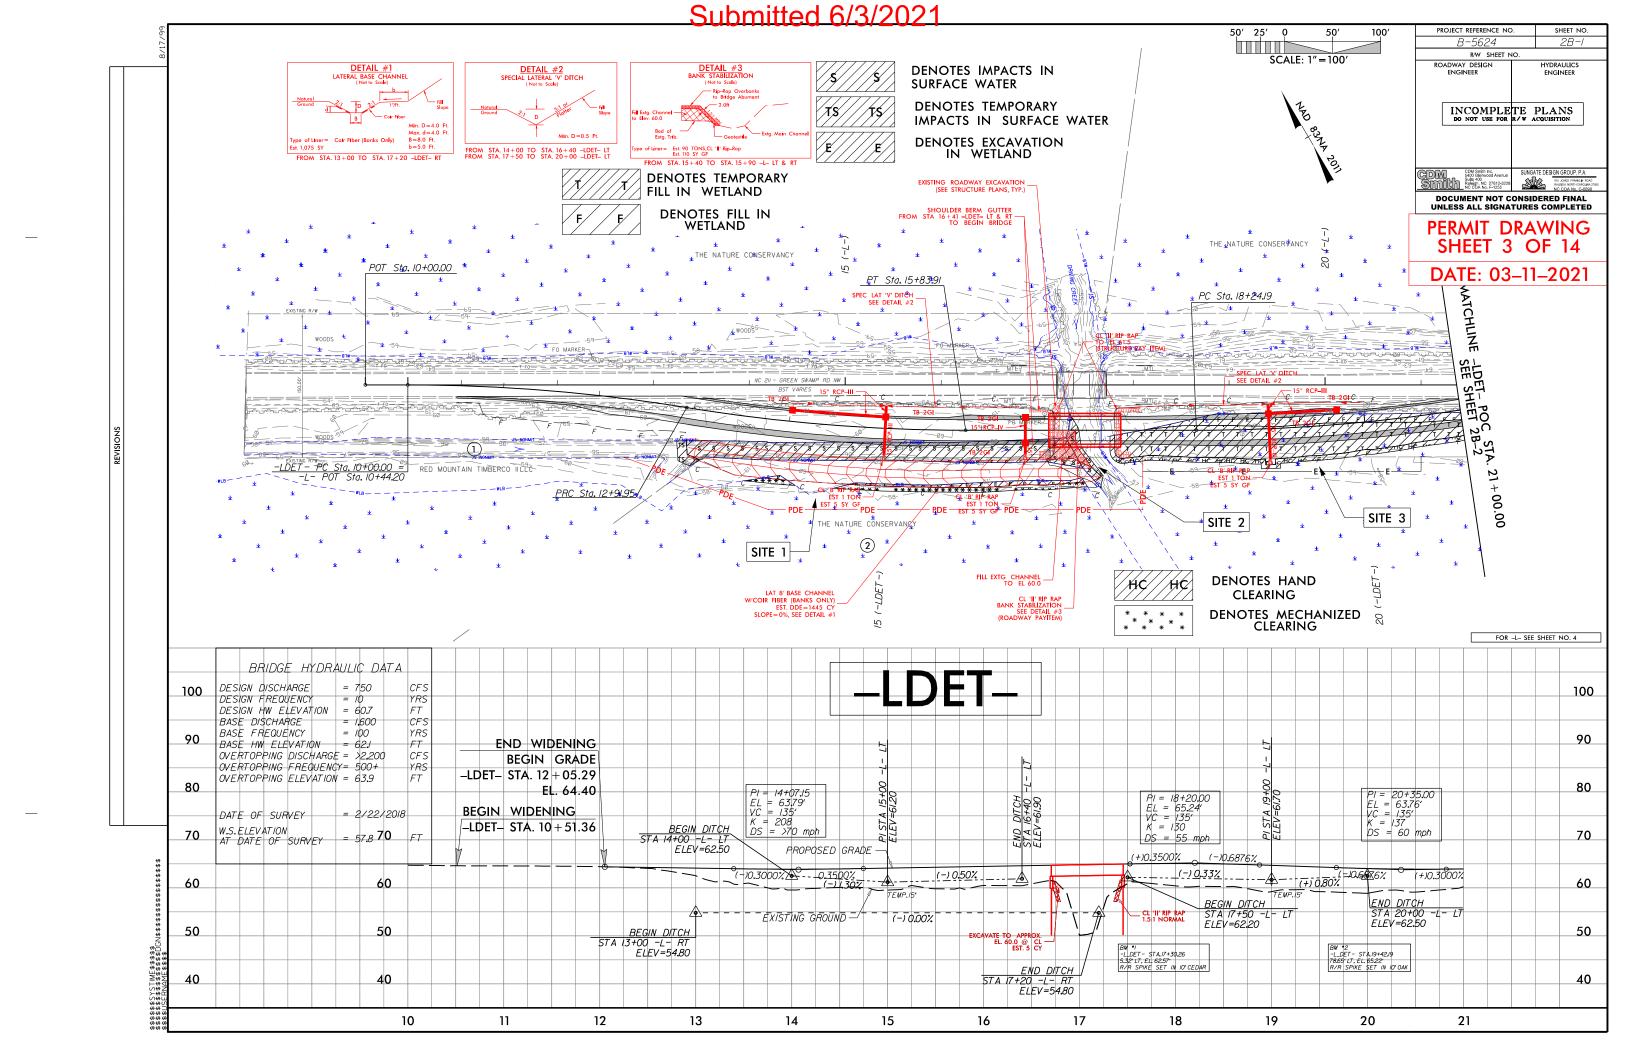

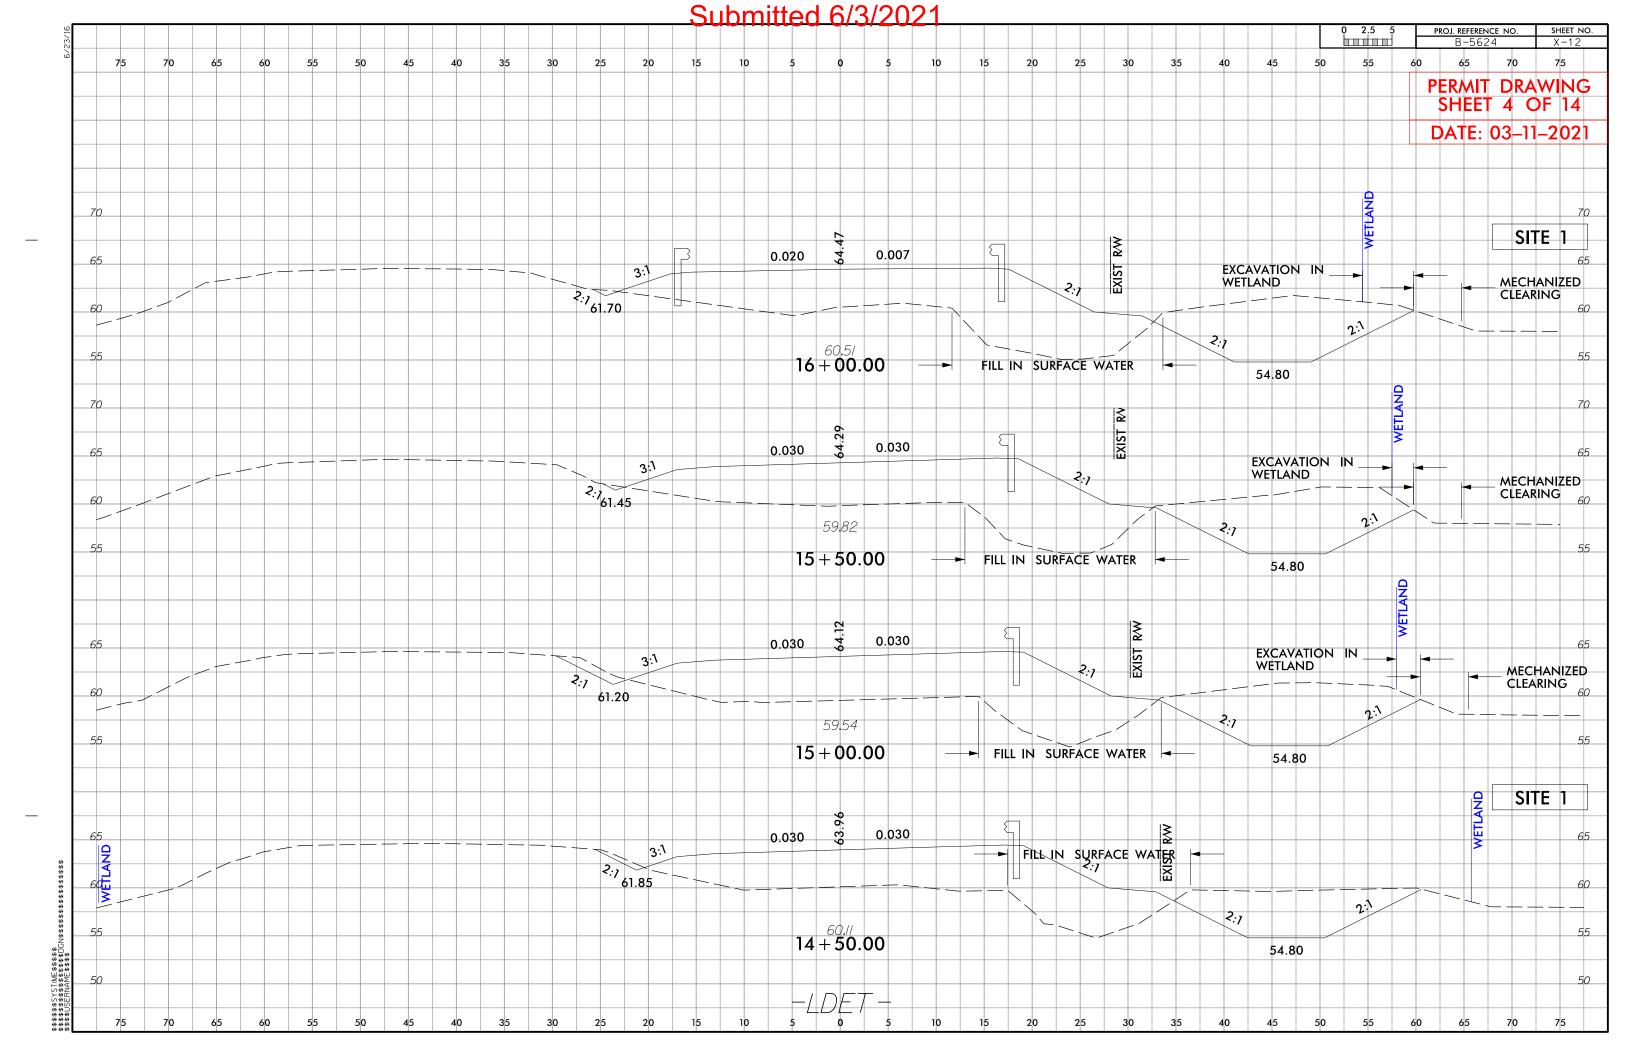

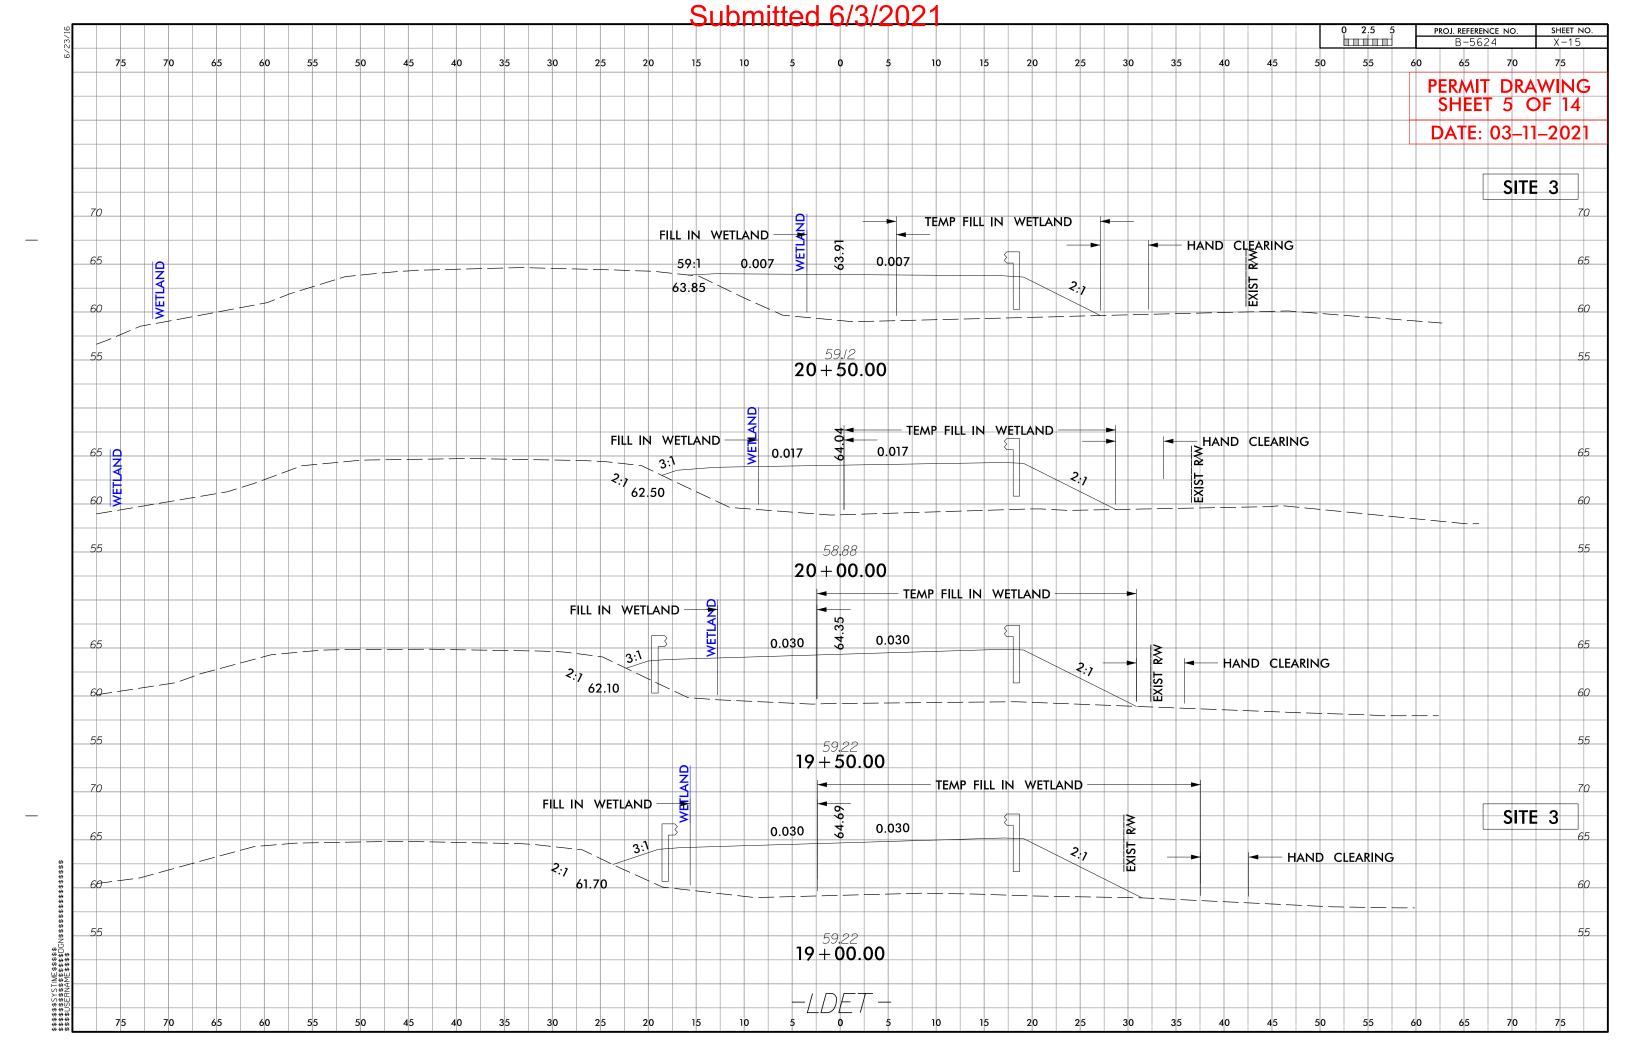


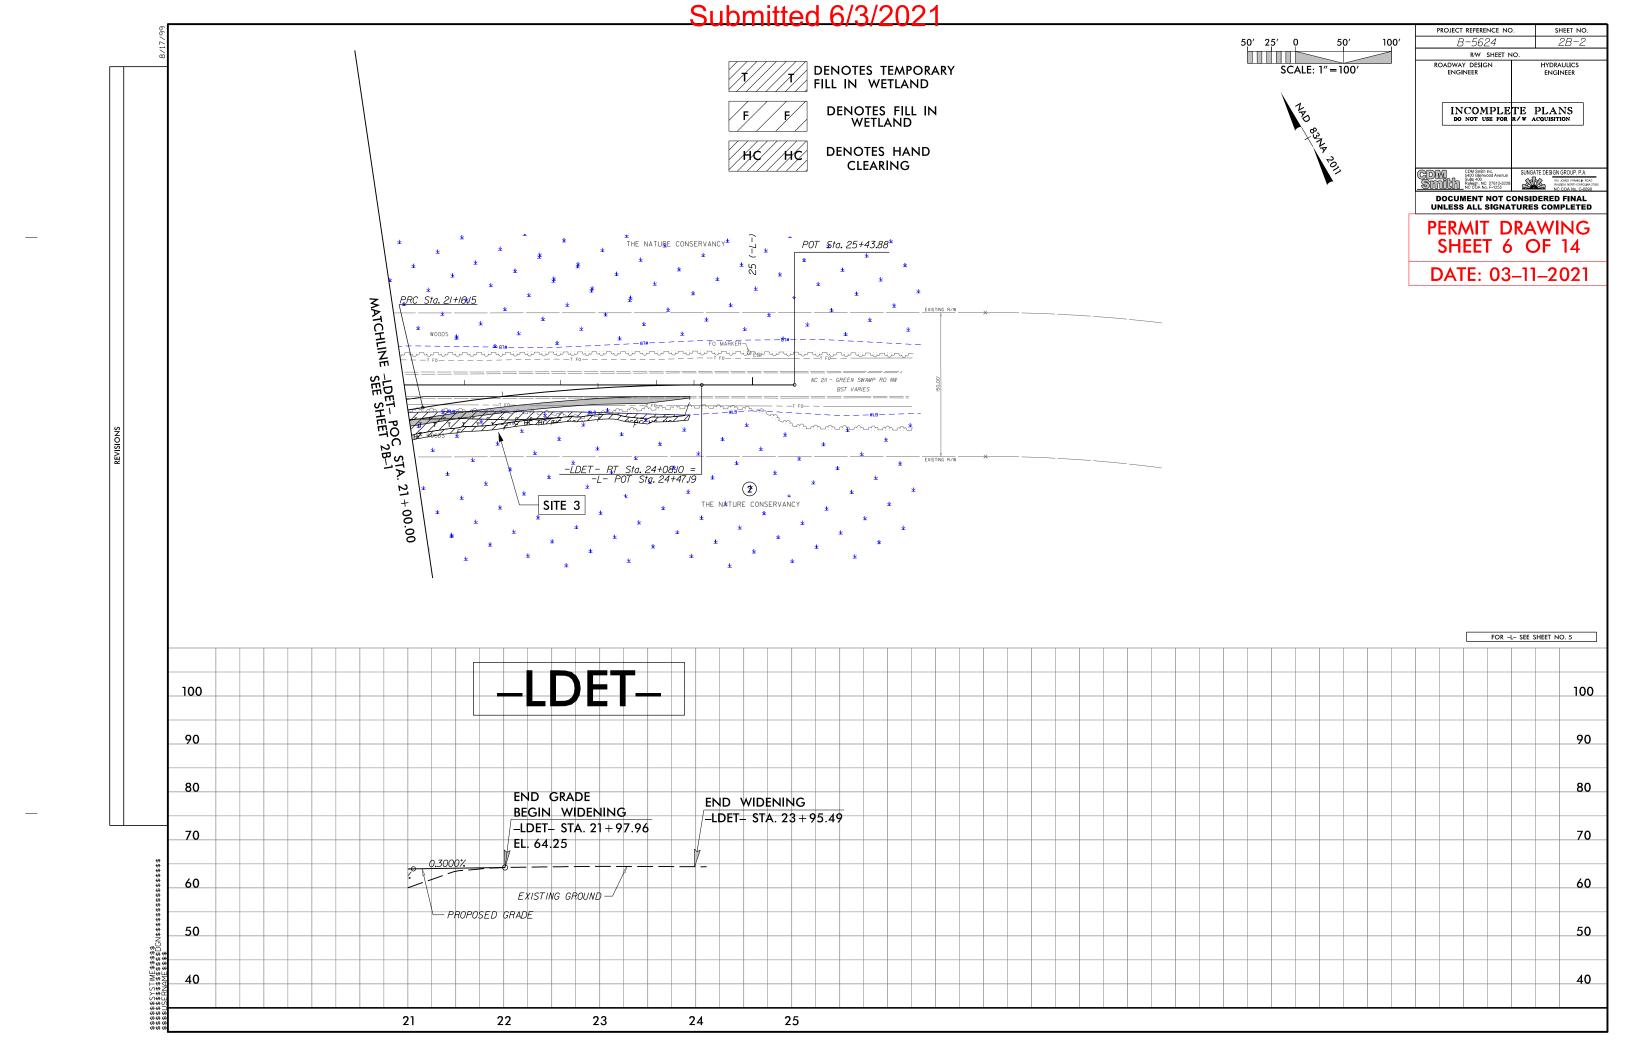


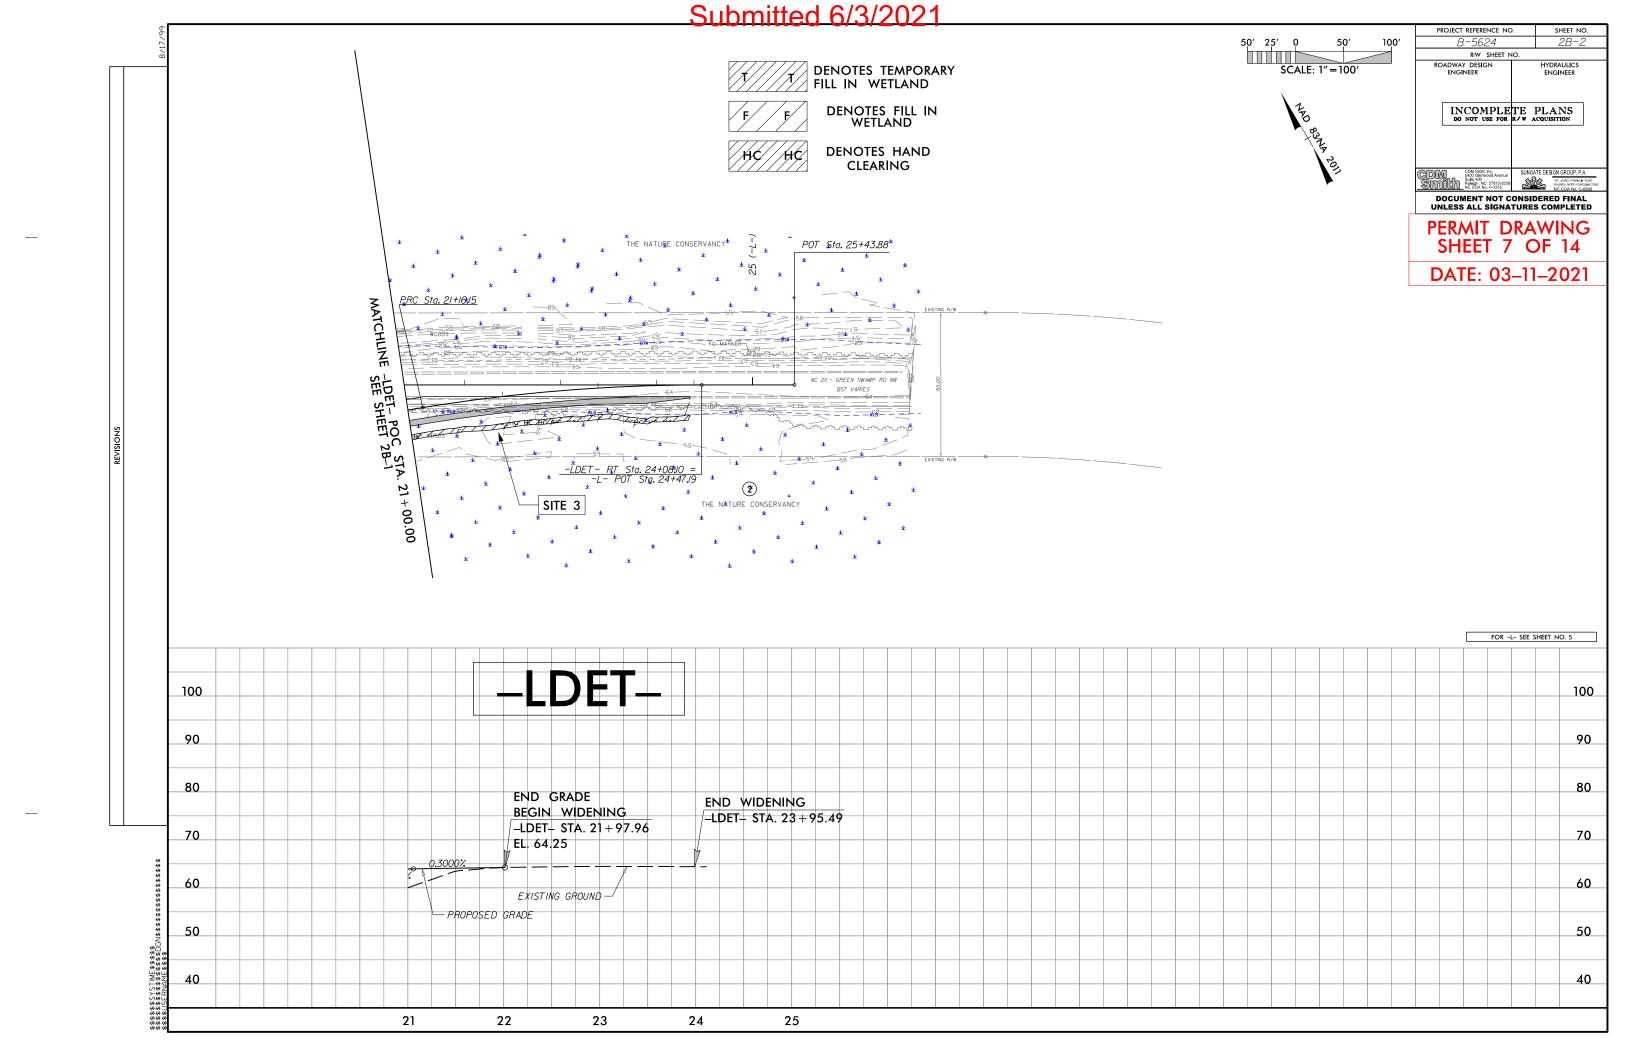


Submitted 6/3/2021 PROJECT REFERENCE NO. SHEET NO. RW SHEET NO. HYDRAULICS ROADWAY DESIGN ENGINEER DENOTES IMPACTS IN **ENGINEER** SCALE: 1"=100' SURFACE WATER **DENOTES TEMPORARY** INCOMPLETE PLANS
DO NOT USE FOR R/W ACQUISITION IMPACTS IN SURFACE WATER Type of Liner = Class 'B' Rip-Rap DENOTES FILL IN WETLAND FROM STA, 13+50 TO STA, 15+75 -L- LT DENOTES MECHANIZED CLEARING DOCUMENT NOT CONSIDERED FINAL UNLESS ALL SIGNATURES COMPLETED PERMIT DRAWING SITE 2 THE NATURE CONSER¥ANCY SHEET 8 OF 14 THE NATURE COMSERVANCY POT Sta. 10+00.00 DATE: 03-11-2021 SITE 4 SITE 5 WOODS ************* RED MOUNTAIN TIMBERCO IILLC * THE NATURE CONSERVANCY (2) CHANNEL RELOCATION AND BANK STABILIZATION IMPACTS ACCOUNTED FOR IN DETOUR SHEETS 2 AND 3 29 /2 BRIDGE APPROACH SLAB FOR -LDET- SEE SHEET NO. 2B-1 85 85 BM *2 -L- STA.19+79.32 36.37'LT, EL.65.22' R/R SPIKE \$ET IN 10'OAK 75 75 PI = 16+83.00 EL = 68.63' VC = 230' K = 154 DS = 60 mphCL STA 17+46 -L-. CL GP EL=68.17 1@85'.45' PSCG W/ 4.0' END BENT CAP. SKEW=90 DEG PI = 12+95,00 EL = 65,12' VC = 180' K = 300 65 65 END OVERLAY BEGIN GRADE BRIDGE HYDRAULIC DATA STA 12+00.00 PROPOSED GRADE DS = >80 mph DESIGN DISCHARGE = 1,300 CFS 55 55 EL. 64.83 DESIGN FREQUENCY = 50 DESIGN HW ELEVATION = 61.3 YRS FT BASE DISCHARGE = 1,600 (+)0.9046% BASE FREQUENCY = 100 45 BASE HW ELEVATION = 61.7 BEGIN OVERLAY OVERTOPPING DISCHARGE = x 2,200 OVERTOPPING FREQUENCY = 500+ EXISTING GROUND -CFS STA 10+44.20 YRS CL 'II' RIP RAP OVERTOPPING ELEVATION = 64.4 - SHEET PILIN 35 35 DATE OF SURVEY = 2/22/2018 W.S. ELEVATION AT DATE OF SURVEY 25 25 10 11 12 13 14 15 16 17 18 19 20 21

Submitted 6/3/2021 PROJECT REFERENCE NO. SHEET NO. RW SHEET NO. HYDRAULICS ENGINEER ROADWAY DESIGN ENGINEER DENOTES IMPACTS IN SCALE: 1"=100' SURFACE WATER **DENOTES TEMPORARY** INCOMPLETE PLANS
DO NOT USE FOR R/W ACQUISITION IMPACTS IN SURFACE WATER Type of Liner = Class 'B' Rip-Rap DENOTES FILL IN WETLAND FROM STA, 13+50 TO STA, 15+75 -L- LT DENOTES MECHANIZED CLEARING DOCUMENT NOT CONSIDERED FINAL UNLESS ALL SIGNATURES COMPLETED PERMIT DRAWING SITE 2 THE NATURE CONSER¥ANCY SHEET 9 OF 14 THE NATURE CONSERVANCY POT Sta. 10+00.00 DATE: 03-11-2021 SITE 4 SITE 5 WOODS RED MOUNTAIN TIMBERCO ILLE THE NATURE CONSERVANCY (2) CHANNEL RELOCATION AND BANK STABILIZATION IMPACTS ACCOUNTED FOR IN DETOUR SHEETS 2 AND 3 29 /2 BRIDGE APPROACH SLAB FOR -LDET- SEE SHEET NO. 2B-1 85 85 BM *2 -L- STA.19+79.32 36.37'LT, EL.65.22' R/R SPIKE \$ET IN 10'OAK 75 75 PI = 16+83.00 EL = 68.63' VC = 230' K = 154 DS = 60 mphCL STA 17+46 -L-. CL GP EL=68.17 1@85'.45' PSCG W/ 4.0' END BENT CAP SKEW=90 DEG PI = 12+95,00 EL = 65,12' VC = 180' K = 300 65 65 END OVERLAY BEGIN GRADE BRIDGE HYDRAULIC DATA STA 12+00.00 PROPOSED GRADE DS = >80 mph DESIGN DISCHARGE = 1,300 CFS 55 55 EL. 64.83 DESIGN FREQUENCY = 50 DESIGN HW ELEVATION = 61.3 YRS FT BASE DISCHARGE = 1,600 (+)0.9046% BASE FREQUENCY = 100 45 BASE HW ELEVATION = 6/.7 BEGIN OVERLAY OVERTOPPING DISCHARGE = x 2,200 OVERTOPPING FREQUENCY = 500+ EXISTING GROUND -CFS STA 10+44.20 YRS CL 'II' RIP RAP OVERTOPPING ELEVATION = 64.4 - SHEET PILIN 35 35 DATE OF SURVEY = 2/22/2018 W.S. ELEVATION AT DATE OF SURVEY 25 25 10 11 12 13 14 15 16 17 18 19 20 21

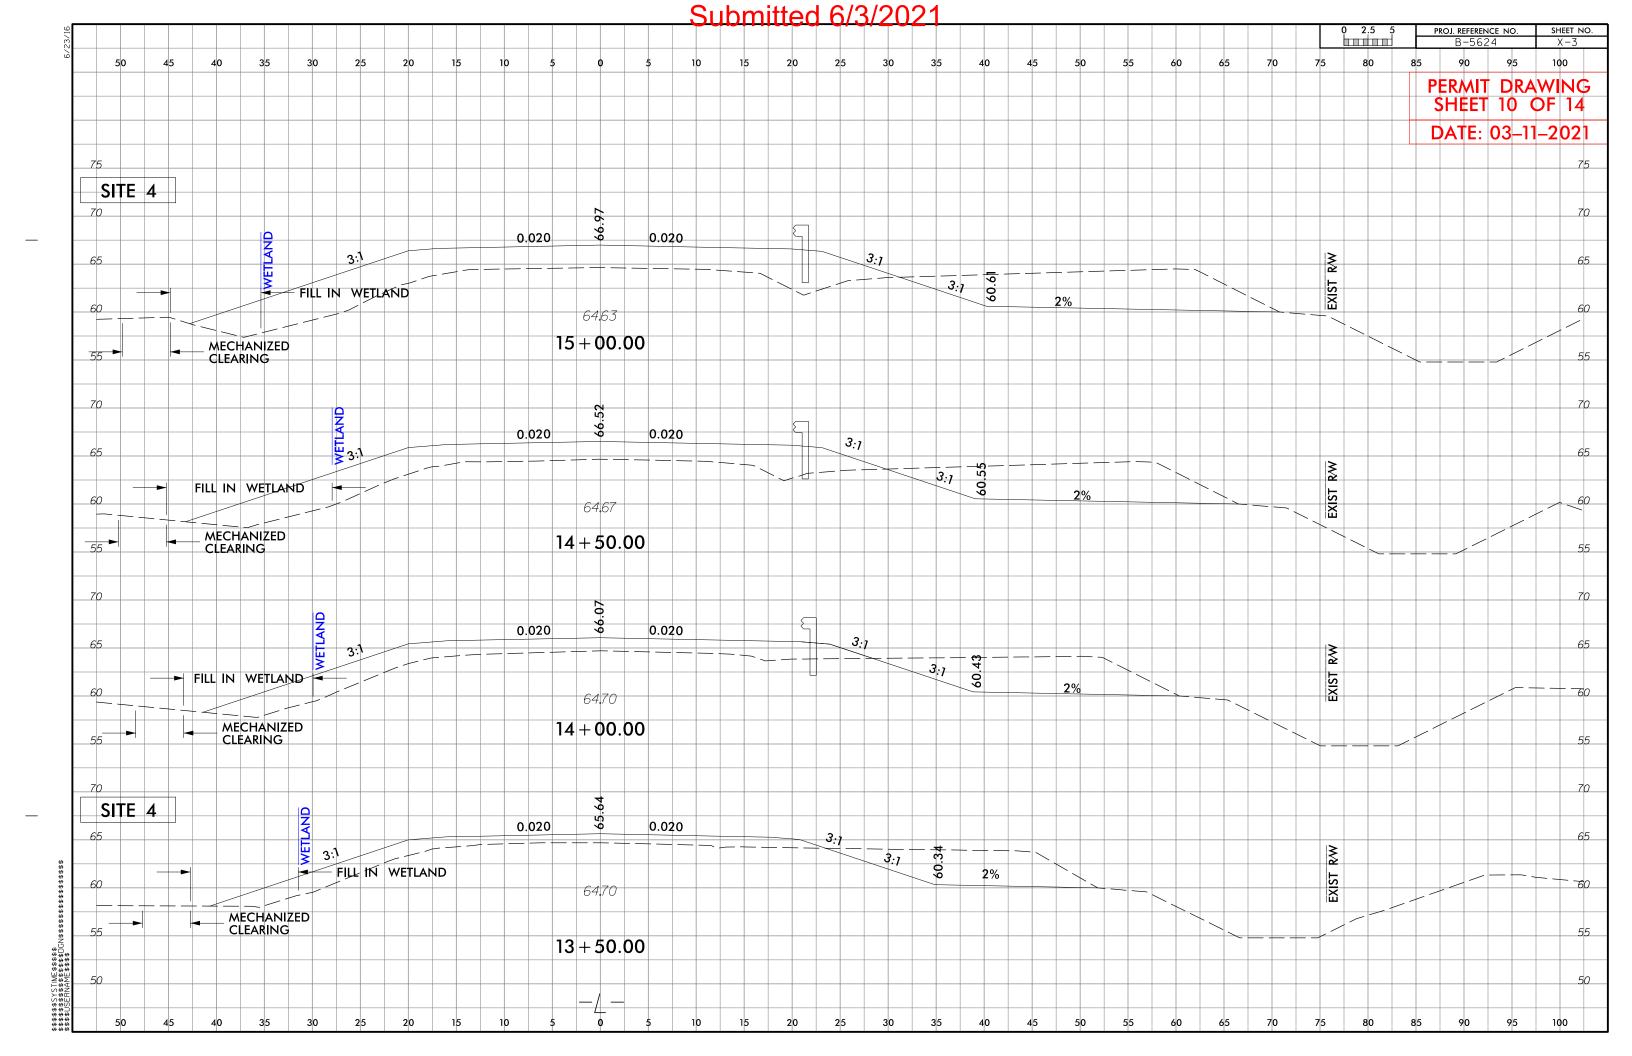

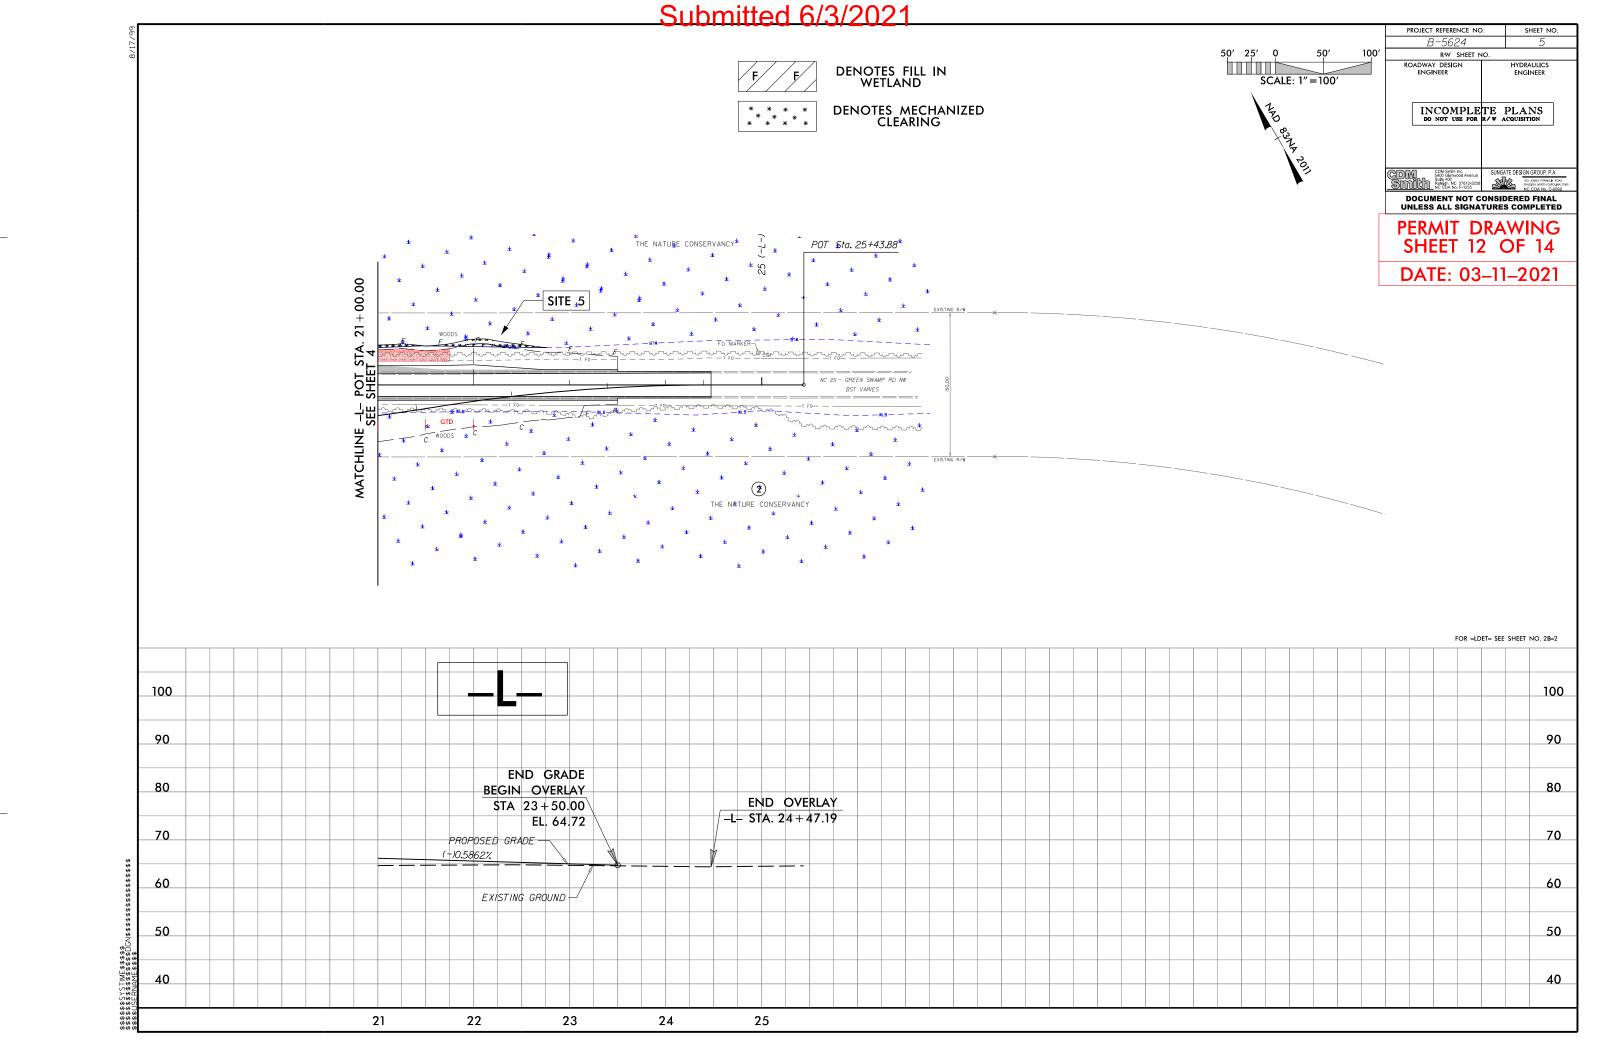

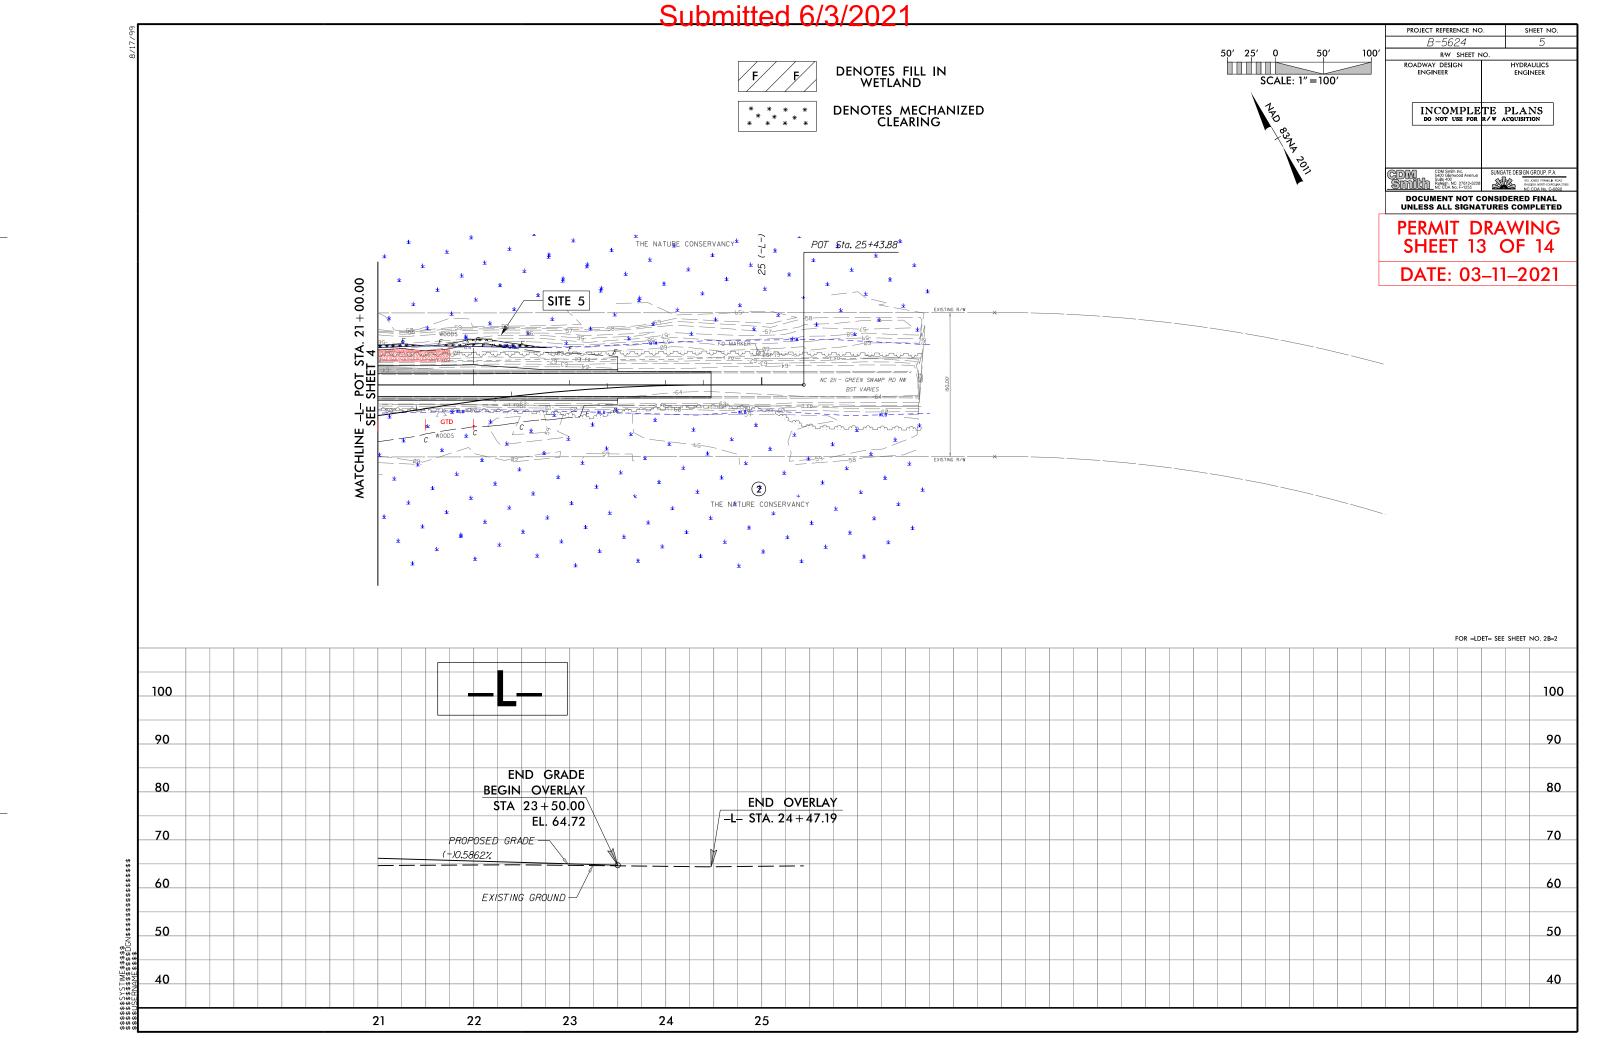

Submitted 6/3/2021

			WETLAND IMPACTS					SURFACE WATER IMPACTS					
Site No.	Station (From/To)	Structure Size / Type	Permanent Fill In Wetlands (ac)	Temp. Fill In Wetlands (ac)	Excavation in Wetlands (ac)	Mechanized Clearing in Wetlands (ac)	Hand Clearing in Wetlands (ac)	Permanent SW impacts (ac)	Temp. SW impacts (ac)	Existing Channel Impacts Permanent (ft)	Existing Channel Impacts Temp. (ft)	Natural Stream Design (ft)	
1	12+87 to 14+14-LDET-RT	ROADWAY FILL			0.02	0.03		0.18	< 0.01				
2	16+72 to18+02-LDET-RT 17+88 to 17+98-LDET-RT 17+04 to 17+89-L-	ROADWAY FILL BANK STABILIZATION BRIDGE	< 0.01			< 0.01		< 0.01	< 0.01	25 43	31 85		
3	17+34 to 23+96-LDET-RT	ROADWAY FILL	0.11	0.27			0.08						
4	11+95 to 17+04-L-LT	ROADWAY FILL	0.08			0.06		< 0.01					
5	17+89 to 22+76-L-LT	ROADWAY FILL	0.04			0.05							
OTAL	C*-		0.23	0.27	0.02	0.14	0.08	0.18	0.03	68	116	0	

^{*}Rounded totals are sum of actual impacts

NOTES:

-Site 1: JS Non-Mit

-0.03 acre of temporary fill will be needed in the hand clearing areas for erosion control measures.

NC DEPARTMENT OF TRANSPORTATION DIVISION OF HIGHWAYS 3/11/2021 BRUNSWICK COUNTY B-5624 45579.2.1 SHEET

OF

14

14

Revised 2018 Feb

8 PROIE

BEGIN PROJECT B-5624 END PROJECT VICINITY MAP

STATE OF NORTH CAROLINA

DIVISION OF HIGHWAYS

UTILITIES BY OTHERS PLANS BRUNSWICK COUNTY

LOCATION: REPLACE BRIDGE NO.57 OVER DRIVING CREEK ON NC211 (GREEN SWAMP ROAD NW)

TYPE OF WORK: RELOCATION OF COMMUNICATION LINES

PERMIT DRAWING SHEET 1 OF 4

DATE: 3-11-2021


B-5624

SHEET NO. UO-1


(NOTE:

ALL UTILITY WORK SHOWN ON THIS SHEET WILL BE DONE BY OTHERS. NO PAYMENT WILL BE MADE TO THE CONTRACTOR FOR UTILITY WORK SHOWN ON THIS SHEET.

T.I.P. NO.

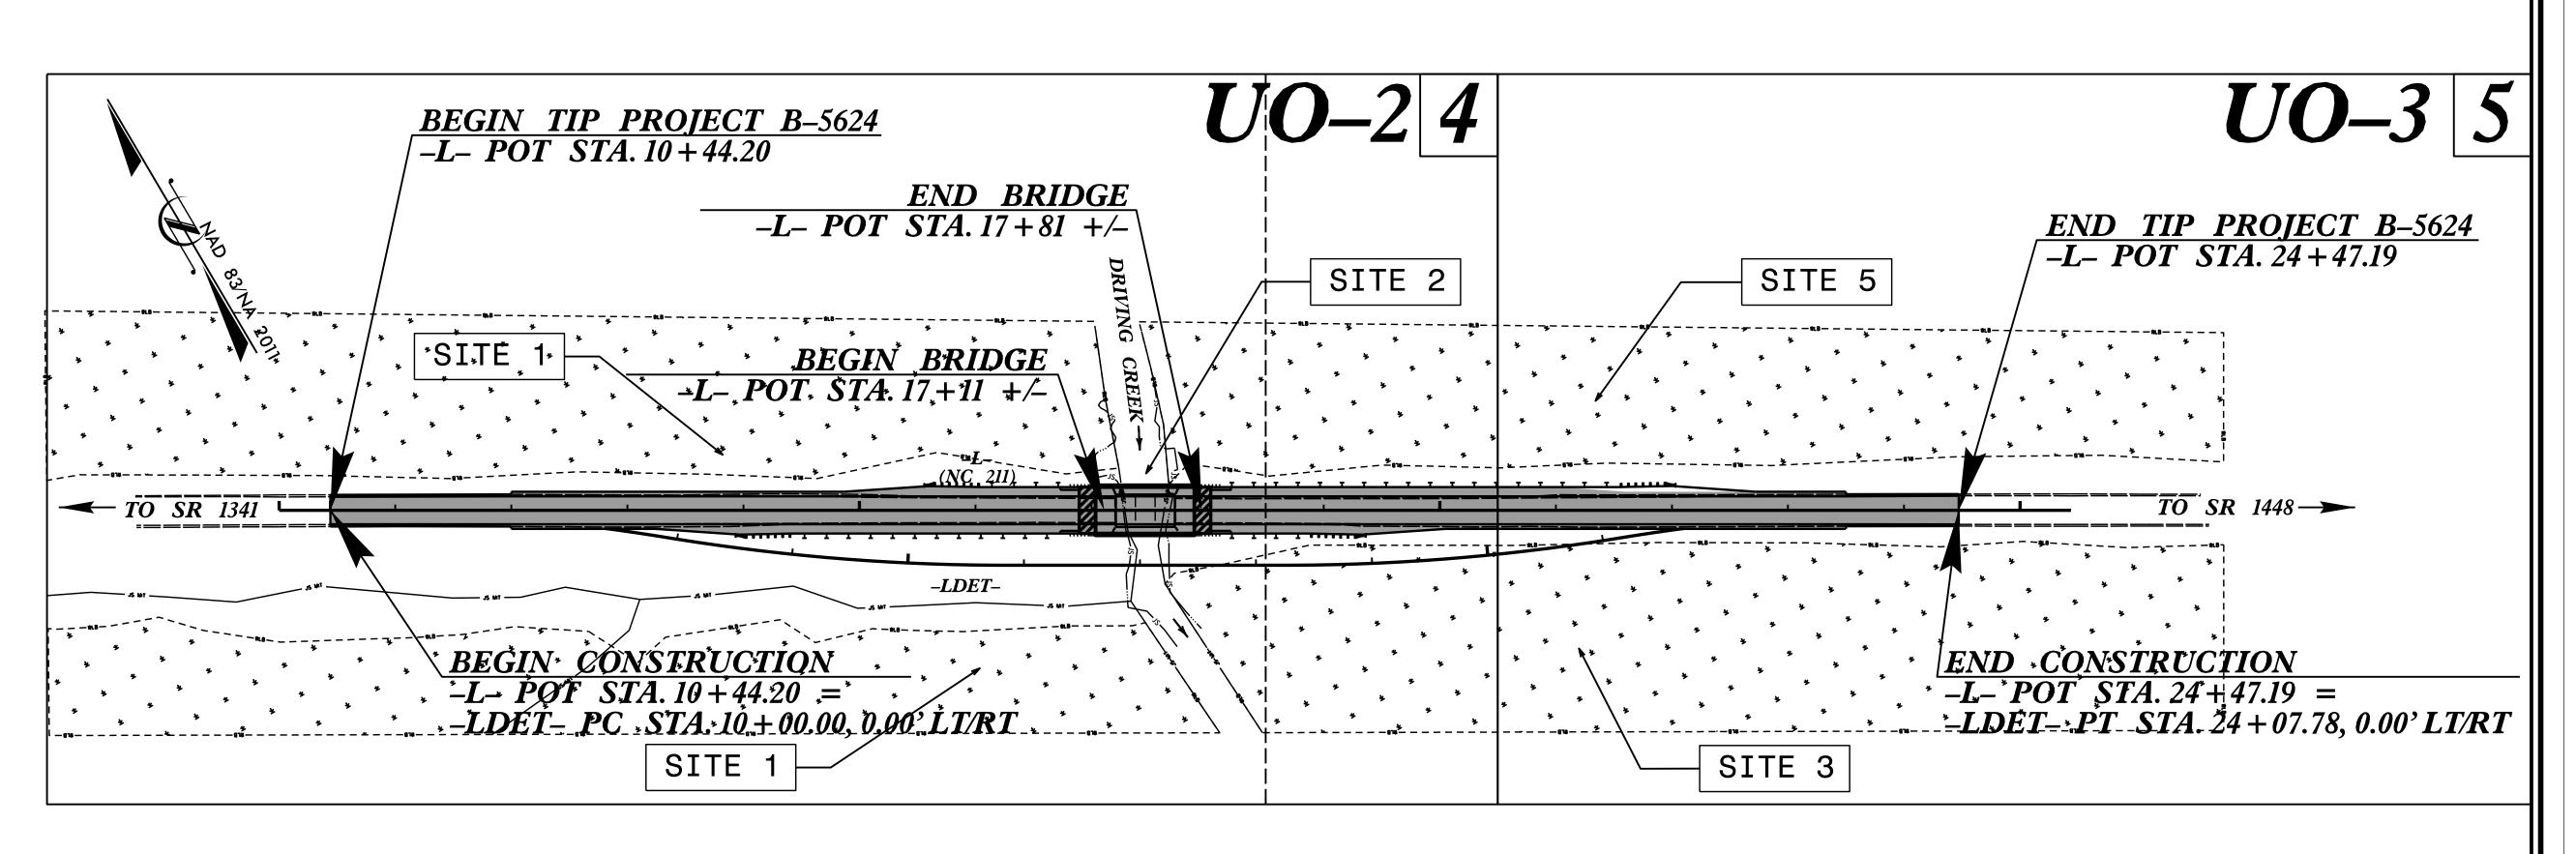

WETLAND AND SURFACE WATER IMPACTS PERMIT

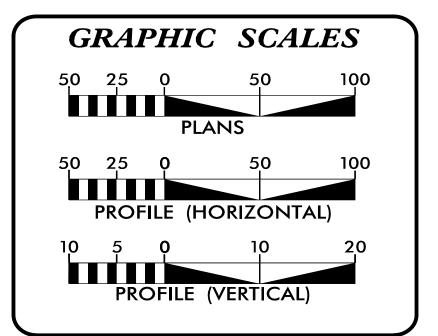

INDEX OF SHEETS

SHEET NO.: **DESCRIPTION:** *UO-1* TITLE SHEET **UO-02 THRU UO-03** UBO PLAN SHEETS

(A) AT&T - COMMUNICATIONS (B) ATMC - COMMUNICATIONS (C) MCNC - COMMUNICATIONS

UTILITY OWNERS WITH CONFLICTS

PREPARED IN THE OFFICE OF

Freddie Bunn

UTILITY PROJECT MANAGER PROJECT UTILITY COORDINATOR



DIVISION OF HIGHWAYS UTILITIES UNIT

1020 BIRCH RIDGE DR


RALEIGH NC 27610


PHONE (919) 707–6690

FAX (919) 250–4151

EASTERN UTILITIES MANAGER Kelvin Martin, EI SENIOR UTILITIES ENGINEER

Larry M. James, Jr. SENIOR UTILITY COORDINATOR

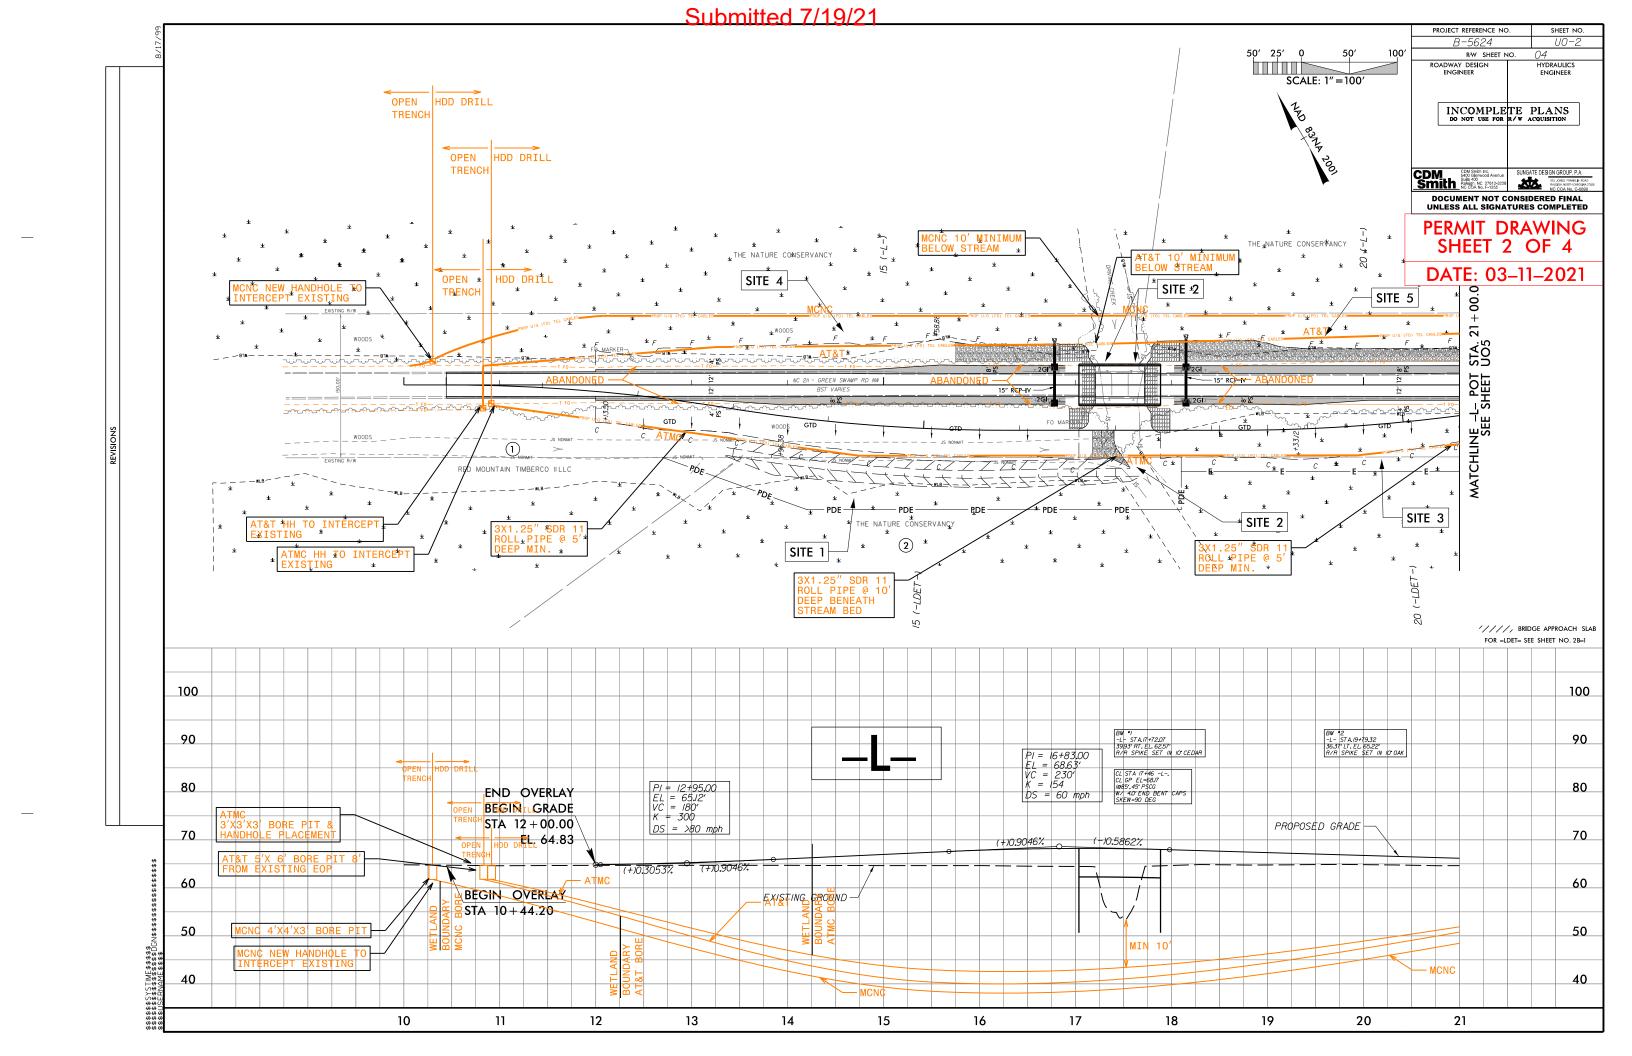

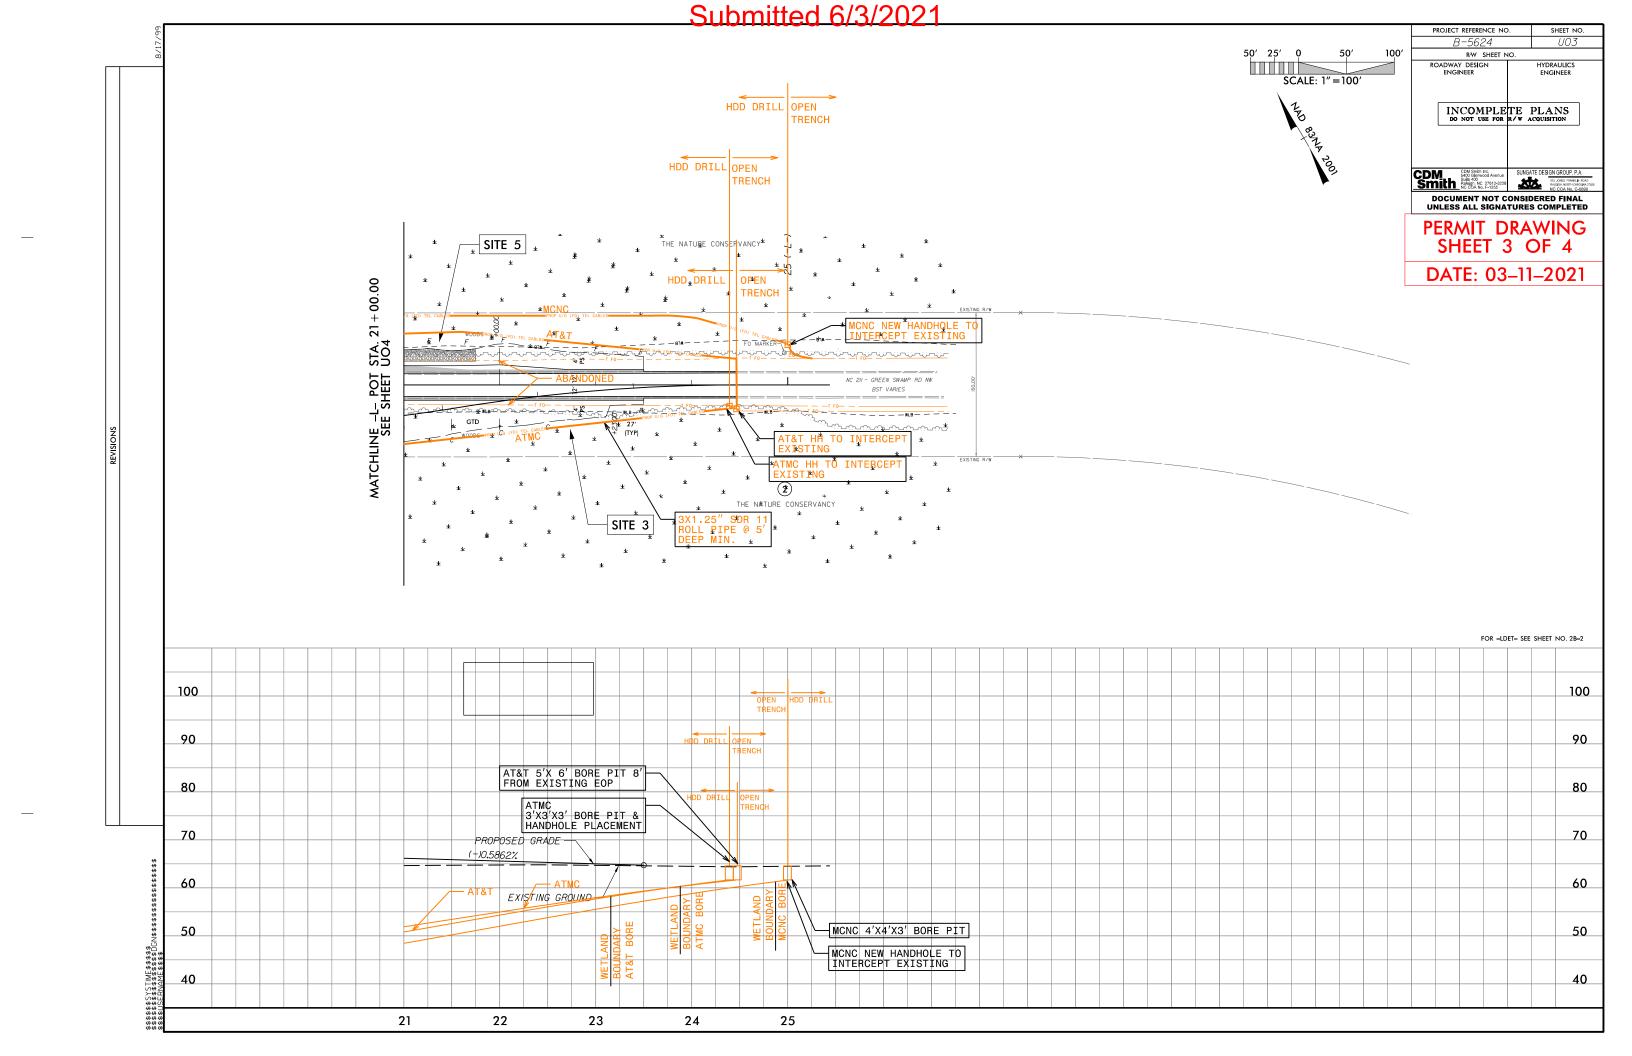

Submitted 6/3/2021

B-5624 NEU ENVIRONMENTAL PERMIT NARRATIVE

AT&T (Telephone): AT&T has an U/G fiber optic cable is in conflict throughout the project along the (North side) of NC 211 (Green Swamp Road). AT&T is encroaching within the NCDOT R/W.

AT&T will place a new U/G conduit (fiber optic) cable that follows along the (North side) of NC 211 (Green Swamp Road) inside the NCDOT R/W by directional bore and trenching. New cables will tie back into existing lines by placing two new handholes at the bore pit locations. Handhole locations are at -L- Sta. 10+82 +/- and -L- Sta. 24+39 +/-. This bore will produce no permanent impacts to the wetlands. All stations are approximate in this report. Contact: Mr. Yuri Moody; Email yuri.moody@genxcgroup.com, Phone 786-519-4809.

ATMC (Telephone): ATMC has an U/G fiber optic cable is in conflict throughout the project along the (South side) of NC 211 (Green Swamp Road). ATMC is encroaching within the NCDOT R/W.

ATMC will place a new U/G conduit (fiber optic) cable that follows along the (South side) of NC 211 (Green Swamp Road) inside the NCDOT R/W by directional bore and trenching. New cables will tie back into existing lines by placing two new handholes at the bore pit locations. Handhole locations are at -L- Sta. 10+82 +/- and -L- Sta. 24+39 +/-. This bore will produce no permanent impacts to the wetlands. All stations are approximate in this report. Contact: Mr. Michael Barry; Email bmichael@atmc.com; Phone 910-755-1709.

MCNC (Telephone): MCNC has an U/G fiber optic cable is in conflict throughout the project along the (North side) of NC 211 (Green Swamp Road). MCNC is encroaching within the NCDOT R/W.

MCNC will place a new U/G conduit (fiber optic) cable that follows along the (North side) of NC 211 (Green Swamp Road) inside the NCDOT R/W by directional bore and trenching. New cables will tie back into existing lines by placing two new handholes at the bore pit locations. Handhole locations are at -L- Sta. 10+30 +/- and -L- Sta. 25+05 +/-. This bore will produce no permanent impacts to the wetlands. All stations are approximate in this report. Contact: Mr. Brett Boger; Email brettboger@telics.com Phone 336-692-6477.

Conclusion (Total Impacts due to Utilities):

Permanent Fill in Wetlands 0.00 acres

Hand Clearing in Wetlands 0.00 acres



United States Department of the Interior

FISH AND WILDLIFE SERVICE
Raleigh ES Field Office
Post Office Box 33726
Raleigh, North Carolina 27636-3726
June 3, 2021



Philip S. Harris III, P.E. NC Department of Transportation Environmental Analysis Unit 1598 Mail Service Center Raleigh, North Carolina 27699-1598

Dear Mr. Harris:

This letter is in response to your letter of May 28, 2021 which provided the U.S. Fish and Wildlife Service (Service) with the biological conclusion of the North Carolina Department of Transportation that the replacement of Bridge No. 57 on NC 211 over Driving Creek in Brunswick County (STIP No. B-5624) may affect, but is not likely to adversely affect the federally threatened wood stork (*Mycteria americana*). The following response is provided in accordance with Section 7 of the Endangered Species Act (ESA) of 1973, as amended (16 U.S.C. 1531-1543).

According to your submitted information, a survey for wood storks was conducted on May 26, 2021. No wood storks or nests were observed. Based on the survey results and other available information, the Service concurs with your conclusion that the proposed action may affect, but is not likely to adversely the wood stork. It is understood that additional surveys will be conducted for the federally endangered rough-leaved loosestrife (*Lysimachia asperulaefolia*) and Cooley's meadowrue (*Thalictrum cooleyi*) during the appropriate survey windows (mid-May – September and mid-June – early July, respectively) prior to project construction to reconfirm the "no effect" conclusions for those species.

With the exception of the additional plant surveys, we believe that the requirements of Section 7(a)(2) of the ESA have been satisfied. We remind you that obligations under Section 7 consultation must be reconsidered if: (1) new information reveals impacts of this identified action that may affect listed species or critical habitat in a manner not previously considered in this review; (2) this action is subsequently modified in a manner that was not considered in this review; or (3) a new species is listed or critical habitat determined that may be affected by this identified action. If you have any questions regarding our response, please contact Mr. Gary Jordan at gary jordan@fws.gov.

Sincerely,

Lary Jordan for
Pete Benjamin
Field Supervisor

Electronic copy:

Brad Shaver, USACE, Wilmington, NC Travis Wilson, NCWRC, Creedmoor, NC Chris Rivenbark, NCDOT, Raleigh, NC Gordon Cashin, NCDOT, Raleigh, NC