

REFERENCE: U-5808

PROJECT: 44381

CONTENTS

<u>SHEET NO.</u>	<u>DESCRIPTION</u>
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STATE OF NORTH CAROLINA
 DEPARTMENT OF TRANSPORTATION
 DIVISION OF HIGHWAYS
 GEOTECHNICAL ENGINEERING UNIT

STRUCTURE
SUBSURFACE INVESTIGATION

COUNTY UNION
 PROJECT DESCRIPTION CHESTNUT LANE CONNECTOR
(SR 1362) FROM MATTHEWS INDIAN TRAIL ROAD
(SR 1367) TO GRIBBLE ROAD (SR 1368)
 SITE DESCRIPTION BRIDGE NO. 576 ON SR 1362
(CHESTNUT LANE CONNECTOR) OVER CSX
RAILROAD

STATE	STATE PROJECT REFERENCE NO.	SHEET NO.	TOTAL SHEETS
N.C.	U-5808	1	17

CAUTION NOTICE

THE SUBSURFACE INFORMATION AND THE SUBSURFACE INVESTIGATION ON WHICH IT IS BASED WERE MADE FOR THE PURPOSE OF STUDY, PLANNING AND DESIGN, AND NOT FOR CONSTRUCTION OR PAY PURPOSES. THE VARIOUS FIELD BORING LOGS, ROCK CORES AND SOIL TEST DATA AVAILABLE MAY BE REVIEWED OR INSPECTED IN RALEIGH BY CONTACTING THE N. C. DEPARTMENT OF TRANSPORTATION, GEOTECHNICAL ENGINEERING UNIT AT (919) 707-6850. THE SUBSURFACE PLANS AND REPORTS, FIELD BORING LOGS, ROCK CORES AND SOIL TEST DATA ARE NOT PART OF THE CONTRACT.

GENERAL SOIL AND ROCK STRATA DESCRIPTIONS AND INDICATED BOUNDARIES ARE BASED ON A GEOTECHNICAL INTERPRETATION OF ALL AVAILABLE SUBSURFACE DATA AND MAY NOT NECESSARILY REFLECT THE ACTUAL SUBSURFACE CONDITIONS BETWEEN BORINGS OR BETWEEN SAMPLED STRATA WITHIN THE BOREHOLE. THE LABORATORY SAMPLE DATA AND THE IN SITU (IN-PLACE) TEST DATA CAN BE RELIED ON ONLY TO THE DEGREE OF RELIABILITY INHERENT IN THE STANDARD TEST METHOD. THE OBSERVED WATER LEVELS OR SOIL MOISTURE CONDITIONS INDICATED IN THE SUBSURFACE INVESTIGATIONS ARE AS RECORDED AT THE TIME OF THE INVESTIGATION. THESE WATER LEVELS OR SOIL MOISTURE CONDITIONS MAY VARY CONSIDERABLY WITH TIME ACCORDING TO CLIMATIC CONDITIONS INCLUDING TEMPERATURES, PRECIPITATION AND WIND, AS WELL AS OTHER NON-CLIMATIC FACTORS.

THE BIDDER OR CONTRACTOR IS CAUTIONED THAT DETAILS SHOWN ON THE SUBSURFACE PLANS ARE PRELIMINARY ONLY AND IN MANY CASES THE FINAL DESIGN DETAILS ARE DIFFERENT. FOR BIDDING AND CONSTRUCTION PURPOSES, REFER TO THE CONSTRUCTION PLANS AND DOCUMENTS FOR FINAL DESIGN INFORMATION ON THIS PROJECT. THE DEPARTMENT DOES NOT WARRANT OR GUARANTEE THE SUFFICIENCY OR ACCURACY OF THE INVESTIGATION MADE, NOR THE INTERPRETATIONS MADE, OR OPINION OF THE DEPARTMENT AS TO THE TYPE OF MATERIALS AND CONDITIONS TO BE ENCOUNTERED. THE BIDDER OR CONTRACTOR IS CAUTIONED TO MAKE SUCH INDEPENDENT SUBSURFACE INVESTIGATIONS AS HE DEEMS NECESSARY TO SATISFY HIMSELF AS TO CONDITIONS TO BE ENCOUNTERED ON THE PROJECT. THE CONTRACTOR SHALL HAVE NO CLAIM FOR ADDITIONAL COMPENSATION OR FOR AN EXTENSION OF TIME FOR ANY REASON RESULTING FROM THE ACTUAL CONDITIONS ENCOUNTERED AT THE SITE DIFFERING FROM THOSE INDICATED IN THE SUBSURFACE INFORMATION.

- NOTES:
- THE INFORMATION CONTAINED HEREIN IS NOT IMPLIED OR GUARANTEED BY THE N. C. DEPARTMENT OF TRANSPORTATION AS ACCURATE NOR IS IT CONSIDERED PART OF THE PLANS, SPECIFICATIONS OR CONTRACT FOR THE PROJECT.
 - BY HAVING REQUESTED THIS INFORMATION, THE CONTRACTOR SPECIFICALLY WAIVES ANY CLAIMS FOR INCREASED COMPENSATION OR EXTENSION OF TIME BASED ON DIFFERENCES BETWEEN THE CONDITIONS INDICATED HEREIN AND THE ACTUAL CONDITIONS AT THE PROJECT SITE.

PERSONNEL

P. ZHANG

C. MEATYARD

C. TREMBLAY

INVESTIGATED BY WOOD E&S, INC.

DRAWN BY P. ZHANG

CHECKED BY S. JOHNSON

SUBMITTED BY P. ZHANG

DATE OCTOBER, 2018



DocuSigned by:
Pu Zhang 10/23/2018 5:15:05 AM
 SIGNATURE DATE


**DOCUMENT NOT CONSIDERED FINAL
 UNLESS ALL SIGNATURES COMPLETED**

NORTH CAROLINA DEPARTMENT OF TRANSPORTATION DIVISION OF HIGHWAYS GEOTECHNICAL ENGINEERING UNIT SUBSURFACE INVESTIGATION SOIL AND ROCK LEGEND, TERMS, SYMBOLS, AND ABBREVIATIONS

Main table containing 15 columns: SOIL DESCRIPTION, GRADATION, ROCK DESCRIPTION, TERMS AND DEFINITIONS, SOIL LEGEND AND AASHTO CLASSIFICATION, MINERALOGICAL COMPOSITION, COMPRESSION, PERCENTAGE OF MATERIAL, GROUND WATER, MISCELLANEOUS SYMBOLS, RECOMMENDATION SYMBOLS, ABBREVIATIONS, EQUIPMENT USED ON SUBJECT PROJECT, FRACTURE SPACING, BEDDING, INDURATION, and COLOR.

PROJECT REFERENCE NO.	SHEET NO.
U-5808	3
SITE PLAN	

3
 KILLOUGH FAMILY FARM 2I, LLC.
 DB 5867 PG 694
 PC 1 PG 101

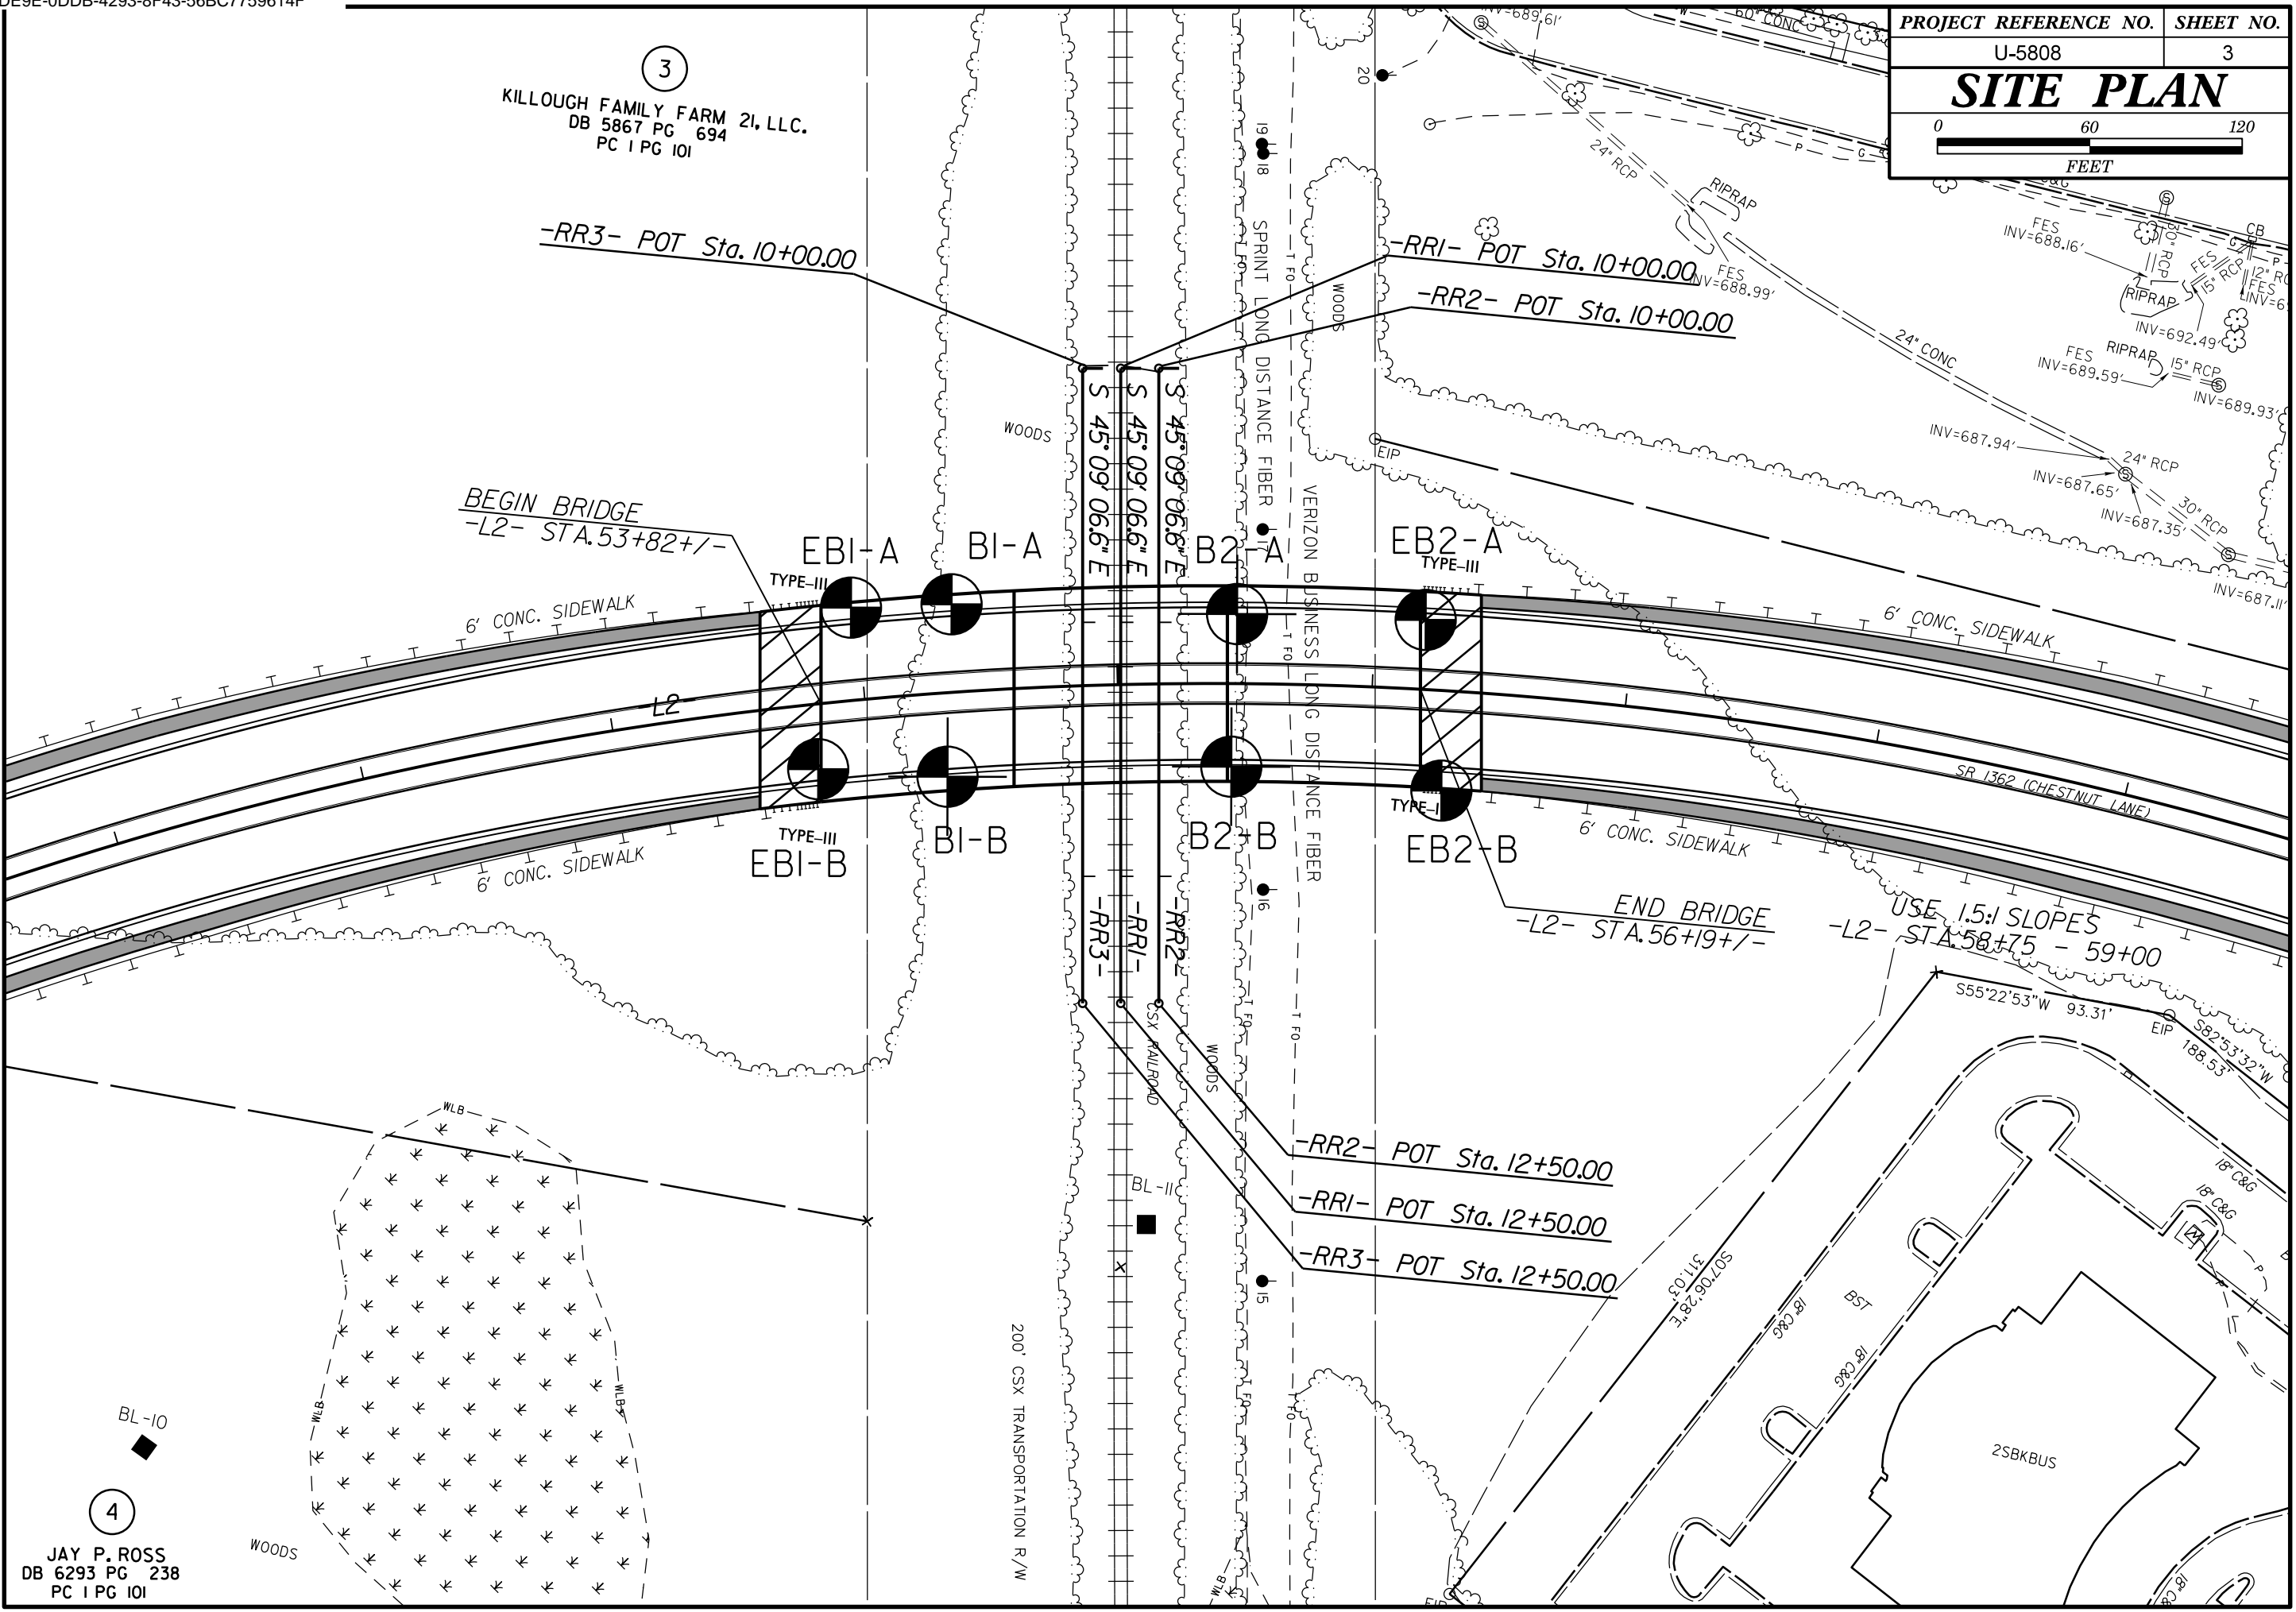

BEGIN BRIDGE
 -L2- STA. 53+82+/-


-RR1- POT Sta. 10+00.00
 -RR2- POT Sta. 10+00.00

END BRIDGE
 -L2- STA. 56+19+/-


-RR2- POT Sta. 12+50.00
 -RR1- POT Sta. 12+50.00
 -RR3- POT Sta. 12+50.00


4
 JAY P. ROSS
 DB 6293 PG 238
 PC 1 PG 101

BL-10

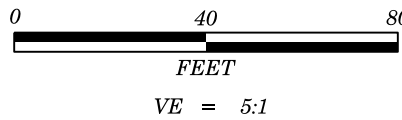

PROJECT REFERENCE NO.	SHEET NO.
U-5808	4
CHESTNUT LANE CONNECTOR BRIDGE OVER CSX RAILROAD -L- PROFILE	

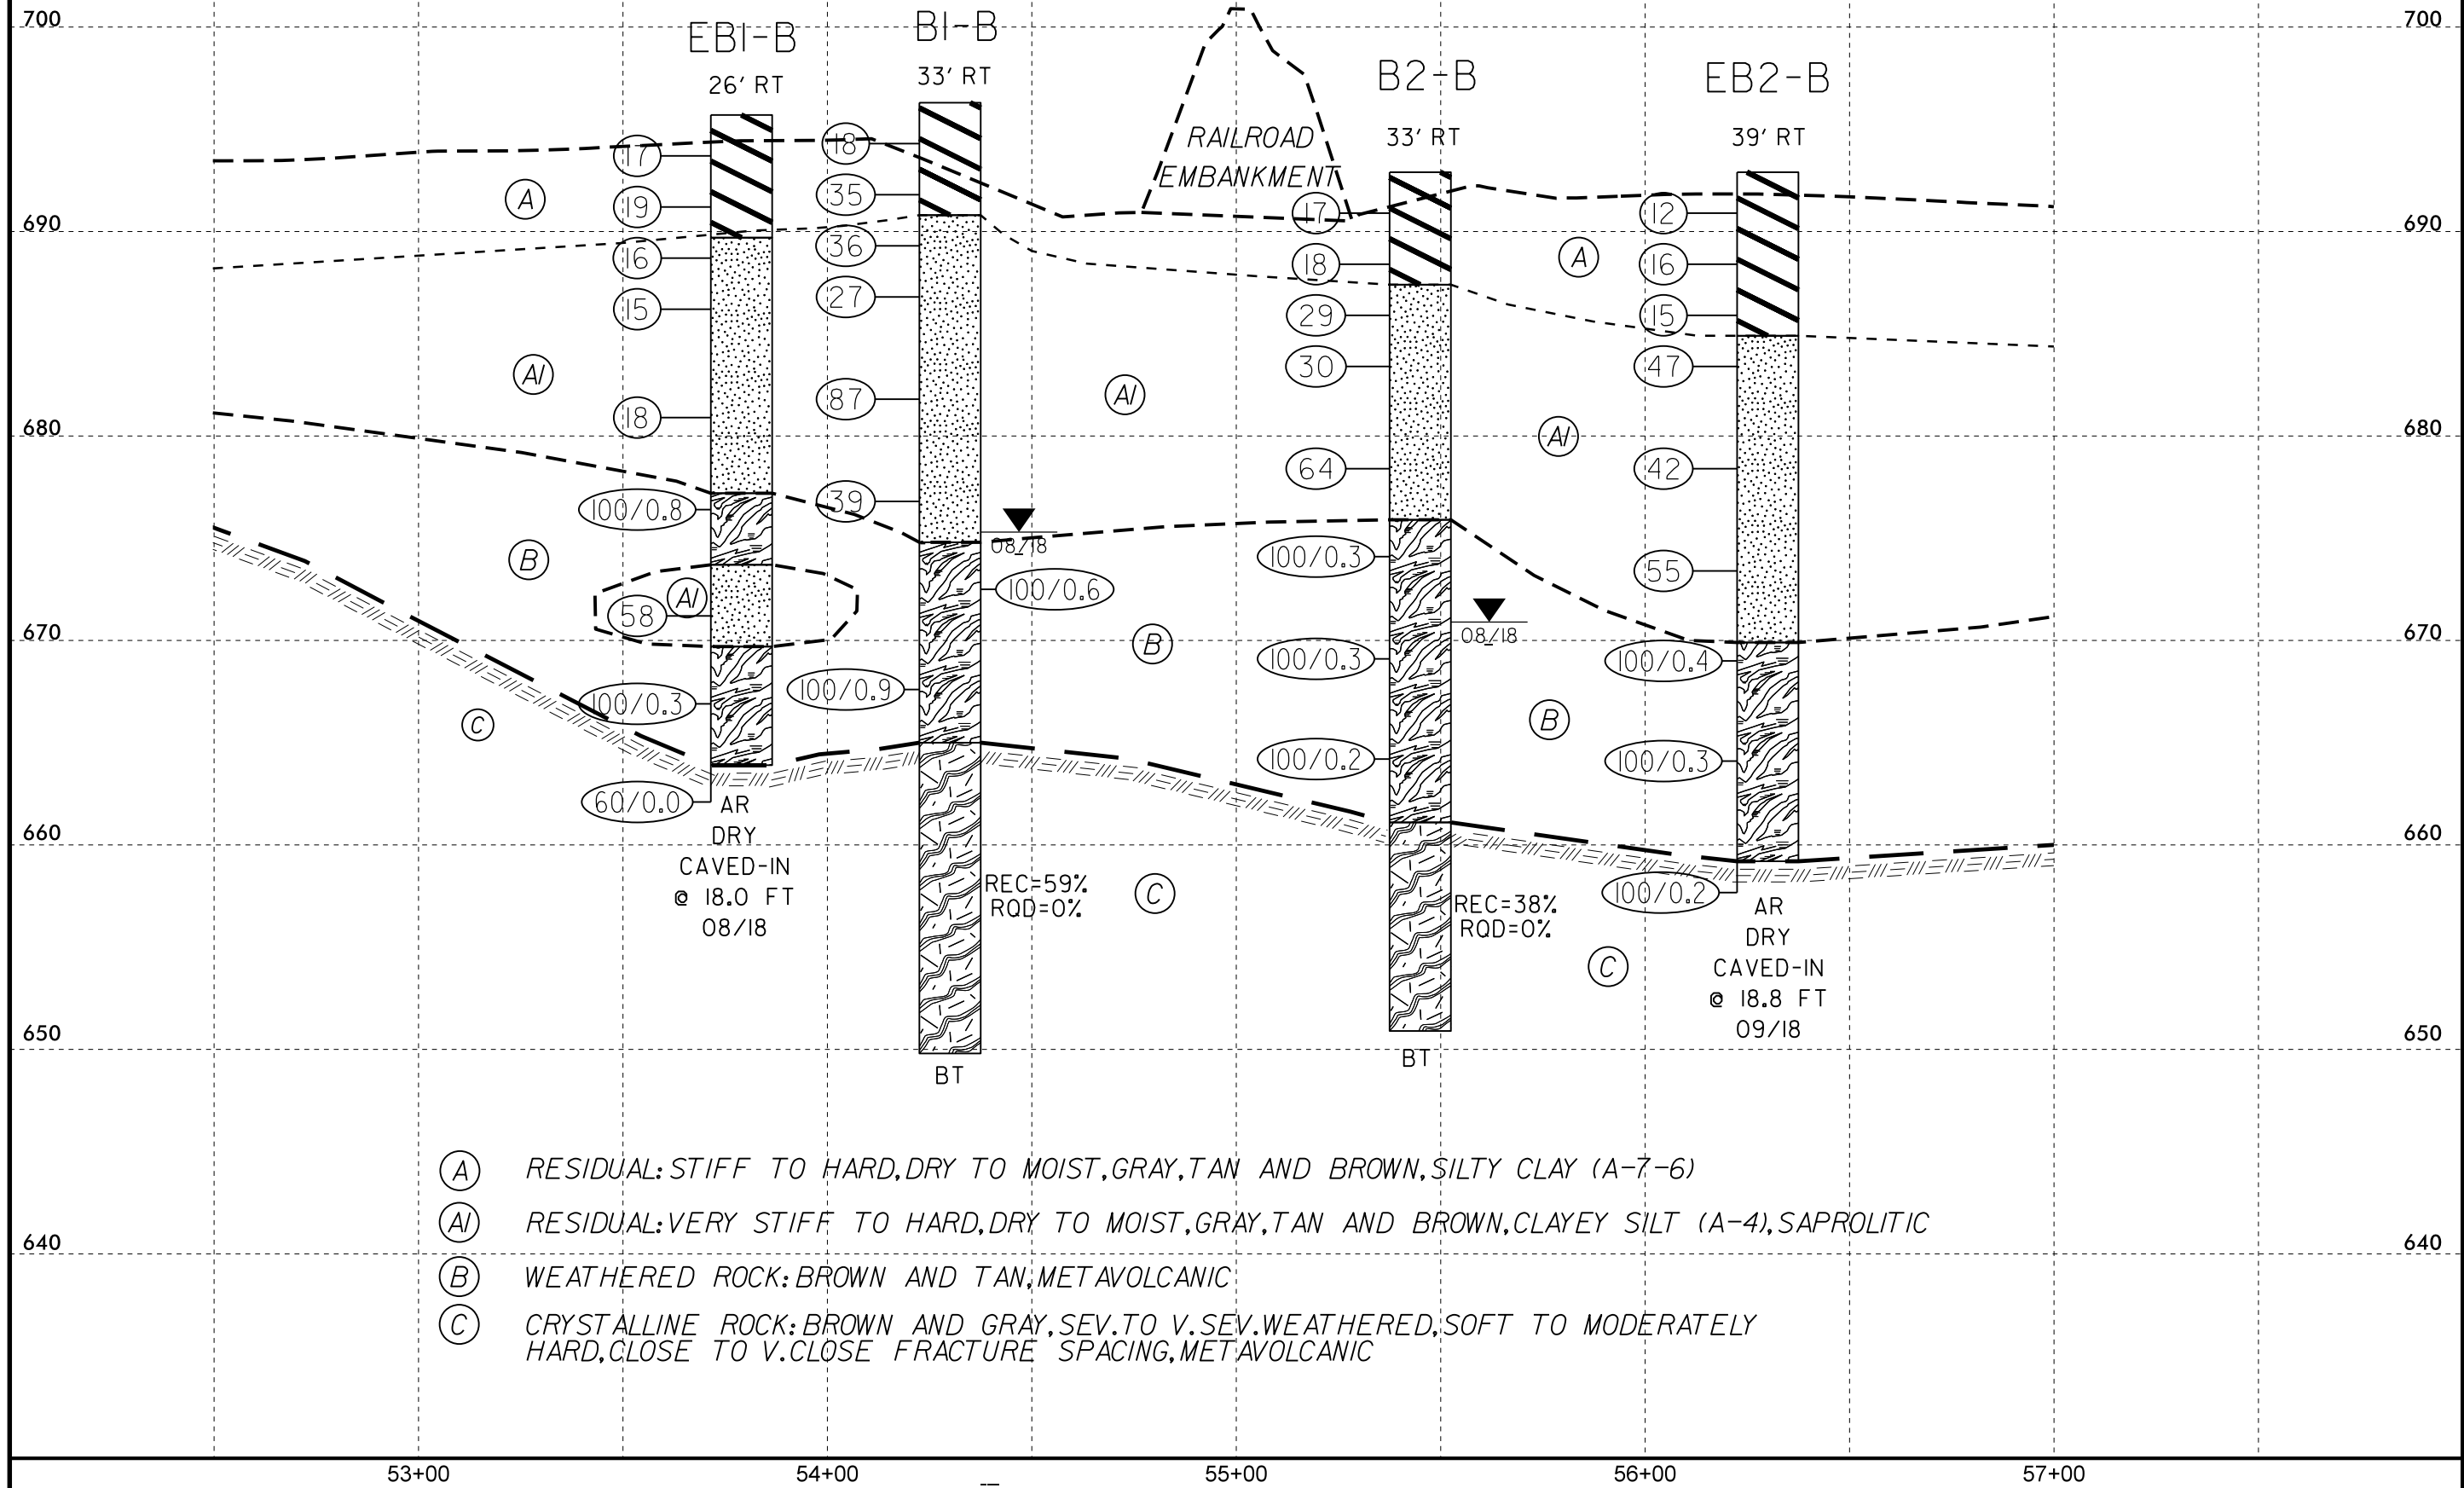

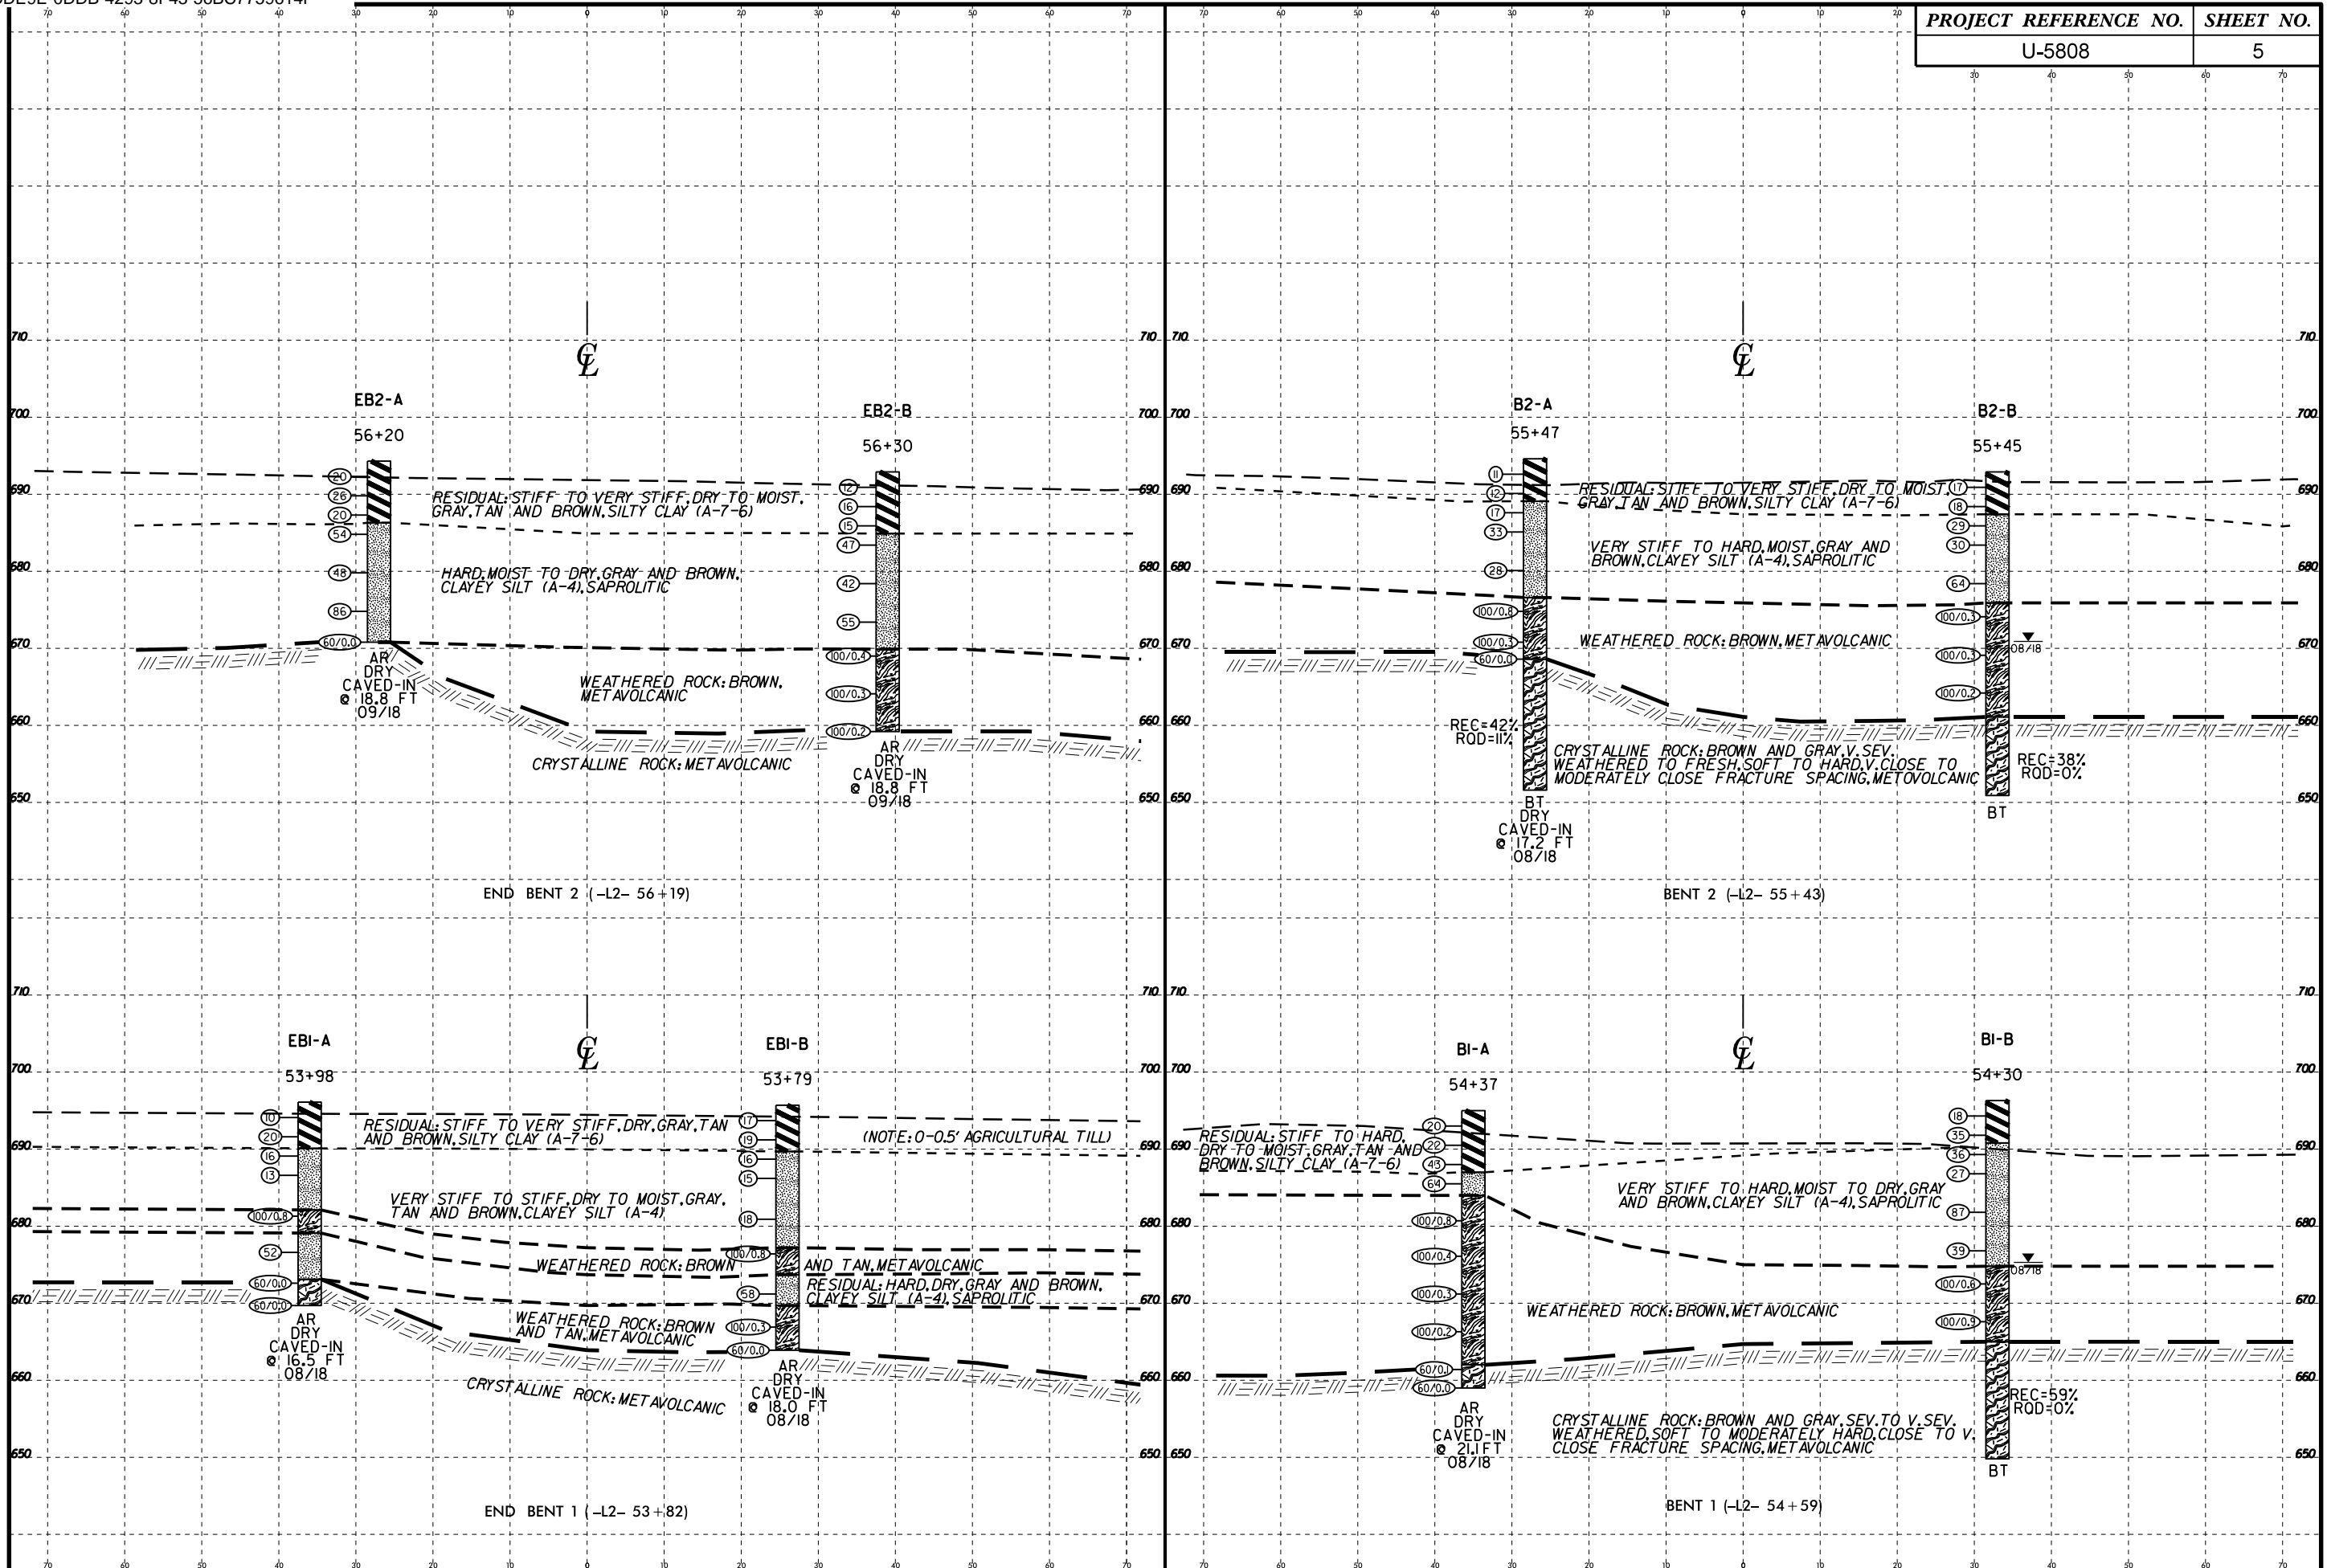

HORIZ. SCALE 0 20 40 (FEET) VE = 1:1

END BENT 1 CROSS SECTION
END BENT 2 CROSS SECTION

HORIZ. SCALE 0 20 40 (FEET) VE = 1:1

BENT 1 CROSS SECTION
BENT 2 CROSS SECTION

GEOTECHNICAL BORING REPORT

BORE LOG

WBS 44381.1.1		TIP U-5808		COUNTY UNION		GEOLOGIST C. Tremblay									
SITE DESCRIPTION Bridge No. 576 on SR 1362 (Chestnut Lane Connector) over CSX Railroad							GROUND WTR (ft)								
BORING NO. EB1-A		STATION 53+98		OFFSET 36 ft LT		ALIGNMENT -L2-									
COLLAR ELEV. 696.1 ft		TOTAL DEPTH 26.4 ft		NORTHING 488,633		EASTING 1,499,549									
DRILL RIG/HAMMER EFF./DATE AME9553 CME-550X 80% 12/15/2017				DRILL METHOD H.S. Augers		HAMMER TYPE Automatic									
DRILLER C. Meatyard		START DATE 08/20/18		COMP. DATE 08/20/18		SURFACE WATER DEPTH N/A									
ELEV (ft)	DRIVE ELEV (ft)	DEPTH (ft)	BLOW COUNT			BLOWS PER FOOT					SAMP. NO.	LOG	SOIL AND ROCK DESCRIPTION	DEPTH (ft)	
			0.5ft	0.5ft	0.5ft	0	25	50	75	100					
700															
695	695.1	1.0	5	5	5									696.1	GROUND SURFACE
	692.6	3.5	5	11	9									690.1	RESIDUAL Gray and brown, silty CLAY (A-7-6) Note: 0-0.5' Agricultural Till
690	690.1	6.0	10	8	8									690.1	Tan and brown, clayey SILT (A-4)
	687.6	8.5	4	5	8									682.1	WEATHERED ROCK Brown and tan, METAVOLCANIC
685	682.6	13.5	5	27	73/0.3									679.1	RESIDUAL Gray and brown, clayey SILT (A-4), saprolitic
680	677.6	18.5	45	27	25									673.1	CRYSTALLINE ROCK METAVOLCANIC
675	672.6	23.5	60/0.0											669.7	Boring Terminated by Auger Refusal at Elevation 669.7 ft in Crystalline Rock: METAVOLCANIC
670	669.7	26.4	60/0.0												

WBS 44381.1.1		TIP U-5808		COUNTY UNION		GEOLOGIST C. Tremblay									
SITE DESCRIPTION Bridge No. 576 on SR 1362 (Chestnut Lane Connector) over CSX Railroad							GROUND WTR (ft)								
BORING NO. EB1-B		STATION 53+79		OFFSET 26 ft RT		ALIGNMENT -L2-									
COLLAR ELEV. 695.7 ft		TOTAL DEPTH 31.8 ft		NORTHING 488,579		EASTING 1,499,585									
DRILL RIG/HAMMER EFF./DATE AME9553 CME-550X 80% 12/15/2017				DRILL METHOD H.S. Augers		HAMMER TYPE Automatic									
DRILLER C. Meatyard		START DATE 08/20/18		COMP. DATE 08/20/18		SURFACE WATER DEPTH N/A									
ELEV (ft)	DRIVE ELEV (ft)	DEPTH (ft)	BLOW COUNT			BLOWS PER FOOT					SAMP. NO.	LOG	SOIL AND ROCK DESCRIPTION	DEPTH (ft)	
			0.5ft	0.5ft	0.5ft	0	25	50	75	100					
700															
695	694.7	1.0	7	7	10									695.7	GROUND SURFACE
	692.2	3.5	6	7	12									689.7	RESIDUAL Gray, tan, and brown, silty CLAY (A-7-6) Note: 0-0.5' Agricultural Till
690	689.7	6.0	5	8	8									689.7	Gray and brown, clayey SILT (A-4)
	687.2	8.5	6	6	9									682.1	WEATHERED ROCK Brown and tan, METAVOLCANIC
685	682.2	13.5	12	10	8									677.2	RESIDUAL Gray and brown, clayey SILT (A-4), saprolitic
680	677.2	18.5	65	35/0.3										673.1	WEATHERED ROCK Brown and tan, METAVOLCANIC
675	672.2	23.5	25	31	27									669.7	Boring Terminated by Auger Refusal at Elevation 669.7 ft in Crystalline Rock: METAVOLCANIC
670	667.2	28.5	100/0.3											663.9	Boring Terminated by Auger Refusal at Elevation 663.9 ft on Crystalline Rock: METAVOLCANIC
665	663.9	31.8	60/0.0												

NCDOT BORE DOUBLE U5808_GEO_RDWY AND BR.GPJ NC_DOT.GDT 10/23/18

GEOTECHNICAL BORING REPORT BORE LOG

WBS 44381.1.1		TIP U-5808		COUNTY UNION		GEOLOGIST C. Tremblay										
SITE DESCRIPTION Bridge No. 576 on SR 1362 (Chestnut Lane Connector) over CSX Railroad							GROUND WTR (ft)									
BORING NO. B1-A		STATION 54+37		OFFSET 35 ft LT		ALIGNMENT -L2-										
COLLAR ELEV. 695.0 ft		TOTAL DEPTH 36.0 ft		NORTHING 488,662		EASTING 1,499,576										
DRILL RIG/HAMMER EFF./DATE AME9553 CME-550X 80% 12/15/2017				DRILL METHOD H.S. Augers		HAMMER TYPE Automatic										
DRILLER C. Meatyard		START DATE 08/27/18		COMP. DATE 08/27/18		SURFACE WATER DEPTH N/A										
ELEV (ft)	DRIVE ELEV (ft)	DEPTH (ft)	BLOW COUNT			BLOWS PER FOOT					SAMP. NO.	LOG	SOIL AND ROCK DESCRIPTION			
			0.5ft	0.5ft	0.5ft	0	25	50	75	100			ELEV. (ft)	DEPTH (ft)		
695														695.0	GROUND SURFACE	0.0
	694.0	1.0	6	9	11								RESIDUAL Gray, tan, and brown, silty CLAY (A-7-6)			
690	691.5	3.5	8	10	12											
	689.0	6.0	12	18	25								687.0 Gray and brown, clayey SILT (A-4)			
685	686.5	8.5	20	31	33											
	681.5	13.5	29	43	57/0.3								WEATHERED ROCK Brown, METAVOLCANIC			
680	676.5	18.5	100/0.4													
	671.5	23.5	100/0.3										684.0 CRYSTALLINE ROCK Brown, METAVOLCANIC			
675	666.5	28.5	100/0.2													
	661.5	33.5	60/0.1										662.0 CRYSTALLINE ROCK Brown, METAVOLCANIC			
670	659.0	36.0	60/0.0													
													659.0 Boring Terminated by Auger Refusal at Elevation 659.0 ft in Crystalline Rock: METAVOLCANIC			
665																
													660/0.1 CRYSTALLINE ROCK Brown, METAVOLCANIC			
660																
													659.0 Boring Terminated by Auger Refusal at Elevation 659.0 ft in Crystalline Rock: METAVOLCANIC			
655																

NCDOT BORE SINGLE U5808 GEO_RDWY AND BR.GPJ NC_DOT.GDT 10/23/18

GEOTECHNICAL BORING REPORT

BORE LOG

WBS 44381.1.1		TIP U-5808		COUNTY UNION		GEOLOGIST C. Tremblay									
SITE DESCRIPTION Bridge No. 576 on SR 1362 (Chestnut Lane Connector) over CSX Railroad							GROUND WTR (ft)								
BORING NO. B1-B		STATION 54+30		OFFSET 33 ft RT		ALIGNMENT -L2-									
COLLAR ELEV. 696.3 ft		TOTAL DEPTH 46.5 ft		NORTHING 488,613		EASTING 1,499,623									
DRILL RIG/HAMMER EFF./DATE AME9553 CME-550X 80% 12/15/2017		DRILL METHOD H.S. Augers		HAMMER TYPE Automatic											
DRILLER C. Meatyard		START DATE 08/22/18		COMP. DATE 08/24/18		SURFACE WATER DEPTH N/A									
ELEV (ft)	DRIVE ELEV (ft)	DEPTH (ft)	BLOW COUNT			BLOWS PER FOOT				SAMP. NO.	LOG MOI	LOG	SOIL AND ROCK DESCRIPTION		
			0.5ft	0.5ft	0.5ft	0	25	50	75				100	ELEV. (ft)	DEPTH (ft)
700															
695	695.3	1.0	8	8	10									696.3	0.0
	692.8	3.5	12	14	21										
690	690.3	6.0	8	18	18									690.8	5.5
	687.8	8.5	7	11	16										
685															
	682.8	13.5	27	33	54										
680															
	677.8	18.5	26	18	21										
675														674.8	21.5
	672.8	23.5	86	14/0.1											
670															
	667.8	28.5	41	59/0.4											
665														664.8	31.5
660															
655															
650														649.8	46.5


NCDOT BORE SINGLE U5808_GEO_RDWY AND BR.GPJ NC_DOT.GDT 10/23/18

GEOTECHNICAL BORING REPORT

CORE LOG

WBS 44381.1.1		TIP U-5808		COUNTY UNION		GEOLOGIST C. Tremblay						
SITE DESCRIPTION Bridge No. 576 on SR 1362 (Chestnut Lane Connector) over CSX Railroad							GROUND WTR (ft)					
BORING NO. B1-B		STATION 54+30		OFFSET 33 ft RT		ALIGNMENT -L2-						
COLLAR ELEV. 696.3 ft		TOTAL DEPTH 46.5 ft		NORTHING 488,613		EASTING 1,499,623						
DRILL RIG/HAMMER EFF./DATE AME9553 CME-550X 80% 12/15/2017		DRILL METHOD H.S. Augers		HAMMER TYPE Automatic								
DRILLER C. Meatyard		START DATE 08/22/18		COMP. DATE 08/24/18		SURFACE WATER DEPTH N/A						
CORE SIZE NQ Core			TOTAL RUN 15.0 ft									
ELEV (ft)	RUN ELEV (ft)	DEPTH (ft)	RUN (ft)	DRILL RATE (Min/ft)	RUN		SAMP. NO.	STRATA		LOG	DESCRIPTION AND REMARKS	
					REC. (%)	RQD (%)		REC. (%)	RQD (%)		ELEV. (ft)	DEPTH (ft)
664.8	664.8	31.5	5.0	4:00/1.0 4:00/1.0 4:00/1.0 8:00/1.0 9:00/1.0	(2.3) 46%	(0.0) 0%		(8.9) 59%	(0.0) 0%			Begin Coring @ 31.5 ft
660	659.8	36.5	5.0	18:00/1.0 10:00/1.0 16:00/1.0 6:00/1.0 8:00/1.0	(3.6) 72%	(0.0) 0%						CRYSTALLINE ROCK Brown and gray, sev. to v. sev. weathered, soft to moderately hard, close to v. close fracture spacing, METAVOLCANIC
655	654.8	41.5	5.0	13:00/1.0 13:00/1.0 5:00/1.0 6:00/1.0 8:00/1.0	(3.0) 60%	(0.0) 0%						
650	649.8	46.5										Boring Terminated at Elevation 649.8 ft in Crystalline Rock: METAVOLCANIC

NCDOT CORE SINGLE U5808_GEO_RDWY AND BR.GPJ NC_DOT.GDT 10/23/18

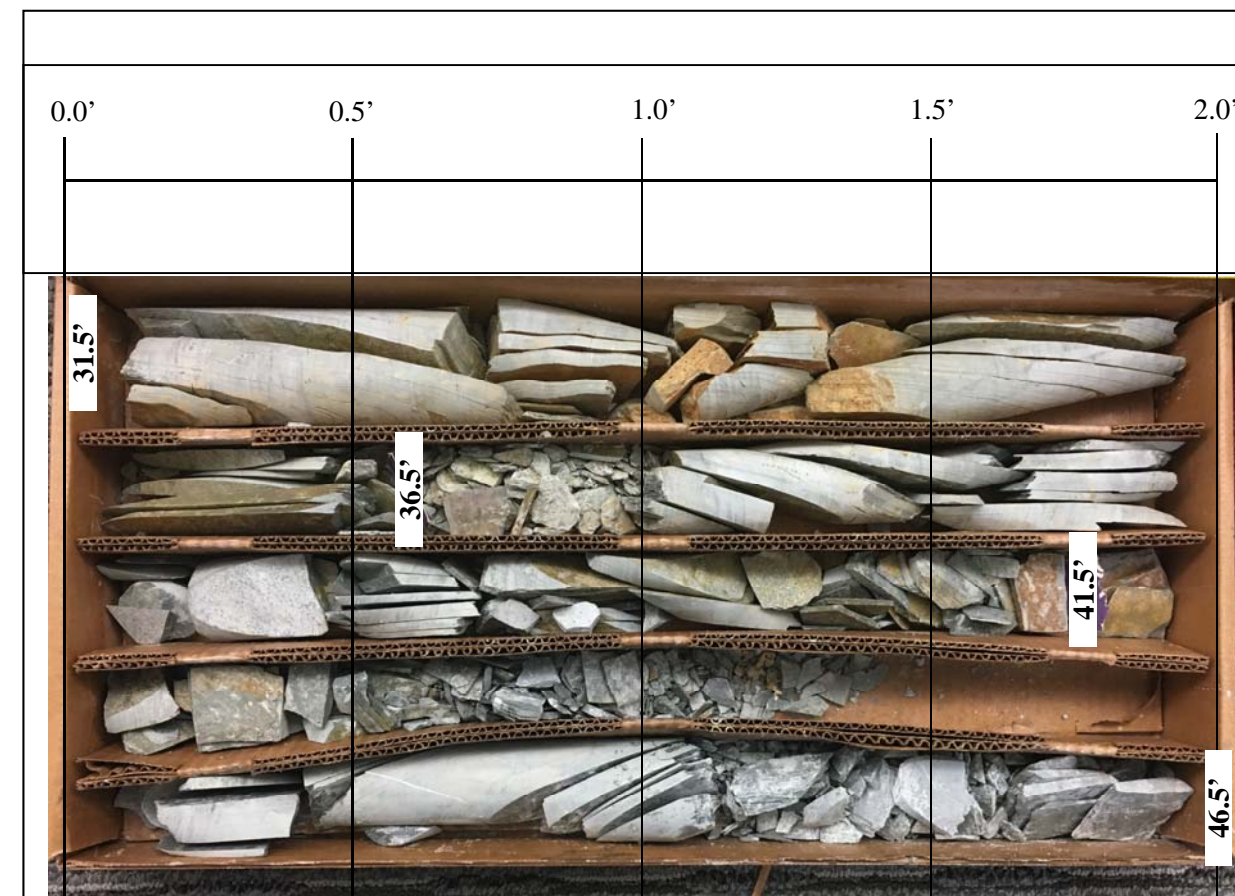

B1-B, Box 1 of 1, 31.5 feet to 46.5 feet.

SCALE 1:40 (1"=4")

ROCK CORE PHOTOGRAPHS

**CHESTNUT LANE CONNECTOR (SR1362)
BRIDGE OVER CSX RR
UNION COUNTY, NORTH CAROLINA
WBS NO.: 44381.1.1, TIP NO.: U-5808**



Wood Environment & Infrastructure Solutions, Inc. 1600
4021 Stirrup Creek Drive, Suite 100
Durham, North Carolina 27703
Tel : (919) 381-9900 Fax: (919) 381-9901

GEOTECHNICAL BORING REPORT

BORE LOG

GEOTECHNICAL BORING REPORT


CORE LOG

WBS 44381.1.1		TIP U-5808		COUNTY UNION		GEOLOGIST C. Tremblay										
SITE DESCRIPTION Bridge No. 576 on SR 1362 (Chestnut Lane Connector) over CSX Railroad							GROUND WTR (ft)									
BORING NO. B2-A		STATION 55+47		OFFSET 27 ft LT		ALIGNMENT -L2-										
COLLAR ELEV. 694.6 ft		TOTAL DEPTH 43.0 ft		NORTHING 488,739		EASTING 1,499,658										
DRILL RIG/HAMMER EFF./DATE AME9553 CME-550X 80% 12/15/2017				DRILL METHOD H.S. Augers		HAMMER TYPE Automatic										
DRILLER C. Meatyard		START DATE 08/30/18		COMP. DATE 08/30/18		SURFACE WATER DEPTH N/A										
ELEV (ft)	DRIVE ELEV (ft)	DEPTH (ft)	BLOW COUNT			BLOWS PER FOOT					SAMP. NO.	LOG	SOIL AND ROCK DESCRIPTION			
			0.5ft	0.5ft	0.5ft	0	25	50	75	100			ELEV. (ft)	DEPTH (ft)		
695														694.6	0.0	GROUND SURFACE
	693.6	1.0	6	6	5								D			RESIDUAL
	691.1	3.5	4	5	7								M			Gray, tan, and brown, silty CLAY (A-7-6)
690	688.6	6.0	6	9	8								M			Gray and brown, clayey SILT (A-4), saprolitic
	686.1	8.5	9	15	18								M			
685	681.1	13.5	8	13	15								M			
680	676.1	18.5	35	39	61/0.3									676.6	18.0	WEATHERED ROCK
	671.1	23.5	100/0.3													Brown, METAVOLCANIC
	668.6	26.0	60/0.0											668.6	26.0	CRYSTALLINE ROCK
665																Brown and gray, METAVOLCANIC
660																
655														651.6	43.0	Boring Terminated at Elevation 651.6 ft in Crystalline Rock: METAVOLCANIC

WBS 44381.1.1		TIP U-5808		COUNTY UNION		GEOLOGIST C. Tremblay							
SITE DESCRIPTION Bridge No. 576 on SR 1362 (Chestnut Lane Connector) over CSX Railroad							GROUND WTR (ft)						
BORING NO. B2-A		STATION 55+47		OFFSET 27 ft LT		ALIGNMENT -L2-							
COLLAR ELEV. 694.6 ft		TOTAL DEPTH 43.0 ft		NORTHING 488,739		EASTING 1,499,658							
DRILL RIG/HAMMER EFF./DATE AME9553 CME-550X 80% 12/15/2017				DRILL METHOD H.S. Augers		HAMMER TYPE Automatic							
DRILLER C. Meatyard		START DATE 08/30/18		COMP. DATE 08/30/18		SURFACE WATER DEPTH N/A							
CORE SIZE NQ Core			TOTAL RUN 17.0 ft										
ELEV (ft)	RUN ELEV (ft)	DEPTH (ft)	RUN (ft)	DRILL RATE (Min/ft)	RUN		SAMP. NO.	STRATA		LOG	DESCRIPTION AND REMARKS		
					REC. (%)	RQD (%)		REC. (%)	RQD (%)		ELEV. (ft)	DEPTH (ft)	
668.6	668.6	26.0	5.0	N=60/0.0 4:00/1.0 6:00/1.0 4:00/1.0 4:00/1.0	(1.8)	(0.0)		(7.2)	(1.8)		668.6	26.0	Begin Coring @ 26.0 ft CRYSTALLINE ROCK Brown and gray, v. sev. weathered to fresh, soft to hard, v. close to moderately close fracture spacing, METAVOLCANIC
665	663.6	31.0	5.0	4:00/1.0 4:00/1.0 4:00/1.0									
			5.0	3:00/1.0 5:00/1.0 5:00/1.0 4:00/1.0 3:00/1.0	(1.6)	(0.0)							
660	658.6	36.0	5.0	6:00/1.0 8:00/1.0 5:00/1.0 6:00/1.0 8:00/1.0	(1.9)	(0.0)							
			5.0	6:00/1.0 8:00/1.0 5:00/1.0 6:00/1.0 8:00/1.0	38%	0%							
655	653.6	41.0	2.0	3:00/1.0 4:00/0.0	(1.9)	(1.8)							
	651.6	43.0			95%	90%					651.6	43.0	Boring Terminated at Elevation 651.6 ft in Crystalline Rock: METAVOLCANIC

NCDOT BORE SINGLE U5808_GEO_RDWY AND BR.GPJ NC_DOT.GDT 10/23/18

NCDOT CORE SINGLE U5808_GEO_RDWY AND BR.GPJ NC_DOT.GDT 10/23/18

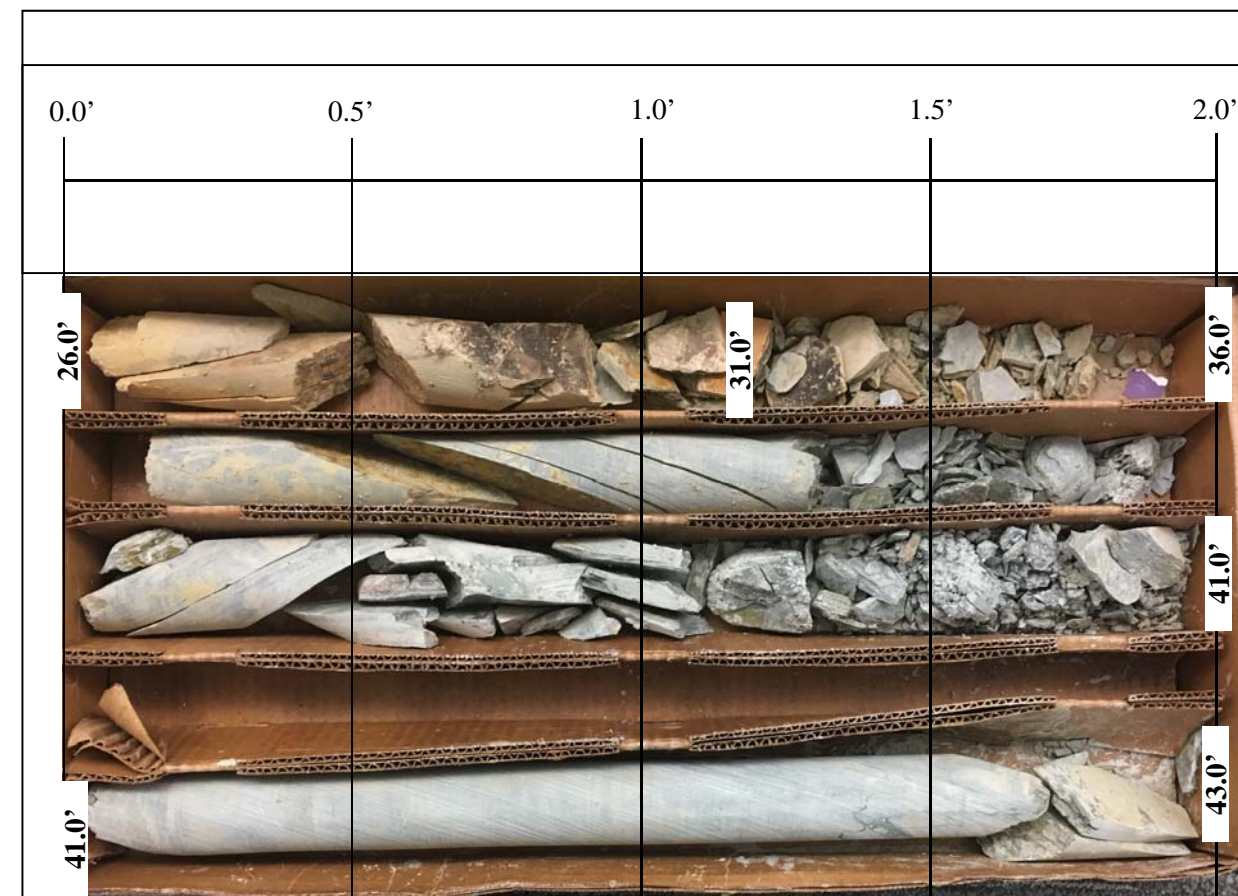

B2-A, Box 1 of 1, 26.0 feet to 43.0 feet.

SCALE 1:40 (1"=4")

ROCK CORE PHOTOGRAPHS

**CHESTNUT LANE CONNECTOR (SR1362)
BRIDGE OVER CSX RR
UNION COUNTY, NORTH CAROLINA
WBS NO.: 44381.1.1, TIP NO.: U-5808**



Wood Environment & Infrastructure Solutions, Inc. 1600
4021 Stirrup Creek Drive, Suite 100
Durham, North Carolina 27703
Tel : (919) 381-9900 Fax: (919) 381-9901

GEOTECHNICAL BORING REPORT

BORE LOG

WBS 44381.1.1		TIP U-5808		COUNTY UNION		GEOLOGIST C. Tremblay										
SITE DESCRIPTION Bridge No. 576 on SR 1362 (Chestnut Lane Connector) over CSX Railroad							GROUND WTR (ft)									
BORING NO. B2-B		STATION 55+45		OFFSET 33 ft RT		ALIGNMENT -L2-										
COLLAR ELEV. 692.9 ft		TOTAL DEPTH 42.0 ft		NORTHING 488,695		EASTING 1,499,699										
DRILL RIG/HAMMER EFF./DATE AME9553 CME-550X 80% 12/15/2017				DRILL METHOD H.S. Augers		HAMMER TYPE Automatic										
DRILLER C. Meatyard		START DATE 08/28/18		COMP. DATE 08/29/18		SURFACE WATER DEPTH N/A										
ELEV (ft)	DRIVE ELEV (ft)	DEPTH (ft)	BLOW COUNT			BLOWS PER FOOT					SAMP. NO.	LOG	SOIL AND ROCK DESCRIPTION			
			0.5ft	0.5ft	0.5ft	0	25	50	75	100			ELEV. (ft)	DEPTH (ft)		
695																
	691.9	1.0	7	8	9									692.9	0.0	GROUND SURFACE
690	689.4	3.5	6	8	10								D	687.4	5.5	RESIDUAL Gray, tan, and brown, silty CLAY (A-7-6)
	686.9	6.0	9	13	16								D			
685	684.4	8.5	8	14	16								M			Gray and brown, clayey SILT (A-4), saprolitic
	679.4	13.5	16	17	47								M			
680	674.4	18.5	100/0.3										M	675.9	17.0	WEATHERED ROCK Brown, METAVOLCANIC
675	669.4	23.5	100/0.3													
670	664.4	28.5	100/0.2													
665																
660														660.9	32.0	CRYSTALLINE ROCK Brown and gray, METAVOLCANIC
655														650.9	42.0	Boring Terminated at Elevation 650.9 ft in Crystalline Rock: METAVOLCANIC


NCDOT BORE SINGLE U5808_GEO_RDWY AND BR.GPJ NC_DOT.GDT 10/23/18

GEOTECHNICAL BORING REPORT

CORE LOG

WBS 44381.1.1		TIP U-5808		COUNTY UNION		GEOLOGIST C. Tremblay						
SITE DESCRIPTION Bridge No. 576 on SR 1362 (Chestnut Lane Connector) over CSX Railroad							GROUND WTR (ft)					
BORING NO. B2-B		STATION 55+45		OFFSET 33 ft RT		ALIGNMENT -L2-						
COLLAR ELEV. 692.9 ft		TOTAL DEPTH 42.0 ft		NORTHING 488,695		EASTING 1,499,699						
DRILL RIG/HAMMER EFF./DATE AME9553 CME-550X 80% 12/15/2017				DRILL METHOD H.S. Augers		HAMMER TYPE Automatic						
DRILLER C. Meatyard		START DATE 08/28/18		COMP. DATE 08/29/18		SURFACE WATER DEPTH N/A						
CORE SIZE NQ Core				TOTAL RUN 10.0 ft								
ELEV (ft)	RUN ELEV (ft)	DEPTH (ft)	RUN (ft)	DRILL RATE (Min/ft)	RUN		SAMP. NO.	STRATA		LOG	DESCRIPTION AND REMARKS	
					REC. (%)	RQD (%)		REC. (%)	RQD (%)		ELEV. (ft)	DEPTH (ft)
660.9	660.9	32.0	5.0	4:00/1.0 6:00/1.0 5:00/1.0 6:00/1.0 7:00/1.0	(1.6)	(0.0)		(3.8)	(0.0)			Begin Coring @ 32.0 ft
660					32%	0%		38%	0%			CRYSTALLINE ROCK Brown and gray, sev. to v. sev. weathered, soft to moderately hard, close to v. close fracture spacing, METAVOLCANIC
655	655.9	37.0	5.0	6:00/1.0 7:00/1.0 5:00/1.0 8:00/1.0 7:00/1.0	(2.2)	(0.0)						
					44%	0%						
	650.9	42.0										Boring Terminated at Elevation 650.9 ft in Crystalline Rock: METAVOLCANIC

NCDOT CORE SINGLE U5808_GEO_RDWY AND BR.GPJ NC_DOT.GDT 10/23/18

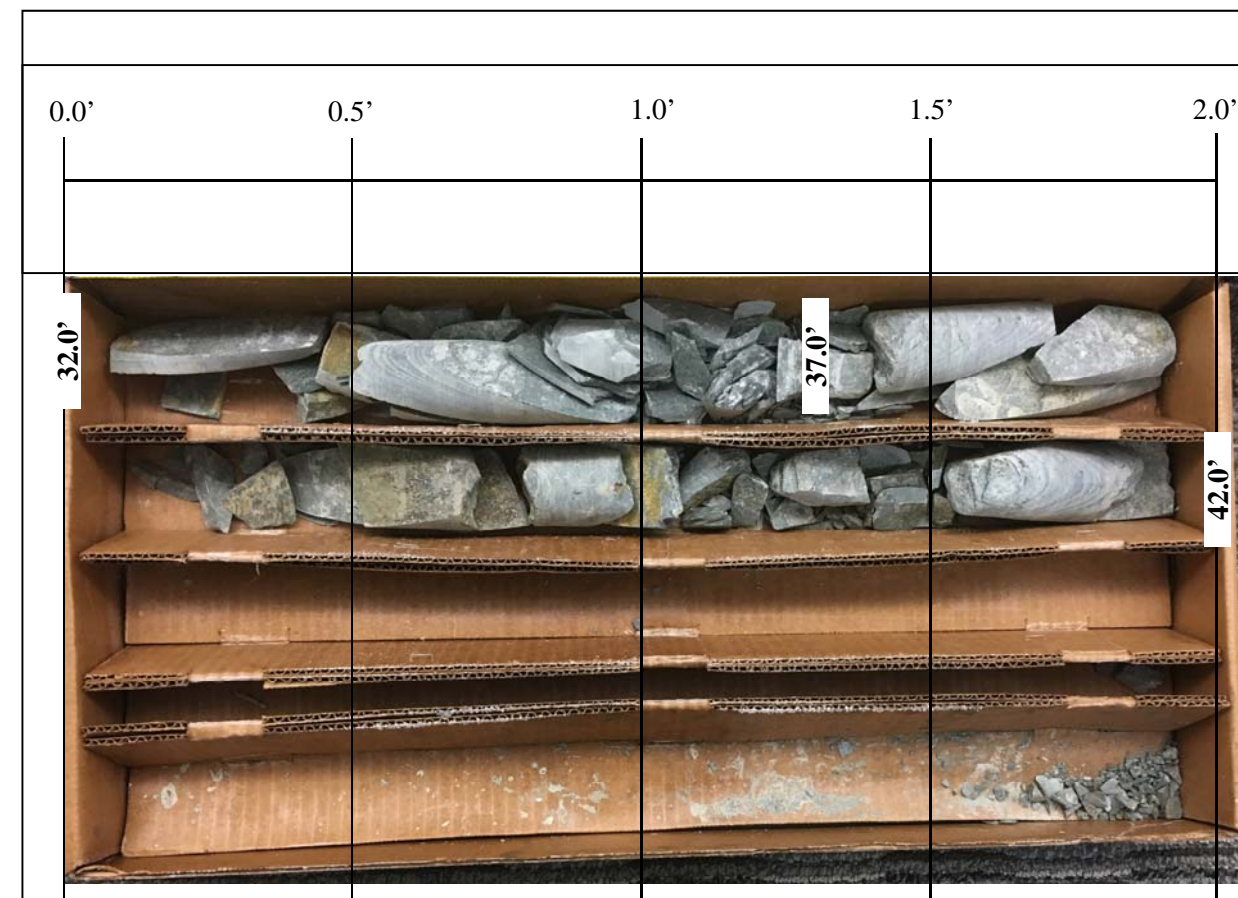

B2-B, Box 1 of 1, 32.0 feet to 42.0 feet.

SCALE 1:40 (1"=4")

ROCK CORE PHOTOGRAPHS

**CHESTNUT LANE CONNECTOR (SR1362)
BRIDGE OVER CSX RR
UNION COUNTY, NORTH CAROLINA
WBS NO.: 44381.1.1, TIP NO.: U-5808**



Wood Environment & Infrastructure Solutions, Inc. 1600
4021 Stirrup Creek Drive, Suite 100
Durham, North Carolina 27703
Tel : (919) 381-9900 Fax: (919) 381-9901

GEOTECHNICAL BORING REPORT

BORE LOG

WBS 44381.1.1		TIP U-5808		COUNTY UNION		GEOLOGIST C. Tremblay										
SITE DESCRIPTION Bridge No. 576 on SR 1362 (Chestnut Lane Connector) over CSX Railroad							GROUND WTR (ft)									
BORING NO. EB2-A		STATION 56+20		OFFSET 27 ft LT		ALIGNMENT -L2-										
COLLAR ELEV. 694.3 ft		TOTAL DEPTH 23.5 ft		NORTHING 488,790		EASTING 1,499,712										
DRILL RIG/HAMMER EFF./DATE AME9553 CME-550X 80% 12/15/2017				DRILL METHOD H.S. Augers		HAMMER TYPE Automatic										
DRILLER C. Meatyard		START DATE 08/31/18		COMP. DATE 08/31/18		SURFACE WATER DEPTH N/A										
ELEV (ft)	DRIVE ELEV (ft)	DEPTH (ft)	BLOW COUNT			BLOWS PER FOOT					SAMP. NO.	LOG	SOIL AND ROCK DESCRIPTION	DEPTH (ft)		
			0.5ft	0.5ft	0.5ft	0	25	50	75	100						
695														694.3	GROUND SURFACE	0.0
	693.3	1.0	4	8	12										RESIDUAL Tan, gray, and reddish brown, sandy silty CLAY (A-7-6)	
690	690.8	3.5	13	13	13											
	688.3	6.0	5	7	13											
685	685.8	8.5	16	24	30									686.3		Gray and brown, clayey SILT (A-4), saprolitic
	680.8	13.5	7	21	27											
675	675.8	18.5	28	51	35											
	670.8	23.5	60/0.0											670.8	Boring Terminated by Auger Refusal at Elevation 670.8 ft on Crystalline Rock: METAVOLCANIC	23.5

WBS 44381.1.1		TIP U-5808		COUNTY UNION		GEOLOGIST C. Tremblay										
SITE DESCRIPTION Bridge No. 576 on SR 1362 (Chestnut Lane Connector) over CSX Railroad							GROUND WTR (ft)									
BORING NO. EB2-B		STATION 56+30		OFFSET 39 ft RT		ALIGNMENT -L2-										
COLLAR ELEV. 692.9 ft		TOTAL DEPTH 33.7 ft		NORTHING 488,747		EASTING 1,499,764										
DRILL RIG/HAMMER EFF./DATE AME9553 CME-550X 80% 12/15/2017				DRILL METHOD H.S. Augers		HAMMER TYPE Automatic										
DRILLER C. Meatyard		START DATE 08/31/18		COMP. DATE 08/31/18		SURFACE WATER DEPTH N/A										
ELEV (ft)	DRIVE ELEV (ft)	DEPTH (ft)	BLOW COUNT			BLOWS PER FOOT					SAMP. NO.	LOG	SOIL AND ROCK DESCRIPTION	DEPTH (ft)		
			0.5ft	0.5ft	0.5ft	0	25	50	75	100						
695														692.9	GROUND SURFACE	0.0
	691.9	1.0	5	6	6										RESIDUAL Tan and brown, silty CLAY (A-7-6)	
690	689.4	3.5	7	7	9											
	686.9	6.0	5	6	9											
685	684.4	8.5	11	16	31									684.9		Gray and brown, clayey SILT (A-4), saprolitic
	679.4	13.5	10	20	22											
675	674.4	18.5	20	28	27											
	669.4	23.5	100/0.4											669.9	WEATHERED ROCK Brown, METAVOLCANIC	23.0
665	664.4	28.5	100/0.3													
660	659.4	33.5	100/0.2											659.2	Boring Terminated at Elevation 659.2 ft in Weathered Rock: METAVOLCANIC	33.7

NCDOT BORE DOUBLE U5808_GEO_RDWY AND BR.GPJ NC_DOT.GDT 10/23/18



PROFILE (-L2-), LOOKING UPSTATION FROM END BENT 1.



PROFILE (-L2-), LOOKING DOWNSTATION FROM END BENT 2.

SITE PHOTOGRAPHS	
CHESTNUT LANE CONNECTOR (SR1362) BRIDGE OVER CSX RR UNION COUNTY, NORTH CAROLINA WBS NO.: 44381.1.1, TIP NO.: U-5808	
	<small>Wood Environment & Infrastructure Solutions, Inc.1600 4021 Stirrup Creek Drive, Suite 100 Durham, North Carolina 27703 Tel : (919) 381-9900 Fax: (919) 381-9901</small>



END BENT 1, LOOKING FROM RT TO LT.



END BENT 2, LOOKING FROM RT TO LT.

SITE PHOTOGRAPHS	
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BENT 1, LOOKING FROM RT TO LT.



BENT 2, LOOKING FROM RT TO LT.

SITE PHOTOGRAPHS

**CHESTNUT LANE CONNECTOR (SR1362)
BRIDGE OVER CSX RR
UNION COUNTY, NORTH CAROLINA
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