
This electronic collection of documents is provided for the convenience of the user and is Not a Certified Document –

The documents contained herein were originally issued and sealed by the individuals whose names and license numbers appear on each page, on the dates appearing with their signature on that page.

This file or an individual page shall not be considered a certified document.

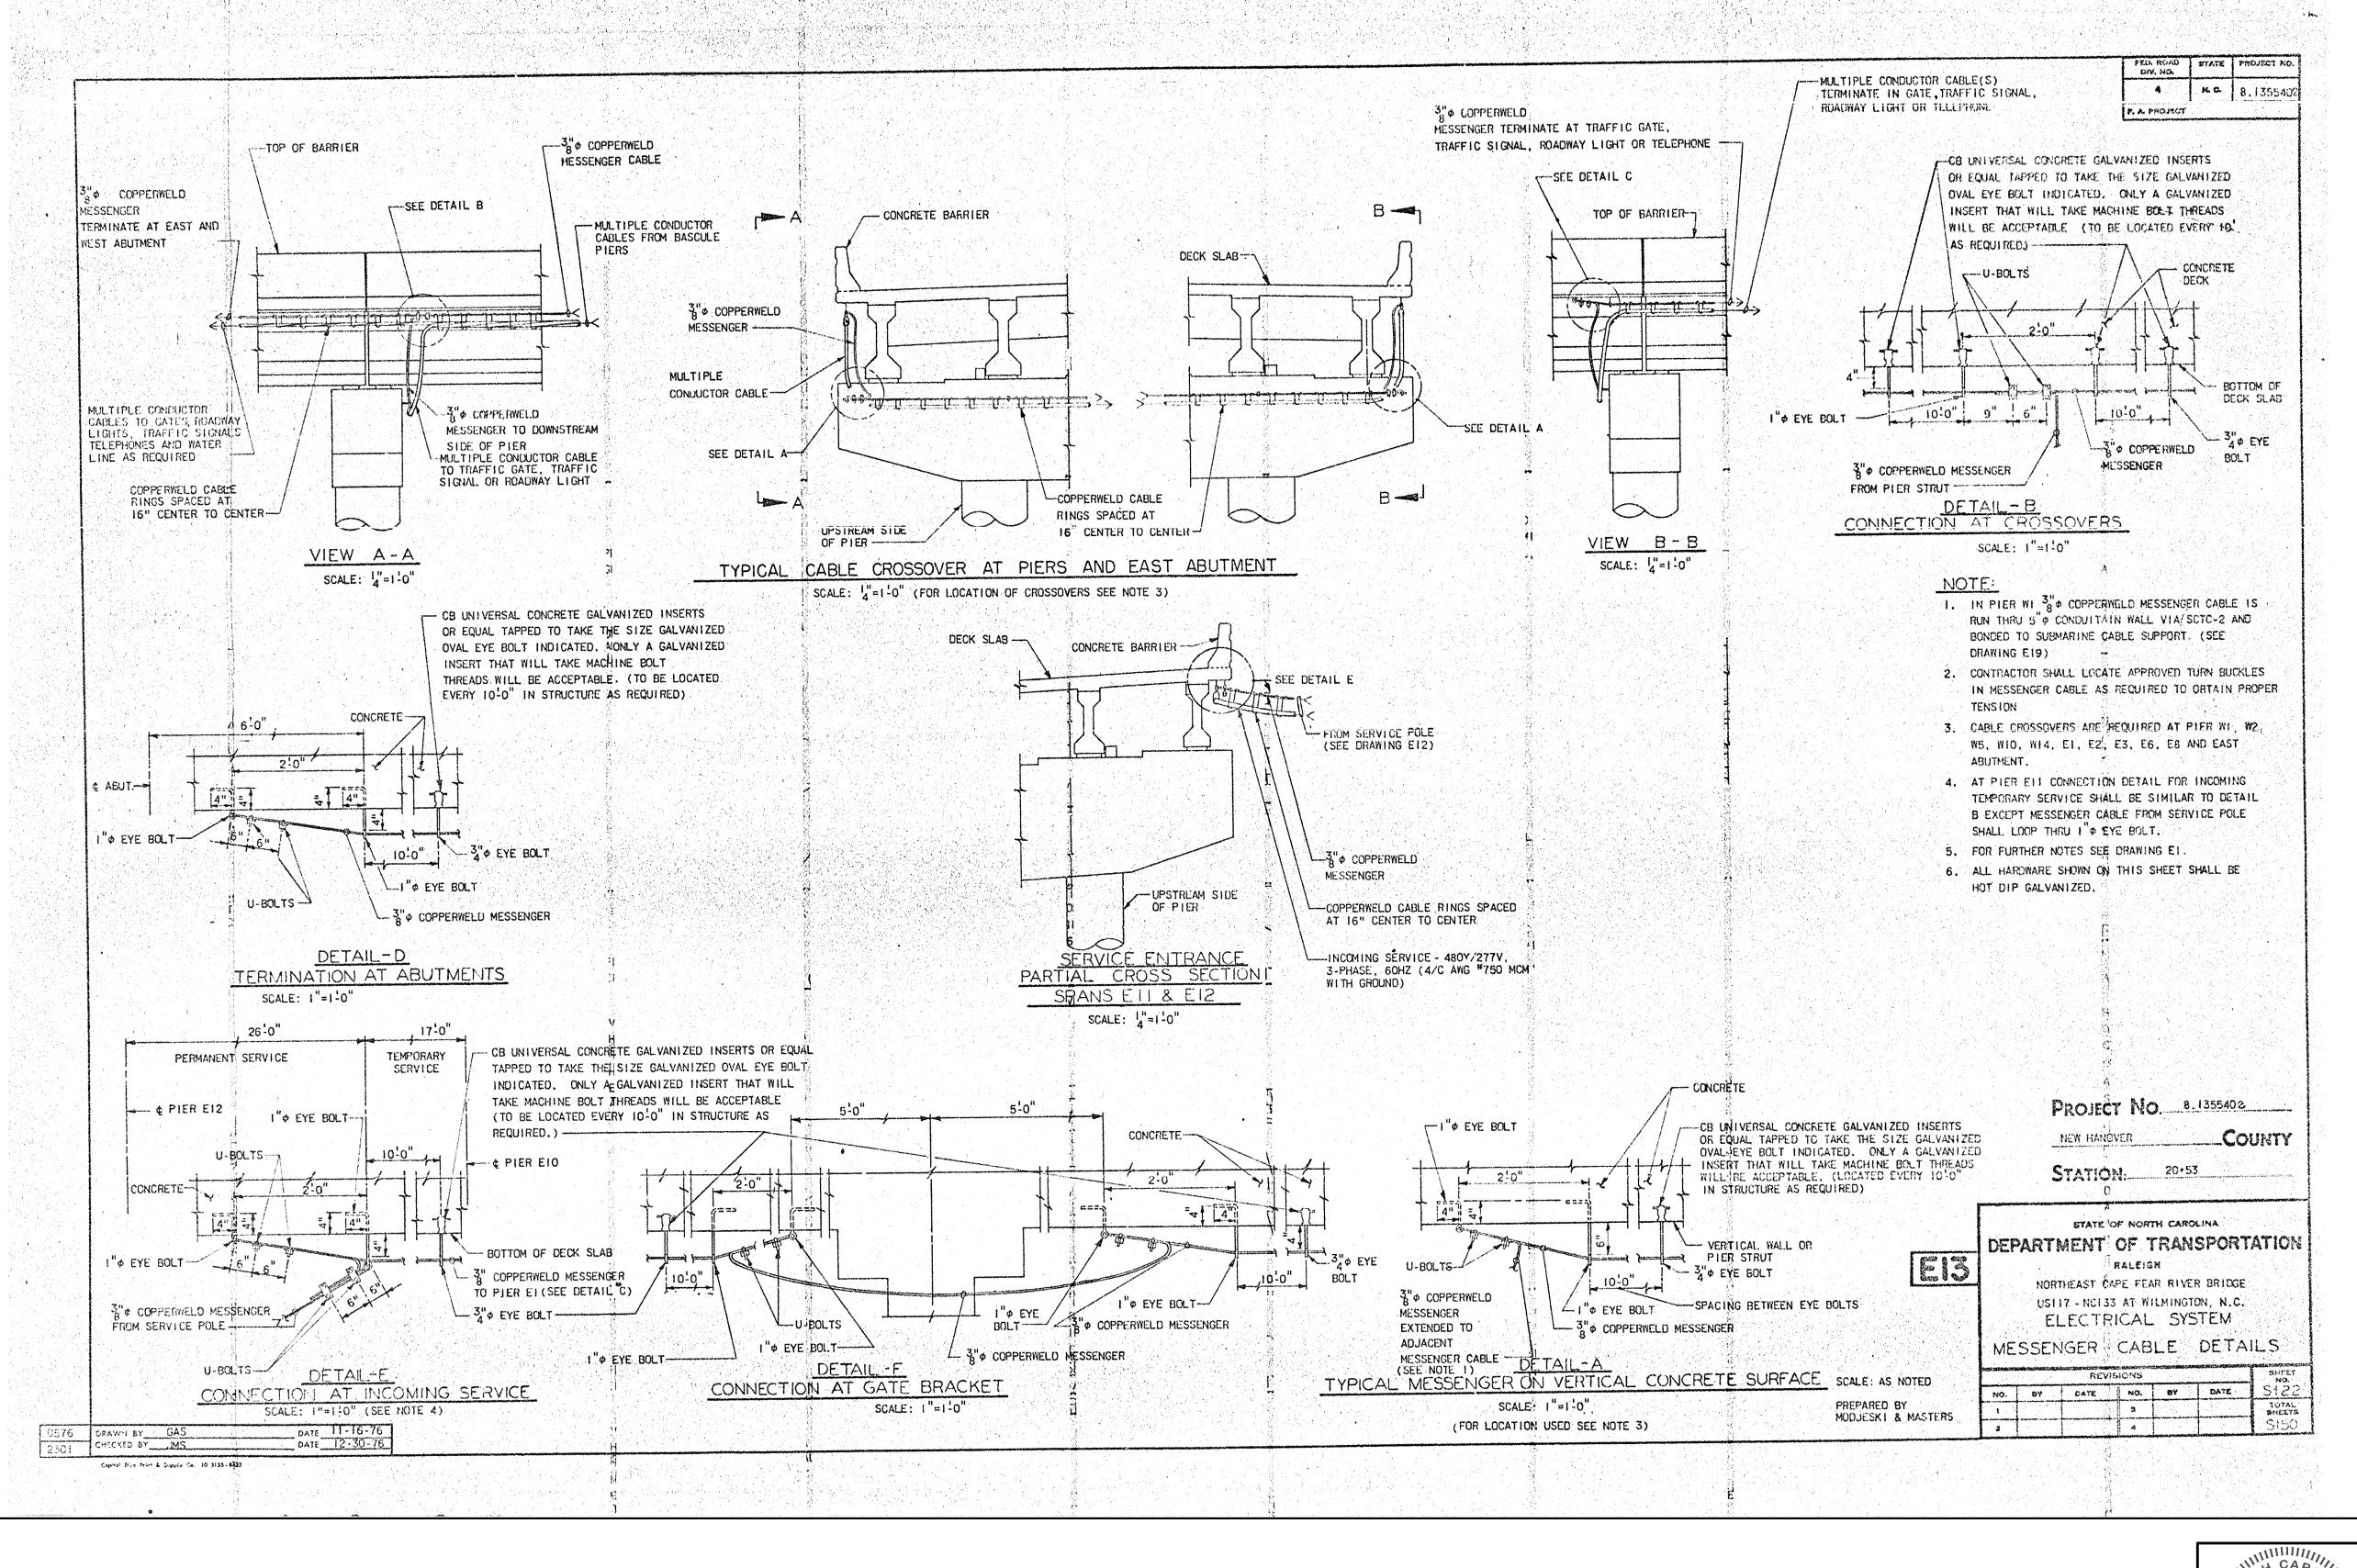

PROJECT NO. 15BPR.14

NEW HANOVER COUNTY

STATION:

DEPARTMENT OF TRANSPORTATION
RALEIGH
ELECTRICAL

MESSENGER CABLE DETAILS - 5

SEAL

044780

Joe Strandsskötremin BC58212F3FAD4FA 1715/2018

REVISIONS

BY: DATE: No. BY: DATE: E-124

3 TOTAL SHEETS
213


MODJESKI and MASTERS
Experience great bridges.

333 FAYETTEVILLE STREET, SUITE 505 RALEIGH, NC 27601 NC LICENSE NO. C-2979

DOCUMENT NOT CONSIDERED FINAL UNLESS ALL SIGNATURES COMPLETED

DESIGNED BY: E. N. CLAY DATE: 10/24/18
DRAWN BY: R. L. REED DATE: 10/24/18
CHECKED BY: L.. V. BORDEN DATE: 11/15/18
DESIGN ENGINEER OF RECORD: J. G. STRENKOSKI DATE: 11/15/18

FOR INFORMATION ONLY ,

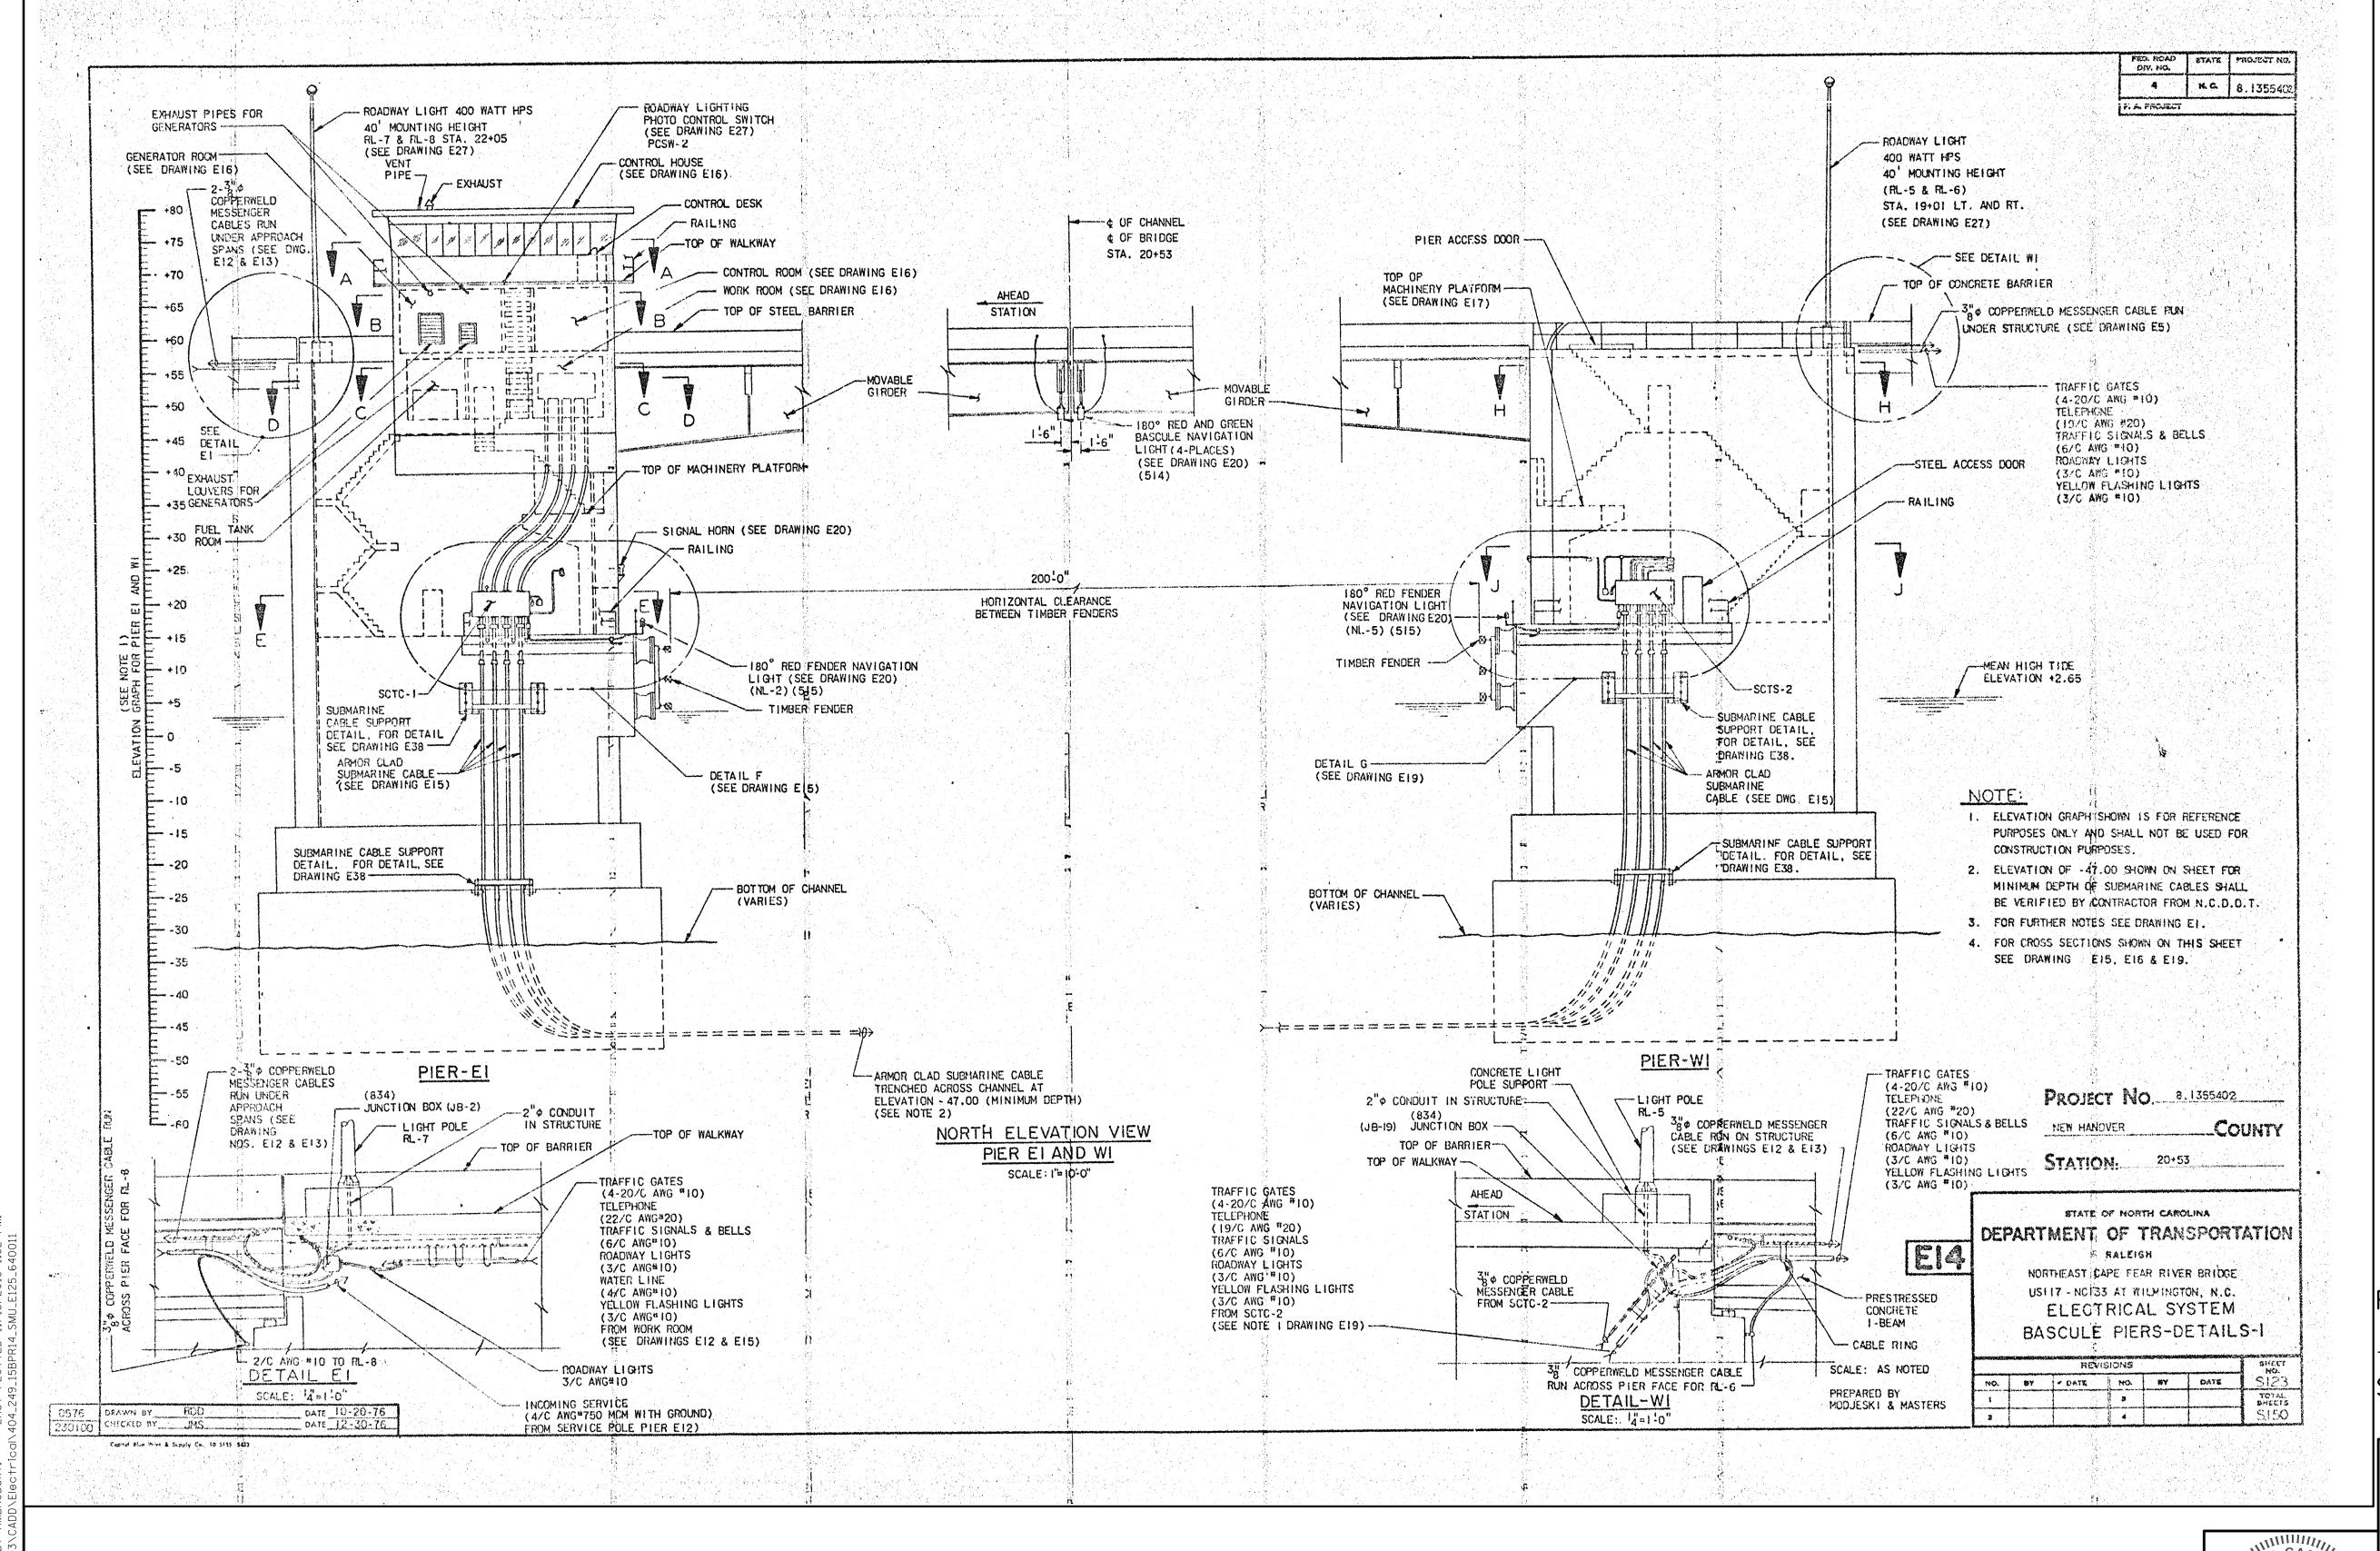

PROJECT NO. 15BPR.14

NEW HANOVER COUNT

STATION:

DEPARTMENT OF TRANSPORTATION
RALEIGH
ELECTRICAL

MESSENGER CABLE DETAILS - 6

SEAL

044780

Doctor The Works FRE THE BC58212F3FAD4FA 11/15/2018

REVISIONS

SHEET NO.

10. BY: DATE: NO. BY: DATE: E-125

1 3 TOTAL SHEET'S
213


MODJESKI and MASTERS
Experience great bridges.

333 FAYETTEVILLE STREET, SUITE 505 RALEIGH, NC 27601 NC LICENSE NO. C-2979


DOCUMENT NOT CONSIDERED FINAL UNLESS ALL SIGNATURES COMPLETED

DESIGNED BY: _	Ε.	N.	CLAY	DATE	<u>: 10/24/18</u>
DRAWN BY: _	R.	L.	REED	DATE	<u>: 10/24/18</u>
CHECKED BY:	L	٧.	BORDEN	DATE	: <u>11/15/18</u>
DESIGN ENGINEE	R J.	G.	STRENKOSKI	DATE	. 11/15/18


FOR INFORMATION ONLY

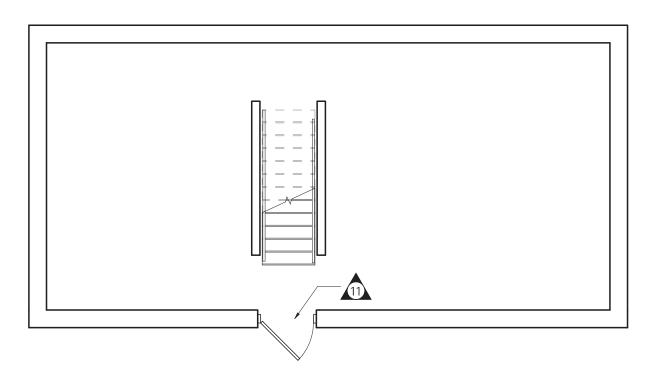


5 GROUND DEMOLITION PLAN D1.1 1/4" = 1'-0"

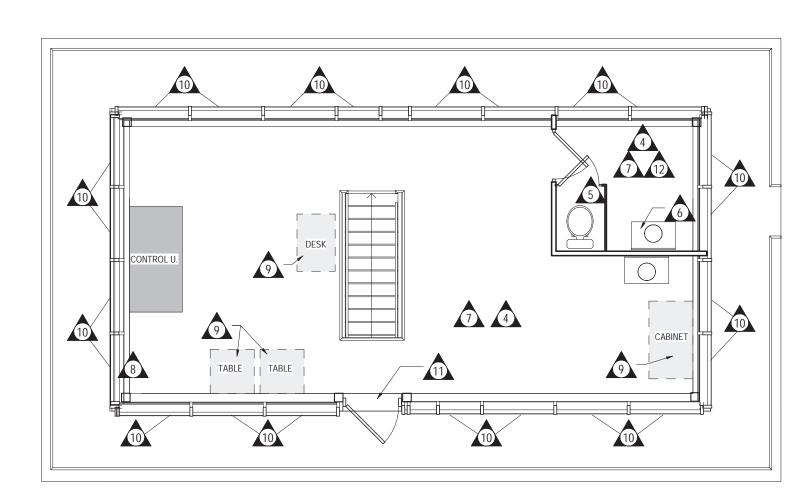

1 \ FIRST FLOOR DEMOLITION PLAN

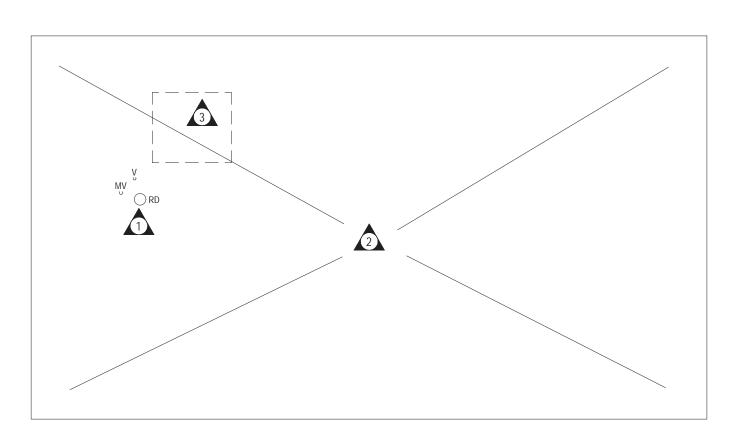

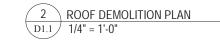

	DEMOLITION LEGEND
TAG	DEMOLITION NOTE
1	DEMOLISH ROOF DRAIN AND ALL RELATED COMPONENTS. PREPARE FOR NEW WORK AS SCHEDULED.
2	DEMOLISH ENTIRE EPDM ROOF SYSTEM INCLUDING ROOF INSULATION, VAPOR RETARDER TO ROOF DECK. REMOVE ALL ASSOCIATED FASTENERS AND ADHESIVES. PREPARE SURFACE FOR NEW WORK AS SCHEDULED.
3	REMOVE MECHANICAL RTU AND ALL RELATED COMPONENTS. PREPARE FOR NEW WORK AS SCHEDULED.
4	REMOVE EXISTING SUSPENDED ACOUSTIC CEILING TILE SYSTEM, GRID, HANGERS, BATT INSULATION AND ALL ASSOCIATED COMPONENTS IN THEIR ENTIRETY
5	DEMOLISH TOILET AND PARTITION. REMOVE ALL ASSOCIATED FASTENERS, HARDWARE, AND ADHESIVES IN THEIR ENTIRETY. PREPARE FOR NEW WORK AS SCHEDULED.
6	DEMOLISH SINK. REMOVE ALL ASSOCIATED FASTENERS, HARDWARE, ADHESIVES AND ALL COMPONENTS IN THEIR ENTIRETY. PATCH AND PREPARE ALL ADJACENT SUBSTRATES TO RECEIVE NEW WORK AS SCHEDULED.
7	REMOVE EXISTING VINYL FLOORING, WALL BASE AND ADHESIVES IN THEIR ENTIRETY TO THEIR EXISTING SUBSTRATE. PREPARE SURFACE FOR NEW FINISH. SEE ROOM FINISH SCHEDULE.
8	REMOVE WINDOW TREATMENTS. REMOVE ALL ASSOCIATED FASTENERS, HARDWARE, AND SUPPORTS. PATCH AND REPAIR ALL ADJACENT SURFACES TO RECIEVE NEW WORK/ FINISHES AS SCHEDULED
9	REMOVE FURNITURE AND REINSTALL FURNITURE AFTER CONSTRUCTION IS COMPLETED
10	REMOVE WINDOW AND FRAME. PATCH AND PREPARE ALL ADJACENT SUBTRATES AND FINISHES TO RECEIVE NEW WORK / FINISHES AS SCHEDULED
11	REMOVE EXISTING DOOR AND FRAME IN THEIR ENTIRETY INCLUDING ALL TRIM, HARDWARE FASTENERS, THRESHOLD ANY LOUVERS AND OTHER ASSOCIATED COMPONENTS. PREPARE EXISTING OPENING FOR NEW DOOR AND FRAME.
12	REMOVE EXISTING TOILET ACCESSORIES IN THEIR ENTIRETY REMOVE ALL ASSOCIATED ANCHORS, SUPPORTS, HARDWARE, FASTENERS AND ADHESIVES. LEAVE EXISTING PAPER TOWEL DISPENSER INTACT

GENERAL DEMOLITION NOTES:

- D1 DASHED LINES INDICATE GENERAL EXISTING CONSTRUCTION TO BE REMOVED GENERAL CONTRACTOR IS RESPONSIBLE FOR FIELD VERIFYING ALL EXISTING CONDITIONS RELATING TO THE DEMOLITION REQUIRED FOR INSTALLATION OF NEW CONSTRUCTION SHOWN ELSEWHERE.
- D2. SEE STRUCTURAL, MECHANICAL, ELECTRICAL, PLUMBING AND FOOD SERVICE DRAWINGS FOR OTHER DEMOLITION WORK REQUIRED. ANY DEMOLITION OF MECHANICAL, ELECTRICAL, OR PLUMBING EQUIPMENT SHOWN ON THESE DRAWINGS, IS FOR COORDINATION ONLY. COORDINATE ALL WORK BY OTHER CONTRACTORS INCLUDING CAPPING AND DISCONNECTING OF BUILDING SERVICES SUCH AS WATER, WASTE, ELECTRIC, DUCTWORK, ETC.
- O3. BEFORE DEMOLITION AND THROUGHOUT CONSTRUCTION, GENERAL CONTRACTOR SHALL BE RESPONSIBLE TO REVIEW WITH OWNER'S REPRESENTATIVE ALL ITEMS BEING REMOVED BY THEIR TRADES. ALL ITEMS DESIGNATED DURING THIS REVIEW TO REMAIN OWNER'S PROPERTY, SHALL BE MAINTAINED IN GOOD CONDITION AND TURNED OVER TO OWNER. ALL ITEMS DESIGNATED TO BE REUSED AS PART OF NEW CONSTRUCTION SHALL BE MAINTAINED IN A REUSABLE CONDITION AND STORED ON SITE BY CONTRACTOR IN A CLEAN, DRY LOCATION UNTIL INSTALLATION. ALL REMAINING ITEMS AND MATERIALS DEEMED TO BE TRASH SHALL BE DISPOSED OF PROPERLY BY LAW, OFF SITE BY THE RESPONSIBLE CONTRACTOR.
- D4. EXISTING CONDITIONS AS THEY APPEAR IN THESE CONTRACT DOCUMENTS MAY VARY WITH ACTUAL CONDITIONS BECAUSE OF WORK PERFORMED WITH OWNER'S STAFF AND BY OTHER CONTRACTORS (I.E. ASBESTOS ABATEMENT CONTRACTOR) PRIOR TO CONTRACT. PORTIONS OF DEMOLITION WORK MAY BE INCLUDED IN THE SCOPE OF WORK OF ANOTHER CONTRACT AND NOT PART OF THIS PROJECT. GENERAL CONTRACTOR SHALL VERIFY THE ACTUAL SCOPE OF DEMOLITION IN THEIR CONTRACT PRIOR TO SUBMITTING A BID.
- D5 GENERAL CONTRACTOR SHALL BE RESPONSIBLE FOR VERIFICATION OF ALL EXISTING BUILDING DIMENSIONS AND CONDITIONS, INCLUDING FINISHES AND MATERIALS, SYSTEMS SHOWN AND DESIGNATED AS EXISTING ON CONTRACT DRAWINGS PRIOR TO STARTING DEMOLITION AND CONSTRUCTION. ANY DISCREPANCIES IN INFORMATION INDICATED ON CONTRACT DRAWINGS SHALL BE DIRECTED IN WRITING TO THE ATTENTION OF THE ARCHITECT PRIOR TO STARTING OF DEMOLITION AND CONSTRUCTION. VERIFICATION OF CLEARANCES REQUIRED FOR ALL NEW EQUIPMENT, PIPING, DUCTWORK AND RELATED COMPONENTS SHALL BE THE CONTRACTORS RESPONSIBILITY.
- D6. DEMOLITION WORK SHOWN ON THE DEMOLITION CONTRACT DRAWINGS SHALL BE FOR THE BUILDING RECEIVING MAJOR DEMOLITION WORK, AND DOES NOT REPRESENT THE DEMOLITION FOR THE PROJECT IN ITS ENTIRETY. REFER TO CONTRACT DRAWINGS FOR ADDITIONAL DEMOLITION WORK, IF, ANY, FOR EACH ROOM OR BUILDING COMPONENT.
- D7. GENERAL CONTRACTOR SHALL BE RESPONSIBLE FOR VERIFICATION OF ALL DEMOLITION CONDITIONS RELATED TO ACCEPTED ALTERNATE BIDS INCLUDING FINISHES AND MATERIALS, SYSTEMS SHOWN AND DESIGNATED AS EXISTING OR NEW ON THE CONTRACT DRAWINGS PRIOR TO STARTING OF DEMOLITION AND CONSTRUCTION. ANY DISCREPANCIES IN INFORMATION INDICATED ON CONTRACT DRAWINGS SHALL BE DIRECTED IN WRITING TO THE ATTENTION OF THE ARCHITECT PRIOR TO STARTING OF DEMOLITION AND
- D8. OWNER RESERVES THE RIGHT TO SALVAGE AND REMOVE ANY EXISTING ITEMS
- D9 DEMOLITION DRAWINGS INDICATE EXISTING SLABS TO BE REMOVED IN THEIR ENTIRETY. REFER TO MECHANICAL, ELECTRICAL AND PLUMBING DRAWINGS FOR ANY SAWCUTTING AND PATCHING OF CONCRETE SLABS THAT NEEDS TO OCCUR AS PART OF THEIR WORK. IN ADDITON, REFER TO STRUCTURAL DRAWINGS FOR SAWCUTTING AND PATCHING THAT NEEDS TO OCCUR TO ACCOMODATE INSTALLATION OF NEW FOOTINGS, PIERS ETC.
- D10. GENERAL CONTRACTOR SHALL BE RESPONSIBLE TO VERIFY EXISTING LOAD BEARING WALLS AND PROVIDE TEMPORARY SHORING AND SUPPORT UNTILL NEW STRUCTURE CAN BE INSTALLED.
- D11. GENERAL CONTRACTOR SHALL BE RESPONSIBLE FOR REMOVING ASBESTOS CONTAINING MATERIALS AND DISPOSING OF THEM OFF SITE IN
- ACCORDANCE WITH STATE LOCAL AND LAWS. D12. WHERE EXTERIOR WALLS ARE SCHEDULED TO BE REMOVED, THEY ARE TO BE REMOVED DOWN TO TOPS OF EXISTING FOOTINGS. REMOVE EXISTING FOOTINGS WHERE THEY INTERFERE WITH NEW CONSTRUCTION.

GENERAL ALTERATION NOTES:

- R1. GENERAL CONTRACTOR IS RESPONSIBLE FOR VERIFICATION AND RECORDING OF R6. ALL EXISTING MATERIALS AND FINISHES DISTURBED OR INTERRUPTED BY THE ALL EXISTING BUILDING DIMENSIONS AND CONDITIONS RELATED TO THE WORK, INCLUDING BUT NOT LIMITED TO FINISHES, MATERIALS AND SYSTEMS SHOWN AND DESIGNATED AS EXISTING IN CONTRACT DOCUMENTS. ANY DISCREPANCIES FROM INFORMATION INDICATED ON CONTRACT DOCUMENTS SHALL BE DIRECTED TO THE ATTENTION OF THE ARCHITECT. VERIFICATION OF CLEARANCES REQUIRED FOR ALL NEW EQUIPMENT, PIPING, DUCTWORK, AND RELATED COMPONENTS SHALL BE THE CONTRACTORS RESPONSIBILITY.
- R2. GENERAL CONTRACTORS RESPONSIBILITY TO REVIEW WITH THE OWNERS REPRESENTATIVE, ALL ITEMS REQUIRING REMOVAL BEFORE THE START OF WORK. OWNER RESERVES THE RIGHT TO SALVAGE ANY ITEM. ALL REMAINING ITEMS SHALL BE DISPOSED OF OFF SITE.
- R3. WHERE EXISTING WALL OPENINGS ARE INDICATED TO BE CLOSED, USE MATERIALS AND FINISHES TO MATCH ADJACENT EXISTING FINISHES. MASONRY SHALL BE TOOTHED INTO THE EXISTING COURSING TO ACHIEVE A UNIFORM JOINT PATTERN TO MATCH THE EXISTING.
- R4. ALL NEW MASONRY WALLS AND INFILLS THAT ARE IN CONTINUANCE WITH EXISTING MASONRY WALLS SHALL BE TOOTHED INTO THE EXISTING COURSING TO ACHIEVE A UNIFORM JOINT PATTERN TO MATCH THE EXISTING, FIELD VERIFY
- R5. IN ALL RENOVATED AREAS OF THE WORK, THE INTENT OF THESE CONTRACT DOCUMENTS IS TO PROVIDE A LEVEL OF QUALITY FOR ALL PATCHED SURFACES EQUAL TO THAT OF NEW SURFACES, INCLUDING BUT NOT LIMITED TO PLASTER, GYPSUM WALL BOARD AND MASONRY.
- WORK SHALL BE REPLACED OR "FILLED IN" TO ACHIEVE UNIFORM COLOR, TEXTURE, PATTERN AND APPEARANCE TO MATCHING ADJACENT MATERIALS AND FINISHES. TRANSITIONS BETWEEN EXISTING TO EXISTING AND NEW TO EXISTING MATERIALS AND FINISHES SHALL BE ACHIEVED IN STRAIGHT HORIZONTAL AND OR VERTICAL LINES BETWEEN DIFFERENT AND OR NEW MATERIALS AND FINISHES.
- 7. PATCH ALL HOLES IN FLOORS, WALLS AND CEILINGS, LEVEL WITH EXISTING ADJACENT SURFACES TO RECEIVE NEW FINISHES AND/OR CONSTRUCTION TO COMPLETE THE WORK. MATCH THE EXISTING ADJACENT MATERIALS,
- R8. PATCH, REPAIR OR REPLACE ALL EXISTING FINISHES AND MATERIALS DISTURBED DURING CONSTRUCTION OR AS A RESULT OF DEMOLITION OR REMOVAL OF AN ITEM. ALL REPAIR OR REPLACEMENT SHALL MATCH ADJACENT EXISTING AND/OR NEW FINISHES, PATTERNS AND MATERIALS. SEE ROOM FINISH SCHEDULE FOR NEW FINISHES.
- R9. PREPARE EXISTING REMAINING WORK SUBSTRATES TO RECEIVE NEW FINISHES AS INDICATED ON THE ROOM FINISH SCHEDULE, SUBSTRATE PREPARATION SHALL BE IN CONFORMANCE WITH THE INSTALLATION REQUIREMENTS OF EACH NEW FINISH.
- R10. ALL WALLS SHOWN WITH MASONRY HATCHING WITHIN THE EXISTING BUILDING SHALL BE NEW AND TOOTHED INTO EXISTING MASONRY. MATCH EXISTING COURSING, JOINT PATTERN AND THICKNESS UNLESS NOTED

MATCH EXISTING WALL THICKNESS.

R11. MASONRY WALLS AND INFILLS THAT ARE IN CONTINUANCE WITH EXISTING MASONRY WALLS SHALL BE TOOTHED INTO THE EXISTING COURSING TO ACHIEVE A UNIFORM JOINT PATTERN TO MATCH THE EXISTING WORK.

- R12. AT THE DEMOLITION OF AN EXISTING ITEM, REMOVE ALL TRACES OF THE DEMOLISHED ITEMS COMPONENTS FROM THE SURFACE OF THE REMAINING FLOOR, WALLS AND CEILING. AT THE REMOVED FASTENERS IN ALL EXISTING MASONRY WALLS AND FLOORS. PATCH HOLF WITH GROUT LEVEL WITH EXISTING ADJACENT SURFACES IN ORDER TO RECEIVE NEW FINISHES.
- R13. AT EXISTING FLOORS: CUT IN PLACE CONSTRUCTION TO RECEIVE NEW WORK, REPLACE WITH MATERIALS TO MATCH EXISTING REMAINING MATERIALS. PATCH FLUSH TO ADJACENT EXISTING ELEVATIONS. APPLY CEMENTITIOUS UNDERLAYMENT TO PRODUCE A UNIFORM SURFACE IN ALL AREAS RECEIVING NEW FINISHES AS INDICATED ON THE ROOM FINISH SCHEDULE. PATCHED JOINTS SHALL NOT TELEGRAPH THRU THE NEW FINISH. SEE DRAWINGS AND SPECIFICATIONS FOR ADDITIONAL REQUIREMENTS AND OTHER FINISHES.
- R14. AT EXISTING FLOORS: WHERE WALLS ARE SCHEDULED FOR DEMOLITION AND EXTEND TO BELOW THE CONTINUOUS CONCRETE FLOOR SLAB. THE WALL SHALL BE DEMOLISHED TO BELOW THE FLOOR THICKNESS. THE FLOOR SHALL BE PATCHED WITH CONCRETE AND GRANULAR FILL TO MATCH THE EXISTING THICKNESS, PROVIDE NEW VAPOR BARRIER TO THE PATCHED AREA. PATCH FLUSH TO ADJACENT EXISTING ELEVATIONS, APPLY CEMENTITIOUS UNDERLAYMENT TO PRODUCE A UNIFORM SURFACE IN ALL AREAS RECEIVING NEW FINISH AS INDICATED ON ROOM FINISH SCHEDULE. PATCHED JOINTS SHALL NOT TELEGRAPH THRU THE NEW FINISH.
- R15. PAINT EXISTING METALS: AT EXISTING DOOR FRAMES TO REMAIN AND OTHER PAINTED METAL COMPONENTS INDICATED. REMOVE ALL DIRT, LOOSE PAINT AND RUST, SAND ENTIRE FRAME, PRIME AND PAINT. COLOR SELECTION BY ARCHITECT. WHERE THE EXISTING PAINT IS INCOMPATIBLE WITH NEW PAINT COATINGS, THE EXISTING PAINT SHALL BE COMPLETELY REMOVED.
- R16. PAINT SURFACES: WHERE PATCHING OCCURS IN THE WORK OF AN EXISTING PAINTED SURFACE, THE PATCHED AREA SHALL BE SPACKLED, PRIMED AND INTERMEDIATE PAINT COATS APPLIED OVER THE PATCH. APPLY FINAL PAINT COAT OVER ENTIRE UNBROKEN SURFACE CONTAINING THE PATCH. THE UNBROKEN SURFACE SHALL BE FROM THE INTERSECTION OF THE WALL TO FLOOR TO THE INTERSECTION OF THE WALL TO CEILING AND FROM THE RIGHT SIDE WALL TO WALL INTERSECTION TO THE LEFT SIDE WALL TO WALL INTERSECTION, PROVIDE ADDITIONAL SPACKLING AND/OR PAINT COATS UNTIL THE PATCH AREAS BLEND INVISIBLY INTO THE ADJACENT EXISTING SURFACE. UNBROKEN CEILING SURFACES SHALL BE FROM CEILING TO WALL INTERSECTION AND OR NEW BULKHEAD CEILING ELEVATION CHANGE FOR THE ENTIRE PERIMETER OF THE CEILING AREA. APPLY PAINT COATS AS DESCRIBED FOR THE WALLS.
- R17. AT EXISTING CERAMIC TILE: AT DEMOLISHED ITEMS AND DAMAGED AREAS, FILL ALL HOLES IN EXISTING CERAMIC WALL AND FLOOR TILE THAT ARE UP TO 1" WITH A COLOR EPOXY GROUT TO MATCH THE EXISTING CERAMIC TILE COLOR. REMOVE AND REPLACE EXISTING TILES AT HOLES THAT ARE OVER 1" AND AT ALL BROKEN AND MISSING WALL AND FLOOR TILES WITH A NEW TILE TO MATCH EXISTING COLOR AND SIZE.

REVISIONS

01	MM-DD-YR	NAME	DESCRIPTION OF CHANGES

ARCHITE

ROHRI HILL ROAD A 17055

BRID HOLMES BEL Ш \propto

CRAI 401 EAS



PROJECT


3133


DEMOLITION PLANS

As indicated

FILENAME:

November 9, 2018

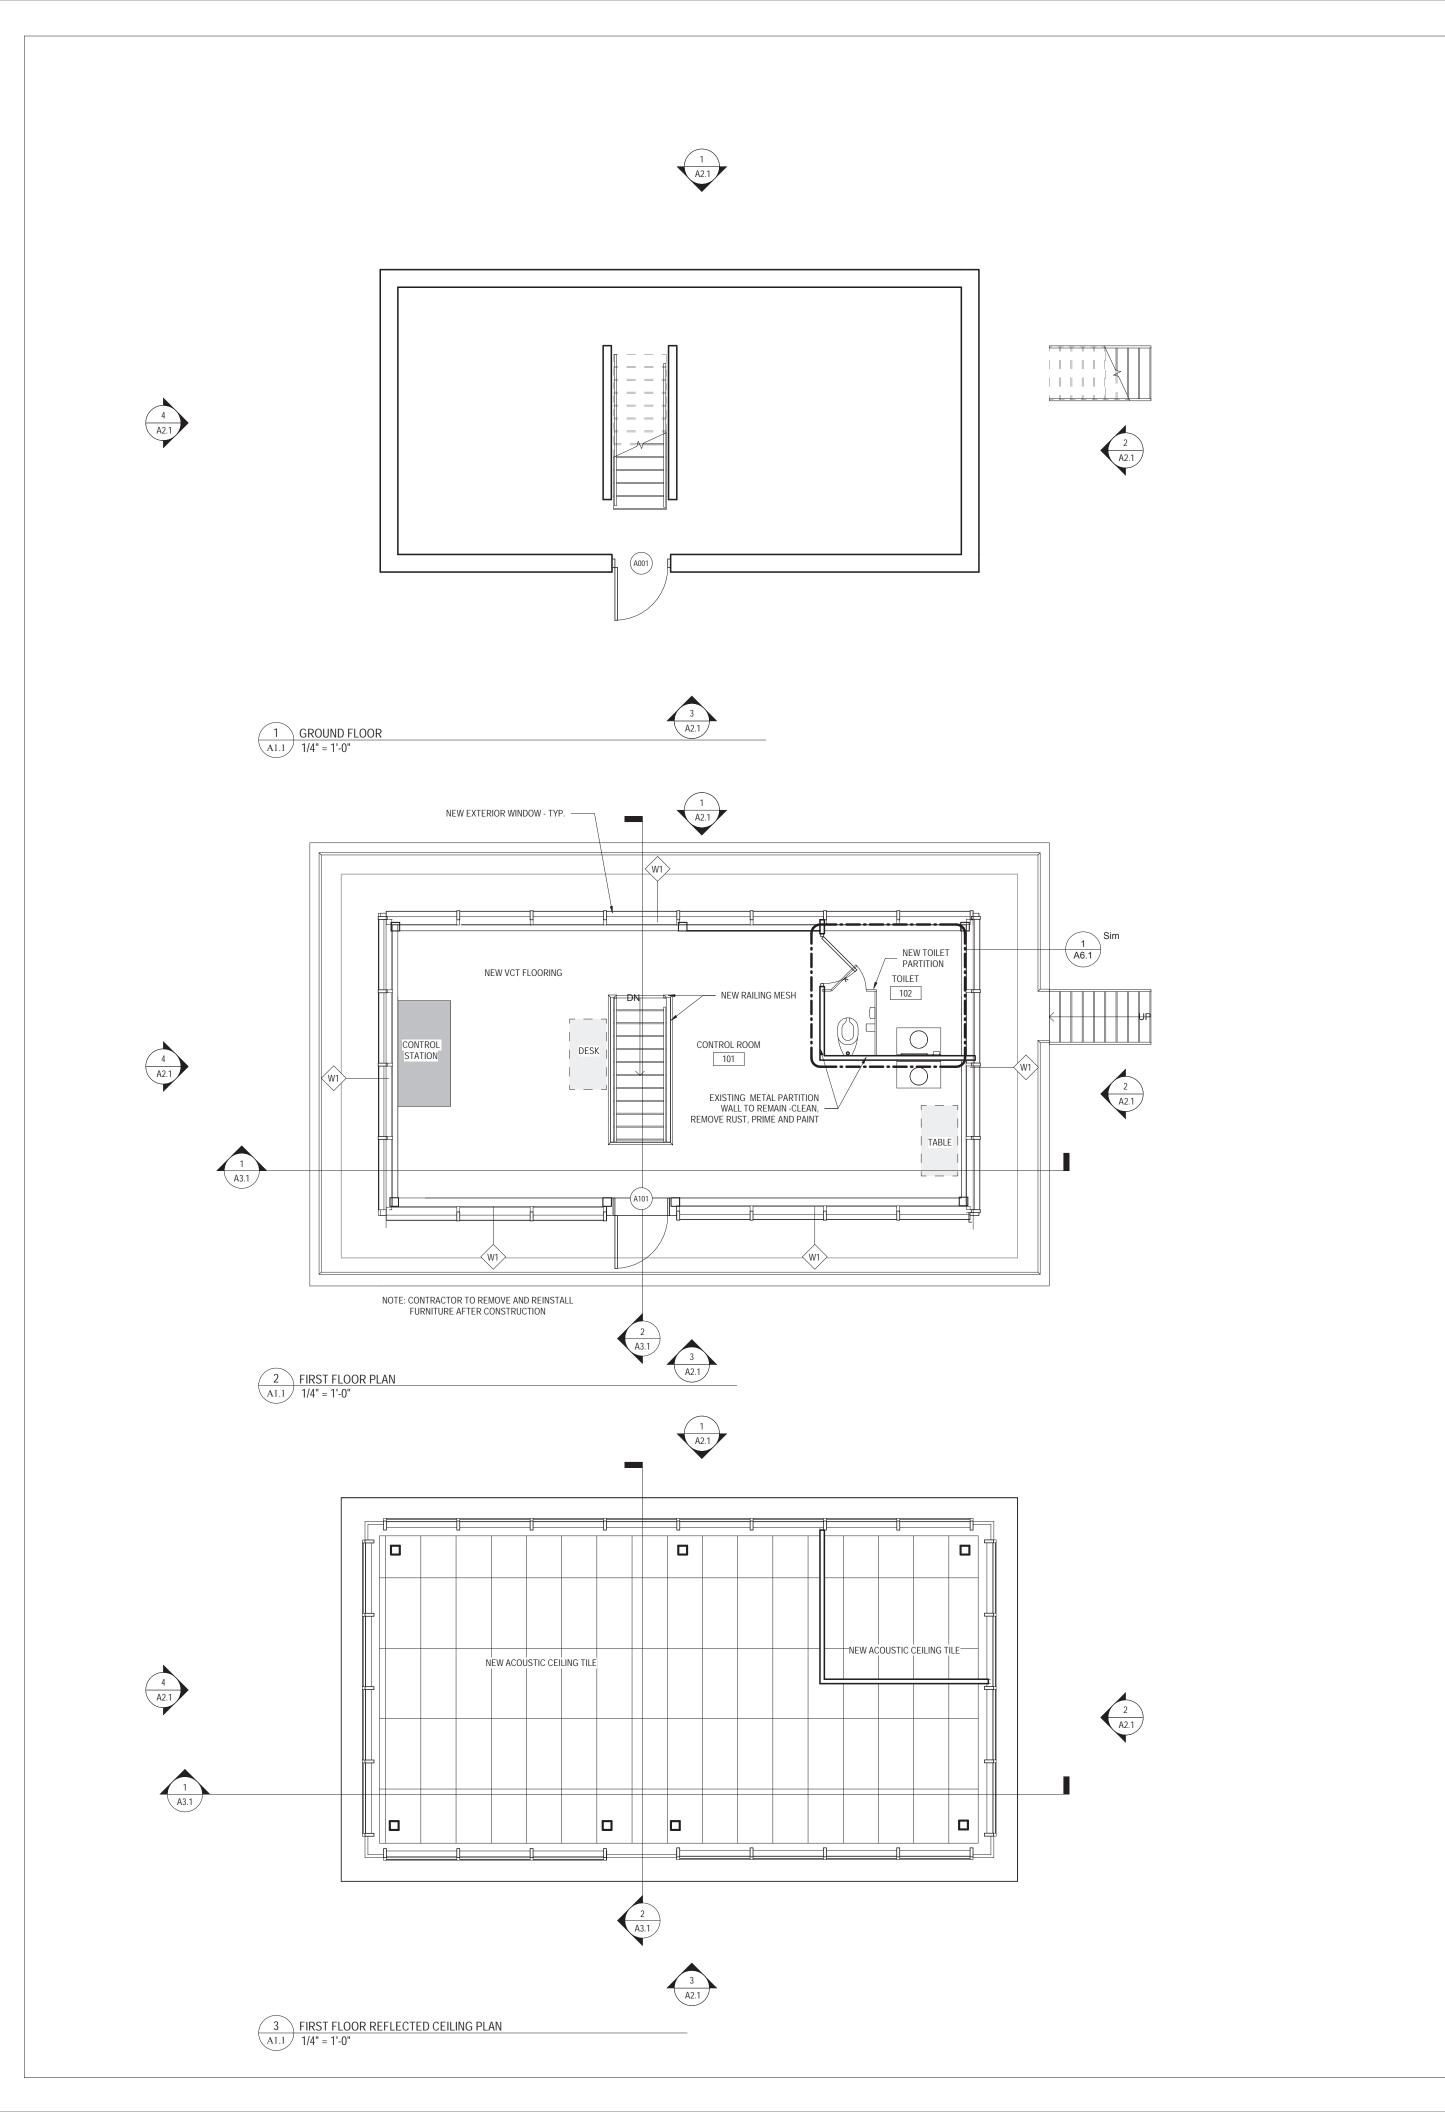

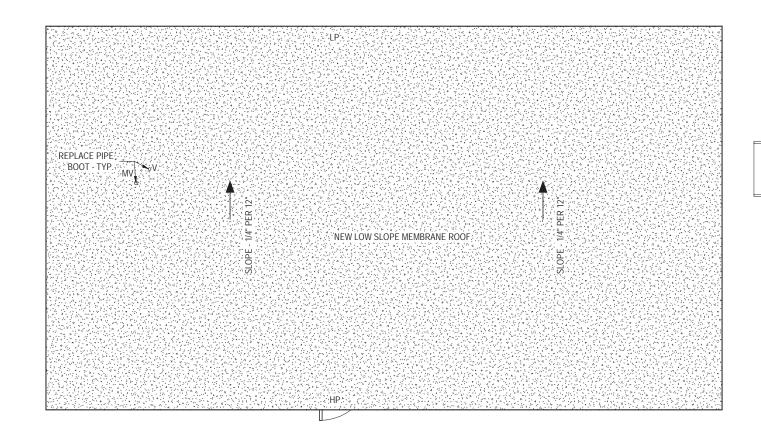

GENERAL NOTES:

4 ROOF PLAN A1.1 1/4" = 1'-0"

- 1. ALL DOOR JAMBS SHALL BE LOCATED 4" FROM INSIDE CORNER OF WALL ON HINGE SIDE UNLESS OTHERWISE INDICATED. 2. COORDINATE LOCATION OF MEP EQUIPMENT, DEVICES, OUTLET BOXES, ETC.
- WITH OTHER EQUIPMENT AND FINISH SCHEDULE PRIOR TO INSTALLATION. 3. UNLESS NOTED OTHERWISE, WHERE DIFFERENT FLOOR ELEVATIONS OCCUR ON OPPOSITE SIDES OF INTERIOR MASONRY WALLS, PROVIDE COLD FLUID
 APPLIED WATERPROOFING (CFAWP) ON THE BACKFILLED FACE OF WALL.

APPLY CFAWP FROM UNDERSIDE OF CONC. SLAB TO TOP OF FOOTING BELOW.

CFAWP NOT TO INTERFERE WITH INSTALLATION OF CONC. SLAB VAPOR

4. ALL WALL LAYOUT DIMENSIONS ARE FROM FACE OF STUD & FACE OF CMU UNLESS OTHERWISE NOTED.

<u>LEGEND</u> LP LOW POINT HP HIGH POINT OD OVERFLOW DRAIN FLOW DIRECTION INDICATES MEMBRANE ROOF SYSTEM WITH TAPERED INSULATION ROOF

ROOF PLAN NOTES:

- 1. COORDINATE ROOF-MOUNTED EQUIPMENT & PENETRATIONS. REFER TO MEP
- 2. PROVIDE ROOFING MANUFACTURERS' STANDARD DETAILS FOR ALL PENETRATIONS & FLASHING AS PER ROOFING MANUFACTURERS' WARRANTY. 3. CRICKETS AND SADDLES SHALL HAVE A MINIMUM OF TWO TIMES THE SLOPE OF THE PRIMARY TAPERED SYSTEM OR STRUCTURAL SLOPE. 4. ROOF MOUNTED EQUIPMENT CURBS AND SUPPORTS SHALL BE FURNISHED AND INSTALLED BY THE EQUIPMENT SUPPLIER.

REFLECTED CEILING PLAN GENERAL NOTES:

- 1. UNLESS NOTED OTHERWISE, GYPSUM BULKHEADS TO BE 3 5/8" METAL STUDS AT 16" O/C WITH 5/8" GWB EACH SIDE, EXTENDING MIN. 1" BELOW ADJACENT CEILING. 2. CEILING GRID SHALL BE COORDINATED WITH MEP EQUIPMENT AND DEVICES.
- 3. UNLESS NOTED OTHERWISE, ALL VISIBLE STRUCTURAL STEEL, ROOF/ FLOOR DECK, DUCTWORK, PIPING, CONDUIT, HANGER WIRES, ETC. AT EXPOSED LOCATIONS OR ABOVE CEILING CLOUDS SHALL BE PAINTED. 4. REFER TO ROOM FINISH SCHEDULE FOR CEILING TYPES.
- 5. ALL VISIBLE HANGER WIRES, STRUCTURE AND BRACING AT EXPOSED CEILING GRID OR CEILING CLOUD LOCATIONS SHALL BE INSTALLED PLUMB AND LEVEL.
- 6. FOR WINDOWS THAT REQUIRE TWO OR MORE ROLLER SHADES, EACH ROLLER SHADE SHALL TERMINATE AT THE CENTER OF THE WINDOW MULLION. REFER TO HOLLOW METAL AND ALUMINUM FRAME ELEVATIONS FOR FOR DIMENSIONS AND WINDOW MULLION DESIGN AND ROLLER SHADE BRAKES.

2' X 4' SUSPENDED CEILING SYSTEM

<u>LEGEND</u>



1/4" = 1'-0"

November 9, 2018

FILENAME:

OVERALL FLOOR PLANS, REFLECTED CEILING PLAN, ROOF PLAN



ALL REPORTS, PLANS SPECIFICATIONS AND COMPUTER FILES RELATING TO THIS PROJECT ARE THE PROPERTY OF CRABTREE, ROHRBAUGH & ASSOCIATES. CRABTREE ROHRBAUGH & ASSOCIATES RETAINS ALL COMMON LAW, STATUTE AND OTHER RESERVED RIGHTS INCLUDING THE COPYRIGHT THERETO. REPRODUCTION OF THE MATERIAL HEREIN OR SUBSTANTIAL USE WITHOUT WRITTEN PERMISSION OF CRABTREE, ROHRBAUGH & ASSOCIATES VIOLATES THE COPYRIGHT LAWS OF THE UNITED STATES AND WILL BE SUBJECT TO LEGAL PROSECUTION.

© CRABTREE, ROHRBAUGH & ASSOCIATES, INC 2018

REVISIONS

BRIDGI

HOLMES


ISABEL

THE

01 MM-DD-YR NAME DESCRIPTION OF CHANGES


ARCHITECTS www.cra-architects.com

ASSOCIATES
MORE, MARYLAND
LOTTESVILLE, VIRGINIA
E SULPHUR SPRINGS, WEST V

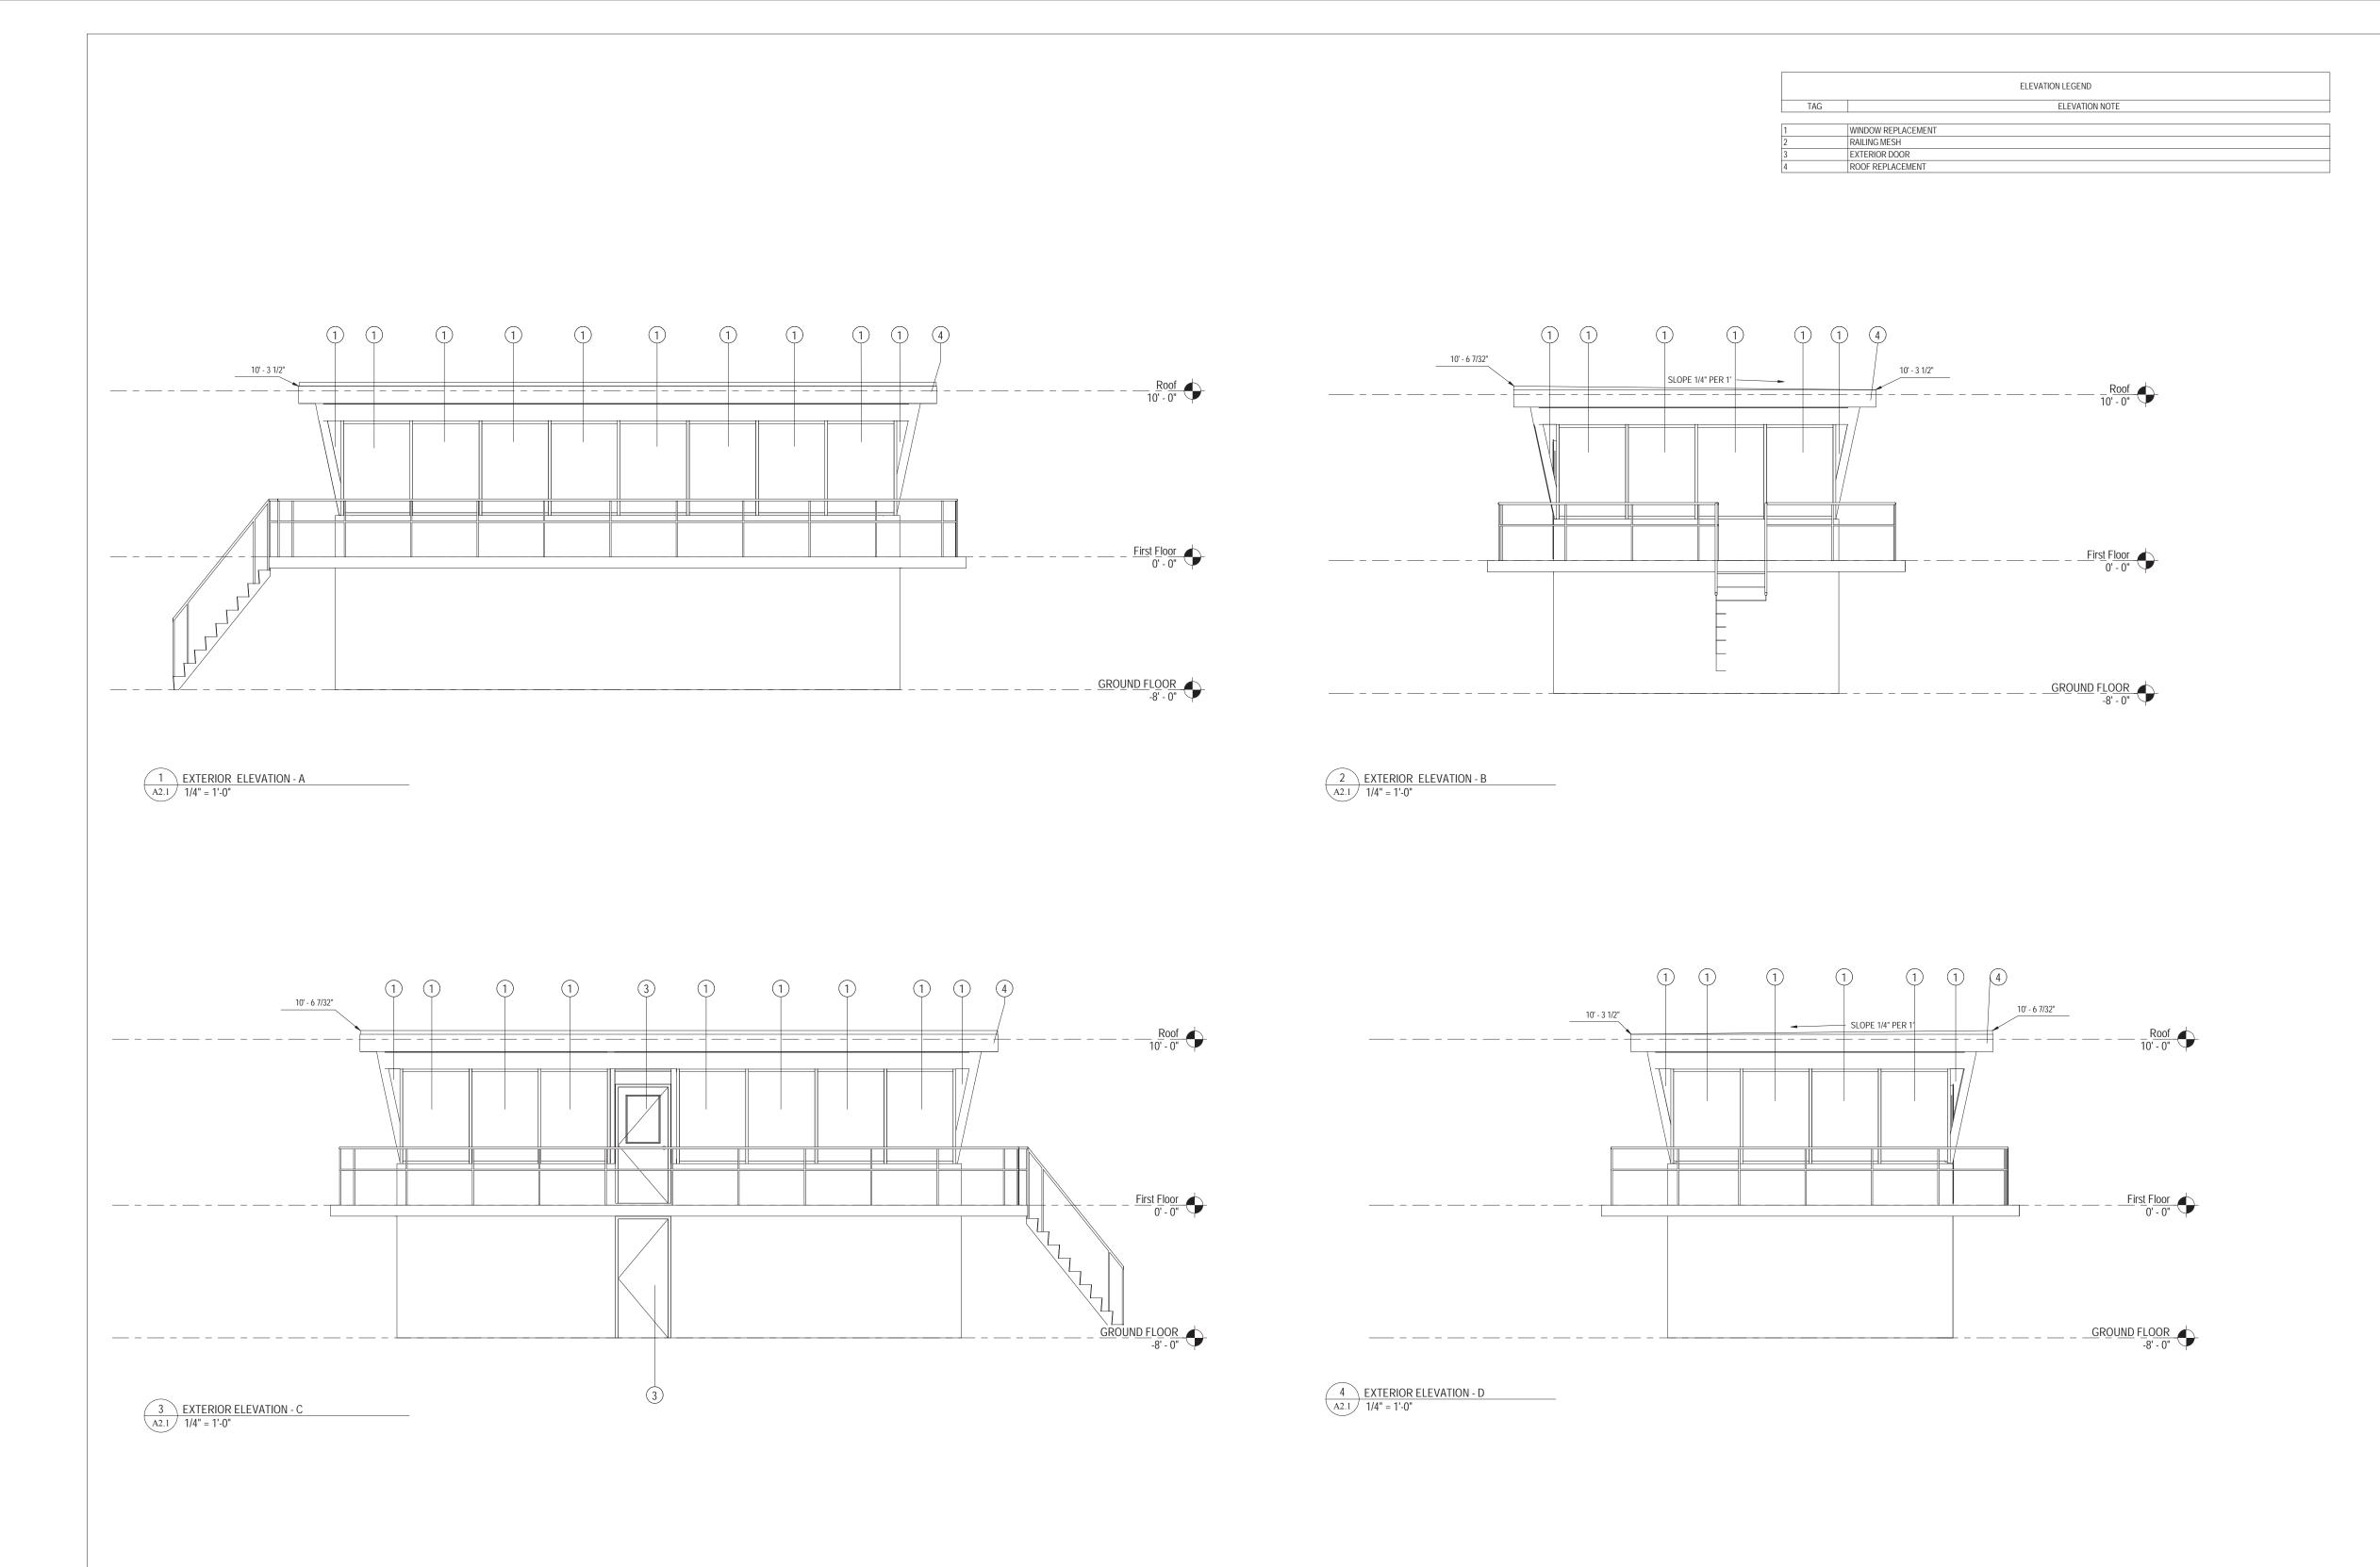



ALL REPORTS, PLANS SPECIFICATIONS AND COMPUTER FILES RELATING TO THIS PROJECT ARE THE PROPERTY OF CRABTREE, ROHRBAUGH & ASSOCIATES. CRABTREE ROHRBAUGH & ASSOCIATES RETAINS ALL COMMON LAW, STATUTE AND OTHER RESERVED RIGHTS INCLUDING THE COPYRIGHT THERETO. REPRODUCTION OF THE MATERIAL HEREIN OR SUBSTANTIAL USE WITHOUT WRITTEN PERMISSION OF CRABTREE, ROHRBAUGH & ASSOCIATES VIOLATES THE COPYRIGHT LAWS OF THE UNITED STATES AND WILL BE SUBJECT TO LEGAL PROSECUTION.

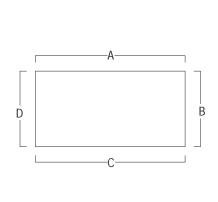

KEY PLAN - EXTERIOR ELEVATION

REVISIONS

01 MM-DD-YR	NAME	DESCRIPTION OF CHANGES

ARCHITECTS www.cra-architects.com

HOLMES BRIDGE THE ISABEL 10 RENOVATIONS

ASSO CRABTREE ROHRBAUGH &

401 EAST WINDING HILL ROAD
MECHANICSBURG PA 17055
717-458-0272
WHITE






OVERALL EXTERIOR ELEVATIONS


November 9, 2018


As indicated

3133

A2.1

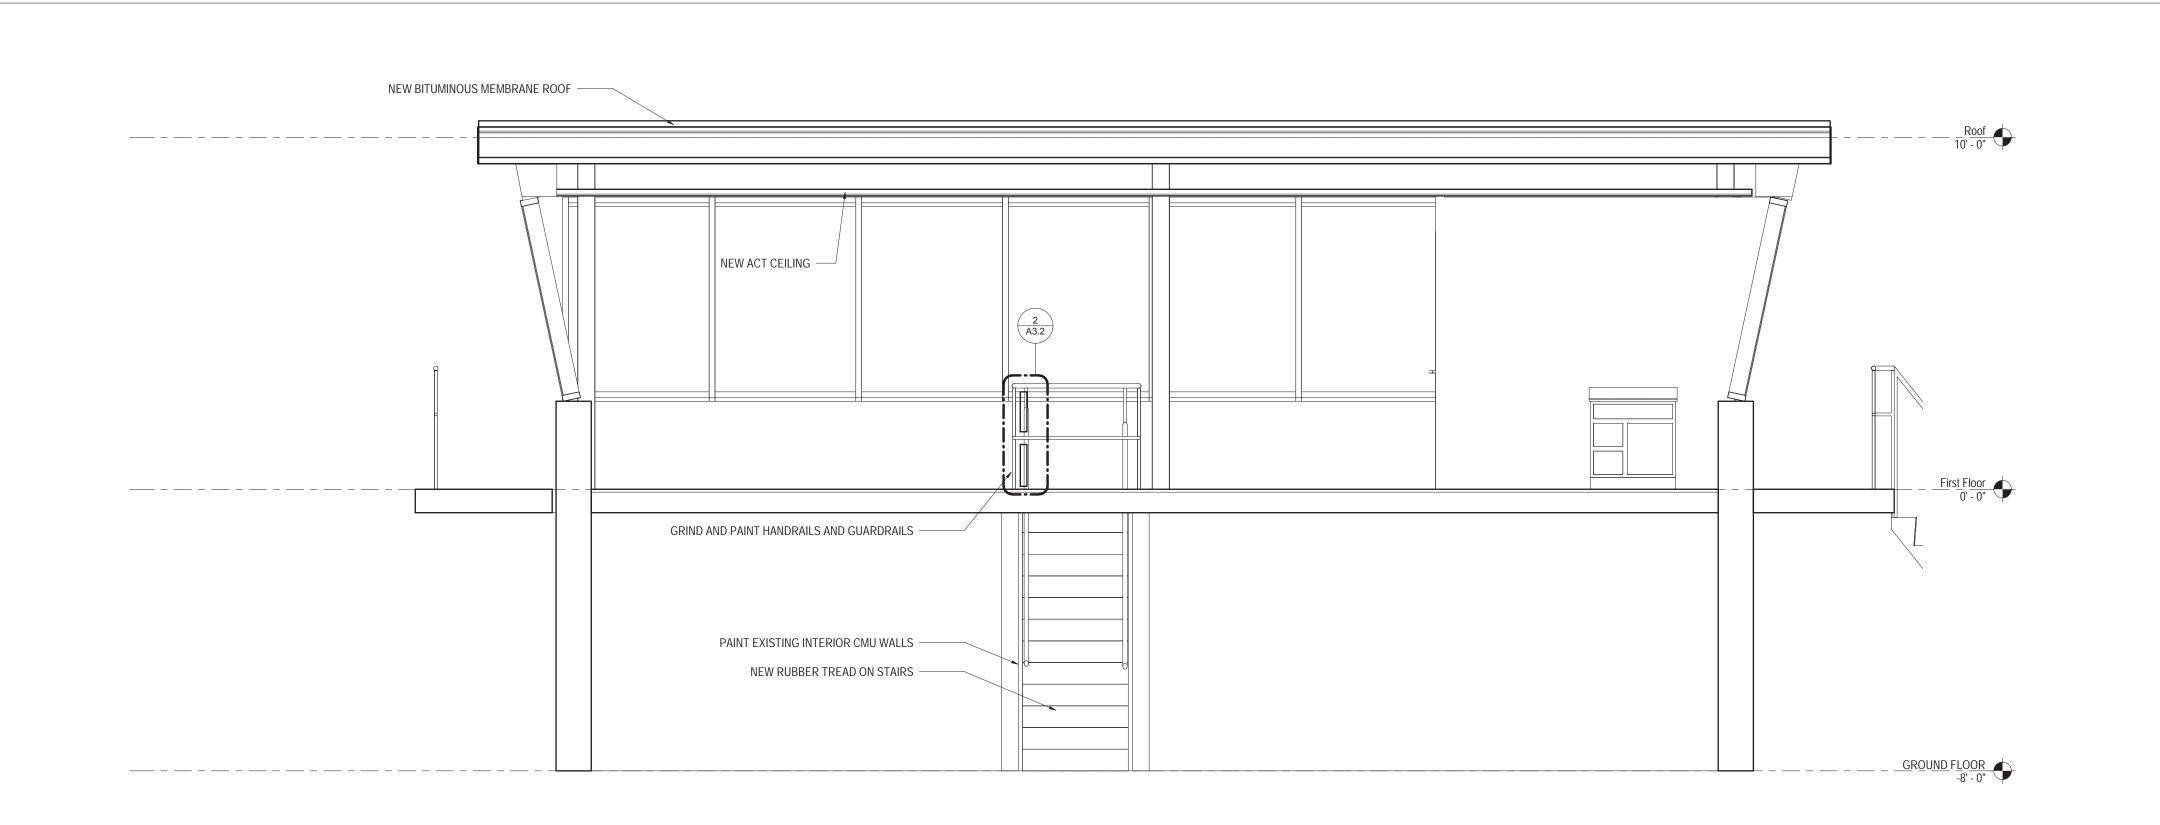

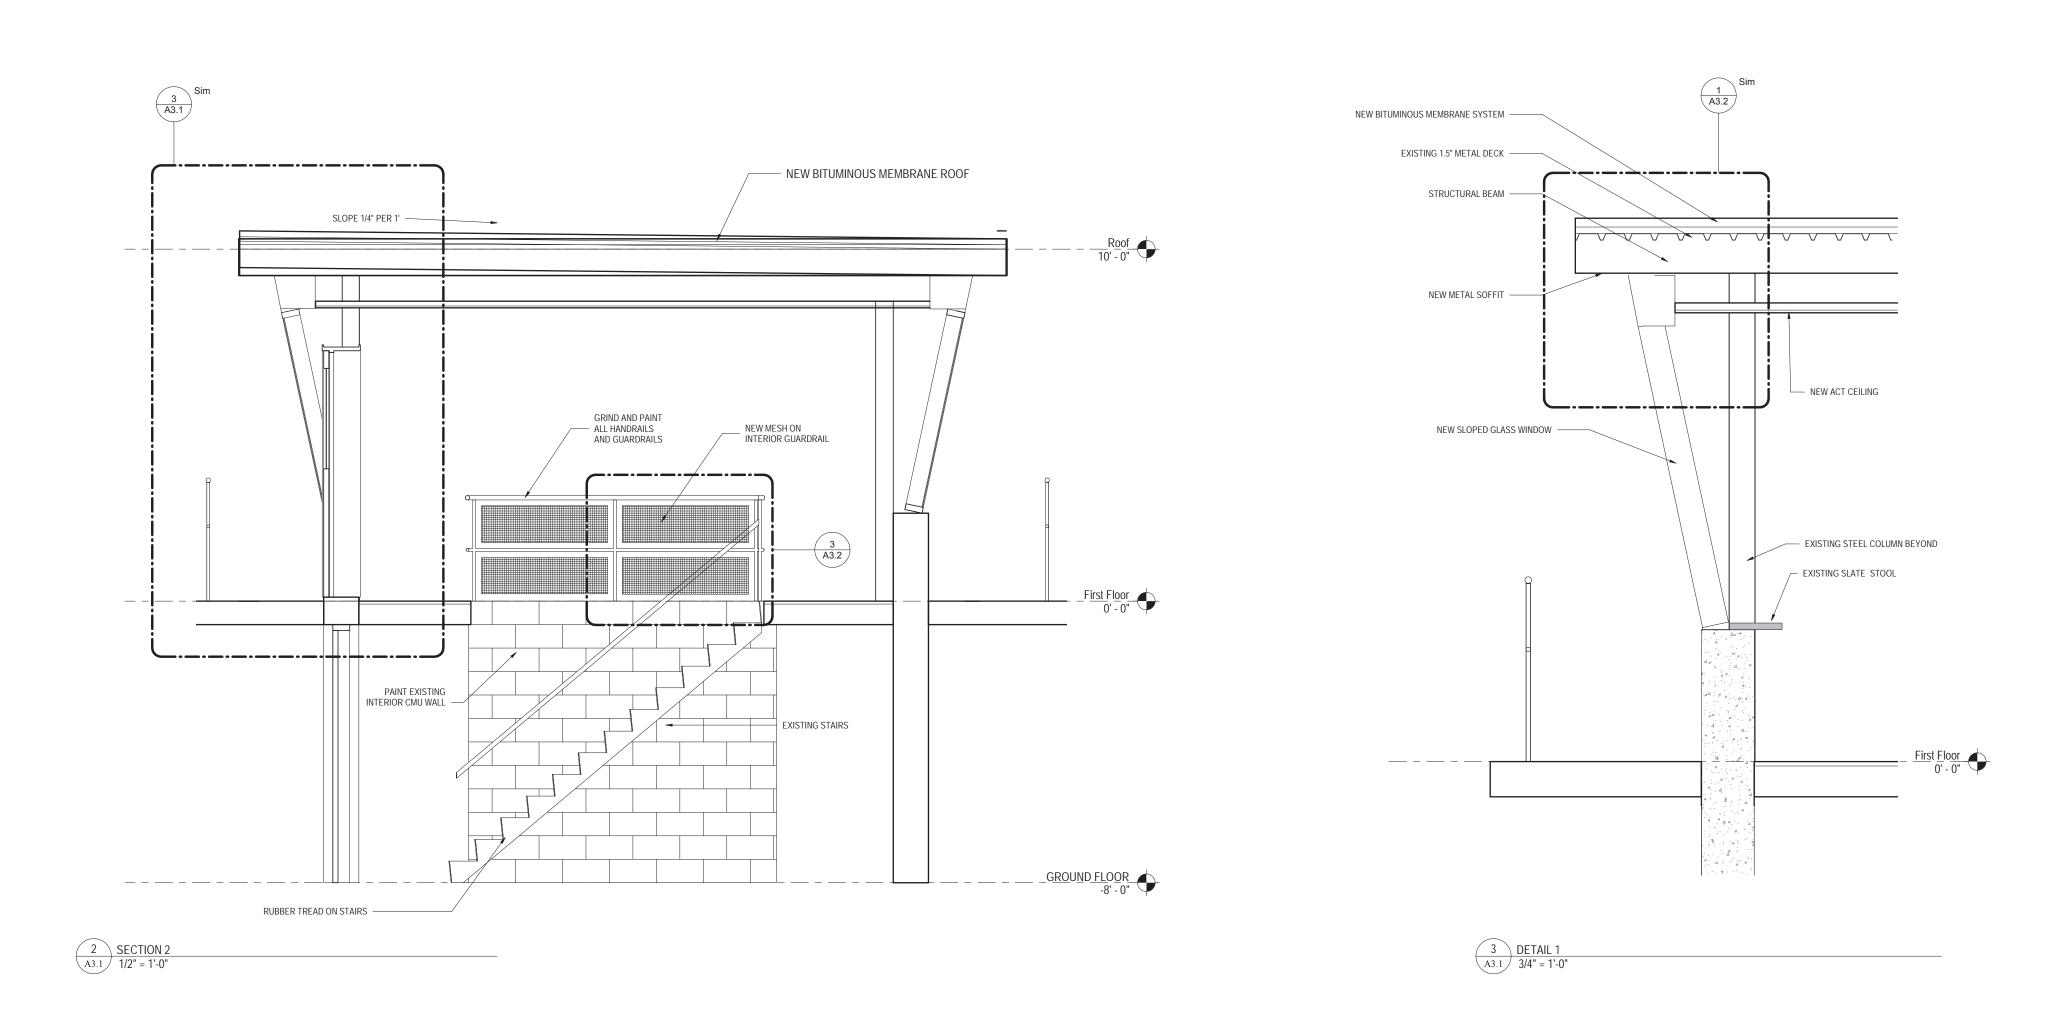

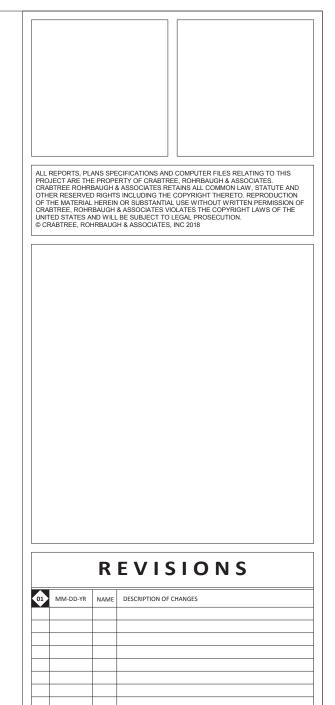

BRIDGI

HOLMES

ISABEL

エ

10

RENOVATIONS

ARCHITE(www.cra-architect


SSO (8E, MARYL


November 9, 2018

BUILDING SECTIONS AND DETAILS

As indicated


3133 A3.1

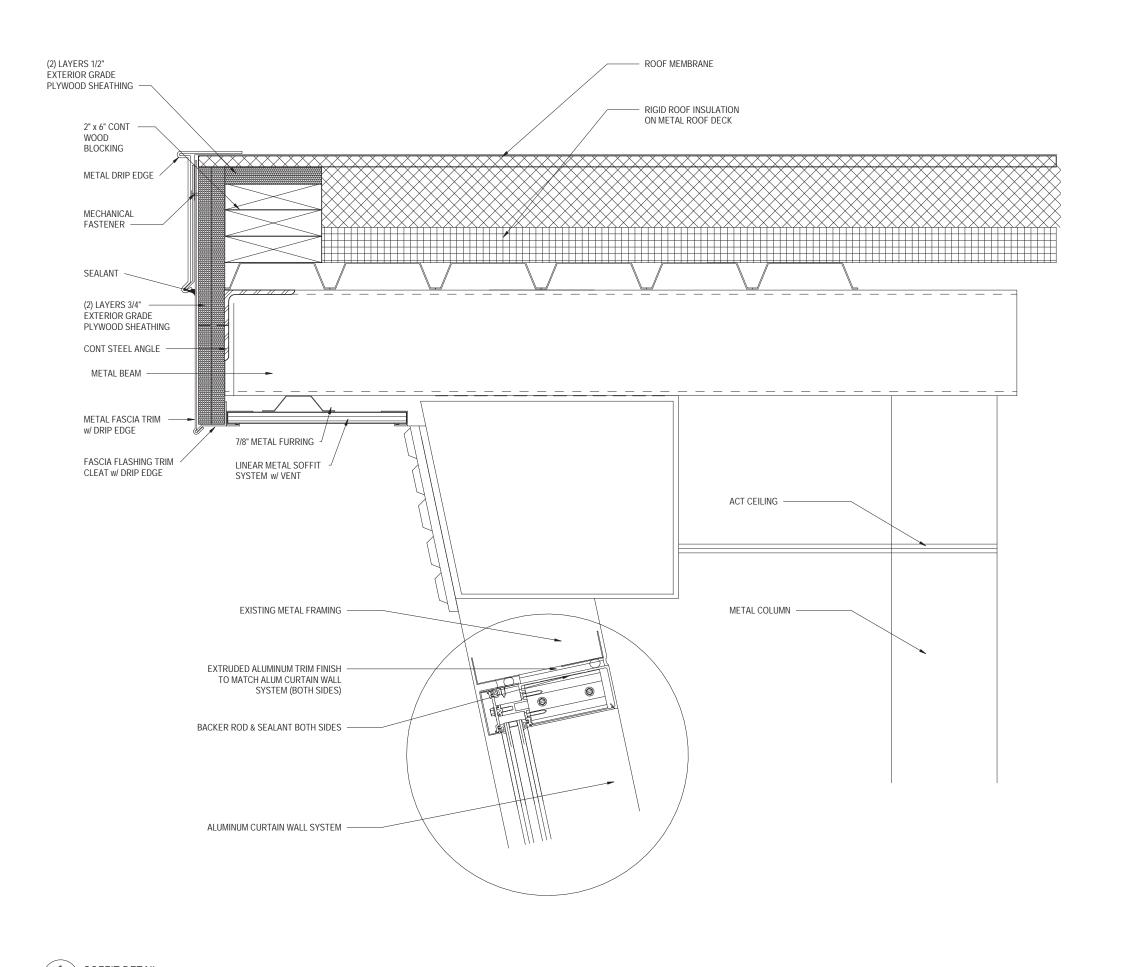

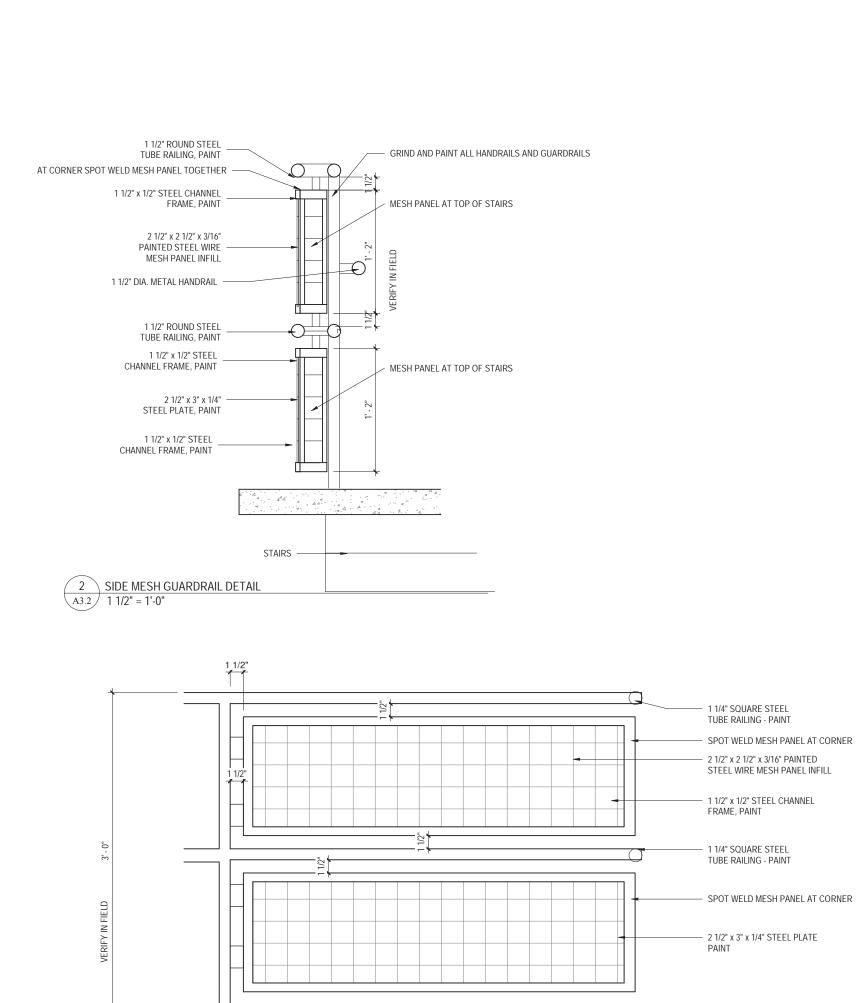

3 MESH GUARDRAIL DETAIL

A3.2 1 1/2" = 1'-0"

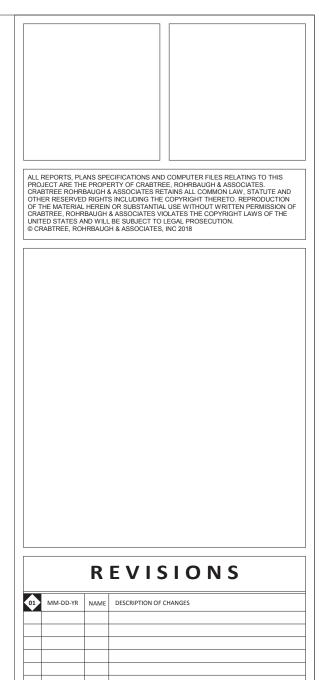

		R	EVISIONS
01	MM-DD-YR	NAME	DESCRIPTION OF CHANGES

ARCHITE(

CIATES

9

BRID(HOLMES CRABTREE ROHRBAUGH & ASSO
401 EAST WINDING HILL ROAD
MECHANICSBURG PA 17055
717-458-0272
WHITE SULPHUR SP THE ISABEL RENOVATIONS TO

SECTION DETAILS

As indicated


08/07/18

PROJECT 3133

A3.2

	ROOM FINISH SCHEDULE									
					WALLS					
		COLOR			WALL	WAIN	SCOT	CEILING		
NUMBER	NAME	SCHEME	FLOOR	BASE	FINISH	FINISH	HEIGHT	FINISH	REMARKS	
101	CONTROL ROOM		VCT	VB	PNT			ACT		
102	TOILET		VCT	VB	PNT			ACT		

		TOILET ACCESSORY SCHEDULE		
No.	DESCRIPTION	MOUNTING	MANUFACTURER	MODEL
1	SOAP DISPENSER	44" MAX TO PUSH BUTTON	OWNER FURNISHED GC INSTALLED	
2	TOILET PARTITION	AS SPECIFIED	AS SPECIFIED	
3	TOILET PAPER DISPENSER	TISSUE ACCESS AT 18" MIN AFF	OWNER FURNISHED GC INSTALLED	
4	MIRROR 18" x 30" w/ SS FRAME	40" AFF TO BOTTOM EDGE OF REFLECTING SURFACE		B-165 (1830)
5	SURFACE-MOUNTED SANITARY NAPKIN DISPOSAL	Satin Finish	Bobrick Washroom Equipment, Inc.	B-270

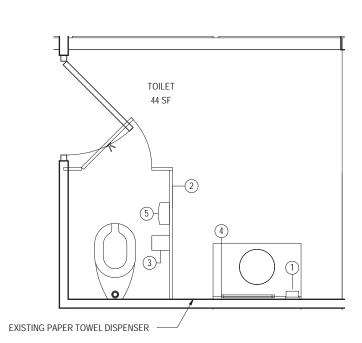

1 LARGE SCALE TOILET PLAN A6.1 1/2" = 1'-0"

LEGEND

<u>MATERIALS</u> <u>SYMBOLS</u> SECTION SECTION OR DETAIL NO. UNDISTURBED EARTH SHEET NO. CONTROLLED FILL **BUILDING SECTION** CONCRETE SECTION INDICATOR GRANULAR FILL BUILDING SECTION SHEET NO. CONC MASONRY UNIT **DETAIL** FACE MASONRY UNITS DETAIL NO. DETAIL SHEET NO. WOOD BLOCKING **INTERIOR ELEVATION** RIGID INSULATION ELEVATION NO. BATT INSULATION ELEVATION SHEET NO. **DOOR TAG** ARCHITECTURAL DRAWING NO. DESIGNATIONS DOOR NUMBER WINDOW TAG WINDOW ELEVATION ----- INDICATES FLOOR PLANS A1.1 — INDICATES SHEET NUMBER WALL TYPE TAG ---- INDICATES ELEVATIONS WALL IDENTIFICATION A2.1 INDICATES SHEET NUMBER MILLWORK SECTION SECTION OR DETAIL NO. INDICATES SECTIONS A3.1 — INDICATES SHEET NUMBER DETAIL SHEET NO. INDICATES LARGE SCALE PLANS A4.1 INDICATES SHEET NUMBER **ROOM TAG** INDICATES GENERAL DETAILS ROOM NAME A5.1 INDICATES SHEET NUMBER BLDG. & ROOM NO. INDICATES SCHEDULES AND FRAME ELEVATIONS

A6.1 INDICATES SHEET NUMBER

I4.1 INDICATES SHEET NUMBER

17.1 INDICATES SHEET NUMBER

INDICATES INTERIOR LARGE SCALE LAYOUTS

INDICATES FLOOR PATTERN LAYOUTS

NORTH ARROW

ARCHITECTURAL ABBREVIATIONS

FD FLOOR DRAIN

FIN FINISH(ED) FL FLOOR

FRT FIRE RETARDANT
FT FOOT or FEET

GA GAUGE GALV GALVANIZED GC GENERAL CONTRACTOR

FIRE EXTINGUISHER (CABINET)

FFE FINISHED FLOOR ELEVATION

FRP FIBERGLASS REINFORCED PANEL

	BBREVIATION LIST IS A STANDARD AND NOT AL CESSARILY USED ON THIS PROJECT	LL ABBRE	VIATIONS		
ABV AC ACT AED AFF ALUM ALT AP ARCH	ABOVE ACOUSTICAL ACOUSTICAL CEILING TILE AUTOMATED EXTERNAL DEFIBRILLATOR ABOVE FINISH FLOOR ALUMINUM ALTERNATE ACCESS PANEL ARCHITECT(URAL)	HGT HP HM HORI	HANDICAPPED HARDWARE HEIGHT HIGH POINT HOLLOW METAL Z HORIZONTAL S HEATING, VENTILATION & AIR CONDITIONING	SFRM SH SIM SJ	SCHEDULE SECTION SQUARE FEET SPLIT FACE CONCRETE MASONRY UNIT SPRAY-APPLIED FIRE RESISTIVE MATERIAL SHEATHING SIMILAR SCORE JOINT SPECIFICATIONS SQUARE
BD BIT BLDG BLK BM	BOARD BITUMINOUS BUILDING BLOCK(ING) BENCH MARK		INSIDE DIAMETER INFORMATION L INSULATION INTERIOR INVERT	SS STD STR SYN	STAINLESS STEEL STANDARD STRUCTURAL SYNTHETIC
BOT BRG BSMT	BOTTOM BEARING BASEMENT	JST JT J	JOIST OINT	T TG THK TOM	TREAD TEMPERED GLASS THICK(NESS) TOP OF MASONRY
CLR CL CJ CLG CMU	CLEAR CENTERLINE CONTROL JOINT CEILING CONCRETE MASONRY UNIT	KIT	KITCHEN(ETTE)	TOP TOS TYP	TOP OF PLANK TOP OF STEEL TYPICAL
COL CONC CONT	CONCRETE WASONRY UNIT COLUMN CONCRETE CONTINUOUS CONSTRUCTION	LAV LB LF	LAWATORY POUND LINEAL FEET LONG LEG HORIZONTAL	UL UNO	UNDERWRITERS LABORATORIES UNLESS NOTED OTHERWISE
CONTR	CONTRACTOR CONTRACTOR CORDINATE CERAMIC TILE	LLV LP	LONG LEG VERTICAL LOW POINT	VCT VERT VIF	VINYL COMPOSITION TILE VERTICAL VERIFY IN FIELD
DEMO DET DF DIM DN DR DS DWG	DEMOLITION DETAIL DRINKING FOUNTAIN DIMENSION DOWN DOON DOOR DOWNSPOUT DRAWING	MAT MAX MC MECH MEP MIN MISC MO	MANUFACTURER MATERIAL MAXIMUM MECHANICAL CONTRACTOR I MECHANICAL, ELECTRICAL, PLUMBING MINIMUM MISCELLANEOUS MASONRY OPENING MOUNTED or MOUNTING	WP W/ WD WG	WATERPROOFING WITH WOOD WIRE GLASS
EA EC EJ EL ELEC ELEV	EACH ELECTRICAL CONTRACTOR EXPANSION JOINT ELEVATION ELECTRICAL ELEVATOR	NIC NO NOM NTS	NOT IN CONTRACT NUMBER NOMINAL NOT TO SCALE		BREVIATION MBOLS
ENT EQ EQUIP EX EXP EXT EW	ENTRANCE EQUAL EQUIPMENT EXISTING EXPOSED EXTERIOR EACH WAY		ON CENTER OUTSIDE DIAMETER G OPENING OPPOSITE	Ø DIA	NTER LINE METER US OR MINUS
		DTM	DARTITION		


PTN PARTITION
PC PLUMBING CONTRACTOR
PL PLATE
PLAM PLASTIC LAMINATE

PLYWOOD
PSF POUNDS PER SQUARE FOOT
PSI POUNDS PER SQUARE INCH
PTD PAINTED

QT QUARRY TILE

R RISER or RADIUS RD ROOF DRAIN

GC GENERAL CONTRACTOR RD ROOF DRAIN
GFCMU GROUND FACE CONCRETE MASONRY UNIT REC RECESSED
GL GLASS RECT RECTANGLE
GCMU GLAZED CONCRETE MASONRY UNIT REINF REINFORCED or REINFORCING
GWB GYPSUM WALL BOARD REQD REQUIRED
GWBAR GYPSUM WALL BOARD ABUSE RESISTANT RM ROOM
GWBMR GYPSUM WALL BOARD MOISTURE RESISTANT RO ROUGH OPENING
GWBFR GYPSUM WALL BOARD FIRE RATED RWC RAIN WATER CONDUCTOR

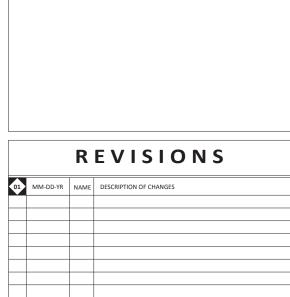

ALL REPORTS, PLANS SPECIFICATIONS AND COMPUTER FILES RELATING TO THIS PROJECT ARE THE PROPERTY OF CRABTREE, ROHRBAUGH & ASSOCIATES. CRABTREE ROHRBAUGH & ASSOCIATES RETAINS ALL COMMON LAW, STATUTE AND OTHER RESERVED RIGHTS INCLUDING THE COPYRIGHT THERETO. REPRODUCTION OF THE MATERIAL HEREIN OR SUBSTANTIAL USE WITHOUT WRITTEN PERMISSION OF CRABTREE, ROHRBAUGH & ASSOCIATES VIOLATES THE COPYRIGHT LAWS OF THE UNITED STATES AND WILL BE SUBJECT TO LEGAL PROSECUTION.

© CRABTREE, ROHRBAUGH & ASSOCIATES, INC 2018

D

ARCHITE(
www.cra-architect CIATE ASSO MORE, MARYL CRABTREE ROHRBAUGH &

401 EAST WINDING HILL ROAD

MECHANICSBURG PA 17055

717-458-0272

WHITE

BRID(HOLMES THE ISABEL 10 RENOVATIONS


ROOM FINISH SCHEDULE, SIGNAGE SCHEDULE, LARGE
SCALE TOILET PLAN AND
GENERAL INFORMATION

November 9, 2018

1/2" = 1'-0"

PROJECT

A6.1

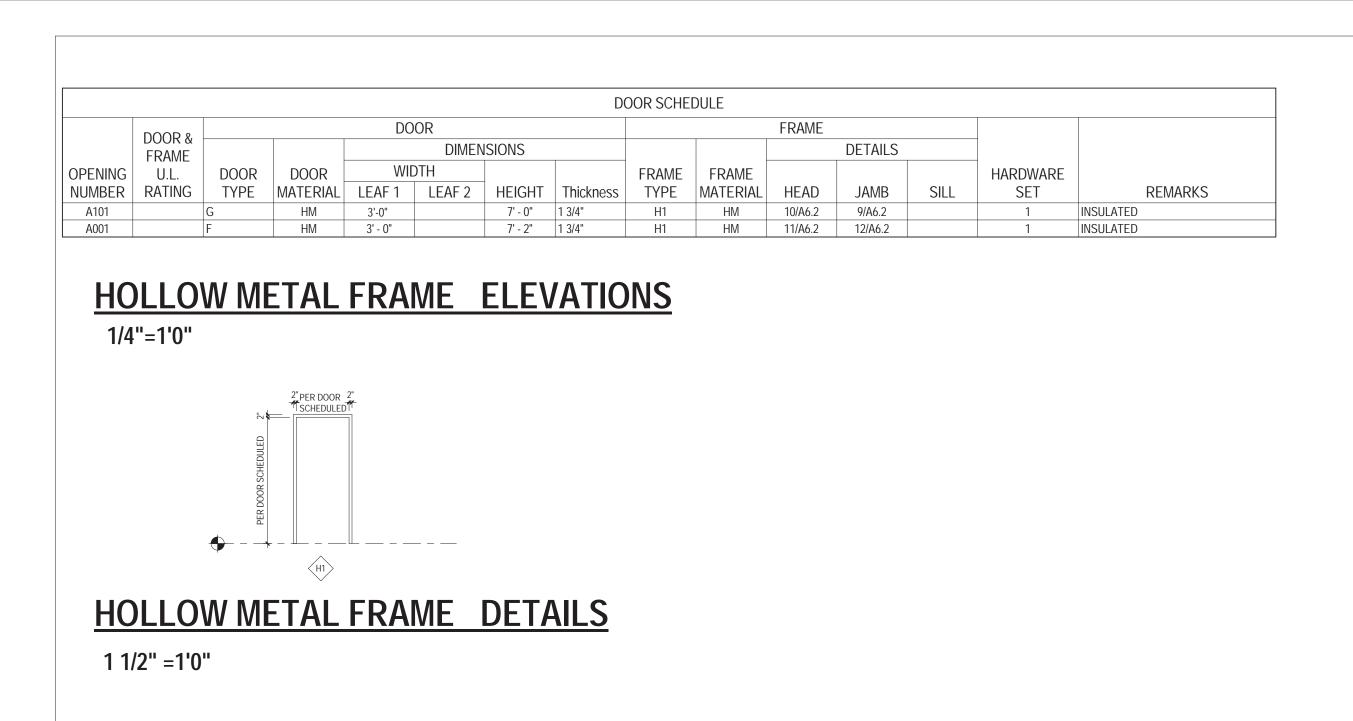

METAL HEADER 👼 上


APPLIED STOP

APPLIED STOP GLAZING (WHERE OCCURS)

1 15/16"

(WHERE OCCURS)

DOOR SIDE

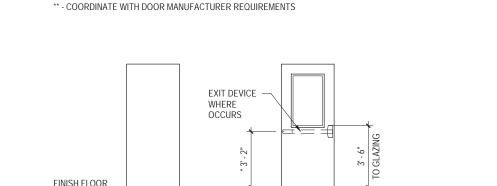

- SEALANT AROUND

BOTH SIDES - TYP

- MASONRY WALL

- RECOMMENDED MOUNTING HEIGHT FROM FINISHED FLOOR TO CENTER LINE OF FIRE EXIT DEVICE

DOOR TYPES


APPLIED STOP _____ 5/8", 2"


(WHERE OCCURS)

GLAZING —

(WHERE OCCURS)

4 HM EXTERIOR HEAD - EXISTING CMU
A6.2 1 1/2" = 1'-0"

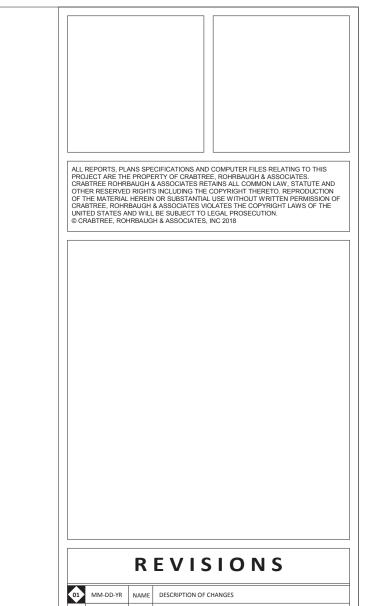

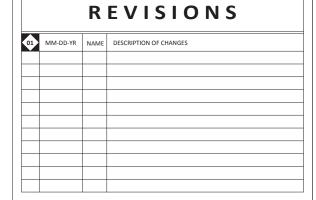

ARCHITECTS

BRID

ISABEL

쁖

RENOVATIONS

DOOR SCHEDULE AND

FRAME ELEVATION

November 9, 2018

As indicated

PROJECT 3133

A6.2


ALUMINUM CURTAIN WALL FRAME ELEVATIONS


SANDED SMOOTH

TUBE COLUMN

FRAME ANCHOR WELDED TO STEEL

APPLIED STOP — (WHERE OCCURS)

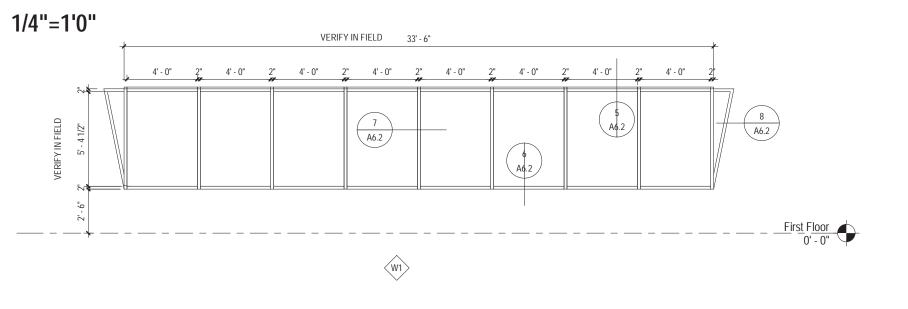

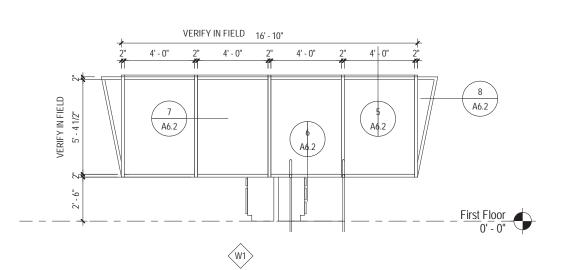


MASONRY WALL


SEALANT AROUND

BOTH SIDES - TYP


8 3/4" @ 8" CMU (10 3/4" @ 10" CMU)


3 HM EXTERIOR HEAD - EXISTING CMU A6.2 1 1/2" = 1'-0"

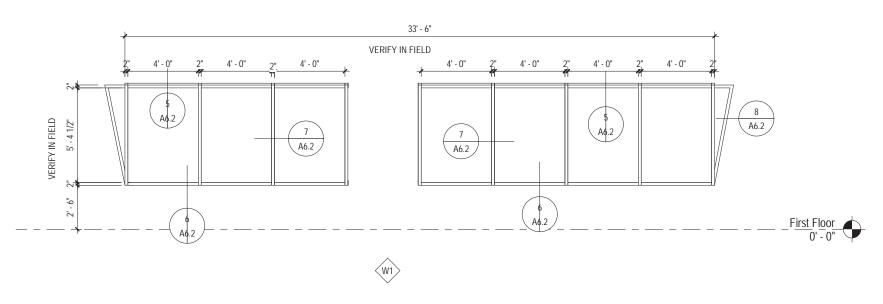


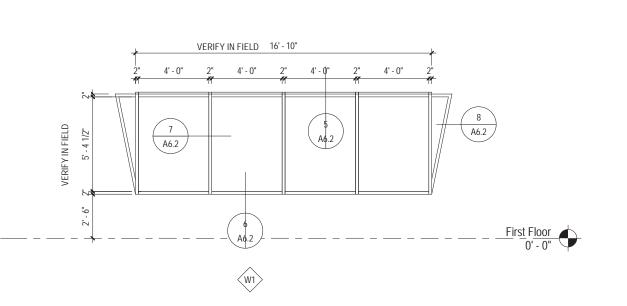



ALUMINUM CURTAIN WALL FRAME DETAILS

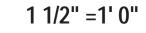

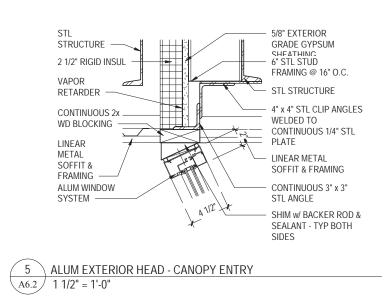

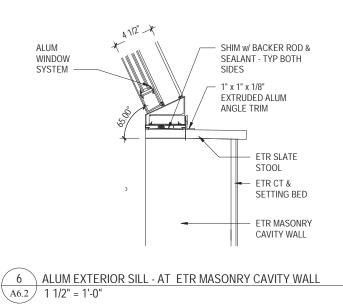

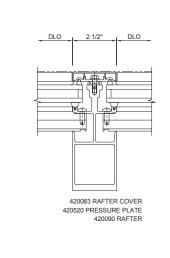


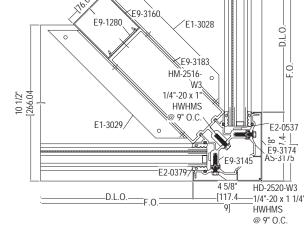



A6.2 ALUM MULLION DETAIL
3" = 1'-0"

8 CORNER WINDOW DETAIL
A6.2 1" = 10'-0"

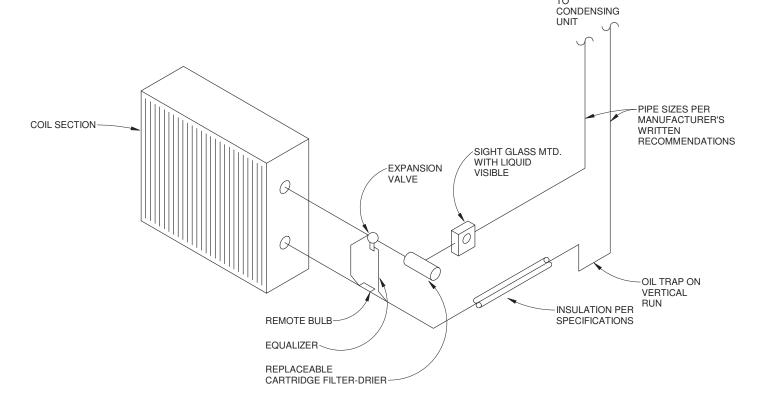

MECHANICAL GENERAL NOTES (APPLY TO ALL DRAWINGS)

- 1. ALL WORK AND EQUIPMENT SHALL COMPLY WITH ALL APPLICABLE LAWS, CODES, AND REQUIREMENTS, OF ALL AUTHORITIES HAVING JURISDICTION, INCLUDING BUT NOT LIMITED TO THE INTERNATIONAL MECHANICAL CODE, THE INTERNATIONAL PLUMBING CODE. THE INTERNATIONAL ENERGY CODE, THE LOCAL FIRE MARSHALL, UNDERWRITERS LABORATORY, IRI, FM, OSHA, AND THE NATIONAL ELECTRICAL CODE. MODIFICATIONS REQUIRED BY THE ABOVE AUTHORITIES IN ORDER TO BRING THE PROJECT INTO CODE COMPLIANCE SHALL BE MADE AT NO ADDITIONAL COST TO OWNER. IF CONTRACT DOCUMENTS ARE MORE STRINGENT THAN CODE REQUIREMENTS, THE CONTRACT DOCUMENTS SHALL GOVERN.
- 2. ALL SPECIFICATIONS AND DRAWINGS ARE COMPLIMENTARY AND MUST BE USED IN COMBINATION TO OBTAIN COMPLETE CONSTRUCTION INFORMATION. ANY CONFLICTING INFORMATION SHALL BE BROUGHT TO THE ATTENTION OF THE ENGINEER, AND WORK SHALL CEASE ON THAT PORTION OF THE PROJECT UNTIL CLARIFICATIONS ARE ISSUED

 3. WORK SHALL BE EXECUTED IN A GOOD WORKMANLIKE MANNER USING MECHANICS IN THEIR

RESPECTIVE TRADES. THE CONTRACTOR IS SOLELY RESPONSIBLE FOR ALL CONSTRUCTION MEANS,

- METHODS, TECHNIQUES, SEQUENCES, AND PROCEDURES FOR COORDINATING THE WORK UNDER THIS CONTRACT. UPON COMPLETION OF CONSTRUCTION, CONTRACTOR SHALL DELIVER COMPLETE AND FUNCTIONAL SYSTEMS AS ENCOMPASSED BY THE CONTRACT. ALL EQUIPMENT SHALL BE INSTALLED PER MANUFACTURER'S RECOMMENDATIONS AND CODE REQUIREMENTS.


 4. WHEREVER FIRE RATED ASSEMBLIES ARE PENETRATED FOR WIRE, DUCT OR PIPE PASSAGE, SEAL AROUND PASSAGES WITH CODE APPROVED, LABORATORY TESTED AND LABELED SEALANT OF FIRE RESISTANCE RATING NOT LESS THAN THAT OF PENETRATED ASSEMBLY THAT WILL PREVENT PASSAGE OF FIRE AND SMOKE. INSTALL APPROPRIATELY RATED FIRE, SMOKE OR COMBINATION DAMPERS IN ALL
- DUCT THAT PENETRATES RATED ASSEMBLIES WHETHER SHOWN OR NOT. DRAWING SYMBOLS ARE USED AS AN AIDE, NOT TO DEFINE AN EXACT NUMBER OF PIECES OF EQUIPMENT.

 5. WIRING OF ALL MOTORIZED OPERATORS AND THERMOSTATS, REGARDLESS OF VOLTAGE ARE THE RESPONSIBILITY OF THE MECHANICAL CONTRACTOR. CONTRACTOR SHALL MAKE ALL FINAL EQUIPMENT CONNECTIONS AND PROVIDE THE NECESSARY ADAPTERS, FITTINGS, VALVES, AND DEVICES FOR A COMPLETE OPERABLE SYSTEM. COORDINATE
- REQUIREMENT FOR PROVISION OF CONTACTORS, AND CONTROL WIRING FOR PROPER FUNCTIONING SYSTEM WITH ELECTRICAL CONTRACTOR. MOTOR STARTERS, AND DISCONNECTS ARE TO BE PROVIDED BY THIS CONTRACTOR FOR INSTALLATION BY OTHERS.

 7. CLEAN ALL MECHANICAL EQUIPMENT AND DUCTWORK OF ALL CONSTRUCTION DUST AT PROJECT
- COMPLETION. REPLACE ALL FILTERS PRIOR TO AIR BALANCING. PROVIDE ONE SPARE SET OF FILTERS FOR EACH PIECE OF EQUIPMENT TO OWNER. NEWLY INSTALLED HVAC EQUIPMENT SHALL NOT BE USED AT ANY TIME FOR TEMPORARY CONDITIONING OF THE SPACE DURING CONSTRUCTION.


 8. COORDINATE INSTALLATION OF NEW WORK WITH ARCHITECTURAL PLANS, STRUCTURAL PLANS, AND LIGHTING PLANS. CONTRACTOR SHALL TAKE ALL INTERFERENCES INTO CONSIDERATION. PROVIDE ALL NECESSARY OFFSETS OR TRANSITIONS WITH EQUIVALENT AREAS TO MATCH SIZES AS INDICATED ON DRAWINGS.
- 9. DO NOT INSTALL ANY MECHANICAL WORK ABOVE ELECTRICAL PANELS. 10. ALL DIMENSIONS AND PIPE SIZES ARE IN INCHES UNLESS NOTED OTHERWISE.
- 11. SLEEVE AND SEAL ALL PIPE, OR DUCT PENETRATIONS OF WALLS AND FLOORS. PACK VOID BETWEEN PIPE, OR DUCT AND SLEEVE WITH INSULATION IN NON-RATED WALLS AND FLOORS. PACK VOID BETWEEN PIPE, OR DUCT AND SLEEVE WITH INSULATION IN FIRE-RATED WALLS AND FLOORS, APPLY INTUMESCENT FIRE SAFING COMPOUND AT PENETRATION, MAINTAINING INTEGRITY AND RATING OF FIRE SEPARATION. SLEEVES THROUGH FLOORS SHALL EXTEND 2" ABOVE FLOOR, BE GROUTED INTO PLACE AND WATERPROOFED. PIPING THROUGH EXTERIOR WALLS SHALL BE SLEEVED AND SEALED WEATHER TIGHT.
- 12. FURNISH AND INSTALL IDENTIFICATION TAGS FOR ALL H.V.A.C. EQUIPMENT. TAGS SHALL BE RIVETED TO ASSOCIATED PIECE OF EQUIPMENT. TAGS SHALL BE CLEAR WITH BLACK LETTERING THAT IDENTIFIES UNIT VALVE SERVES. TAGS SHALL TRANSPARENT TO BLEND IN WITH CEILING TILE. M.C. SHALL CONSULT
- WITH OWNER TO SHOW SAMPLE TAGS BEFORE PURCHASING TAGS. 13. FURNISH AND INSTALL ALL EQUIPMENT ELECTRICAL DISCONNECTS UNLESS INDICATED OTHERWISE. DISCONNECTS SHALL BE PROVIDED BY EQUIPMENT MANUFACTURER.

3 SPLIT SYSTEM REFRIGERANT PIPING DETAIL NO SCALE

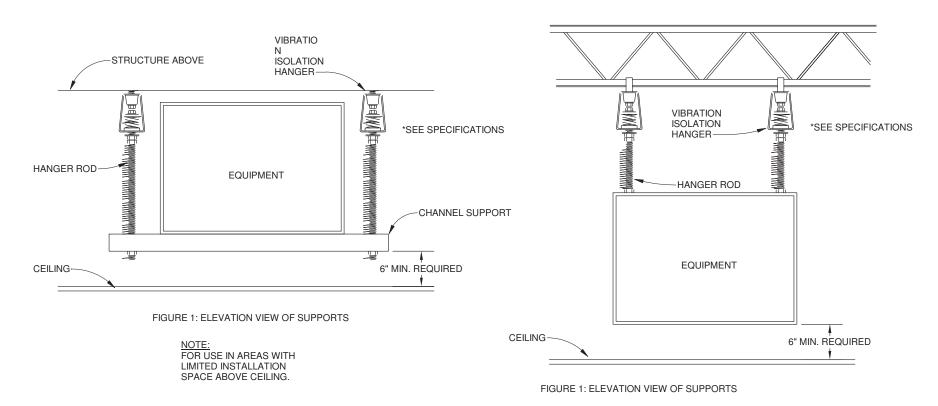

VIBRATION ISOLATION FOR SUSPENDED EQUIPMENT DETAIL

NO SCALE

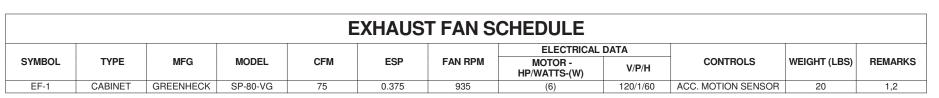


REMARKS:

1. PROVIDE WITH FACTORY DISCONNECT SWITCH AND ACCESSORY MOTION SENSOR.

HEAT PUMP SPLIT SYSTEM UNIT SCHEDULE													
			SUPPLY FAN		COOLING /				ELECTRICAL DATA				
SYMBOL	MFG	MODEL	AIR FLOW	OUTDOOR UNIT SYMBOL	HEATING RATED CAP (MBH)		SEER R	REFRIG. TYPE	MCA	МОР	V/P/H	WEIGHT (LBS.)	REMARKS
MSI-1	LG	LC247HV / LUU247HV	530	MSO-1	24.0 / 27.0	2	17.0	R-410A	18.1	30	208-230/60/1	57	1,2,3,4
MSI-2	LG	LC247HV / LUU247HV	530	MSO-1	24.0 / 27.0	2	17.0	R-410A	18.1	30	208-230/60/1	57	1.2.3.4

- REMARKS:
 1. PROVIDE UNIT WITH LOW AMBIENT KIT AND WIND BAFFLE.
 2. SINGLE POINT POWER CONNECTION TO OUTDOOR UNIT. EC TO PROVIDE DISCONNECT SWITCH FOR OUTDOOR AND INDOOR UNIT. EC TO PROVIDE CONDUIT AND WIRE FROM OUTDOOR UNIT.
- 3. PROVIDE UNIT WITH ACCESSORY MINI CONDENSATE PUMP. 4. OUTDOOR UNIT MOUNTED ON EXISTING STRUCTURE.

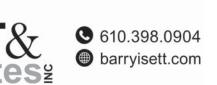

NO SCALE

4 CIATE ROHRBAI REET, SUITE 200 CRABTREE F 250 WEST MAIN STRE CHARLOTTESVILLE V 434-975-7262 FAX 4

HITE

UNITED STATES AND WILL BE SUBJECT TO LEGAL PROSECUTION.
© CRABTREE, ROHRBAUGH & ASSOCIATES, INC 2017

REVISIONS

01 MM-DD-YR NAME DESCRIPTION OF CHANGES


ABE <u>S</u> RENOVATIONS

RID

 \Box


FILENAME: 18016 Holmes Bridge NC Revit-18 HVAC.rv

NOVEMBER 2, 2018

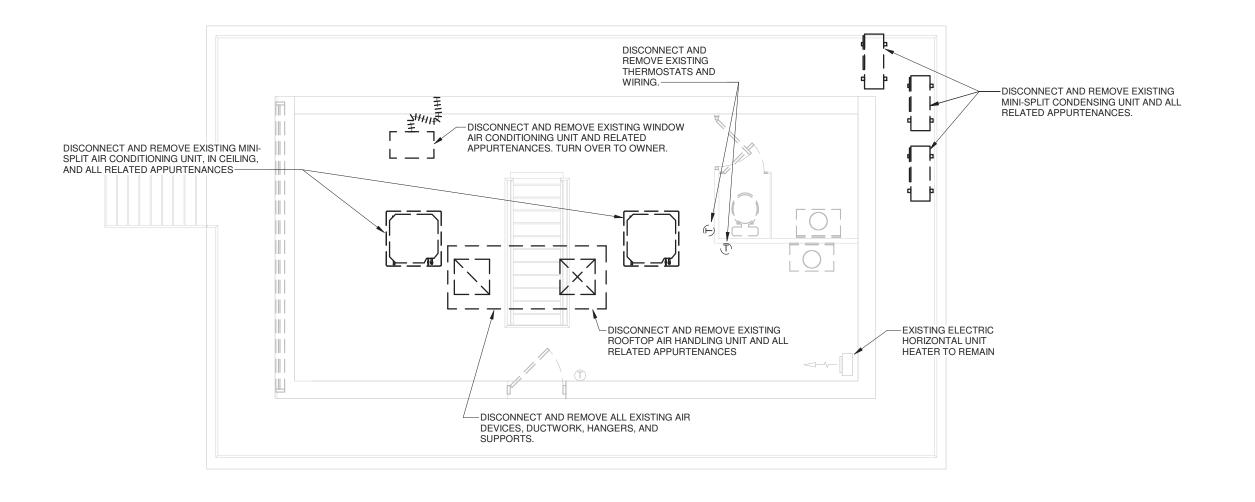


OVERALL CONTROL HOUSE LEVEL PLAN - MECHANICAL DEMOLITION

1/4" = 1'-0"

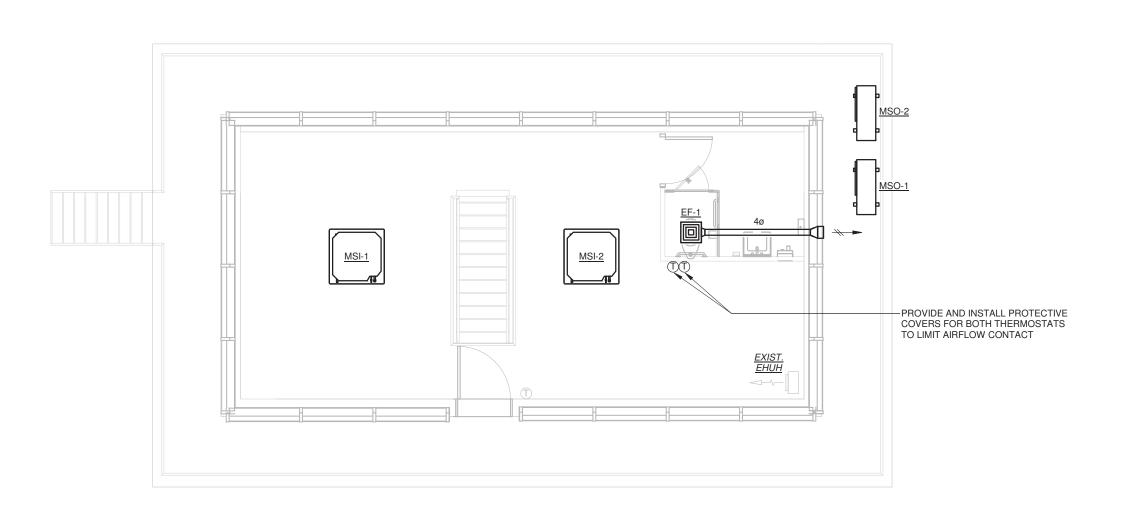

2 M1.1 OVERALL CONTROL HOUSE LEVEL PLAN - MECHANICAL



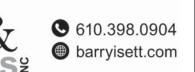



SEAL 045985	
REPORTS, PLANS SPECIFICATIONS AND QUECT ARE THE PROPERTY OF CRABTREI ABTREE ROHRBAUGH & ASSOCIATES RETHER RESERVED RIGHTS INCLUDING THE CITHE MATERIAL HEREIN OR SUBSTANTIAL ABTREE, ROHRBAUGH & ASSOCIATES VICTED STATES AND WILL BE SUBJECT TO LEARTHEE, ROHRBAUGH & ASSOCIATES, I	E, ROHRBAUGH & ASS AINS ALL COMMON LA COPYRIGHT THERETC USE WITHOUT WRITT LATES THE COPYRIG EGAL PROSECUTION.

01	MM-DD-YR	NAME	DESCRIPTION OF CHANGES

BRIDGE

THE ISABE

RENOVATIONS

ARCHITECTS

ASSO VEST MAIN STR ROHRBAUGH & HILL ROAD | 250 WE

CRABTREE ROHR
401 EAST WINDING HILL ROAD
MECHANICSBURG PA 17055
717-458-0272 FAX 717-458-00

OVERALL CONTROL HOUSE LEVEL PLANS - MECHANICAL

NOVEMBER 2, 2018

PLOT SCALE: 1/4" = 1'-0"

PROJECT 3133 FILENAME: 18016 Holmes Bridge NC Revit-18 HVAC.rvt

	PLUMBING SYMBOLS
<u></u>	GATE VALVE
— <u>—</u> —	GLOBE VALVE
— 	CHECK VALVE
	BUTTERFLY VALVE
	BALL VALVE
	PLUG VALVE
GPM	CALIBRATED BALANCING SHUT-OFF VALVE & GPM SETTING
—————————————————————————————————————	ANGLE VALVE
— ☼—	TWO-WAY CONTROL VALVE
	THREE-WAY CONTROL VALVE
sı	SOLENOID VALVE
	STRAINER
<u> </u>	PRESSURE REGULATING VALVE
*	SAFETY RELIEF VALVE
	VENTURI FLOW MEASURING DEVICE
[AS]	AIR SEPARATOR
─ ─	UNION
	TEMPERATURE/PRESSURE TEST PLUG
<u></u>	PRESSURE GAUGE WITH GAUGE COCK
<u> </u>	THERMOMETER
•—————————————————————————————————————	WALL HYDRANT (NON-FREEZE)
C—+ NFRH	ROOF HYDRANT (NON-FREEZE)
<u> </u>	HOSE BIBB
<u>CP-#</u>	PUMP
<u>CP-#</u>	CIRCULATOR PUMP
□ WHA	WATER HAMMER ARRESTER
○ <u>FD-#</u>	FLOOR DRAIN
○ <u>AD-#</u>	AREA DRAIN (STORM WATER)
O RD-#	ROOF DRAIN
——————————————————————————————————————	PIPE ANCHOR
	PIPE GUIDE
	PIPE TRANSITION
7	EXPANSION COMPENSATOR
	FLEXIBLE CONNECTION
	ELBOW DOWN
<u> </u>	ELBOW UP
	TEE DOWN
	TEE UP
	FLOW ARROW
	FLOOR CLEANOUT FLUSH WITH FINISH FLOOR
<u>YCO</u>	YARD CLEANOUT FLUSH IN GRASS OR PAVED AREA
<u>CO</u>	CLEANOUT IN HORIZONTAL RUN
<u>VCO</u>	CLEANOUT IN VERTICAL DROP EXPOSED
<u> WCO</u>	CLEANOUT IN VERTICAL DROP WITH EXTENSION THROUGH WALL
	PIPE CAP
	CONTINUATION BREAK
AD	ACCESS DOOR IN WALL OR CEILING
•	CONNECT TO EXISTING
•	LIMIT OF DEMOLITION
0'-0"	DISTANCE FROM FLOOR TO BOTTOM OF OBJECT
⊳™	CONCRETE THRUST BLOCK
.01 —>	SLOPING PIPE (.01 = 1%) & DIRECTION OF SLOPE
-	

EXISTING PIPING SYMBOLS						
— — EXISTING PIPING TO BE REMOVED						
xxx	EXISTING PIPING TO REMAIN - SERVICE IS SAME DESIGNATION AS NEW					
	EXISTING PIPING NOTED AS CAPPED AND PORTION REMOVED					

	GENERAL SYMBOLS					
X P-X	SECTION MARKER					
X P-X	PARTIAL PLAN / DETAIL MARKER					
(xx xx)	RISER TYPE: S:SANITARY/W:WASTE/V:VENT/CW:COLD WATER/HW:HOT WATER RISER NUMBER					

	PLUMBING LINE TYPES
	POTABLE DOMESTIC COLD WATER
NP	NON-POTABLE DOMESTIC COLD WATER
	DOMESTIC HOT WATER (120° F)
	DOMESTIC HOT WATER RECIRCULATION (120° F)
140°	DOMESTIC HOT WATER (140° F)
——————————————————————————————————————	DOMESTIC HOT WATER RECIRCULATION (140° F)
	SANITARY SEWER (GRAVITY)
VSAN	SANITARY SEWER (VACUUM)
w	WASTE
AW	ACID WASTE
——————————————————————————————————————	SLURRY SUPPLY/RETURN FOR PULPER
	VENT
AV	ACID VENT
SD	STORM DRAIN
OSD	OVERFLOW (SECONDARY) STORM DRAIN
SSD	SIPHONIC STORM DRAIN SYSTEM
———ID———	INDIRECT DRAIN
G	NATURAL GAS
———GR———	GREASE (WASTE) LINE
IW	INDIRECT WASTE
———PD———	PUMP DISCHARGE

ROOF DRAIN SCHEDULE

MARK OUTLET SIZE DOME SIZE DOME TYPE COMMENTS

PLUMBING GENERAL NOTES:

REQUIREMENT SHALL APPLY.

- 1. FIELD VERIFY ALL DIMENSIONS AND EXISTING CONDITIONS BEFORE ORDERING EQUIPMENT OR FABRICATING COMPONENTS.
- 2. UNLESS NOTED OTHERWISE, CONSTRUCTION MATERIAL AND EQUIPMENT REMOVED SHALL BECOME THE PROPERTY OF THE CONTRACTOR AND SHALL BE LEGALLY DISPOSED OF OFF THE
- 3. INSTALL ALL EQUIPMENT AND MATERIALS IN STRICT ACCORDANCE WITH RESPECTIVE MANUFACTURER'S WRITTEN INSTRUCTIONS UNLESS THERE IS A CONFLICT BETWEEN THESE INSTRUCTIONS AND THE CURRENT CODE IF A CONFLICT OCCURS, THE MORE STRINGENT
- 4. COORDINATE WORK WITH STRUCTURAL AND ARCHITECTURAL FEATURES AND PROVIDE OFFSETS AND FITTINGS AS REQUIRED.
- 5. COORDINATE WORK WITH ALL OTHER TRADES. CEILING HEIGHTS ON ARCHITECTURAL PLANS ARE
- 6. ALL DIMENSIONS AND PIPE SIZES ARE IN INCHES UNLESS NOTED OTHERWISE.
- 7. RUN PIPING CONCEALED EXCEPT IN MECHANICAL ROOMS OR WHERE NOTED OTHERWISE.
- 8. PROVIDE ACCESS PANELS IN WALLS OR CEILINGS WHERE REQUIRED FOR ALL CONCEALED VALVES AND EQUIPMENT WHERE NO OTHER ACCESS IS PROVIDED. INSTALL RATED ACCESS PANELS IN FIRE RATED CONSTRUCTION TO MAINTAIN RATING.
- 9. RUN CONCEALED PIPING ON ROOM SIDE OF BUILDING INSULATION UNLESS NOTED OTHERWISE.
- 10. ALL EXPOSED PIPING SHALL BE CLEANED AND HAVE THE SURFACE PREPARED TO RECEIVE PAINTED FINISH. PRIME AND PAINT THE EXPOSED PIPING IN COLOR AS SELECTED BY THE
- 11. SLOPE ALL SOIL, WASTE AND STORM WATER LINES PER CODE.
- 12. CONNECT WATER, WASTE, AND VENT PIPING TO FIXTURES IN ACCORDANCE WITH SIZES INDICATED ON FIXTURE SCHEDULE. RUN-OUTS TO FIXTURES WITHOUT SIZES INDICATED ON DRAWINGS, SHALL BE THE SAME SIZE AS THE CONNECTOR SIZE FOR THE CORRESPONDING FIXTURE AS INDICATED ON THE FIXTURE SCHEDULE.
- 13. THE CONTRACTOR SHALL VERIFY LOCATION OF ALL UNDERGROUND UTILITIES AND PIPING BEFORE COMMENCING WORK AND AGREES TO BE FULLY RESPONSIBLE FOR ALL DAMAGES WHICH MIGHT OCCUR BY THE FAILURE TO EXACTLY LOCATE AND PRESERVE ANY UNDERGROUND
- 14. INSTALL ALL WORK IN ACCORDANCE WITH ALL APPLICABLE CODES AND REGULATIONS.
- 15. PATCH ALL OPENINGS IN BUILDING CONSTRUCTION WHERE PIPING, ETC. IS INSTALLED. MATERIAL AND FINISH TO MATCH EXISTING SURROUNDING CONSTRUCTION.
- 16. THE CONTRACTOR SHALL PROVIDE PIPE SLEEVES IN ALL FOUNDATION WALLS FOR PIPING
- 17. THE CONTRACTOR SHALL VERIFY AND CONFIRM ALL PLUMBING FIXTURE LOCATIONS AND TYPES WITH ARCHITECTURAL PLANS, DETAILS AND ELEVATIONS. ANY DISCREPANCIES BETWEEN THE PLUMBING DRAWINGS AND THE ARCHITECTURAL DRAWINGS SHALL BE BROUGHT TO THE ATTENTION OF THE ARCHITECT FOR RESOLUTION, PRIOR TO INSTALLATION.
- 18. THE CONTRACTOR SHALL CUT ANY OPENING IN FLOORS, WALLS, ROOFS AND CEILINGS REQUIRED FOR INSTALLATION OF PLUMBING EQUIPMENT, PIPING, ETC.. THE CONTRACTOR SHALL ALSO PATCH AND REPAIR ANY EXISTING FLOORS, WALLS, AND CEILING OPENINGS LEFT BY THE REMOVAL OR INSTALLATION OF PLUMBING EQUIPMENT, PIPING, ETC.. PATCHING SHALL MATCH THE EXISTING ADJACENT SUBSTRATE. THE CONTRACTOR SHALL BE RESPONSIBLE FOR ALL FINISHES WHERE PATCHING MENTIONED ABOVE IS PROVIDED.



R	Ε	V		S	I	0	Ν	S
---	---	---	--	---	---	---	---	---

01	MM-DD-YR	NAME	DESCRIPTION OF CHANGES

4

RD

THE ISABE

RENOVATIONS

ASSO ST WINDING H

CRABTREE ROHRBAUGH250 WEST MAIN STREET, SUITE 200
CHARLOTTESVILLE VA 22902
434-975-7262 FAX 434-975-7263


SYMBOLS, ABBREVIATIONS, NOTES AND DETAILS - PLUMBING


PLOT SCALE: 12" = 1'-0"

FILENAME: 18016 Holmes Bridge NC Revit-18 PLUMB.rvt

NOVEMBER 2, 2018



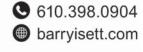


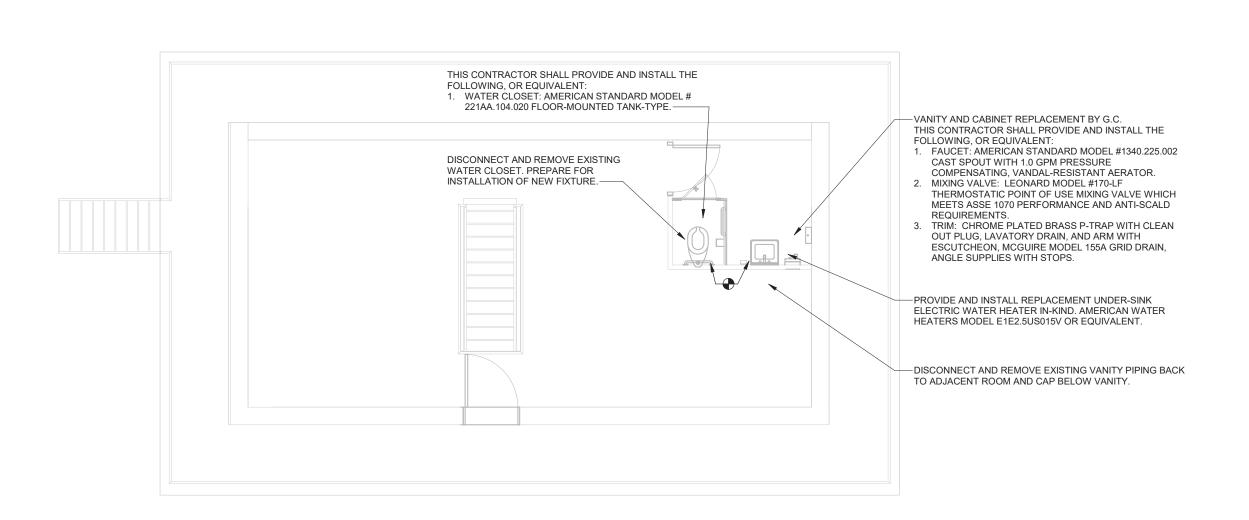

OVERALL CONTROL HOUSE LEVEL PLAN PLUMBING
1/4" = 1'-0"





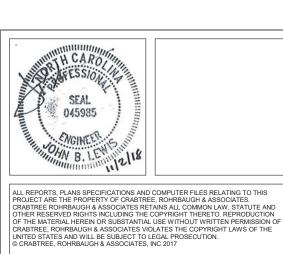

01	MM-DD-YR	NAME	DESCRIPTION OF CHANGES
"	WIWI-DD-TTC	TV-MVIL	DEGGIN HON OF GRANDES
_			

ARCHITE

BRIDGI THE ISABE

CIATES HILL ROAD H & ASSO 401 EAST WINDING H MECHANICSBURG P 717-458-0272 FAX 7 **CRABTREE ROHRBAUGH**250 WEST MAIN STREET, SUITE 200
CHARLOTTESVILLE VA 22902
A34-975-7262 FAX 434-975-7263 RENOVATIONS

OVERALL CONTROL HOUSE LEVEL AND ROOF PLANS -PLUMBING

PLOT SCALE: 1/4" = 1'-0" FILENAME: 18016 Holmes Bridge NC Revit-18 PLUMB.rvt

NOVEMBER 2, 2018

3133

DISTRIBUTION						
NEW 208Y/120 PANELBOARD						
\[\textit{Z///\textit{Z}}\]	NEW 480Y/277 PANELBOARD					
←	HOMERUN TO PANELBOARD					
	EQUIPMENT ON SAME CIRCUIT BUT SEPARATELY CONTROLLED					
	CONDUIT CONCEALED IN WALL OR CEILING					
	CONDUIT RUN UNDERFLOOR OR UNDERGROUND					

EQUIPMENT					
J	JUNCTION BOX				
<u> </u>	JUNCTION BOX- WALL MOUNT				
	DISCONNECT SWITCH - MOUNTED 5' ABOVE FINISHED FLOOR OR ON EQUIPMENT				
\boxtimes_1	COMBINATION STARTER/DISCONNECT - 5' ABOVE FINISHED FLOOR OR ABOVE CEILING				
<i>\(\)</i>	MOTOR				
S _T	MANUAL MOTOR STARTER				
TV	TV OUTLET - MOUNT 18" AFF UNLESS NOTED OTHERWISE.				
IDF	MAIN DISTRIBUTION FRAME				
Ф	WALL MOUNTED CLOCK - MOUNTING HT. TO CENTER OF DEVICE AS SPECIFIED ON 'E3' SERIES DRAWINGS				
<u>\$</u>	WALL MOUNTED PAGING HORN				
S	CEILING MOUNTED PAGING SPEAKER				
® _L	CEILING MOUNTED LOCAL SPEAKER				
SO	SPEAKER/CLOCK COMBO				

FIRE ALARM						
F	FIRE ALARM PULL STATION - 42" ABOVE FINISHED FLOOR					
F◀ (XX)	COMBINATION FIRE ALARM HORN W/ VISUAL UNIT (STROBE) - 80", BOTTOM OF LENS, AFF ALL DEVICES MUST HAVE ADJUSTABLE CANDELA RATINGS					
COMBINATION FIRE ALARM HORN W/ VISUAL UNIT (STROBE) - CEILING MOUNTED ALL DEVICES MUST HAVE ADJUSTABLE CANDELA RATINGS						
VISUAL ONLY UNIT - 80", BOTTOM OF LENS, AFF ALL DEVICES MUST HAVE ADJUSTABLE CANDELA RATINGS						
cFX (XX)	VISUAL ONLY UNIT - CEILING MOUNTED ALL DEVICES MUST HAVE ADJUSTABLE CANDELA RATINGS					
D	MAGNETIC DOOR HOLD OPEN (24VAC) (FURNISHED BY OTHERS)					
(S)	SMOKE DETECTOR					
(D)	DUCT TYPE SMOKE DETECTOR - FURNISH AND INSTALLED BY MC, WIRED BY E.C					
H	HEAT DETECTOR					
©	CARBON MONOXIDE DETECTOR					

(XX) RECOMMENDED VISUAL UNIT CANDELA RATING

	RECEPTACLES						
φ	DUPLEX RECEPTACLE - WALL MOUNTED						
 	QUADRUPLEX RECEPTACLE - WALL MOUNTED						
ф	DUPLEX RECEPTACLE - CEILING MOUNTED						
	SPECIAL - SINGLE PHASE - WALL MOUNTED (SIZE AS INDICATED)						
•	SPECIAL - THREE PHASE - WALL MOUNTED (SIZE AS INDICATED)						
∇	DATA OUTLET						
√4	DATA OUTLET (NUMBER DENOTES QUANTITY OF DEVICES)						
\mathbf{V}^4	COMBINATION TELE/DATA OUTLET (NUMBER DENOTES QUANTITY OF DATA DEVICES)						
▼WH	TELEPHONE OUTLET, WALL HUNG						
∇_{M}	DATA OUTLET. WALL MOUNTED; FOR OWNER PROVIDED WIRELESS SYSTEM						
∇^{C}_{C}	DATA OUTLET. CEILING MOUNTED; FOR OWNER PROVIDED WIRELESS SYSTEM						
4 4	FLOOR BOX WITH DATA OUTLETS AND ELECTRICAL RECEPTACLES (NUMBER DENOTES QUANTITY OF DEVICES)						
MI	MULTI-MEDIA INTERFACE: VGA W/ 3.5MM (AUDIO/VIDEO), HDMI, USB EXTENDER OUTLET						
PL	PLUG LOAD CONTROLLER, WATTSTOPPER #LMPL-201. DEVICE SHALL BE MOUNTED ABOVE CEILING. PROVIDE A 4"x4" JUNCTION BOX FOR DEVICE MOUNTING.						

<u>NOTES:</u> 1. DEVICES TO BE MOUNTED 18" ABOVE FINISHED FLOOR, UNLESS NOTED OTHERWISE. 2. A/C = ABOVE COUNTERTOP APPROXIMATELY 42" ABOVE FINISHED FLOOR. 3. GFI = GROUND FAULT INTERRUPTER 4. WP = GROUND FAULT INTERRUPTER WITH WEATHERPROOF WHILE-IN-USE COVER

	LIGHTING CONTROL
S	SINGLE POLE LIGHT SWITCH - FLUSH MOUNTED
s ₃	THREE-WAY LIGHT SWITCH - FLUSH MOUNTED
s ₄	FOUR-WAY LIGHT SWITCH - FLUSH MOUNTED
W	OCCUPANCY SENSOR - WALLSTATION, WATTSTOPPER #LMDW-100-W
S 1	LOW-VOLTAGE 1-BUTTON WALLSTATION, WATTSTOPPER #LMSW-101-W (PROVIDE W/ ENGRAVING)
S 3	LOW-VOLTAGE 3-BUTTON WALLSTATION, WATTSTOPPER #LMSW-103-W (PROVIDE W/ ENGRAVING)
S 4	LOW-VOLTAGE 4-BUTTON WALLSTATION, WATTSTOPPER #LMSW-104-W (PROVIDE W/ ENGRAVING)
SD	LOW-VOLTAGE DIMMING WALLSTATION, WATTSTOPPER #LMDM-101-W (PROVIDE W/ ENGRAVING)
SP	DIGITAL PARTITION SWITCH, WATTSTOPPER #LMPS-104-W (PROVIDE WITH ENGRAVING)
OS	LOW-VOLTAGE VACANCY/OCCUPANCY SENSOR - DUAL TECHNOLOGY, CEILING MOUNTED, WATTSTOPPER #LMDC-100 (REFER TO SEQUENCE OF OPERATIONS FOR VAC/OCC MODE)
PS	PHOTOSENSOR - SINGLE ZONE SWITCHING AND DIMMING, CLOSED LOOP WATTSTOPPER #LMLS-400
RC	ROOM CONTROLLER, 1-LOAD, 2-LOAD, OR 3-LOAD AS REQUIRED PER ROOM, DEVICE SHALL BE MOUNTED ABOVE CEILING. WATTSTOPPER #LMRC-210 FOR ALL LED LUMINAIRES, WATTSTOPPER #LMRC-220 FOR LED RETROFIT LUMINAIRES.
EL	EMERGENCY LIGHTING CONTROL UNIT, DEVICE SHALL BE MOUNTED ABOVE CEILING. WATTSTOPPER #ELCU200
NB	NETWORK BRIDGE CONTROLLER (NOT SHOWN ON PLANS), PROVIDE (1) ONE PER ROOM, DEVICE SHALL BE MOUNTED ABOVE CEILING. WATTSTOPPER #LMBC-300
PI	PARTITION INTERFACE, WATTSTOPPER #LMIO-102. DEVICE SHALL BE MOUNTED ABOVE CEILING.
(IR)	ISOLATED RELAY INTERFACE, WATTSTOPPER #LMRL-100. DEVICE SHALL BE MOUNTED ABOVE CEILING. TIES INTO ROOM VAV BOXES. NOT SHOWN ON DRAWINGS.
	LOW-VOLTAGE WIRING PER MANUFACTURER'S RECOMMENDATIONS

GENERAL LIGHTING CONTROL NOTES:

- CONTRACTOR TO FIELD VERIFY NUMBER OF RELAYS REQUIRED PER CIRCUIT AND PROVIDE APPROPRIATE DEVICE.
- 2. PROVIDE A 4"x4" JUNCTION BOX FOR DEVICE MOUNTING.
- PROVIDE A 4"x4" JUNCTION BOX IF DEVICE IS BEING MOUNTED WITHOUT THE ROOM CONTROLLER. I. DEVICE MOUNTING BRACKET SHALL BE ZIP TIED TO STRUCTURE.
- . MOUNT SWITCHES AND WALLSTATIONS 48" AFF. 6. REFER TO LIGHTING CONTROL SEQUENCE OF OPERATIONS ON 'E5' SERIES DRAWINGS FOR WALLSTATION ENGRAVING SCHEDULE.

GENERAL NOTES:

- 1. VERIFY ALL CONDITIONS AND MEASUREMENTS ON SITE PRIOR TO THE INSTALLATION OF ANY EQUIPMENT. 2. INSTALL WORK IN ACCORDANCE WITH THE NATIONAL ELECTRICAL CODE AND EQUIPMENT MANUFACTURER'S RECOMMENDED INSTRUCTIONS.
- CONTACT THE UTILITY COMPANIES PRIOR TO BEGINNING WORK
- INSTALL FIRE ALARM SYSTEMS IN ACCORDANCE WITH NFPA 72.
 THE INTENT OF THE FIRE ALARM AUDIBLE DEVICES IS TO PROVIDE A SOUND LEVEL OF +15db OVER AMBIENT IN ALL OCCUPIED AREAS OF THE BUILDING. PROVIDE DEVICES IN A QUANTITY AND CAPACITY TO MEET THIS
- REQUIREMENT. 6. INSTALL CONDUIT AND BOXES ABOVE SUSPENDED CEILING OR CONCEALED IN WALLS.
- 7. WHERE NOTED ON THE DRAWINGS, INSTALL WIRE AND DEVICES IN SURFACE MOUNTED RACEWAY. EXTEND CONDUIT TO RACEWAY ENTRANCE. 8. THE DRAWINGS DO NOT INDICATE PULL/SPLICE BOXES. INSTALL BOXES TO MEET JOB CONDITIONS AND NEC
- REQUIREMENTS.

 9. FASTEN HORIZONTAL CONDUIT TO THE BUILDING PERMANENT STRUCTURE AT A SPACING NOT MORE THAN 7'-6". FASTEN EXPOSED CONDUIT ON MASONRY AT A SPACING NOT MORE THAN 5'-0". USE BEAM CLAMPS
- AND STUD ANCHORS, DO NOT USE FRICTION CLAMPS. 10. INSTALL EXPANSION FITTINGS WITH BONDING JUMPERS WHERE CONDUITS PASS THROUGH EXPANSION OR
- CONTROL JOINTS. 11. INSTALL AN INDEPENDENT GROUND WIRE FOR ALL FEEDERS AND SUBFEEDERS SHOWN ON THE ONE-LINE DIAGRAM. INSTALL AN INDEPENDENT GROUND IN ALL CONDUITS, WHETHER INDICATED OR NOT ON THE DRAWINGS. SIZE WIRE PER NEC REQUIREMENTS.
- 12. GROUND ALL ELECTRICAL EQUIPMENT PER THE NATIONAL ELECTRICAL CODE. DO NOT EXCEED 10 OHMS. 13. COORDINATE THE INSTALLATION OF LIGHTING FIXTURES, RECEPTACLES, DISCONNECT SWITCHES, AND SWITCHES WITH THE INSTALLATION OF OTHER EQUIPMENT.
- 14. THE LOCATION OF SWITCHES, BOXES, AND CONDUITS PROVIDING POWER TO EQUIPMENT SHOWN ON THE DRAWINGS IS APPROXIMATE. COORDINATE FINAL LOCATION OF ELECTRICAL DEVICES WITH THE INSTALLATION OF OTHER EQUIPMENT. DO NOT MOUNT ELECTRICAL DEVICES TO INTERFERE WITH
- 15. WHEREVER THE INSTALLATION OF ELECTRICAL EQUIPMENT SHOWN ON THE DRAWINGS IS IMPRACTICAL DUE TO LOCAL INTERFERENCE OR OTHER REASONS, CONTACT THE ENGINEER AND INSTALL THE
- EQUIPMENT AT NEW LOCATIONS AS DIRECTED. 16. SIZE CONDUITS IN ACCORDANCE WITH NATIONAL ELECTRICAL CODE BUT NOT LESS THAN 3/4". WHERE
- FIXTURES ARE SUPPORTED FROM CONDUIT, THE MINIMUM SIZE SHALL BE 1". 17. MOUNT PANELBOARDS WITH TOP OF ENCLOSURE AT 6'-0" ABOVE FINISHED FLOOR.
- 18. PROVIDE ALL PANELBOARDS WITH SOLID NEUTRAL AND EQUIPMENT GROUND BUS. 19. COORDINATE CABLE LENGTH AND VOLTAGE DROP LIMITATIONS FOR ALL SYSTEMS AND MAKE ANY ADJUSTMENTS NECESSARY, INCLUDING, BUT NOT LIMITED TO, WIRE AND CONDUIT SIZE INCREASE AND/OR ADDING EQUIPMENT TO MAKE A COMPLETE AND OPERABLE SYSTEM AND TO MEET REFERENCED CODE AND STANDARDS REQUIREMENTS. THIS SHALL BE DONE AT NO ADDITIONAL COST
- 20. THE OWNER WILL RETAIN SALVAGE RIGHTS TO ALL LIGHT FIXTURES PRIOR TO DISPOSAL BY THE CONTRACTOR. 21. ALL EXISTING OR NEW EXPOSED CONDUIT SHALL BE PAINTED THE SAME COLOR OF THE CEILING OR WALL.
- COORDINATE WITH THE ARCHITECTURAL PLANS FOR PROPER PAINT COLORS NEEDED.

 22. MEASURE STEADY STATE LOAD CURRENTS AT EACH PANELBOARD FEEDER; RE-ARRANGE CIRCUITS IN THE PANELBOARD TO BALANCE THE PHASE LOADS TO WITHIN 5 PERCENT OF EACH OTHER. MAINTAIN PROPER
- PHASING FOR MULTI-WIRE BRANCH CIRCUITS. 23. CUT OPENINGS IN FLOORS, WALLS, ROOFS, AND CEILINGS REQUIRED FOR INSTALLATION OF ELECTRICAL EQUIPMENT, WIRING, CONDUIT, ETC. PATCH AND REPAIR ANY EXISTING FLOORS, WALLS, ROOF, AND CEILING OPENINGS LEFT BY REMOVAL OR INSTALLATION OF ELECTRICAL EQUIPMENT, WIRING, CONDUIT, ETC. PATCHING SHALL MATCH THE EXISTING ADJACENT SUBSTRATE.
- 24. THE FOLLOWING INSTALLATION STANDARDS SHALL BE FOLLOWED ON ALL WALL MOUNTED DEVICES, UNLESS NOTED OTHERWISE: (A) EXISTING MASONRY WALLS: SURFACE MOUNTED RACEWAY. RUN FEED FROM CEILING IN RACEWAY; (B) EXISTING STUD WALLS: FLUSH MOUNTED WALL DEVICES, CUT WALL AND
- FISH AS REQUIRED; (C) NEW WALLS: FLUSH MOUNTED WALL DEVICES. 25. FIRE ALARM CABLING ABOVE RECESSED CEILINGS AND IN INACCESSIBLE LOCATIONS MAY BE ROUTED EXPOSED. ALL OTHER AREAS SHALL HAVE CABLE IN CONDUIT.

ABBREVIATIONS:

ABOVE FINISHED FLOOR ABOVE FINISHED GRADE AFF AFG AIR HANDLING UNIT ALTERNATE AREA PROTECTION PANEL AUTOMATIC TEMPERATURE CONTROL AUTOMATIC TRANSFER SWITCH BELOW FINISHED FLOOR BELOW FINISHED GRADE CONDUIT CONDENSING UNIT CABINET UNIT HEATER DIAMETER DIGITAL METER ELECTRICAL CONTRACTOR EXHAUST FAN ELECTRICAL ELEVATION EXPLOSION PROOF EXISTING BACK BOX TO REMAIN FXISTING TO REMAIN EXISTING DEVICE TO BE RELOCATED FAN COIL UNIT FULL LOAD AMPERES G, GND, GRD GROUND GENERAL CONTRACTOR HEATING CONTRACTOR HIGH INTENSITY DISCHARGE HEATING, VENTILATION & AIR CONDITIONING KCMIL THOUSAND CIRCULAR MILS KILOVOLT AMPERES MECHANICAL CONTRACTOR NATIONAL ELECTRIC CODE NATIONAL ELECTRIC MANUFACTURER'S ASSOCIATION OVERHEAD FIBER PLUMBING CONTRACTOR TRANSIENT VOLTAGE SURGE SUPPRESSOR UNIT HEATER UNDERGROUND FIBER VOLTS WIRE GUARD WEATHERPROOF

THE SYMBOLS AND ABBREVIATIONS SHOWN ARE STANDARDS AND DO NOT NECESSARILY APPEAR ON THE DRAWINGS.

	LIGHTING FIXTURE SCHEDULE									
MARK	MARK MANUFACTURER MODEL NO. DESCRIPTION LAMP WATTAGE VOLTAGE MOUNTING						REMARKS			
E1	LITHONIA	LHQM-LED-R-HO	DUAL HEAD COMBINATION EXIT AND EMERGENCY BATTERY FIXTURE	LED	10 W			PROVIDE WITH UL924 COMPLIANT BATTERY		
E2	LITHONIA	ELA-T-QWP-L0309	WEATHERPROOF DUAL HEAD REMOTE LAMP	LED	2 W			FED FROM FIXTURE E2 BATTERY PACK		
RA	LITHONIA	2GTL-4-40L-EZ1-LP840	2X4 LENSED TROFFER	LED	31 W	UNV 120/277V	RECESSED	CONTROL HOUSE RECESSED		
SA	LITHONIA	FEML48-4000LM-LPAFL-MD-MVOLT-GZ 10-40K-80CRI	4' GASKETED AND LENSED SURFACE FIXTURE	LED	31 W			CONTROL HOUSE SURFACE		


GENERAL LIGHTING FIXTURE NOTES:

- 1. COORDINATE MOUNTING HEIGHTS WITH 'A' SERIES DRAWINGS PRIOR TO INSTALLATION. 2. VERIFY ALL CEILING TYPES SHOWN ON THE 'A' SERIES DRAWINGS AND PROVIDE ALL NECESSARY MOUNTING
- 3. EXIT SIGNS SHALL BE CEILING, WALL, OR END MOUNTED. FIELD COORDINATE FINAL MOUNTING
- 4. EXIT SIGNS SHALL HAVE DIRECTIONAL CHEVRONS AS REQUIRED. FIELD COORDINATE FINAL CHEVRON CONFIGURATION.
- 5. PROVIDE APPROPRIATE CABLE/CORD LENGTH FOR ALL PENDANT MOUNTED FIXTURES. REFER TO 'A' SERIES FLOOR PLANS, SECTIONS, AND INTERIOR ELEVATIONS FOR ADDITIONAL INFORMATION. WHEN MOUNTING HEIGHT OF ANY LIGHT FIXTURES IS NOT CLEARLY STATED OR SHOWN ON DRAWINGS, CONTACT ENGINEER FOR APPROPRIATE LENGTH PRIOR TO INSTALLATION.

PROVIDE FIXTURES AS SCHEDULED OR EQUAL AS APPROVED BY THE PROFESSIONAL.

DRAWING LIST

E0.1 GENERAL NOTES FLOOR PLANS - ELECTRICAL

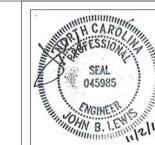

UNITED STATES AND WILL BE SUBJECT TO LEGAL PROSECUTION.
© CRABTREE, ROHRBAUGH & ASSOCIATES, INC 2017

REVISIONS

01	MM-DD-YR	NAME	DESCRIPTION OF CHANGES
			· · · · · · · · · · · · · · · · · · ·

R

 \Box

ABE

<u>S</u>

ENOVATIONS

4

5 H 20

ROHRBAI HILL ROAD


CRABTREE F
401 EAST WINDING HI
MECHANICSBURG PA
717-458-0272 FAX 7

12" = 1'-0"

FILENAME: 18016 Holmes Bridge NC Revit-18


NOVEMBER 2, 2018



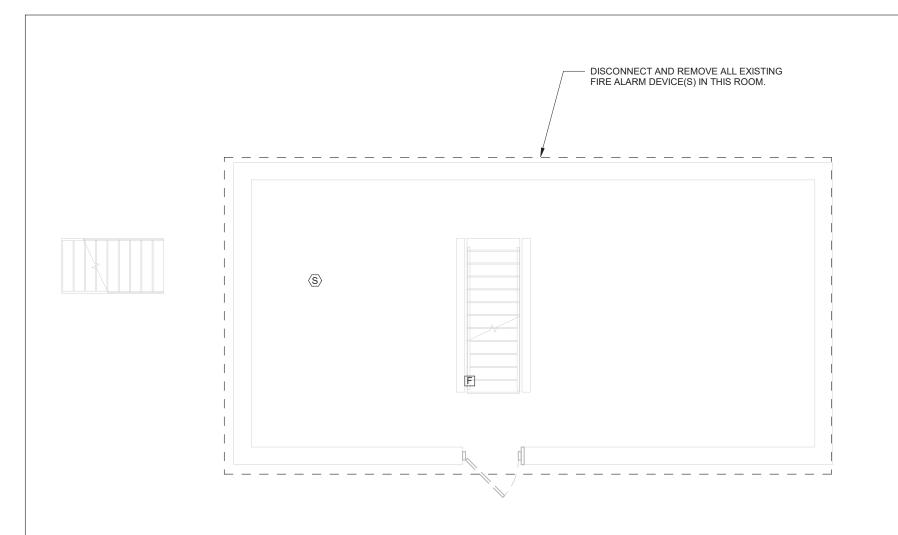


LOWER CONTROL AND GENERATOR ROOM
ELECTRICAL DEMOLITION


1/4" = 1'-0"

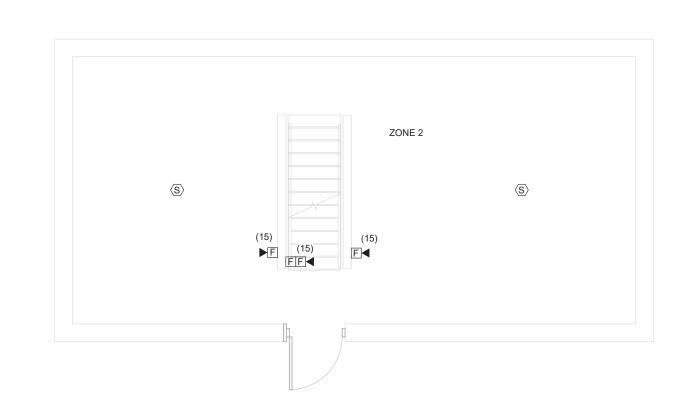

LOWER CONTROL AND GENERATOR ROOM -3 E1.1 SYSTEMS 1/4" = 1'-0"

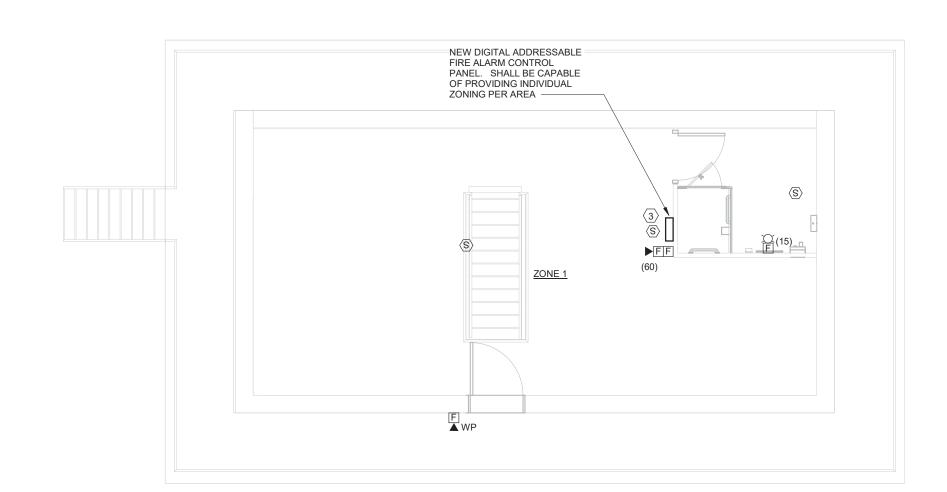


5 CONTROL ROOM FLOOR PLAN - SYSTEMS

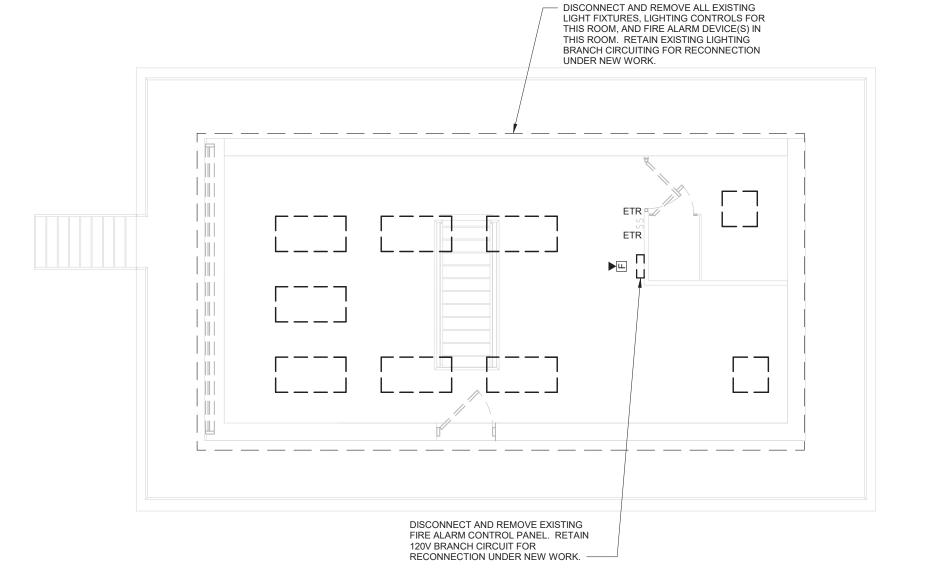

CONTROL ROOM FLOOR PLAN - ELECTRICAL

DEMOLITION

1/4" = 1'-0"

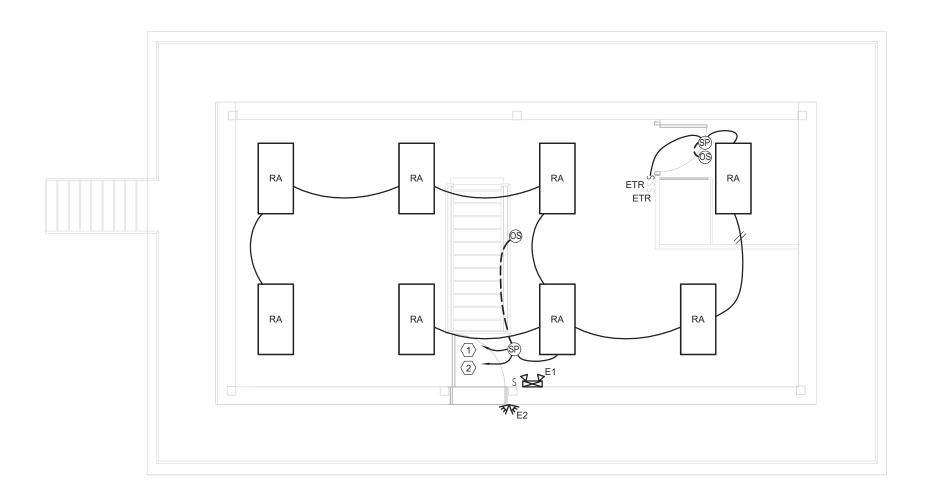

4 CONTROL ROOM FLOOR PLAN - LIGHTING
E1.1 1/4" = 1'-0"

GENERAL PLAN NOTES:


- UNLESS NOTED OTHERWISE, ALL ELECTRICAL DEVICES AND EQUIPMENT ARE EXISTING TO REMAIN.
 CONNECT EMERGENCY LIGHTING TO LOCAL NORMAL LIGHTING CIRCUIT, AHEAD OF SWITCHING, WITH 2 #12 AND 1 #12 GROUND IN 3/4" CONDUIT.
- PROVIDE PLENUM RATED CABLE ABOVE CEILINGS.
 PROVIDE CABLE IN CONDUIT IN ALL EXPOSED AREAS.
- THE EXISTING ELECTRICAL DISTRIBUTION & SERVICE EQUIPMENT IS LOCATED ON
- THE LEVELS BELOW.

 NOT ALL EXISTING DEVICES ARE SHOWN. UNLESS NOTED OTHERWISE, ALL ELECTRICAL DEVICES AND EQUIPMENT ARE EXISTING TO REMAIN.


DRAWING NOTES:

- $\langle \mathsf{1}
 angle$ EXTEND TO EXISTING BRANCH CIRCUIT THAT PREVIOUSLY FED LIGHT FIXTURES IN THIS SPACE UTILIZLING 2 #12 AND 1 #12 GROUND IN 3/4" CONDUIT.
- $\fbox{2}$ EXTEND TO EXISTING SWITCH AT BOTTOM OF STAIRS, ON LEVEL BELOW, UTILIZLING 2 #12 AND 1 #12 GROUND IN 3/4" CONDUIT.
- 3 RECONNECT TO EXISTING 120 VOLT BRANCH CIRCUIT.

Pack

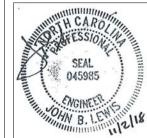

ALL REPORTS, PLANS SPECIFICATIONS AND COMPUTER FILES RELATING TO THIS PROJECT ARE THE PROPERTY OF CRABTREE, ROHRBAUGH & ASSOCIATES. CRABTREE ROHRBAUGH & ASSOCIATES RETAINS ALL COMMON LAW, STATUTE AND OTHER RESERVED RIGHTS INCLUDING THE COPYRIGHT THERETO. REPRODUCTION OF THE MATERIAL HEREIN OR SUBSTANTIAL USE WITHOUT WRITTEN PERMISSION OF CRABTREE, ROHRBAUGH & ASSOCIATES VIOLATES THE COPYRIGHT LAWS OF THE UNITED STATES AND WILL BE SUBJECT TO LEGAL PROSECUTION.

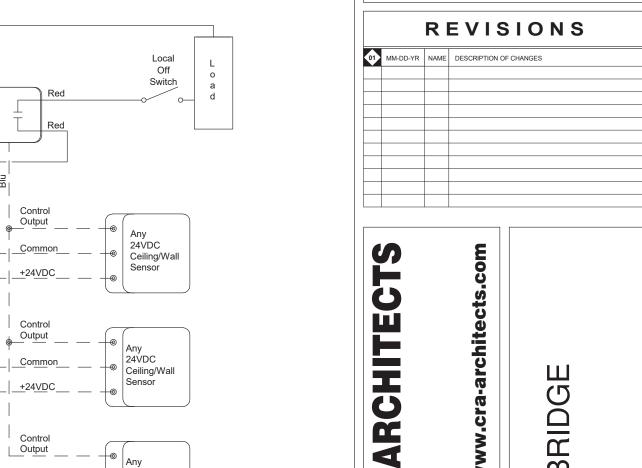


CIATES

REET, SUITE 200

SSO MAIN STR

I

ROHRBAUGI

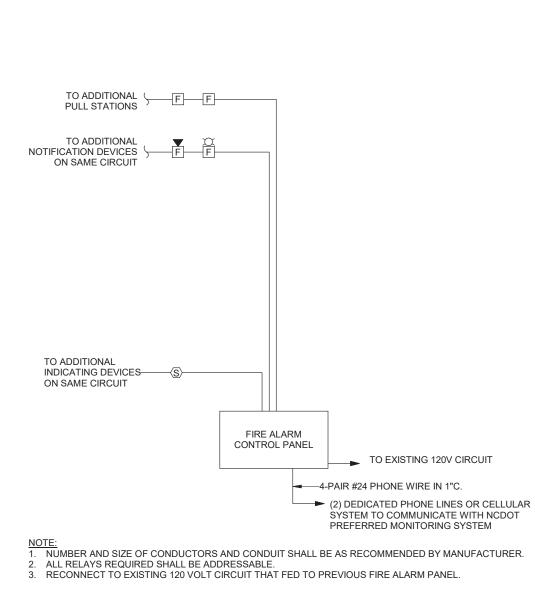

CONTROL DETAIL

TYPICAL MULTIPLE SENSOR LIGHTING

7 FIRE ALARM RISER DIAGRAM NOT TO SCALE





FLOOR PLANS - ELECTRICAL

As indicated

FILENAME: 18016 Holmes Bridge NC Revit-18 ELECT.rvt

NOVEMBER 2, 2018

PROJECT 3133 EI.I

RIDG


 \Box

ISABEI

里


RENOVATIONS




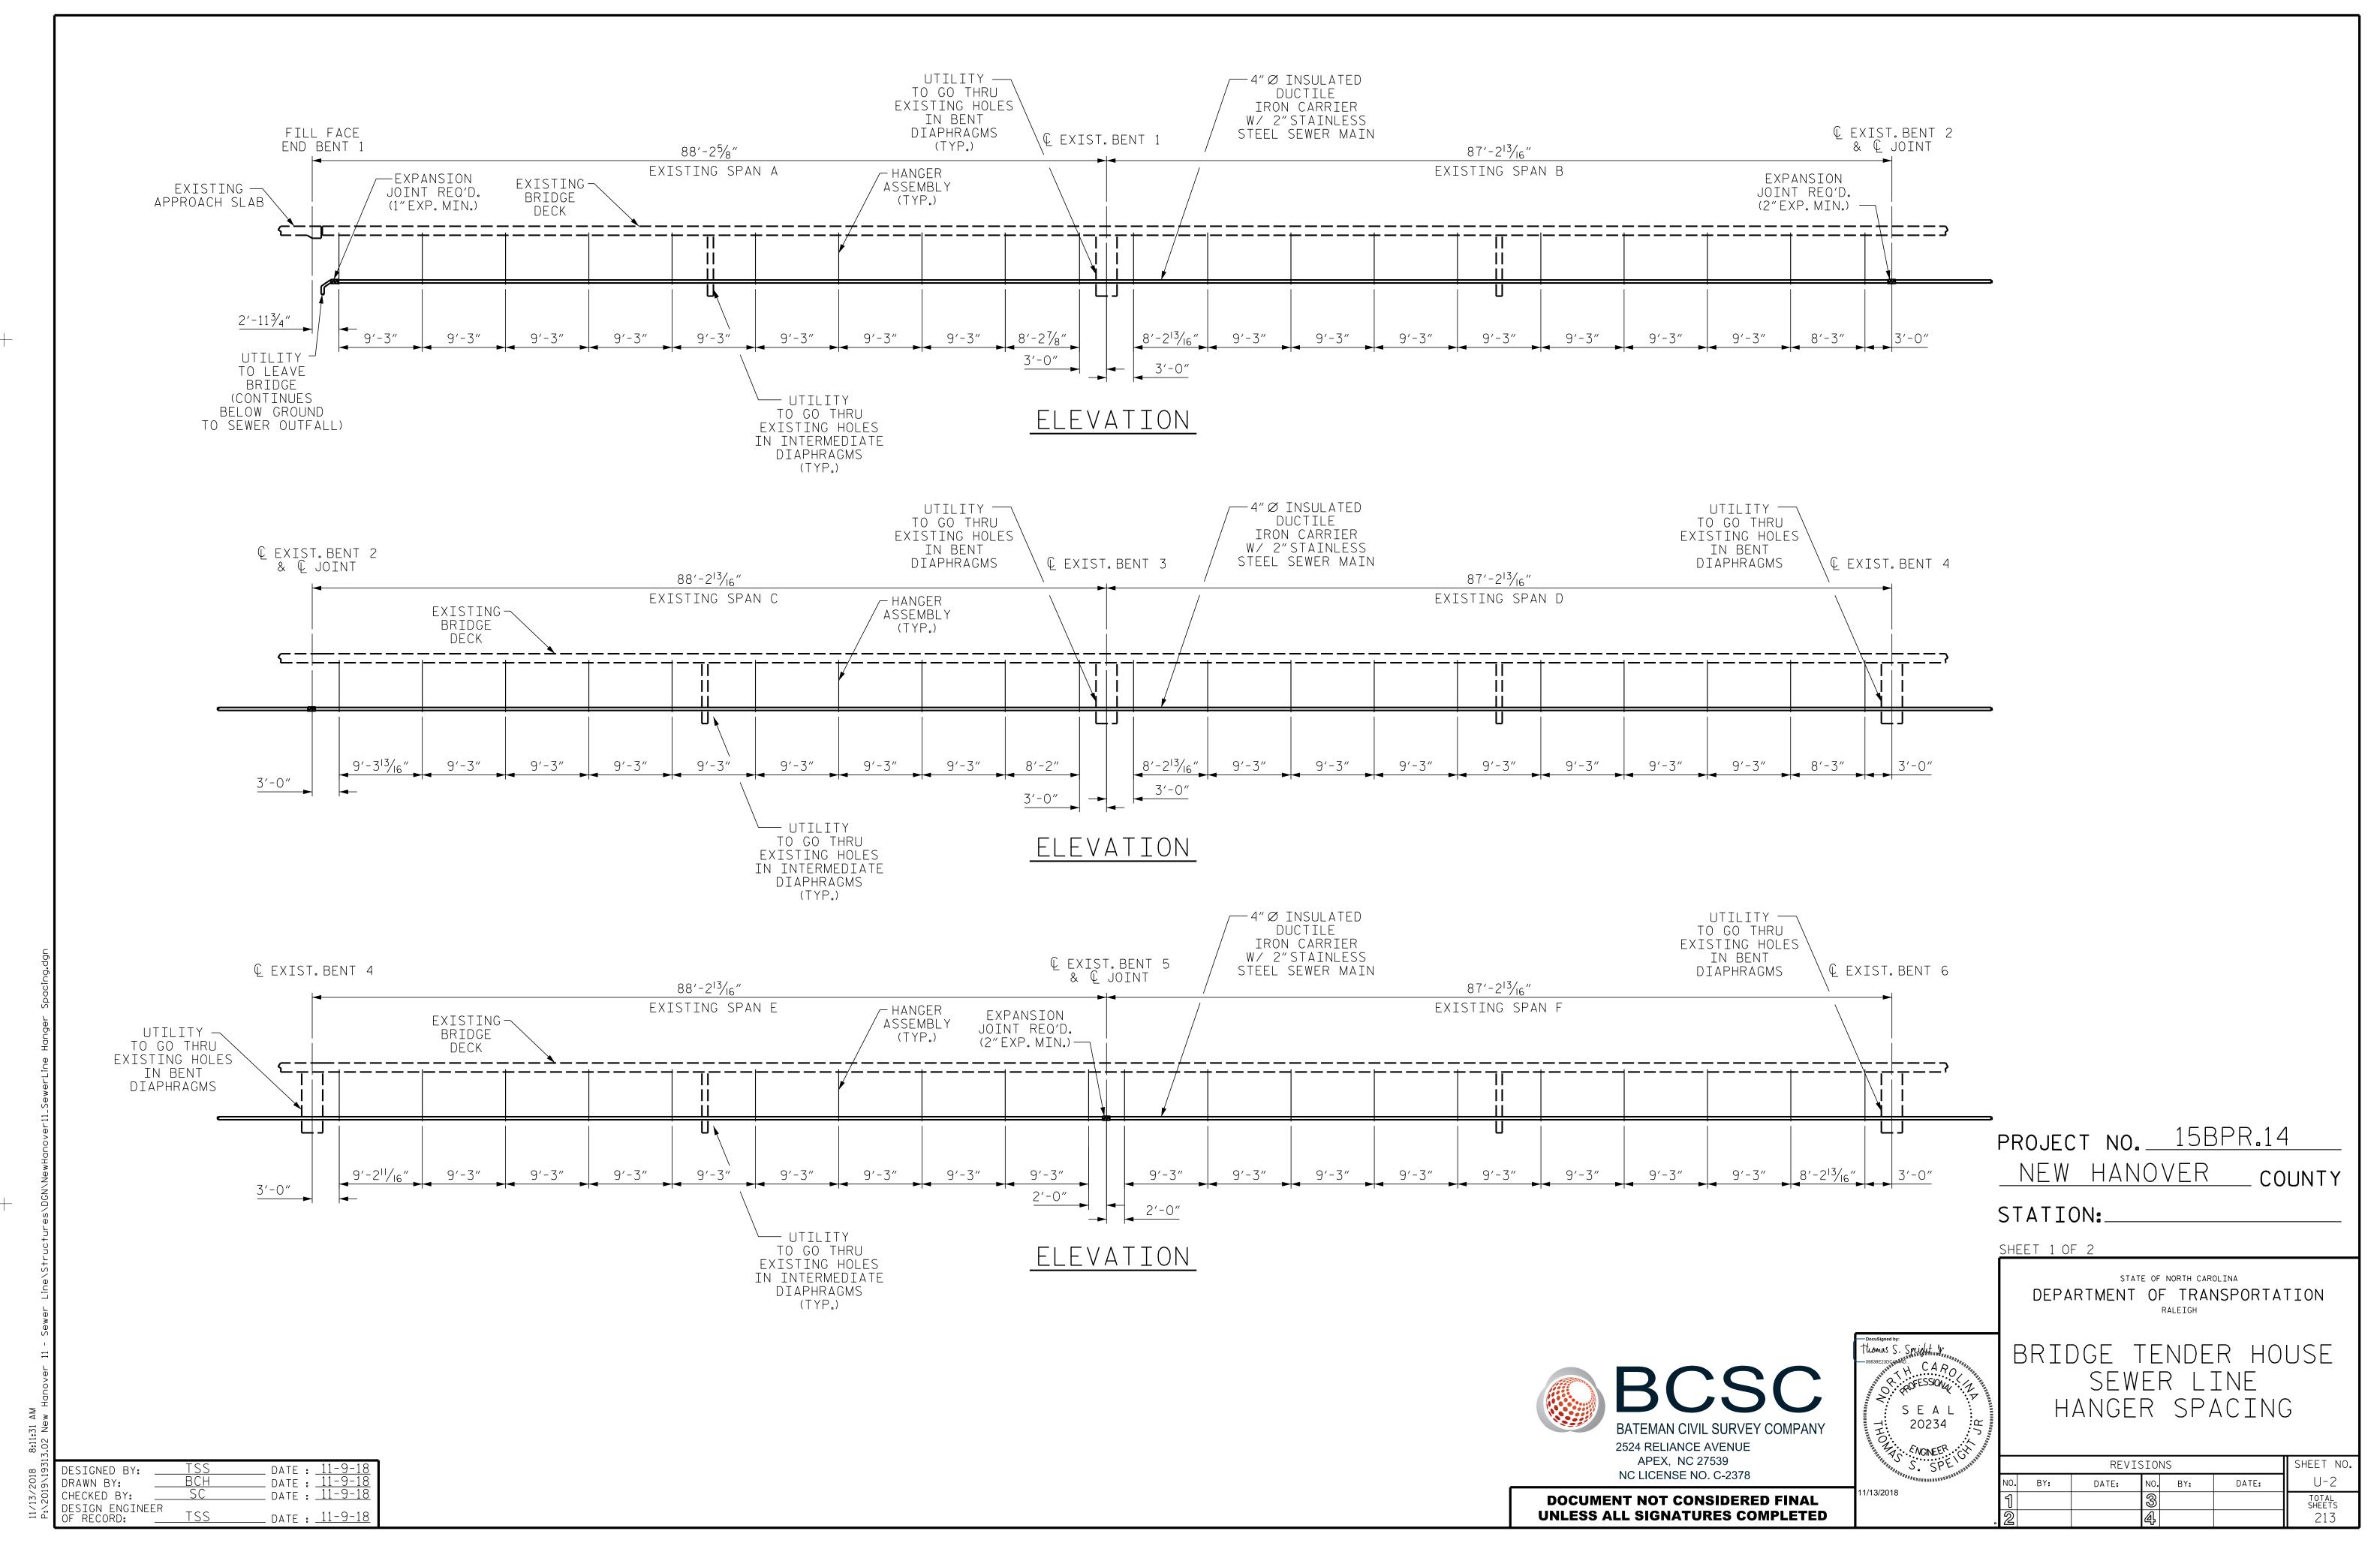


NOTES:

1. PROVIDE EXPANSION JOINTS AT LOCATIONS SHOWN. CONTRACTOR CAN PROVIDE ADDITIONAL EXPANSION JOINTS AS DEEMED NECESSARY. INDICATED EXPANSION JOINTS SHALL BE STAINLESS STEEL AND PROVIDE FOR THE AMOUNT OF MOVEMENT SHOWN (MIN.).

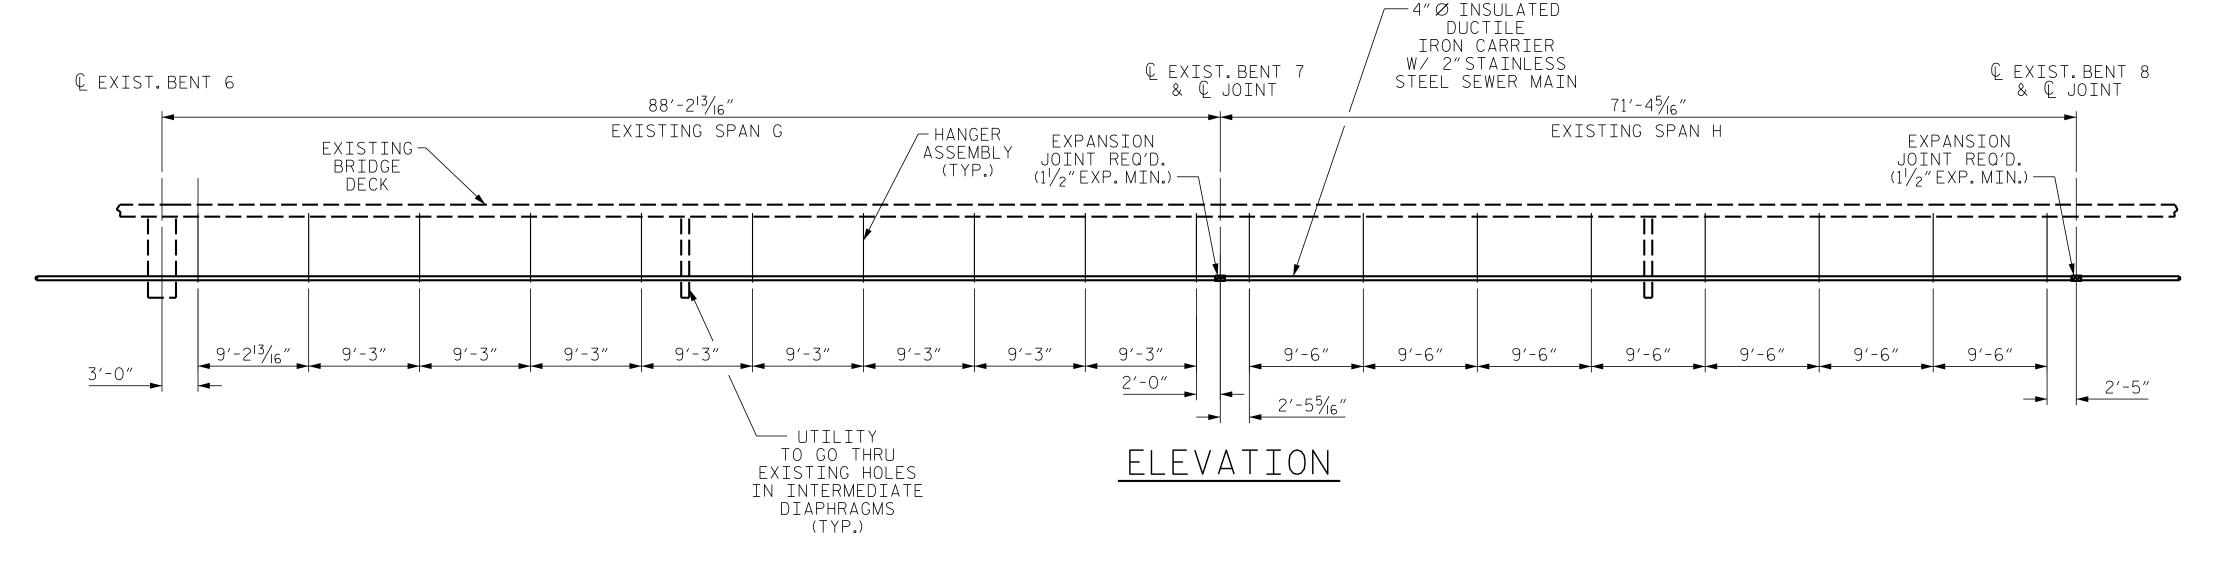

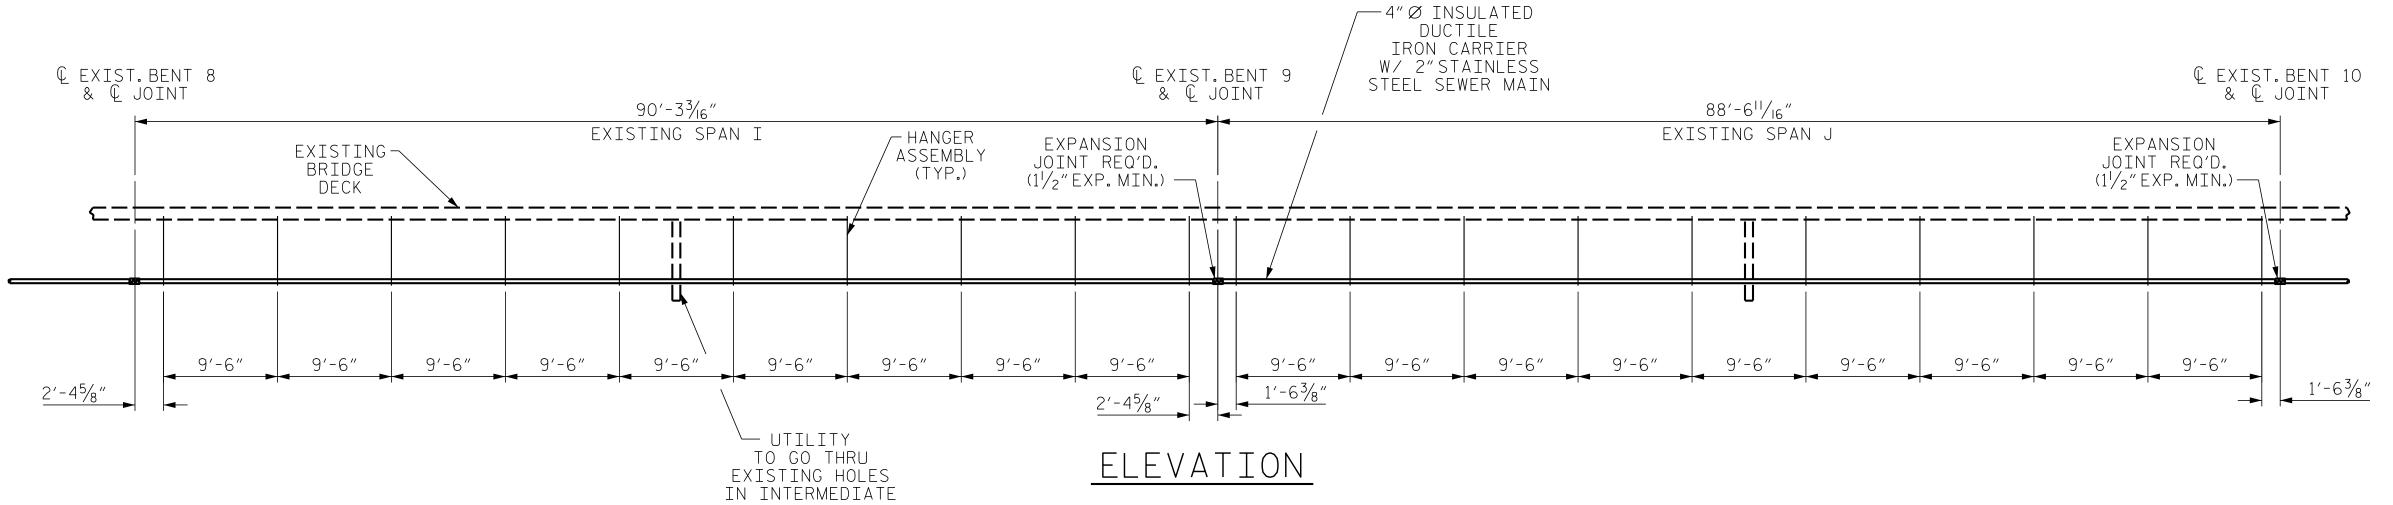

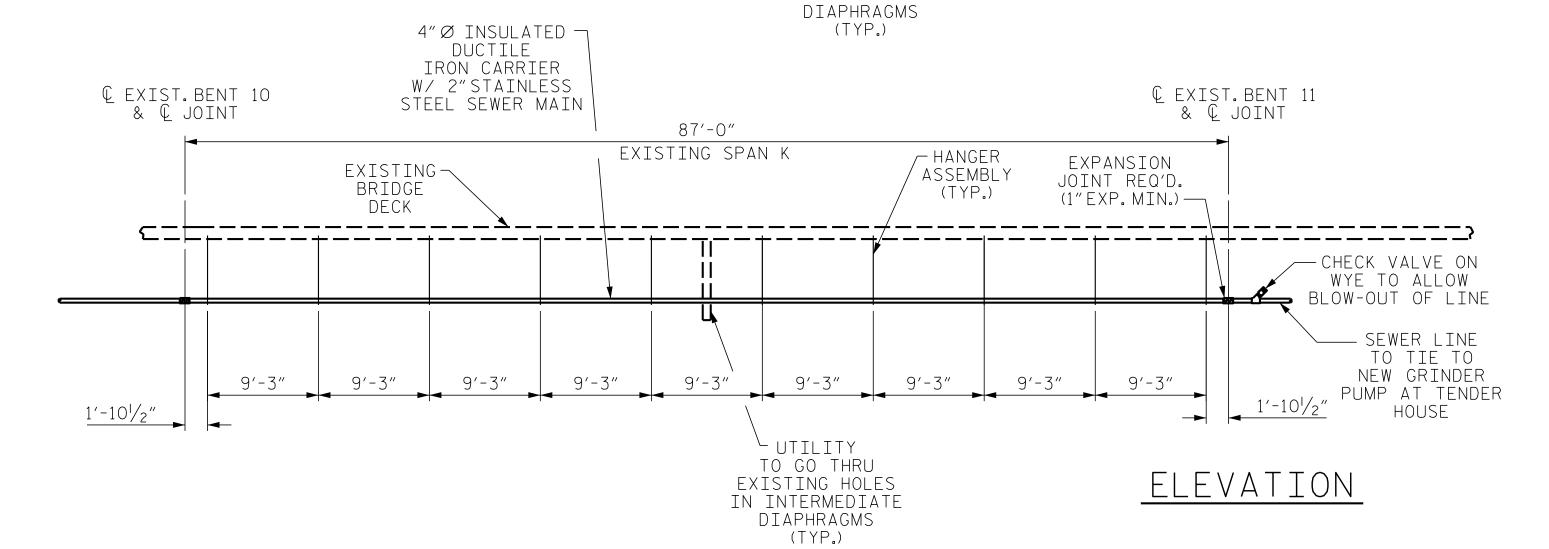

PROJECT NO. 15BPR.14

NEW HANOVER COUNTY

STATION:_

SHEET 2 OF 2

9838E23Reversion CARO

S E A L 20234

O. ENGINEER.

STATE OF NORTH CAROLINA

DEPARTMENT OF TRANSPORTATION

RALEIGH

BRIDGE TENDER HOUSE SEWER LINE HANGER SPACING

REVISIONS
SHEET NO.

BY: DATE: NO. BY: DATE:
U-3
TOTAL
SHEETS
213

BCSC

BATEMAN CIVIL SURVEY COMPANY

2524 RELIANCE AVENUE

APEX, NC 27539


NC LICENSE NO. C-2378

DOCUMENT NOT CONSIDERED FINAL UNLESS ALL SIGNATURES COMPLETED

nover11_SewerLine Hanger Sp

EXISTING TYPICAL SECTION

LOOKING TOWARDS TENDER HOUSE SPANS A THRU F SHOWN OTHER SPANS SIMILAR

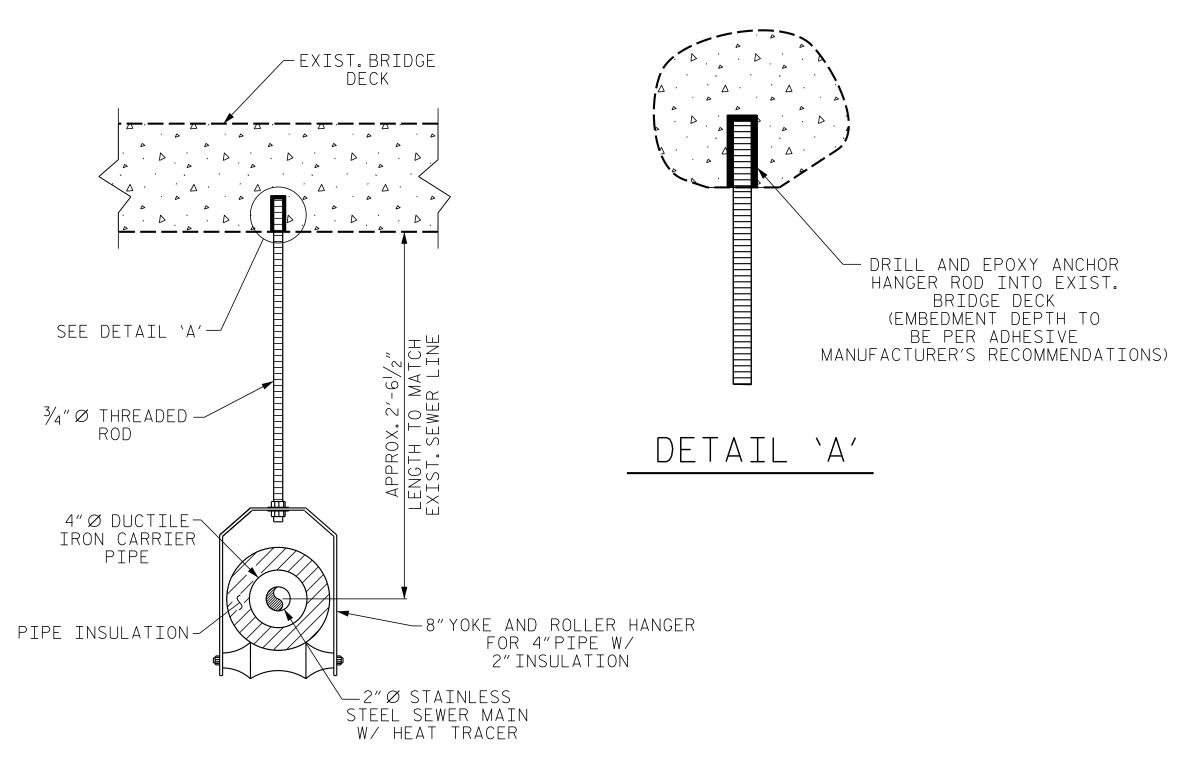


TYPICAL HANGER ASSEMBLY DETAIL

ALL HANGER MATERIAL SHALL BE STAINLESS STEEL

NOTES:

- 1. THE PROPOSED UTILITY CONSTRUCTION SHALL MEET THE APPLICABLE REQUIREMENTS OF THE NC DEPARTMENT OF TRANSPORTATION'S "STANDARD SPECIFICATIONS FOR ROADS AND STRUCTURES" DATED JANUARY 2018.
- 2. SEWER LINES TO BE INSTALLED WITHIN COMPLIANCE OF THE RULES AND REGULATIONS OF THE NORTH CAROLINA DEPARTMENT OF ENVIRONMENT QUALITY, DIVISION OF WATER RESOURCES, WATER QUALITY SECTION. PERFORM ALL WORK IN ACCORDANCE WITH THE APPLICABLE PLUMBING CODES.
- 3. CONTRACTOR SHALL PROVIDE FINAL DETAILED PIPING SCHEMATICS FOR SHOP DRAWING APPROVAL PRIOR TO INSTALLATION.
- 4. ALL UTILITY MATERIALS SHALL BE APPROVED PRIOR TO DELIVERY TO THE PROJECT. SEE 1500-7, "SUBMITTALS AND RECORDS" IN SECTION 1500 OF THE STANDARD SPECIFICATIONS.
- 5. JOINTS IN DUCTILE IRON CARRIER PIPE SHALL BE MEGALUG, SERIES 1100 BY EBAA IRON OR APPROVED EQUAL.
- 6. MAXIMUM PIPE BEND SHALL BE 45° UNLESS APPROVED BY THE ENGINEER.
- 7. BURIED SECTION OF SEWER LINE SHALL BE 2" DIAMETER SCHEDULE 40 PVC PIPE AND FITTINGS MEETING THE REQUIREMENTS OF ASTM D2665.
- 8. A HEAT TRACING HEATING CABLE SHALL BE PROVIDED ALONG THE BRIDGE ATTACHED PORTION OF THE SEWER LINE.
 HEAT CABLE SHALL BE INDUSTRIAL SERIES (IN) BY DELTA-THERM OR APPROVED EQUAL. HEAT TRACING CABLE ACCESSORIES,
 INCLUDING CONTROL BOX, SHALL BE BY SAME MANUFACTURER AS TRACING CABLE UNLESS OTHERWISE APPROVED.
- 9. CONTRACTOR SHALL REMOVE AND DISPOSE OF EXISTING SEWER PIPING.
- 10. ALL WORK SHOWN ON SHEETS U-1 THROUGH U-4 SHALL BE PAID FOR UNDER THE LUMP SUM PRICE BID FOR 'BRIDGE TENDER HOUSE SEWER LINE REPLACEMENT', SEE PROJECT SPECIAL PROVISION.
- 11. HEAT CONDUIT MAY BE OMITTED IF ENOUGH ELECTRICAL INSULATION PROVIDED TO COMPLY WITH NATIONAL ELECTRICAL CODE. AND AS APPROVED BY THE ENGINEER.
- 12. ANY OTHER IMPROVEMENTS SHALL BE MADE AS APPROVED BY ENGINEER.

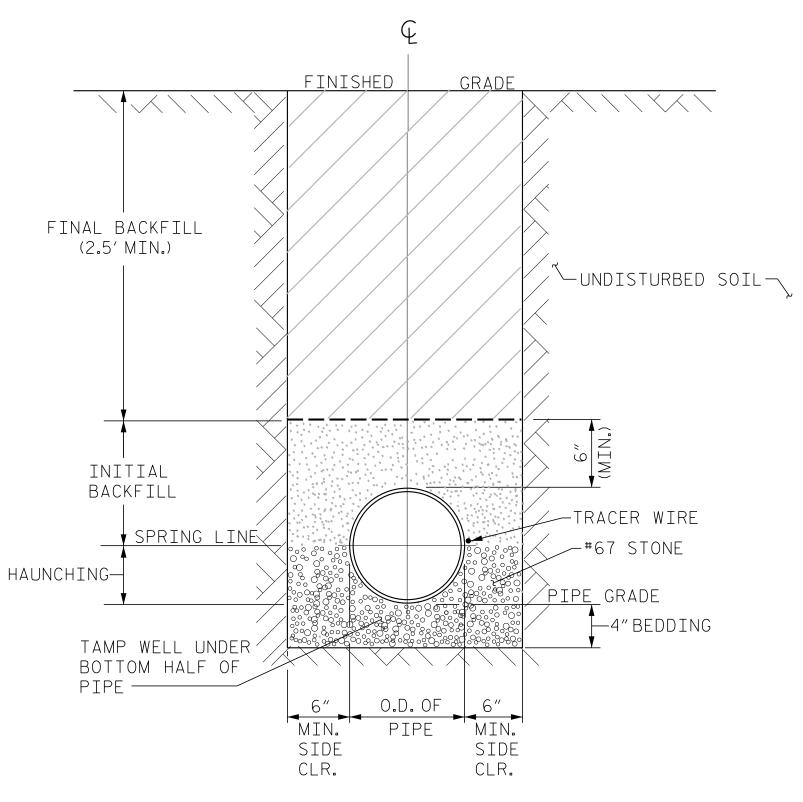

SEWER LINE TRENCH DETAIL

NOTES:

- 1. FOR TRENCHES REQUIRING SHORING AND BRACING, DIMENSIONS SHALL BE TAKEN FROM THE INSIDE FACE OF THE SHORING AND BRACING.
- 2. NO ROCKS OR BOULDERS 4"OR LARGER TO BE USED IN INITIAL BACKFILL. 3. ALL BACKFILL MATERIAL SHALL BE SUITABLE NATIVE MATERIAL.
- 4. BACKFILL SHALL BE TAMPED IN 6"LIFTS IN TRAFFIC AREAS, 12" IN NON-TRAFFIC
- 5. CONTRACTOR WILL FURNISH AND INSTALL METALLIC WIRING TAPE 24-INCHES ABOVE THE PIPE AND COPPER TRACING WIRE.
- 6. PROVIDE SILT FENCE ON DOWN SLOPE SIDE OF TRENCH. (CONTRACTOR SHALL COMPLY WITH ALL NC DEQ EROSION AND SEDIMENT CONTROL RULES AND REGULATIONS.)



DOCUMENT NOT CONSIDERED FINAL UNLESS ALL SIGNATURES COMPLETED PROJECT NO. 15BPR.14 NEW HANOVER COUNTY STATION:

STATE OF NORTH CAROLINA DEPARTMENT OF TRANSPORTATION

BRIDGE TENDER HOUSE SEWER LINE DETAILS

CAROFESSIONA

SEAL 20234

O. ENGINEER. S. SPE

		SHEET NO.				
١٥.	BY:	DATE:	NO.	BY:	DATE:	U-4
1			3			TOTAL SHEETS
2			4			213

_ DATE : <u>11-9-18</u> _ DATE : <u>11-9-18</u> _ DATE : <u>11-9-18</u> DESIGNED BY: DRAWN BY: CHECKED BY: DESIGN ENGINEER DF RECORD: ____ _ DATE : <u>11-9-18</u>

STANDARD NOTES

DESIGN DATA:

---- A.A.S.H.T.O. (CURRENT) ----- SEE PLANS STRESS IN EXTREME FIBER OF STRUCTURAL STEEL - AASHTO M270 GRADE 36 - - 20,000 LBS.PER SQ.IN. - AASHTO M270 GRADE 50W - - 27,000 LBS.PER SQ.IN. - AASHTO M270 GRADE 50 - - 27,000 LBS.PER SQ.IN. REINFORCING STEEL IN TENSION - GRADE 60 - - - 24.000 LBS. PER SQ. IN. CONCRETE IN SHEAR - - - - - - - - - - SEE A.A.S.H.T.O. STRUCTURAL TIMBER - TREATED OR UNTREATED EXTREME FIBER STRESS - - - 1,800 LBS. PER SQ. IN. COMPRESSION PERPENDICULAR TO GRAIN ---- 375 LBS.PER SQ.IN. EQUIVALENT FLUID PRESSURE OF EARTH ---- 30 LBS.PER CU.FT.

MATERIAL AND WORKMANSHIP:

EXCEPT AS MAY OTHERWISE BE SPECIFIED ON PLANS OR IN THE SPECIAL PROVISIONS, ALL MATERIAL AND WORKMANSHIP SHALL BE IN ACCORDANCE WITH THE 2018 "STANDARD SPECIFICATIONS FOR ROADS AND STRUCTURES" OF THE N. C. DEPARTMENT OF TRANSPORTATION.

STEEL SHEET PILING FOR PERMANENT OR TEMPORARY APPLICATIONS SHALL BE HOT ROLLED.

CONCRETE:

UNLESS OTHERWISE REQUIRED ON PLANS, CLASS A CONCRETE SHALL BE USED FOR ALL PORTIONS OF ALL STRUCTURES WITH THE EXCEPTION THAT: CLASS AA CONCRETE SHALL BE USED IN BRIDGE SUPERSTRUCTURES, ABUTMENT BACKWALLS, AND APPROACH SLABS; AND CLASS B CONCRETE SHALL BE USED FOR SLOPE PROTECTION AND RIP RAP.

CONCRETE CHAMFERS:

UNLESS OTHERWISE NOTED ON THE PLANS, ALL EXPOSED CORNERS ON STRUCTURES SHALL BE CHAMFERED 3/4" WITH THE FOLLOWING EXCEPTIONS: TOP CORNERS OF CURBS MAY BE ROUNDED TO 1/2" RADIUS WHICH IS BUILT INTO CURB FORMS; CORNERS OF TRANSVERSE FLOOR EXPANSION JOINTS SHALL BE ROUNDED WITH A 1/4" FINISHING TOOL UNLESS OTHERWISE REQUIRED ON PLANS; AND CORNERS OF EXPANSION JOINTS IN THE ROADWAY FACES AND TOPS OF CURBS AND SIDEWALKS SHALL BE ROUNDED TO A 1/4" RADIUS WITH A FINISHING STONE OR TOOL UNLESS OTHERWISE REQUIRED ON PLANS.

DOWELS:

DOWELS WHEN INDICATED ON PLANS AS FOR CULVERT EXTENSIONS, SHALL BE EMBEDDED AT LEAST 12" INTO THE OLD CONCRETE AND GROUTED INTO PLACE WITH 1:2 CEMENT MORTAR.

ALLOWANCE FOR DEAD LOAD DEFLECTION, SETTLEMENT,

ETC. IN CASTING SUPERSTRUCTURES:

BRIDGES SHALL BE BUILT ON THE GRADE OR VERTICAL CURVE SHOWN ON PLANS. SLABS. CURBS AND PARAPETS SHALL CONFORM TO THE GRADE OR CURVE.

ALL DIMENSIONS WHICH ARE GIVEN IN SECTION AND ARE AFFECTED BY DEAD LOAD DEFLECTIONS ARE DIMENSIONS AT CENTER LINE OF BEARING UNLESS OTHERWISE NOTED ON PLANS. IN SETTING FORMS FOR STEEL BEAM BRIDGES AND PRESTRESSED CONCRETE GIRDER BRIDGES, ADJUSTMENTS SHALL BE MADE DUE TO THE DEAD LOAD DEFLECTIONS FOR THE ELEVATIONS SHOWN. WHERE BLOCKS ARE SHOWN OVER BEAMS FOR BUILDING UP TO THE SLAB, THE VERTICAL DIMENSIONS OF THE BLOCKS SHALL BE ADJUSTED BETWEEN BEARINGS TO COMPENSATE FOR DEAD LOAD DEFLECTIONS, VERTICAL CURVE ORDINATE, AND ACTUAL BEAM CAMBER. WHERE BOTTOM OF SLAB IS IN LINE WITH BOTTOM OF TOP FLANGES, DEPTH OF SLAB BETWEEN BEARINGS SHALL BE ADJUSTED TO COMPENSATE FOR DEAD LOAD DEFLECTION, VERTICAL CURVE ORDINATE, AND ACTUAL BEAM CAMBER.

IN SETTING FALSEWORK AND FORMS FOR REINFORCED CONCRETE SPANS, AN ALLOWANCE SHALL BE MADE FOR DEAD LOAD DEFLECTIONS, SETTLEMENT OF FALSEWORK, AND PERMANENT CAMBER WHICH SHALL BE PROVIDED FOR IN ADDITION TO THE ELEVATIONS SHOWN. AFTER REMOVAL OF THE FALSEWORK, THE FINISHED STRUCTURES SHALL CONFORM TO THE PROFILE AND ELEVATIONS SHOWN ON THE PLANS AND CONSTRUCTION ELEVATIONS FURNISHED BY THE ENGINEER.

DETAILED DRAWINGS FOR FALSEWORK OR FORMS FOR BRIDGE SUPERSTRUCTURE AND ANY STRUCTURE OR PARTS OF A STRUCTURE AS NOTED ON THE PLANS SHALL BE SUBMITTED TO THE ENGINEER FOR APPROVAL BEFORE CONSTRUCTION OF THE FALSEWORK OR FORMS IS STARTED.

REINFORCING STEEL:

ALL REINFORCING STEEL SHALL BE DEFORMED. DIMENSIONS RELATIVE TO PLACEMENT OF REINFORCING ARE TO CENTERS OF BARS UNLESS OTHERWISE INDICATED IN THE PLANS. DIMENSIONS ON BAR DETAILS ARE TO CENTERS OF BARS OR ARE OUT TO OUT AS INDICATED ON PLANS.

WIRE BAR SUPPORTS SHALL BE PROVIDED FOR REINFORCING STEEL WHERE INDICATED ON THE PLANS. WHEN BAR SUPPORT PIECES ARE PLACED IN CONTINUOUS LINES, THEY SHALL BE SO PLACED THAT THE ENDS OF THE SUPPORTING WIRES SHALL BE LAPPED TO LOCK LEGS ON ADJOINING PIECES.

STRUCTURAL STEEL:

AT THE CONTRACTOR'S OPTION, HE MAY SUBSTITUTE $\frac{7}{8}$ " Ø SHEAR STUDS FOR THE $\frac{3}{4}$ " Ø STUDS SPECIFIED ON THE PLANS. THIS SUBSTITUTION SHALL BE MADE AT THE RATE OF 3 - $\frac{7}{8}$ " Ø STUDS FOR 4 - $\frac{3}{4}$ " Ø STUDS, AND STUD SPACING CHANGES SHALL BE MADE AS NECESSARY TO PROVIDE THE SAME EQUIVALENT NUMBER OF $\frac{7}{8}$ " Ø STUDS ALONG THE BEAM AS SHOWN FOR $\frac{3}{4}$ " Ø STUDS BASED ON THE RATIO OF 3 - $\frac{7}{8}$ " Ø STUDS FOR 4 - $\frac{3}{4}$ " Ø STUDS. STUDS OF THE LENGTH SPECIFIED ON THE PLANS MUST BE PROVIDED. THE MAXIMUM SPACING SHALL BE 2'-0".

EXCEPT AT THE INTERIOR SUPPORTS OF CONTINUOUS BEAMS WHERE THE COVER PLATE IS IN CONTACT WITH BEARING PLATE, THE CONTRACTOR MAY, AT HIS OPTION, SUBSTITUTE FOR THE COVER PLATES DESIGNATED ON THE PLANS COVER PLATES OF THE EQUIVALENT AREA PROVIDED THESE PLATES ARE AT LEAST 5/16" IN THICKNESS AND DO NOT EXCEED A WIDTH EQUAL TO THE FLANGE WIDTH LESS 2" OR A THICKNESS EQUAL TO 2 TIMES THE FLANGE THICKNESS. THE SIZE OF FILLET WELDS SHALL CONFORM TO THE REQUIREMENTS OF THE CURRENT ANSI/AASHTO/AWS "BRIDGE WELDING CODE". ELECTROSLAG WELDING WILL NOT BE PERMITTED.

WITH THE SOLE EXCEPTION OF EDGES AT SURFACES WHICH BEAR ON OTHER SURFACES, ALL SHARP EDGES AND ENDS OF SHAPES AND PLATES SHALL BE SLIGHTLY ROUNDED BY SUITABLE MEANS TO A RADIUS OF APPROXIMATELY 1/16 INCH OR EQUIVALENT FLAT SURFACE AT A SUITABLE ANGLE PRIOR TO PAINTING, GALVANIZING, OR METALLIZING.

HANDRAILS AND POSTS:

METAL STANDARDS AND FACES OF THE CONCRETE END POSTS FOR THE METAL RAIL SHALL BE SET NORMAL TO THE GRADE OF THE CURB, UNLESS OTHERWISE SHOWN ON PLANS. THE METAL RAIL AND TOPS OF CONCRETE POSTS USED WITH THE ALUMINUM RAIL SHALL BE BUILT PARALLEL TO THE GRADE OF THE CURB.

METAL HANDRAILS SHALL BE IN ACCORDANCE WITH THE PLANS. RAILS SHALL BE AS MANUFACTURED FOR BRIDGE RAILING. CASTINGS SHALL BE OF A UNIFORM APPEARANCE. FINS AND OTHER DEFORMATIONS RESULTING FROM CASTING OR OTHERWISE SHALL BE REMOVED IN A MANNER SO THAT A UNIFORM COLORING OF THE COMPLETED CASTING SHALL BE OBTAINED. CASTINGS WITH DISCOLORATIONS OR OF NON-UNIFORM COLORING WILL NOT BE ACCEPTED. CERTIFIED MILL REPORTS ARE REQUIRED FOR METAL RAILS AND POSTS.

SPECIAL NOTES:

GENERALLY, IN CASE OF DISCREPANCY, THIS STANDARD SHEET OF NOTES SHALL GOVERN OVER THE SPECIFICATIONS, BUT THE REMAINDER OF THE PLANS SHALL GOVERN OVER NOTES HEREON, AND SPECIAL PROVISIONS SHALL GOVERN OVER ALL. SEE SPECIFICATIONS ARTICLE 105-4.

ENGLISH