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# 204111

# NORTH CAROLINA DEPARTMENT OF TRANSPORTATION

### CITIES OF BURLINGTON & GRAHAM


COMPUTERIZED TRAFFIC SIGNAL SYSTEM

REPLACEMENT OF EXISTING SIGNAL SYSTEM WITH A NEW COMPUTERIZED TRAFFIC SIGNAL SYSTEM. RELATED WORK INCLUDES:

UPGRADING LOCAL INTERSECTION CONTROLLERS, CABINETS, AND SYSTEM DETECTORS WITH LIMITED SIGNAL WIRING AND SIGNAL HEAD UPGRADES WHEN NECESSARY; UPGRADE AND EXPANSION OF CCTV MONITORING NETWORK; INSTALLING CENTRAL EQUIPMENT AND CENTRAL SOFTWARE; AND INSTALLATION OF AN ETHERNET COMMUNICATIONS NETWORK COMPRISED OF FIBER-OPTIC CABLE AND WIRELESS TECHNOLOGY WITH ALL RELATED EQUIPMENT.

U-6015STATE PROJ. NO. 47160.1.1 STBG-0701 (036) 47160.3.1 CONST

> **DOCUMENT NOT CONSIDERED FINAL** UNLESS ALL SIGNATURES COMPLETED

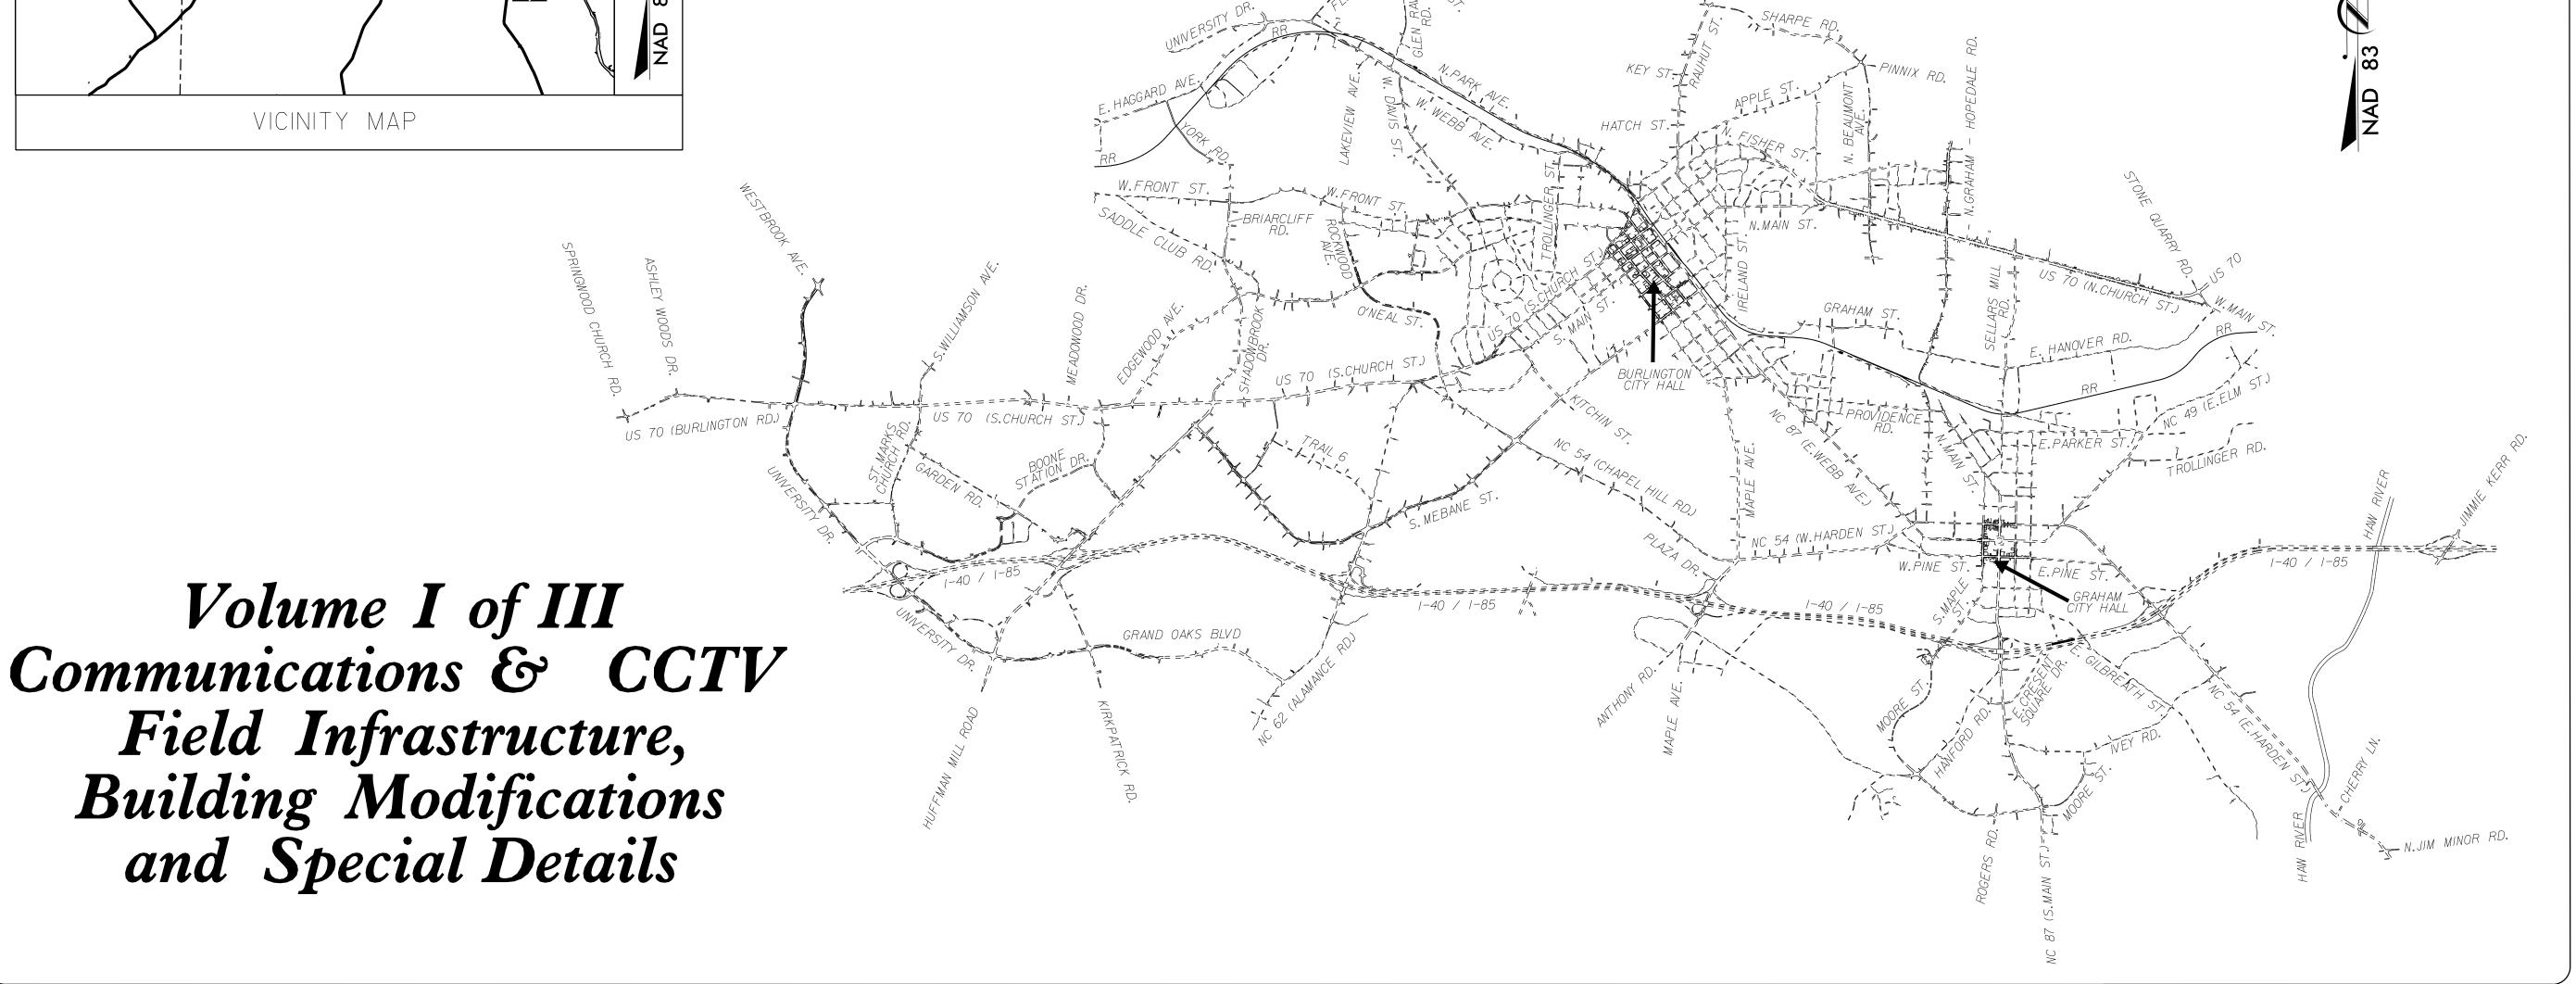

2018 STANDARD SPECIFICATIONS

City of Burlington

VICINITY MAP

LETTING DATE: SEPTEMBER 18, 2018

PROJECT LENGTH = 55 MILES



750 Greenfield Parkway, Garner, NC 27529 **NCDOT CONTACTS**: TRANSPORTATION MOBILITY & SAFETY DIVISION INTELLIGENT TRANSPORTATION SYSTEMS SECTION SHERRY YOW - METRO SYSTEMS PROJECT ENGINEER WILLIAM B. HAIRSTON, III - PROJECT DESIGN ENGINEER CYNTHIA MULDROW - DESIGN ENGINEER

#### **ATKINS**

1616 EAST MILLBROOK ROAD, SUITE 160 RALEIGH, NORTH CAROLINA 27609 (919) 876-6888 NCBEES #F-0326

MELISSA B. TOTH, PE - ATKINS PROJECT MANAGER H. ALFRED BADGETT, PE - ATKINS SENIOR PROJECT ENGINEER BRADFORD SLOCUM, PE - ATKINS PROJECT ENGINEER ANTHONY M. ENCARNACION, PE - ATKINS PROJECT ENGINEER





SEAL

Melissa B. Toth 6/13/2018

#### U-6015

#### INDEX OF SHEETS

#### Volume I

V OUMING A	
ITS-1.00	TITLE SHEET - COMMUNICATIONS & CCTV FIELD INFRASTRUCTURE
	BUILDING MODIFICATIONS AND SPECIAL DETAILS
ITS-2.00	INDEX OF SHEETS AND ROADWAY STANDARD DRAWINGS
ITS-3.00 THRU ITS-3.02	BLOCK DIAGRAMS
ITS-4.00 THRU ITS-4.06	SYSTEM DETECTORS AND CONTROL ZONES
ITS-5.00	CCTV CAMERA INSTALLATION, WOOD POLES
ITS-5.01 THRU ITS-5.03	CCTV CAMERA INSTALLATION, METAL POLES
	ELECTRICAL SERVICE GROUNDING
ITS-5.05	CCTV CABINET ASSEMBLY LAYOUT
ITS-5.06	SIGNAL CABINET DETAIL, POLE-MOUNTED
ITS-5.07	RISER DETAIL
ITS-5.08	FOUNDATION MODIFICATION DETAIL
ITS-5.09	BASE ADAPTER DETAIL
ITS-5.10	GROUND MOUNTED ELECTRICAL SERVICE DETAIL
ITS-5.11	OVERHEAD ELECTRICAL SERVICE DETAIL
ITS-5.12	AERIAL FIBER-OPTIC CABLE STORAGE & SPLICE ENCLOSURES
ITS-5.13	BASE-MOUNTED CABINET FOUNDATION DETAIL
ITS-5.14	TERMINAL SPLICE CABINET DETAIL
ITS-5.15	CCTV AND RADIO BUILDING MOUNTING
ITS-5.16 THRU ITS-5.25	TCC DETAILS
CRP-1.000 THRU CRP-1.017	SUMMARY OF WORK BY CABLE ROUTING PLANS
	CCTV INSTALLATION SUMMARY
CRP-3.000 THRU CRP-3.002	CABLE ROUTING PLANS KEY SHEET
CRP-4.000	LEGEND/ GENERAL NOTES/ ABBREVIATIONS
CRP-5.000	CONSTRUCTION NOTES
CRP-6.001 THRU CRP-6.199	
TMP-7.01 THRU TMP-7.04	TRANSPORTATION MANAGEMENT PLAN

#### Volume II

, 00001100 ==	
FS 1.00	TITLE SHEET (FIBER-OPTIC SPLICING)
FS 1.01	INDEX OF SHEETS AND ROADWAY STANDARD DRAWINGS
FS 2.00	COMMS. CABLE SCHEMATICS SHEET LAYOUT
FS 2.01 THRU FS 2.04	COMMS. CABLE SCHEMATICS
FS 2.05 THRU FS 2.25	FIBER-OPTIC RING SCHEMATICS
FS 3.00	FIBER-OPTIC CABLE USAGE SUMMARY
FS 4.000	FIBER-OPTIC SPLICING DETAILS KEY SHEET
FS 4.001 THRU FS 4.120	FIBER-OPTIC SPLICING DETAILS

#### Volume III – Part 1

SIG. 1.00	TITLE SHEET (TRAFFIC SIGNAL DESIGNS)
SIG. 1.01	INDEX OF SHEETS AND ROADWAY STANDARD DRAWINGS
SIG. 1.02	SIGNAL PLANS INDEX SHEET
SIG. 2.00 THRU SIG. 2.26	SUMMARY OF WORK BY INTERSECTION
SIG. 3.00 THRU SIG. 100.1	TRAFFIC SIGNAL PLANS


#### Volume III – Part 2

SIG. 101.A	TITLE SHEET (TRAFFIC SIGNAL DESIGNS)
SIG. 101.0 THRU SIG. 208.1	TRAFFIC SIGNAL PLANS


#### ROADWAY STANDARD DRAWINGS

THE FOLLOWING ROADWAY STANDARDS AS APPEAR IN "ROADWAY STANDARD DRAWINGS" CONTRACT SERVICES UNIT - N.C. DEPARTMENT OF TRANSPORTATION - RALEIGH, N.C., DATED JANUARY 2018 ARE APPLICABLE TO THIS PROJECT AND BY REFERENCE ARE HEREBY CONSIDERED A PART OF THESE PLANS:

STD. NO.	TITLE
848.01	CONCRETE SIDEWALK
1101.01	WORK ZONE ADVANCE WARNING SIGNS
1101.02	TEMPORARY LANE CLOSURES
1101.03	TEMPORARY ROAD CLOSURES
1101.04	TEMPORARY SHOULDER CLOSURES
1101.11	TRAFFIC CONTROL DESIGN TABLES
1110.02	PORTABLE WORK ZONE SIGNS
1115.01	FLASHING ARROW BOARDS
1130.01	DRUMS
1135.01	CONES
1145.01	BARRICADES
1150.01	FLAGGERS
1165.01	TRUCK MOUNTED ATTENUATOR
1180.01	SKINNY DRUMS
1205.01	PAVEMENT MARKINGS – LINE TYPES AND OFFSETS
1205.02	PAVEMENT MARKINGS – TWO-LANE AND MULTI-LANE ROADWAYS
1205.04	PAVEMENT MARKINGS - INTERSECTIONS
1205.05	PAVEMENT MARKINGS – TURN LANES
1205.07	PAVEMENT MARKINGS – PEDESTRIAN CROSSWALKS
1205.08	PAVEMENT MARKINGS – SYMBOLS AND WORD MESSAGES
1700.01	ELECTRICAL SERVICE OPTIONS
1700.02	ELECTRICAL SERVICE GROUNDING
1705.01	SIGNAL HEADS – SIGNAL HEADS
1705.02	SIGNAL HEADS – MOUNTING
1705.03	SIGNAL HEADS – WIRE COLOR CONVENTIONS
1705.04	SIGNAL HEADS - PEDESTRIAN PUSHBUTTON PLACEMENT
1715.01	UNDERGROUND CONDUIT – TRENCHING
1716.01	JUNCTION BOXES
1720.01	WOOD POLES
1721.01	GUY ASSEMBLIES
1725.01	INDUCTIVE DETECTION LOOPS
	FIBER-OPTIC CABLE - SPARE CABLE STORAGE
	SPREAD SPECTRUM RADIO
	PEDESTALS – PEDESTRIAN PUSHBUTTON (TYPE I)
	PEDESTALS – FOUNDATIONS
	CONTROLLERS AND CABINETS - CABINET COMPONENT LAYOUT
1/51.02	CONTROLLERS AND CABINETS – POWER, GROUND AND AUXILIARY

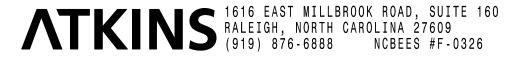

DOCUMENT NOT CONSIDERED FINAL **UNLESS ALL SIGNATURES COMPLETED** 

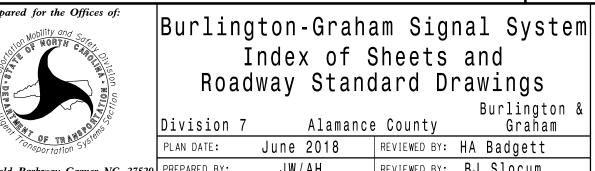


Roadway Standard Drawings Burlington & Alamance County

June 2018 REVIEWED BY: HA Badgett JW/AH REVIEWED BY: BJ Slocum REVISIONS INIT. DATE


#### U-6015 ITS-3.00


#### **BLOCK DIAGRAM** PROPOSED TRAFFIC CONTROL **CENTER EQUIPMENT**

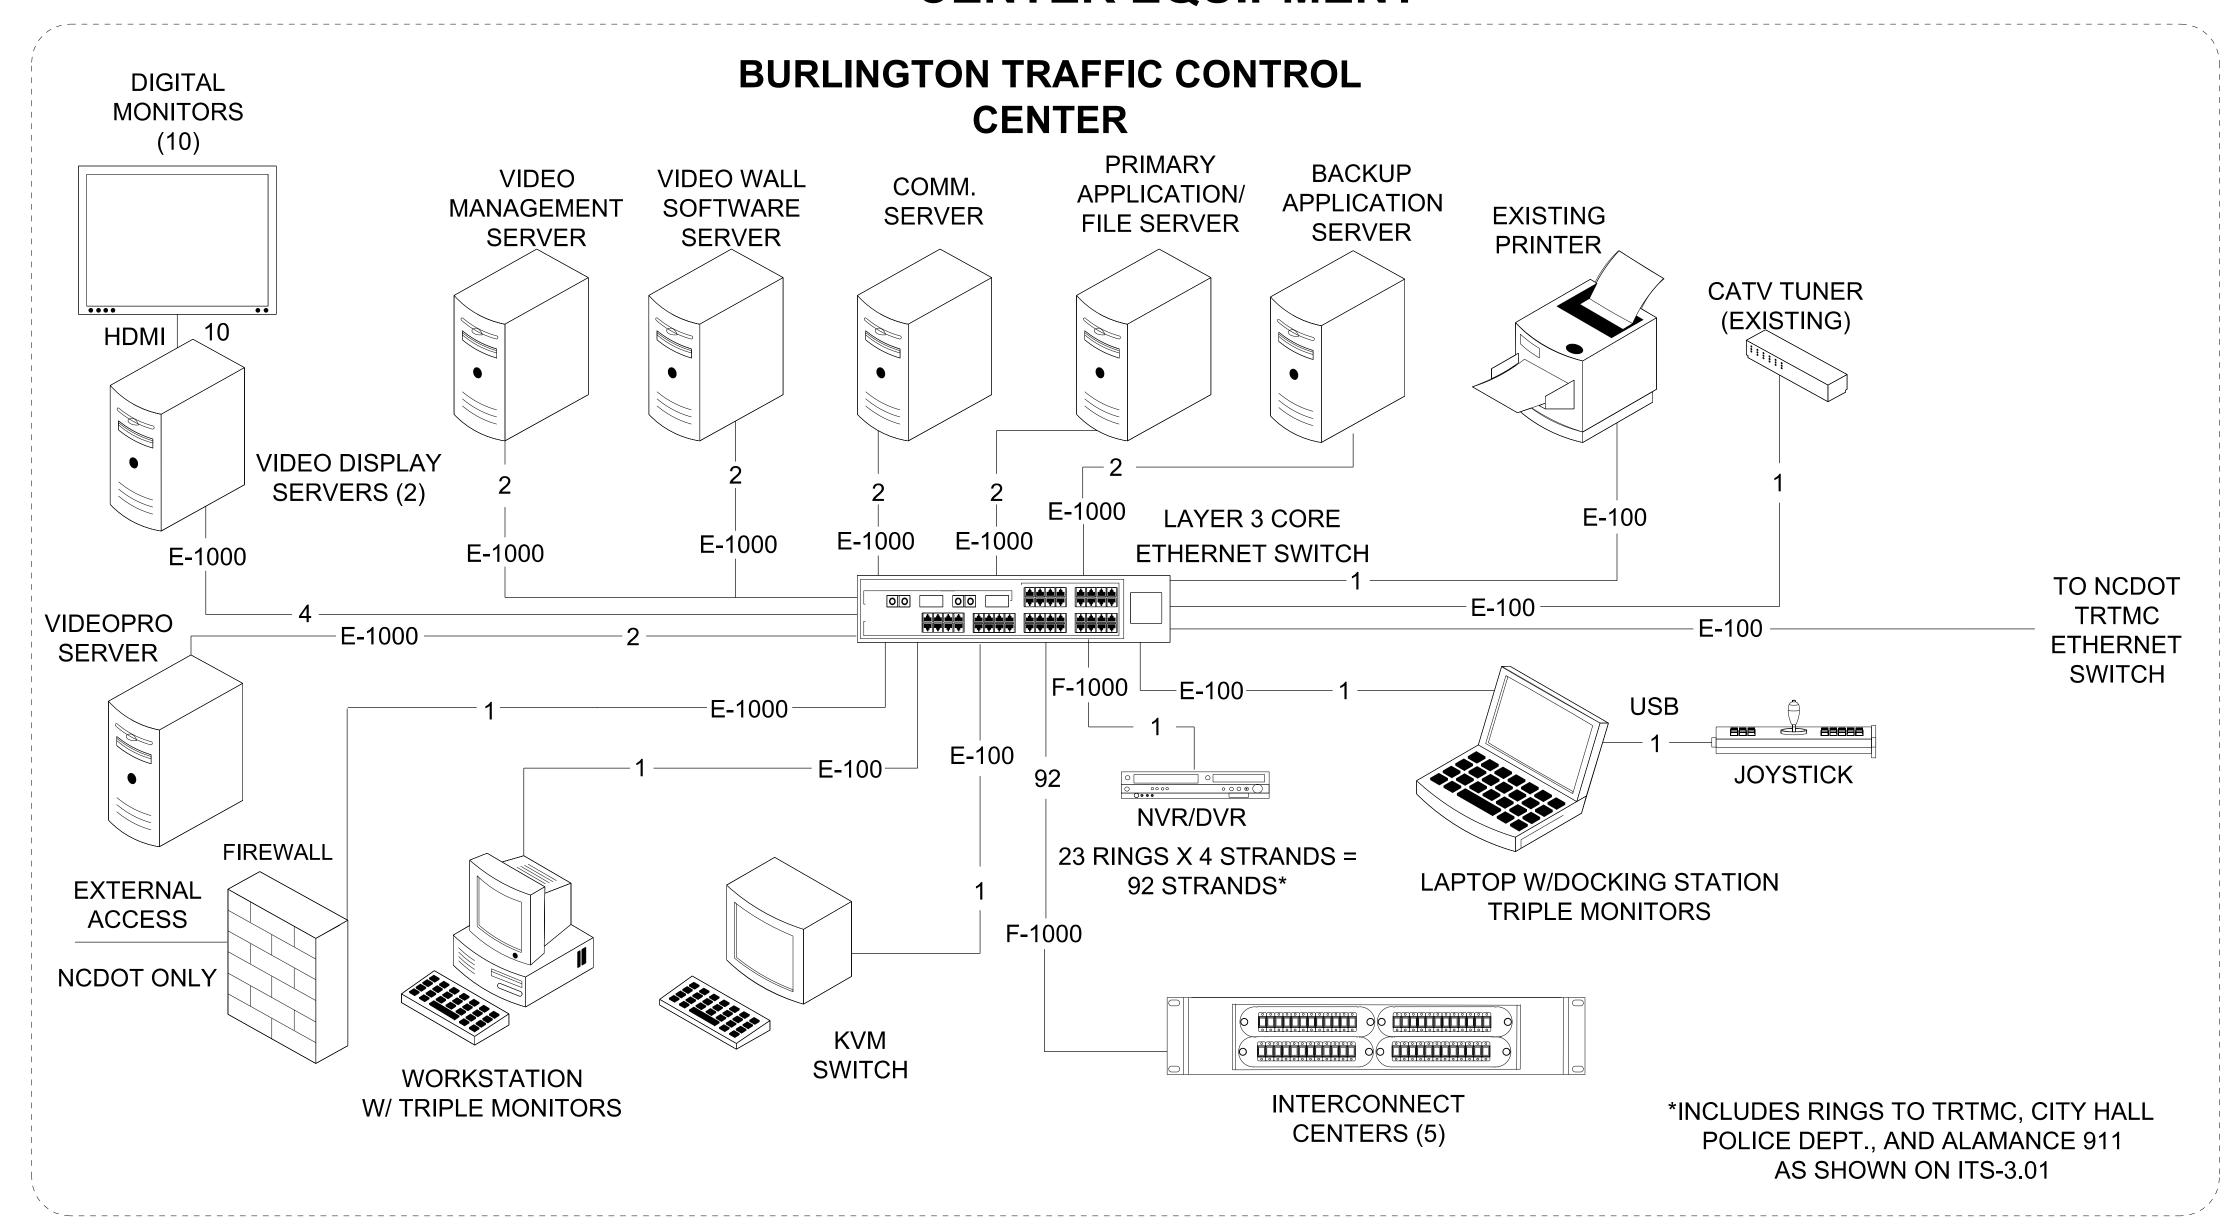

#### **NOTES**


- 1. ALL EQUIPMENT PROPOSED EXCEPT WHERE NOTED.
- 2. PROVIDE INTERNET ACCESS THROUGH EXISTING CITY IT FIREWALL.
- 3. MAINTAIN THE TACTICS SERVERS THROUGHOUT PROJECT.
- 4. REPLACE TWO EXISTING WORKSTATIONS IN TCC WITH ONE LAPTOP AND ONE WORKSTATION.
- 5. FIELD DEVICE CONNECTIONS TO INTERCONNECT CENTERS SHOWN ON ITS-3.01 AND ITS-3.02

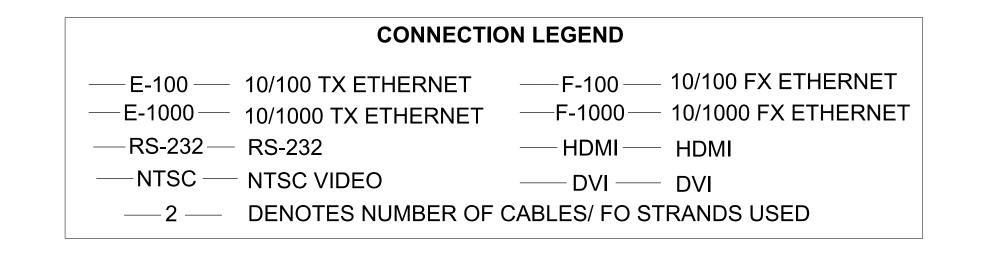

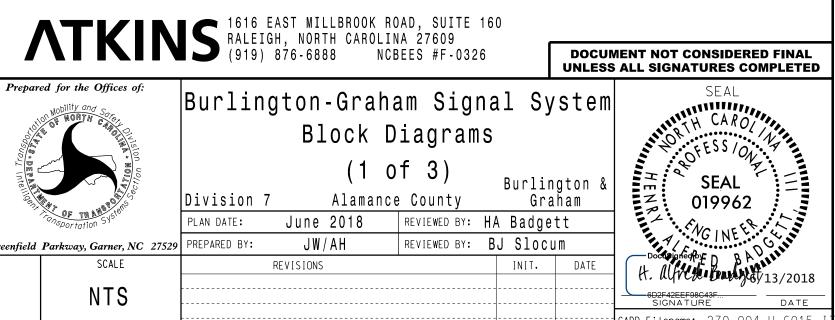

U-6015 ITS-3.01

# BLOCK DIAGRAM PROPOSED FIELD CCTV EQUIPMENT

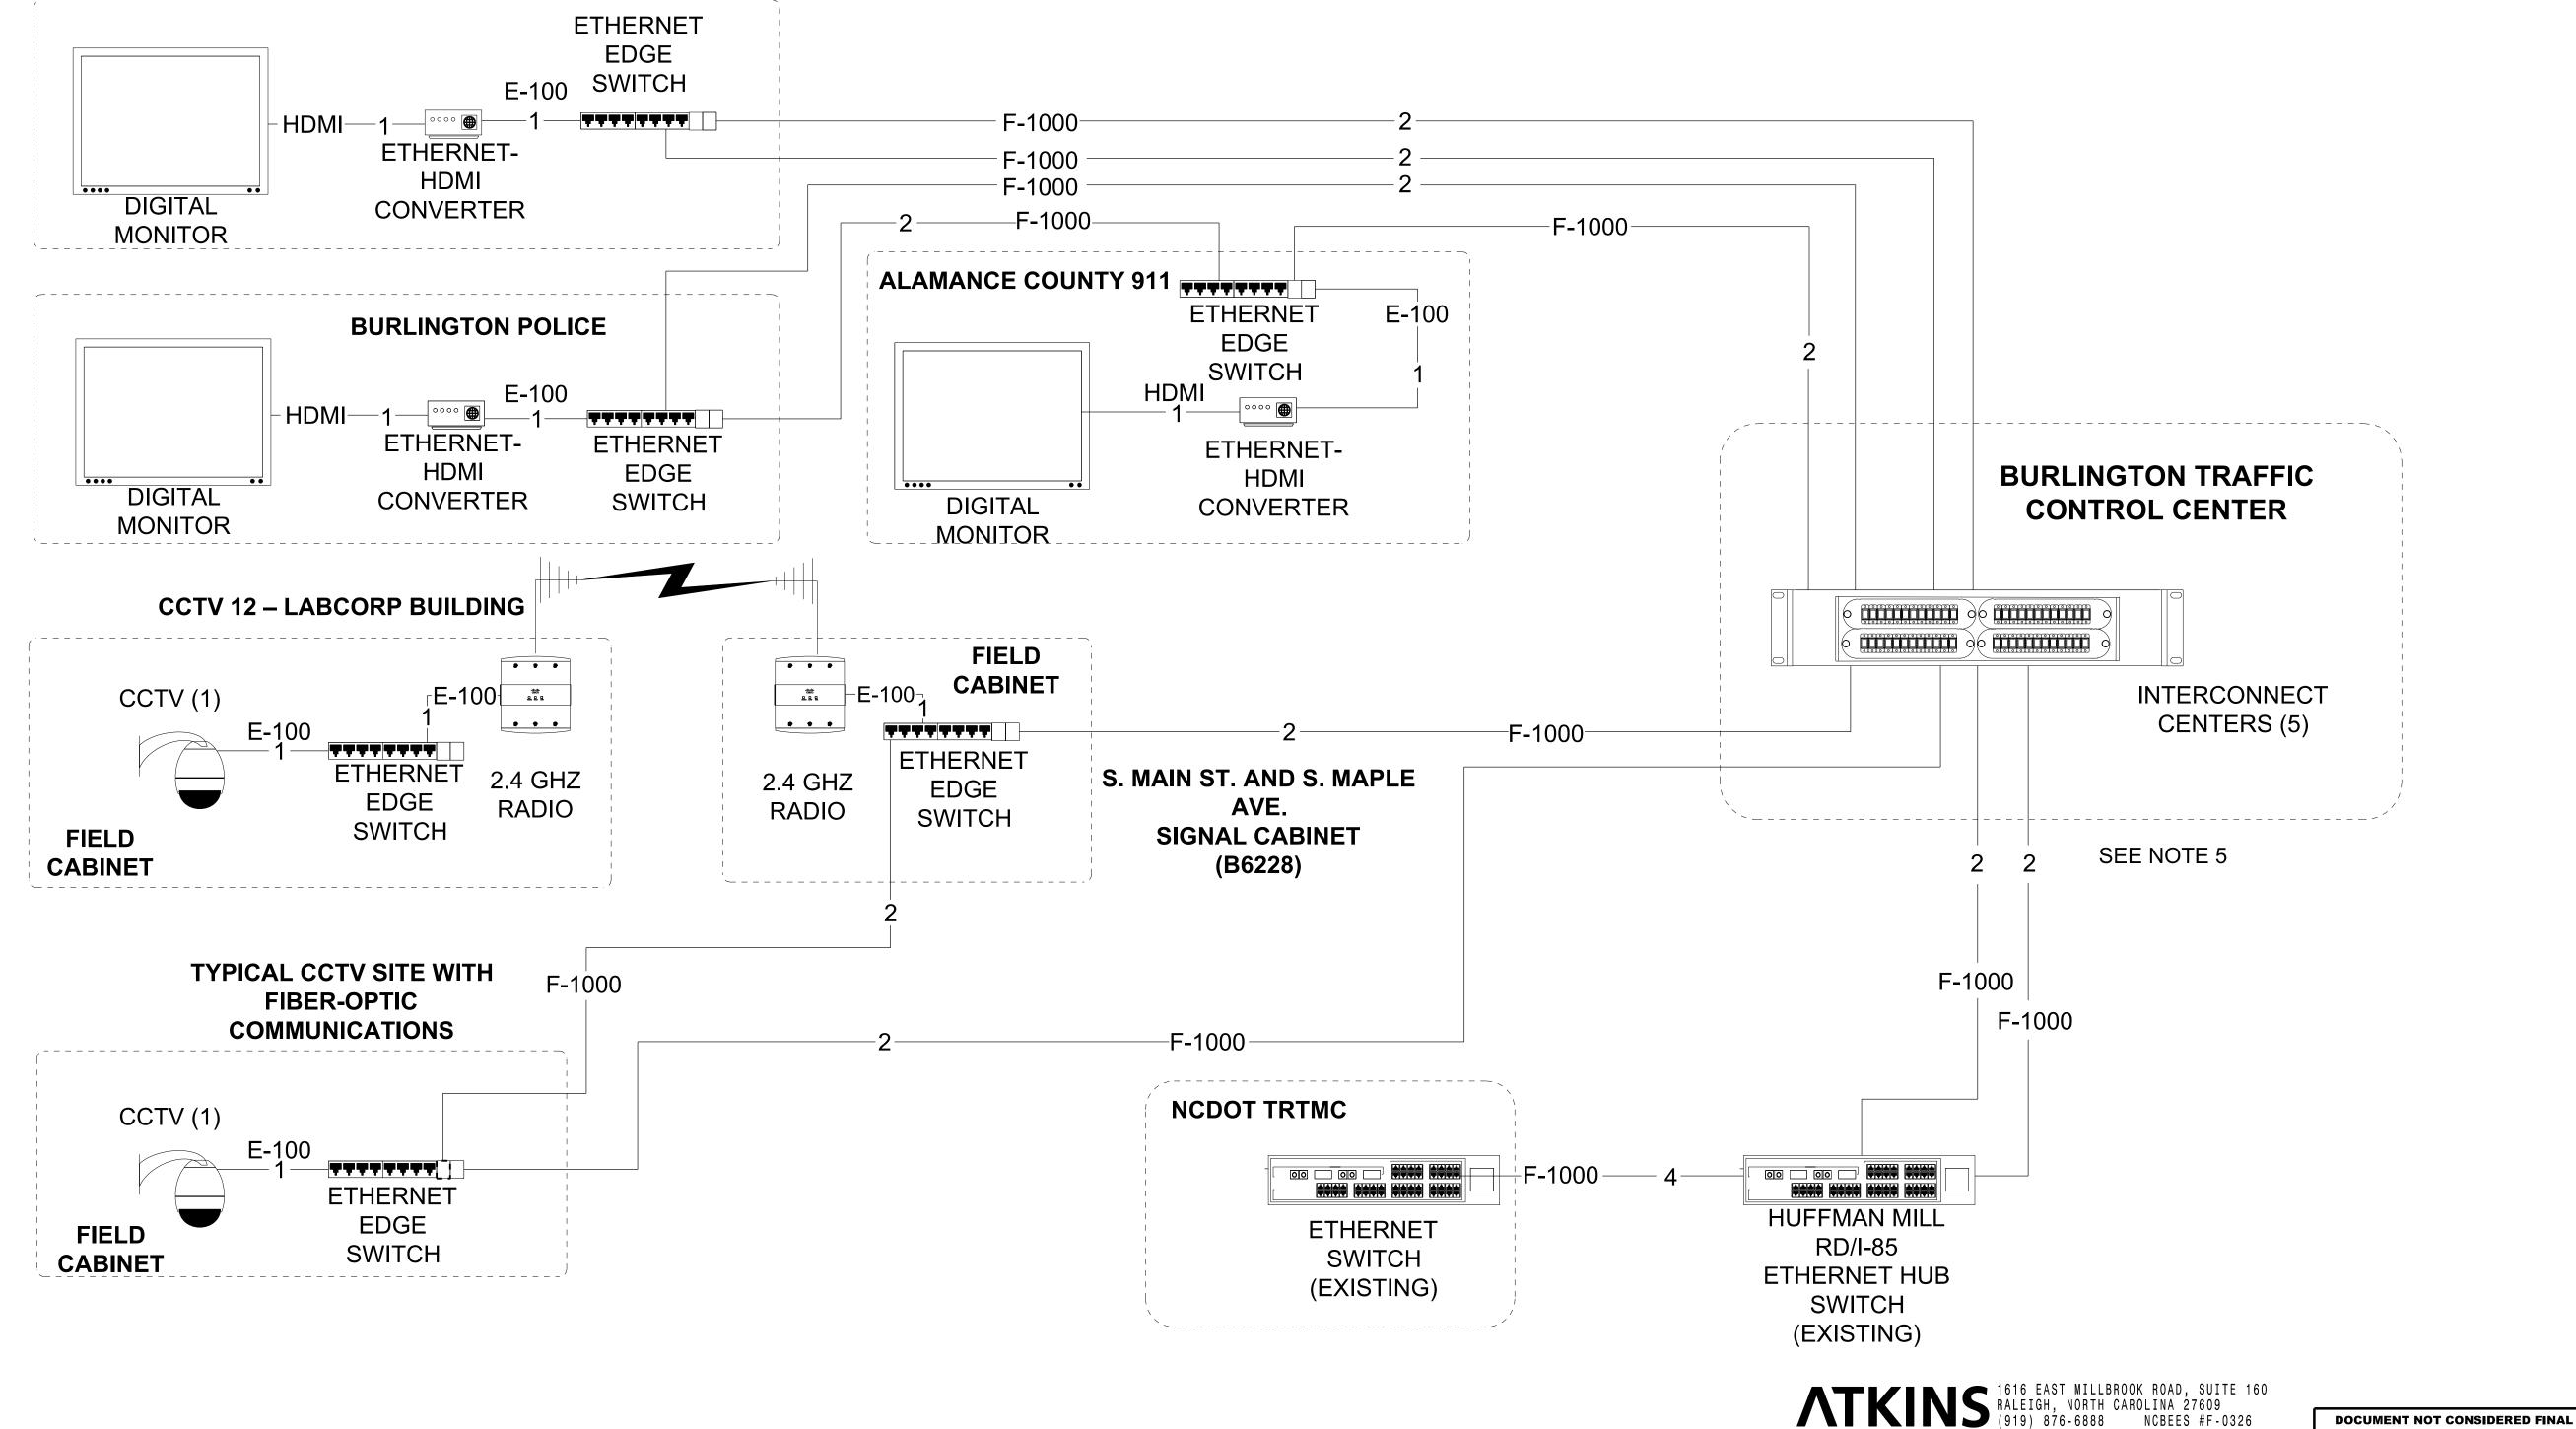


#### **NOTES**

- 1. ALL EQUIPMENT PROPOSED EXCEPT WHERE NOTED.
- 2. CCTV ARE EQUIPPED WITH INTERNAL ENCODERS.
- 3. EQUIPMENT IN CITY HALL, POLICE DEPT. AND ALAMANCE CO. 911 TO BE PROVIDED AND INSTALLED BY OTHERS.
- 4. MAINTAIN THE TACTICS SERVERS THROUGHOUT PROJECT.
- 5. SEE ITS-3.00 FOR ADDITIONAL EQUIPMENT IN TRAFFIC CONTROL CENTER.

**BURLINGTON CITY** 

HALL

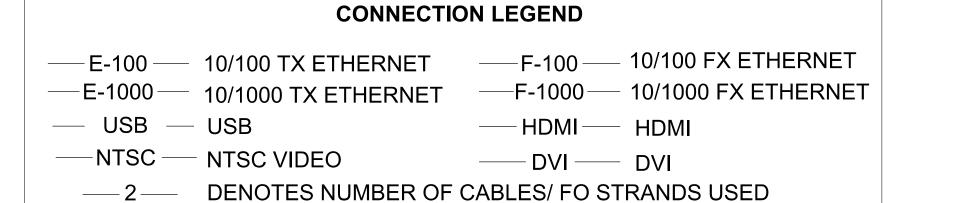

Burlington-Graham Signal System

Block Diagrams

(2 of 3)

Burlington & Division 7 Alamance County Graham

PLAN DATE: June 2018 REVIEWED BY: HA Badgett

Turner, NC 27529 PREPARED BY: JW/AH REVIEWED BY: BJ Slocum

PLAN DATE: JUNE 2018 REVIEWED BY: HA BAGGETT

Fild Parkway, Garner, NC 27529 PREPARED BY: JW/AH REVIEWED BY: BJ Slocum

SCALE REVISIONS INIT. DATE

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U-6015 ITS-3.0

June 2018 REVIEWED BY: HA Badgett

REVIEWED BY: BJ Slocum


INIT. DATE

JW/AH


REVISIONS


50 Greenfield Parkway, Garner, NC 275

NTS

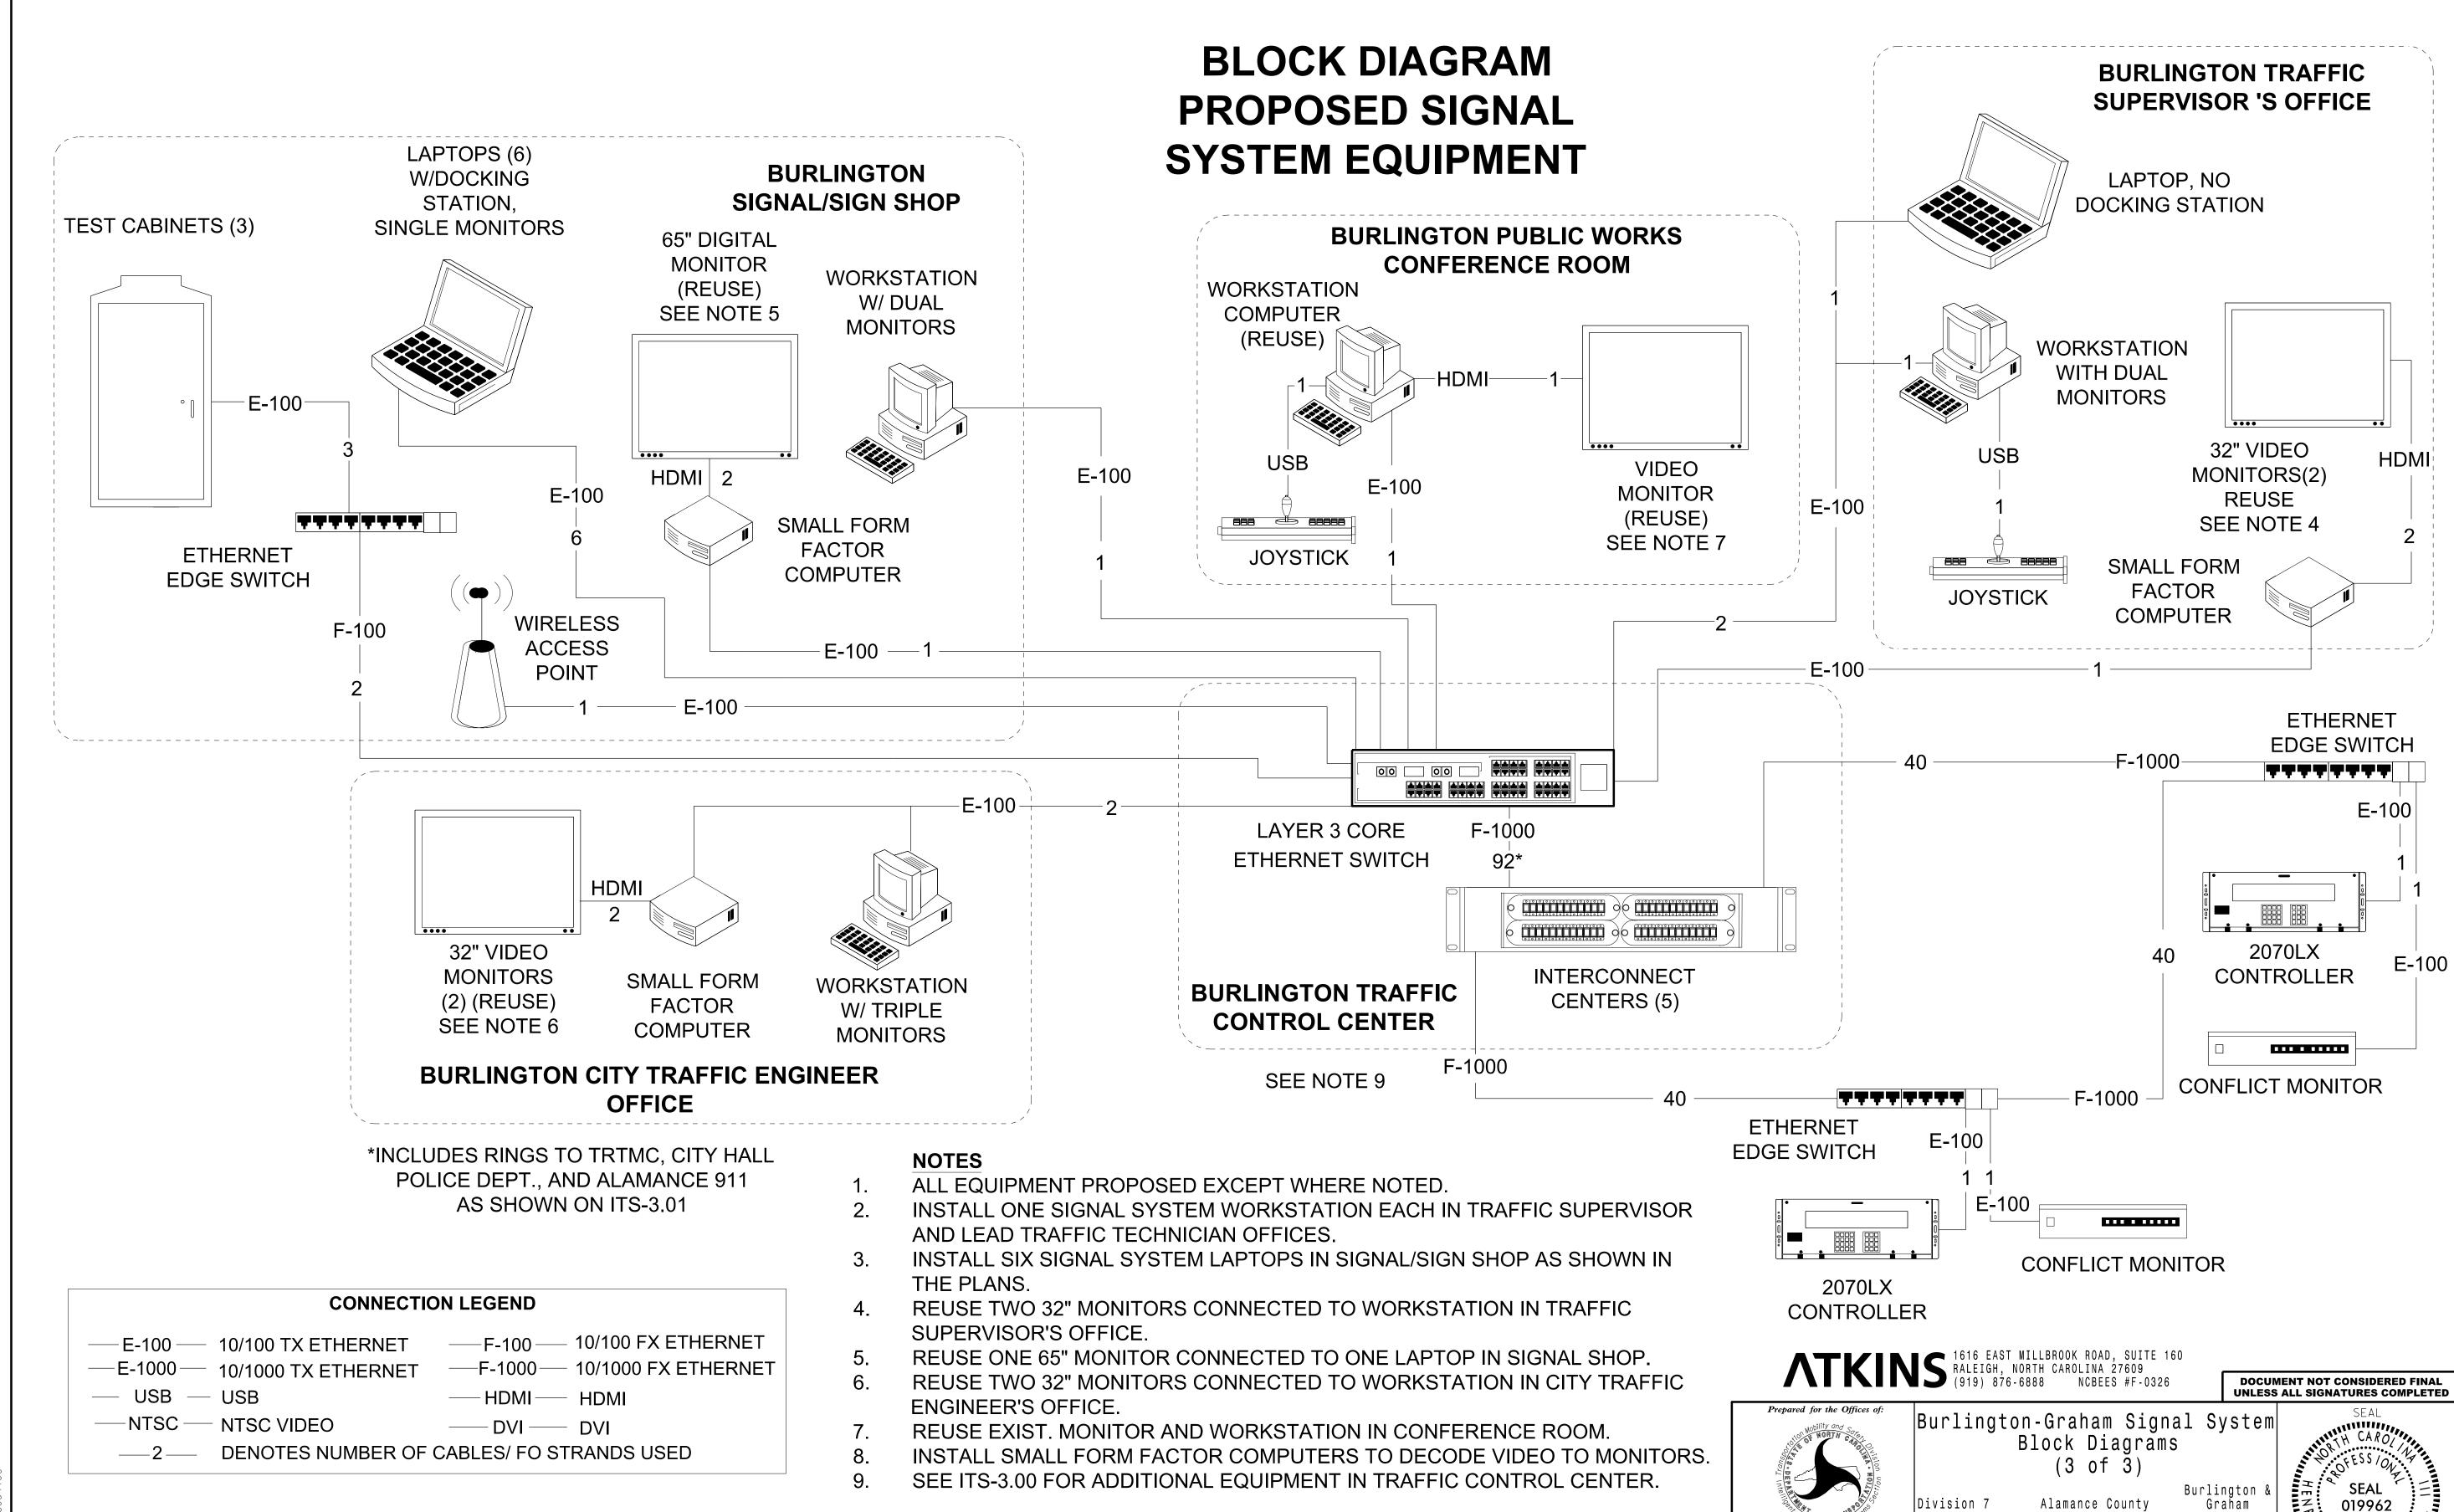


|3-JUN-2018 U9:40 | 0:\*Transportation\*Traffic\*Curr\*100056469 U-6015 B-G Sig Sys\*To | HOEK7534 | AT LUS354180

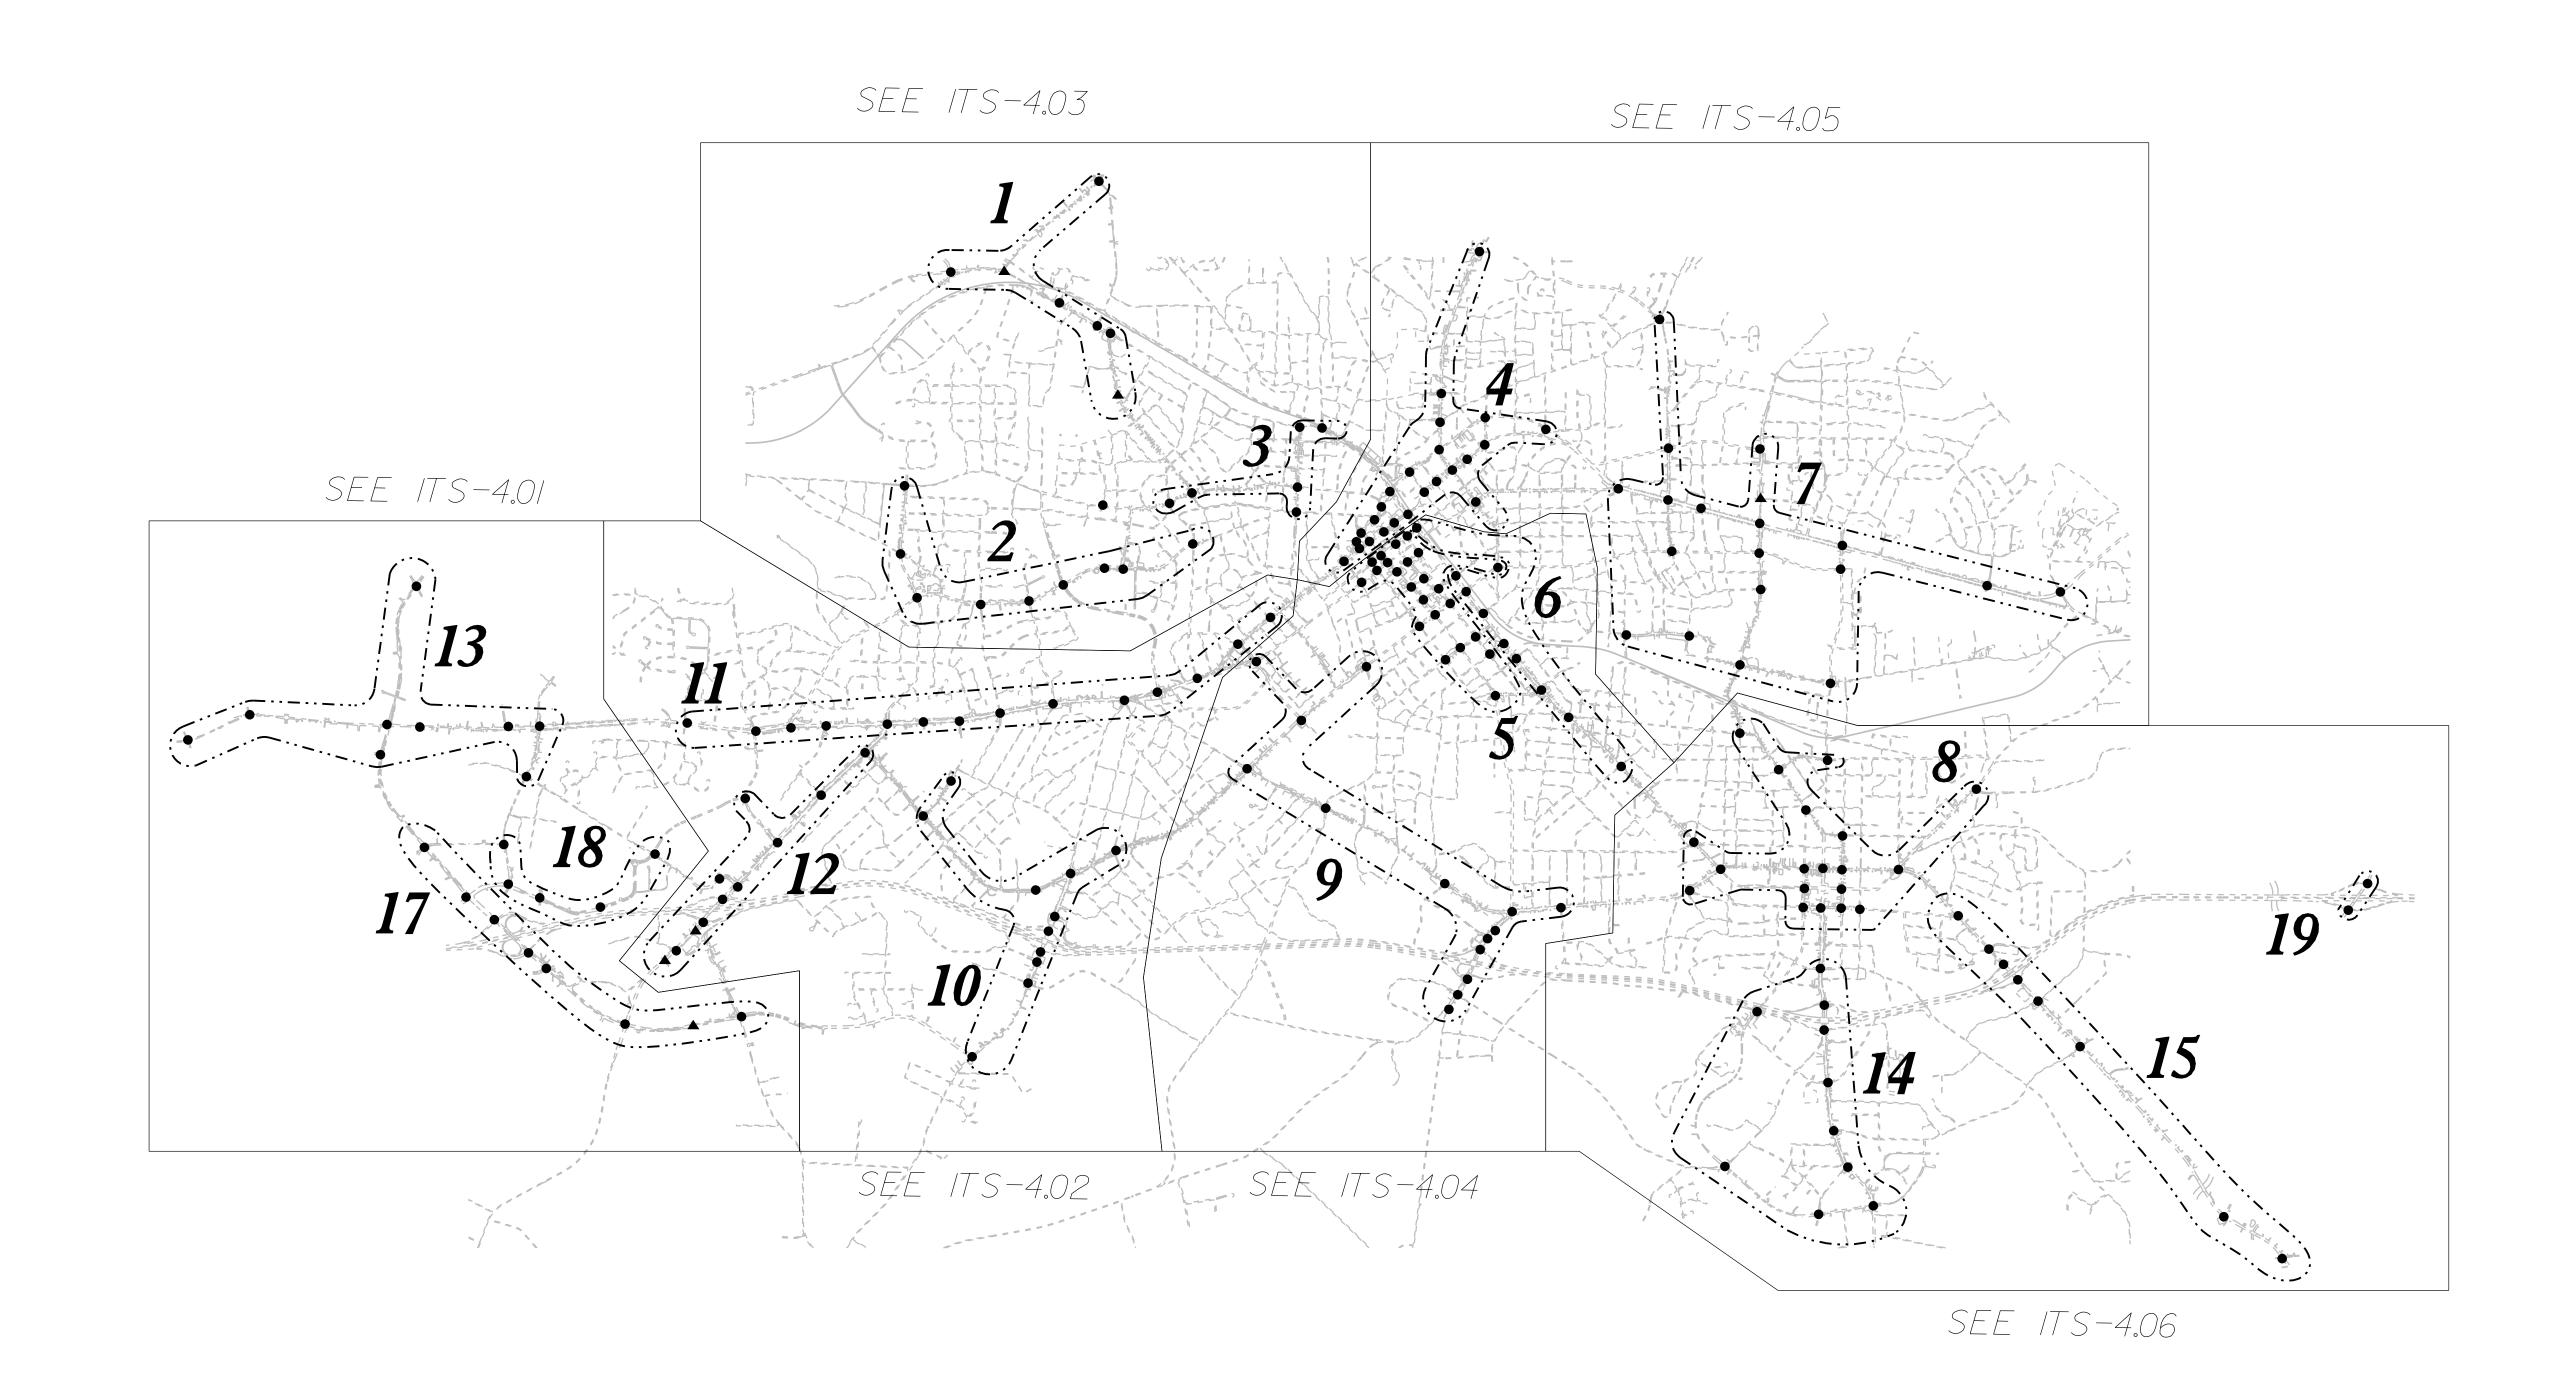

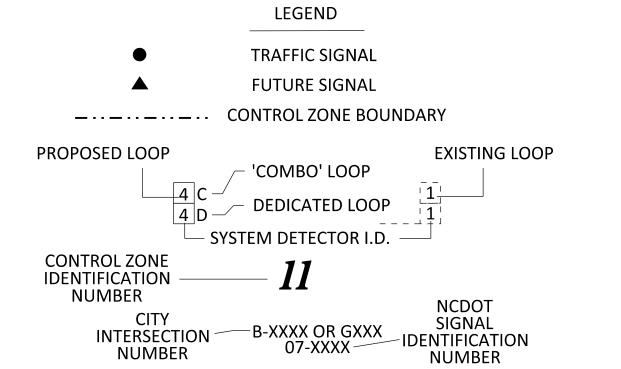

#### NOTES

- SEE SIGNAL AND CABLE ROUTING PLANS FOR EXACT LOCATIONS OF SYSTEM DETECTORS.
- CONTROL ZONE 16 IS A TEST ZONE IN SIGNAL SHOP AND NOT SHOWN.

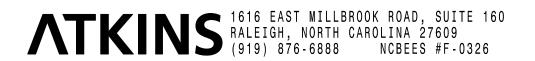



Burlington-Graham Signal System System Detectors and Control Zones (1 of 7)


Alamance County June 2018 REVIEWED BY: HA Badgett

JW/AH REVIEWED BY: BJ Slocum 750 Greenfield Parkway, Garner, NC 27529 PREPARED BY: REVISIONS


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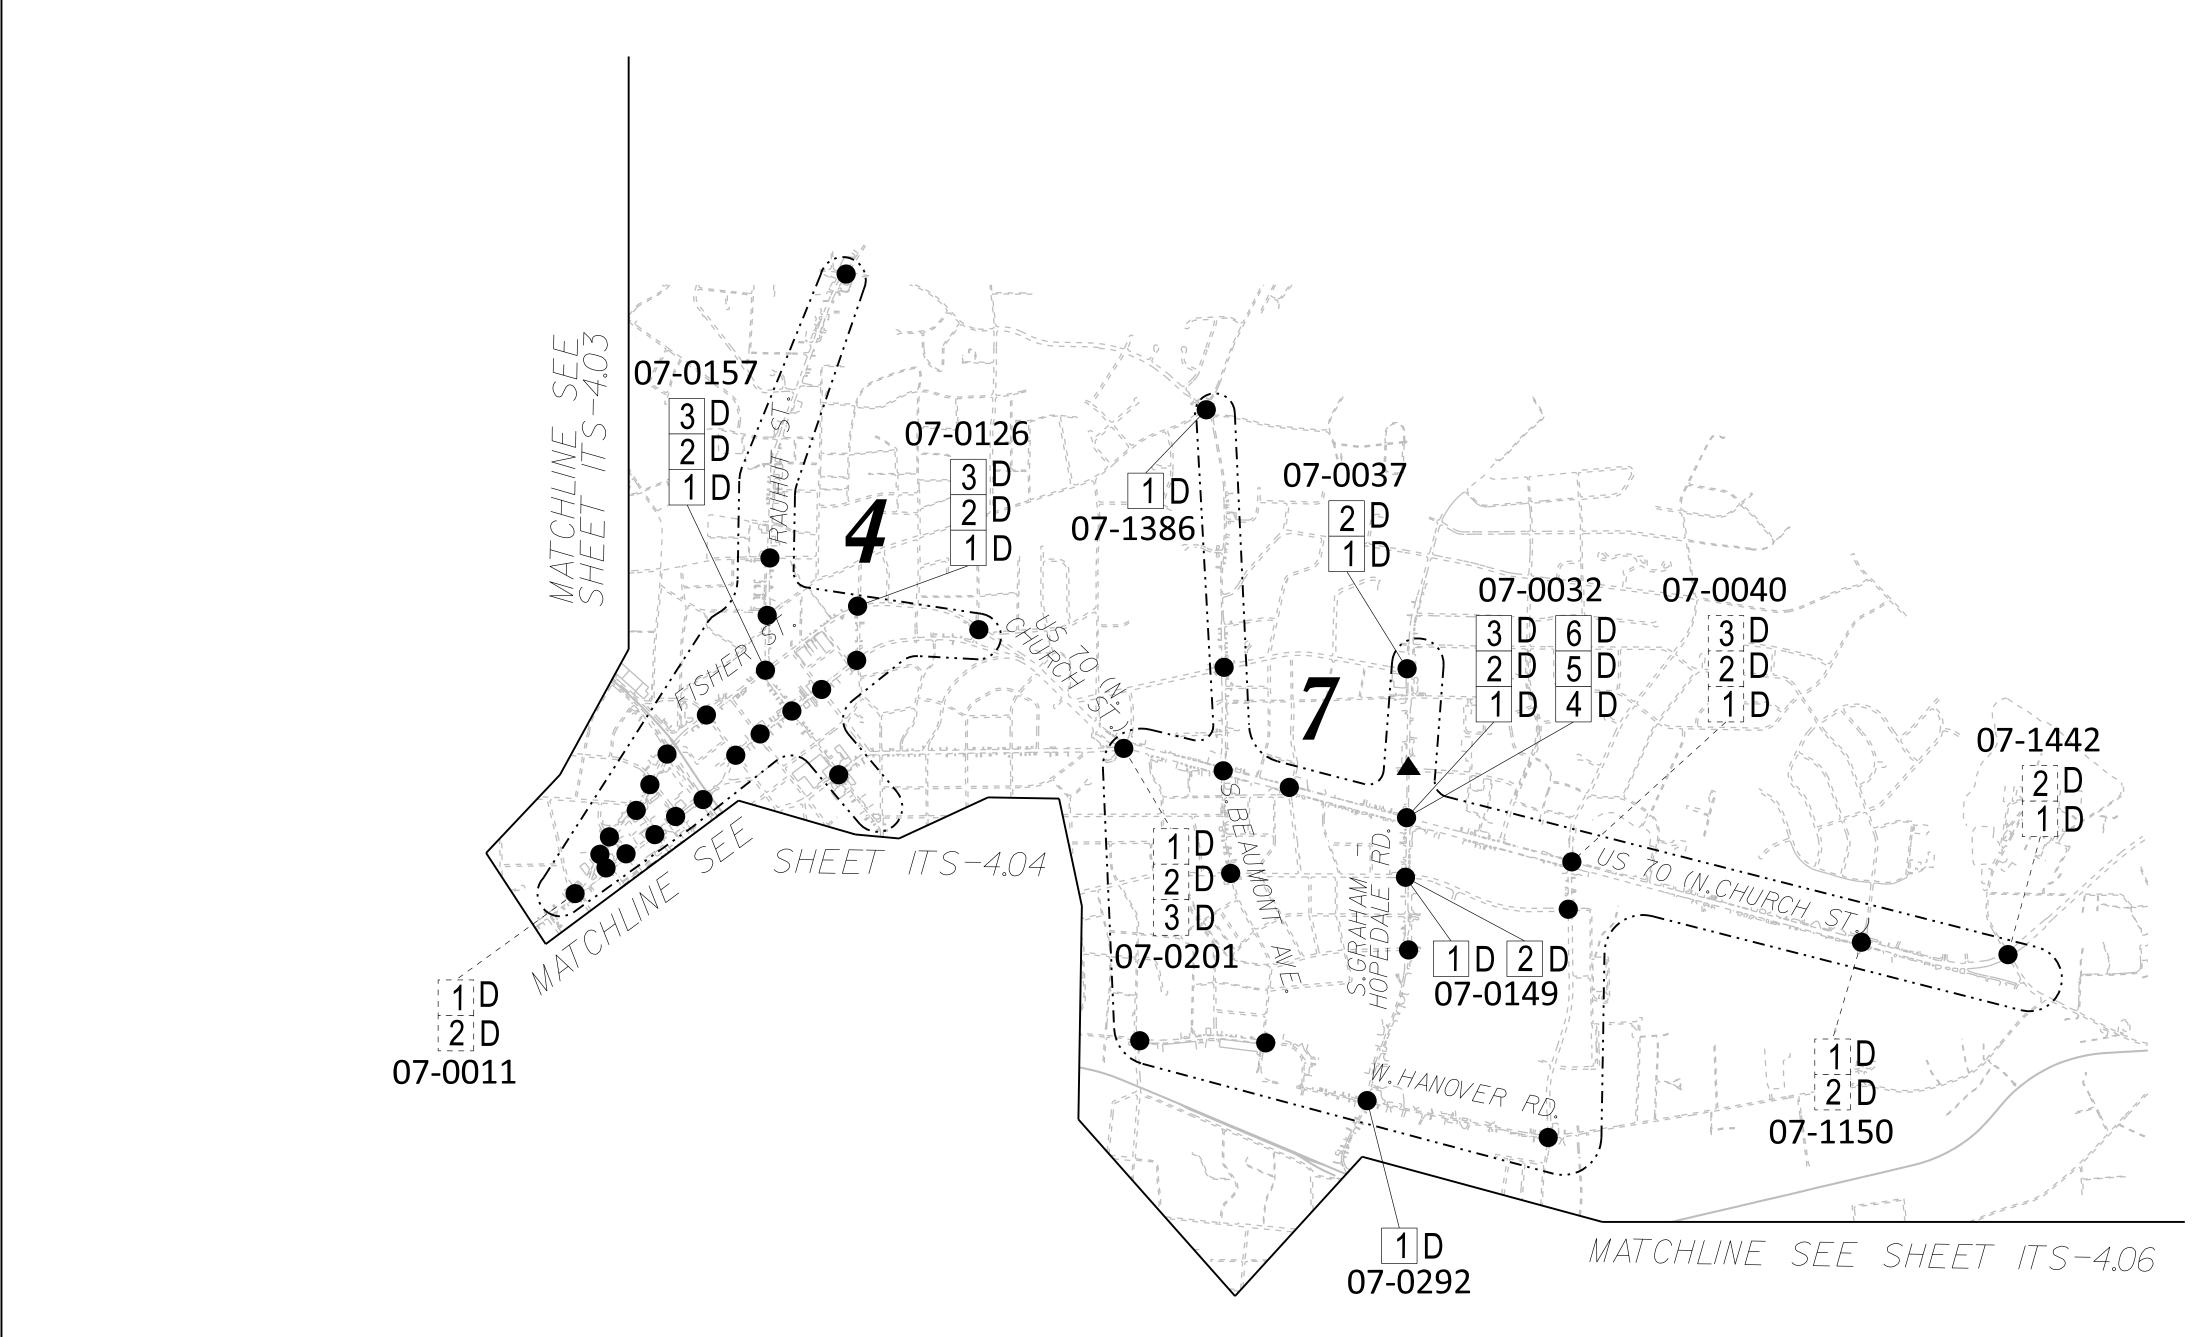


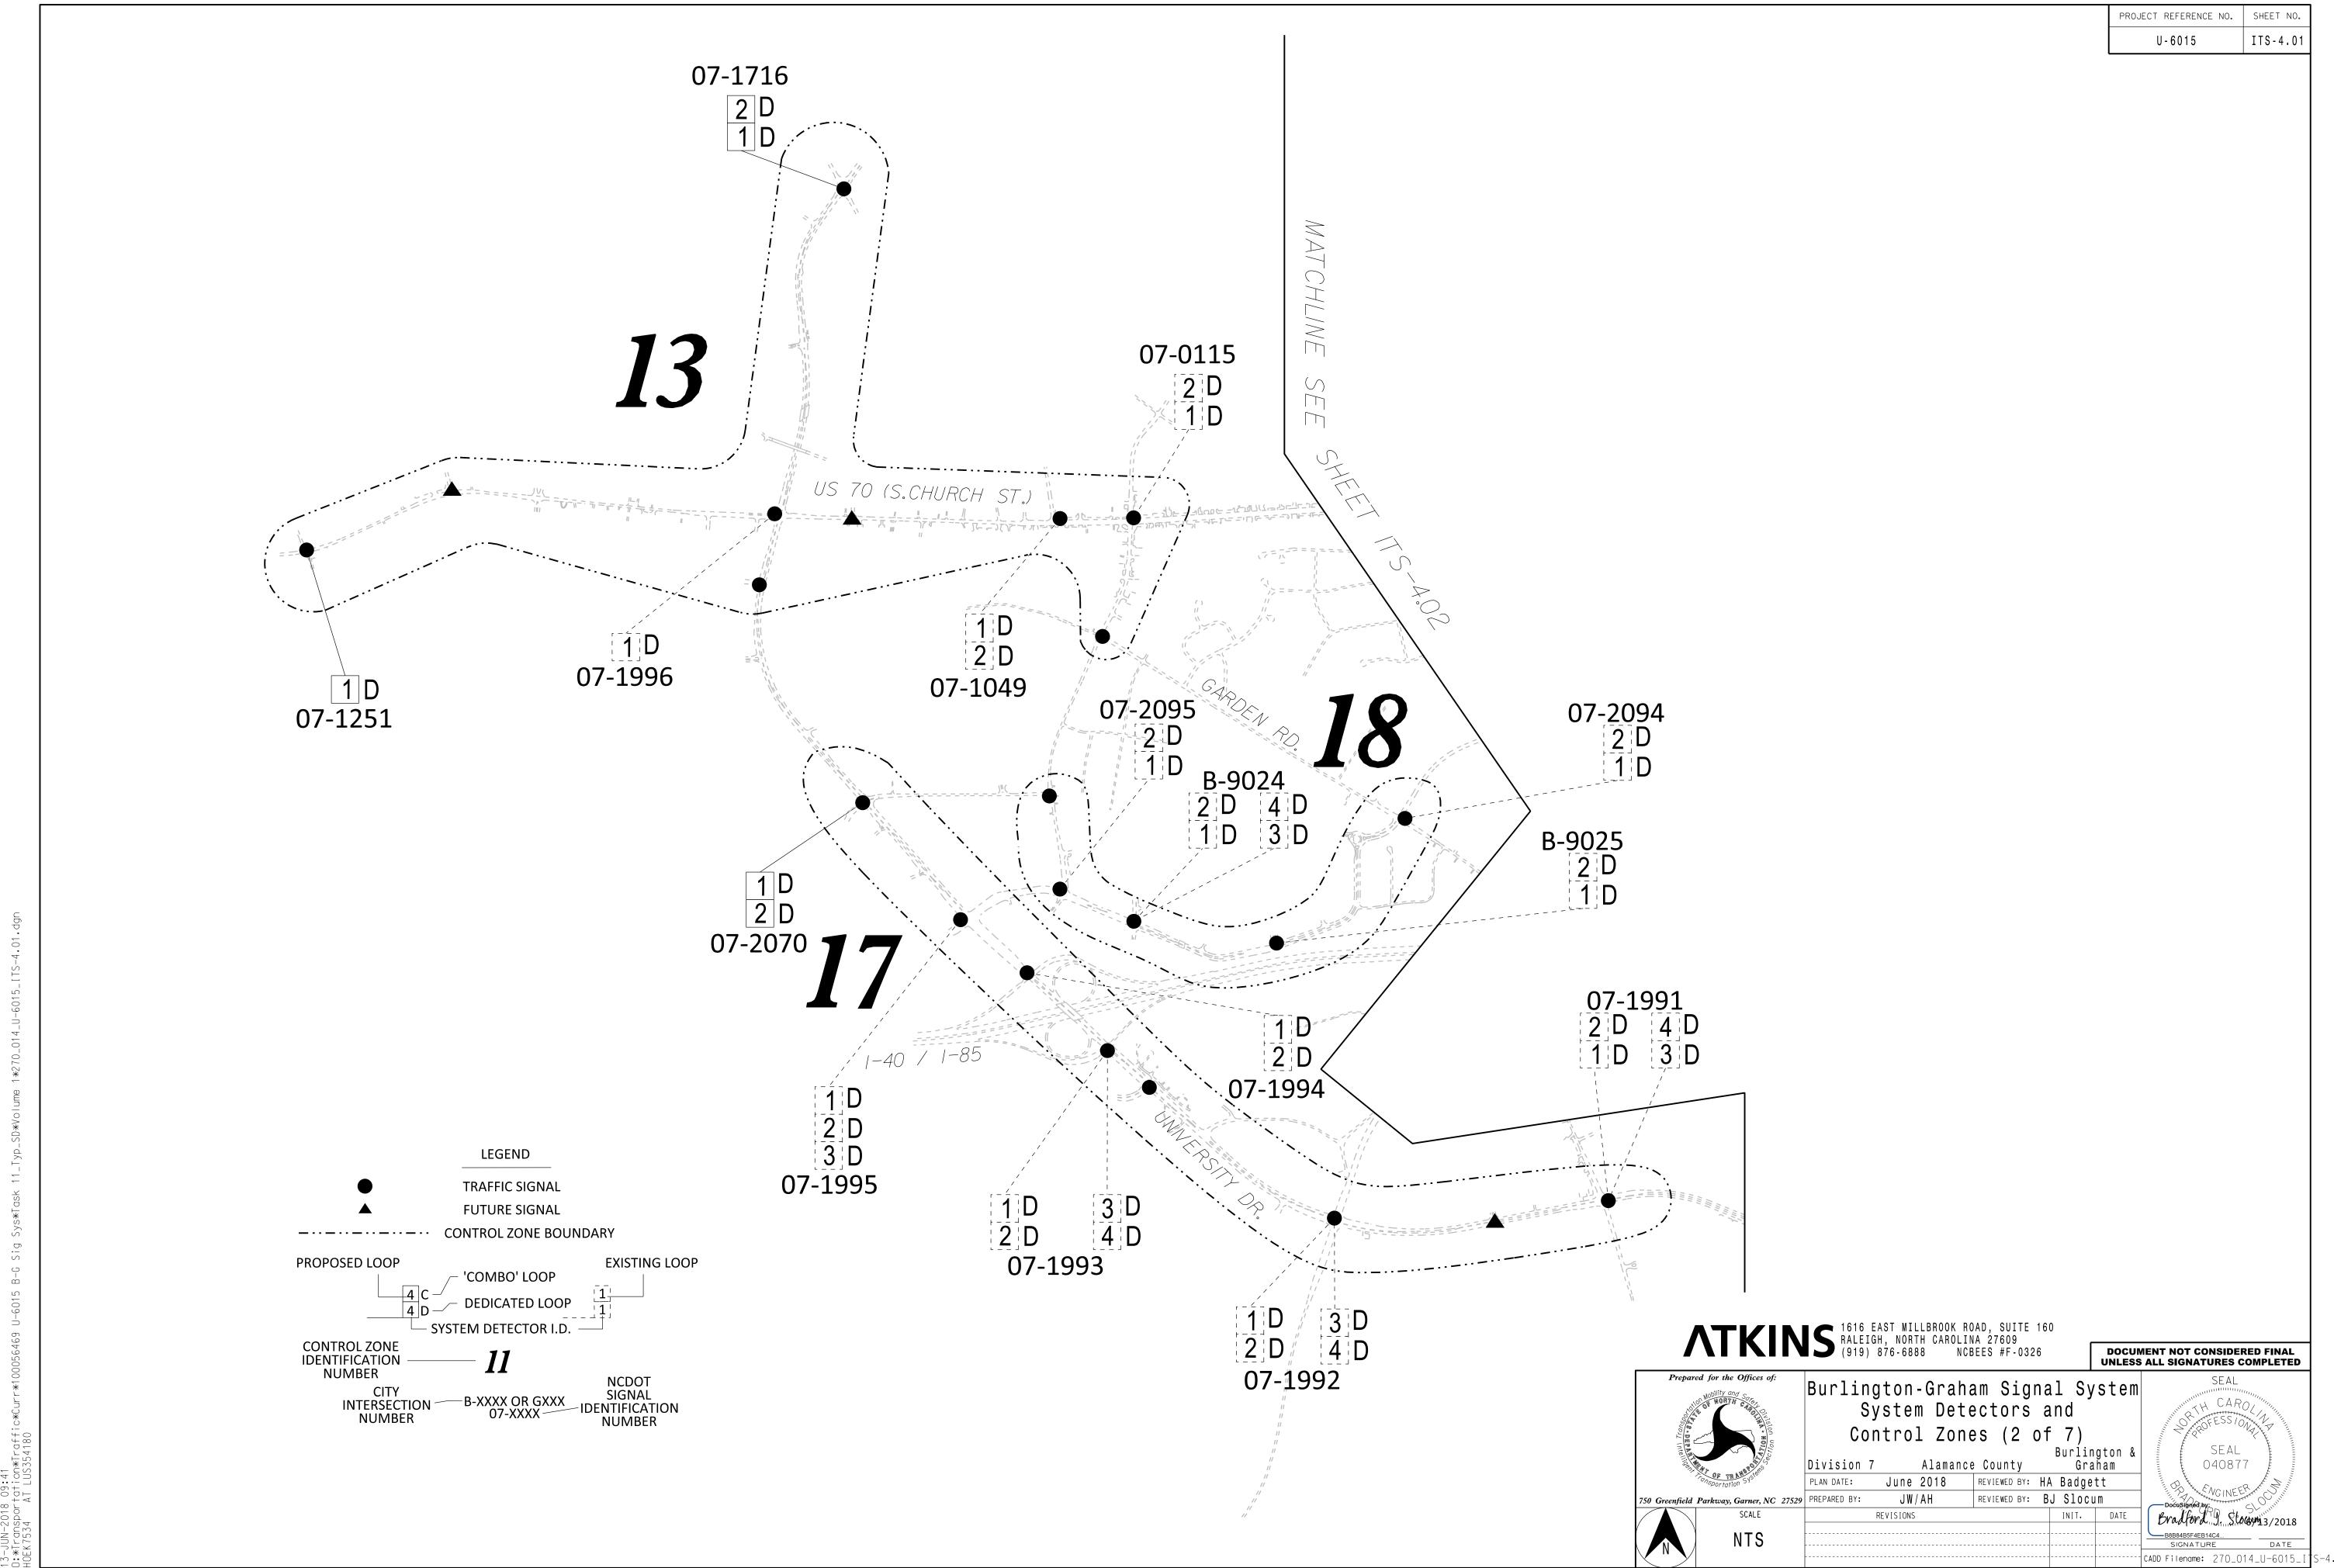
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and of 5)

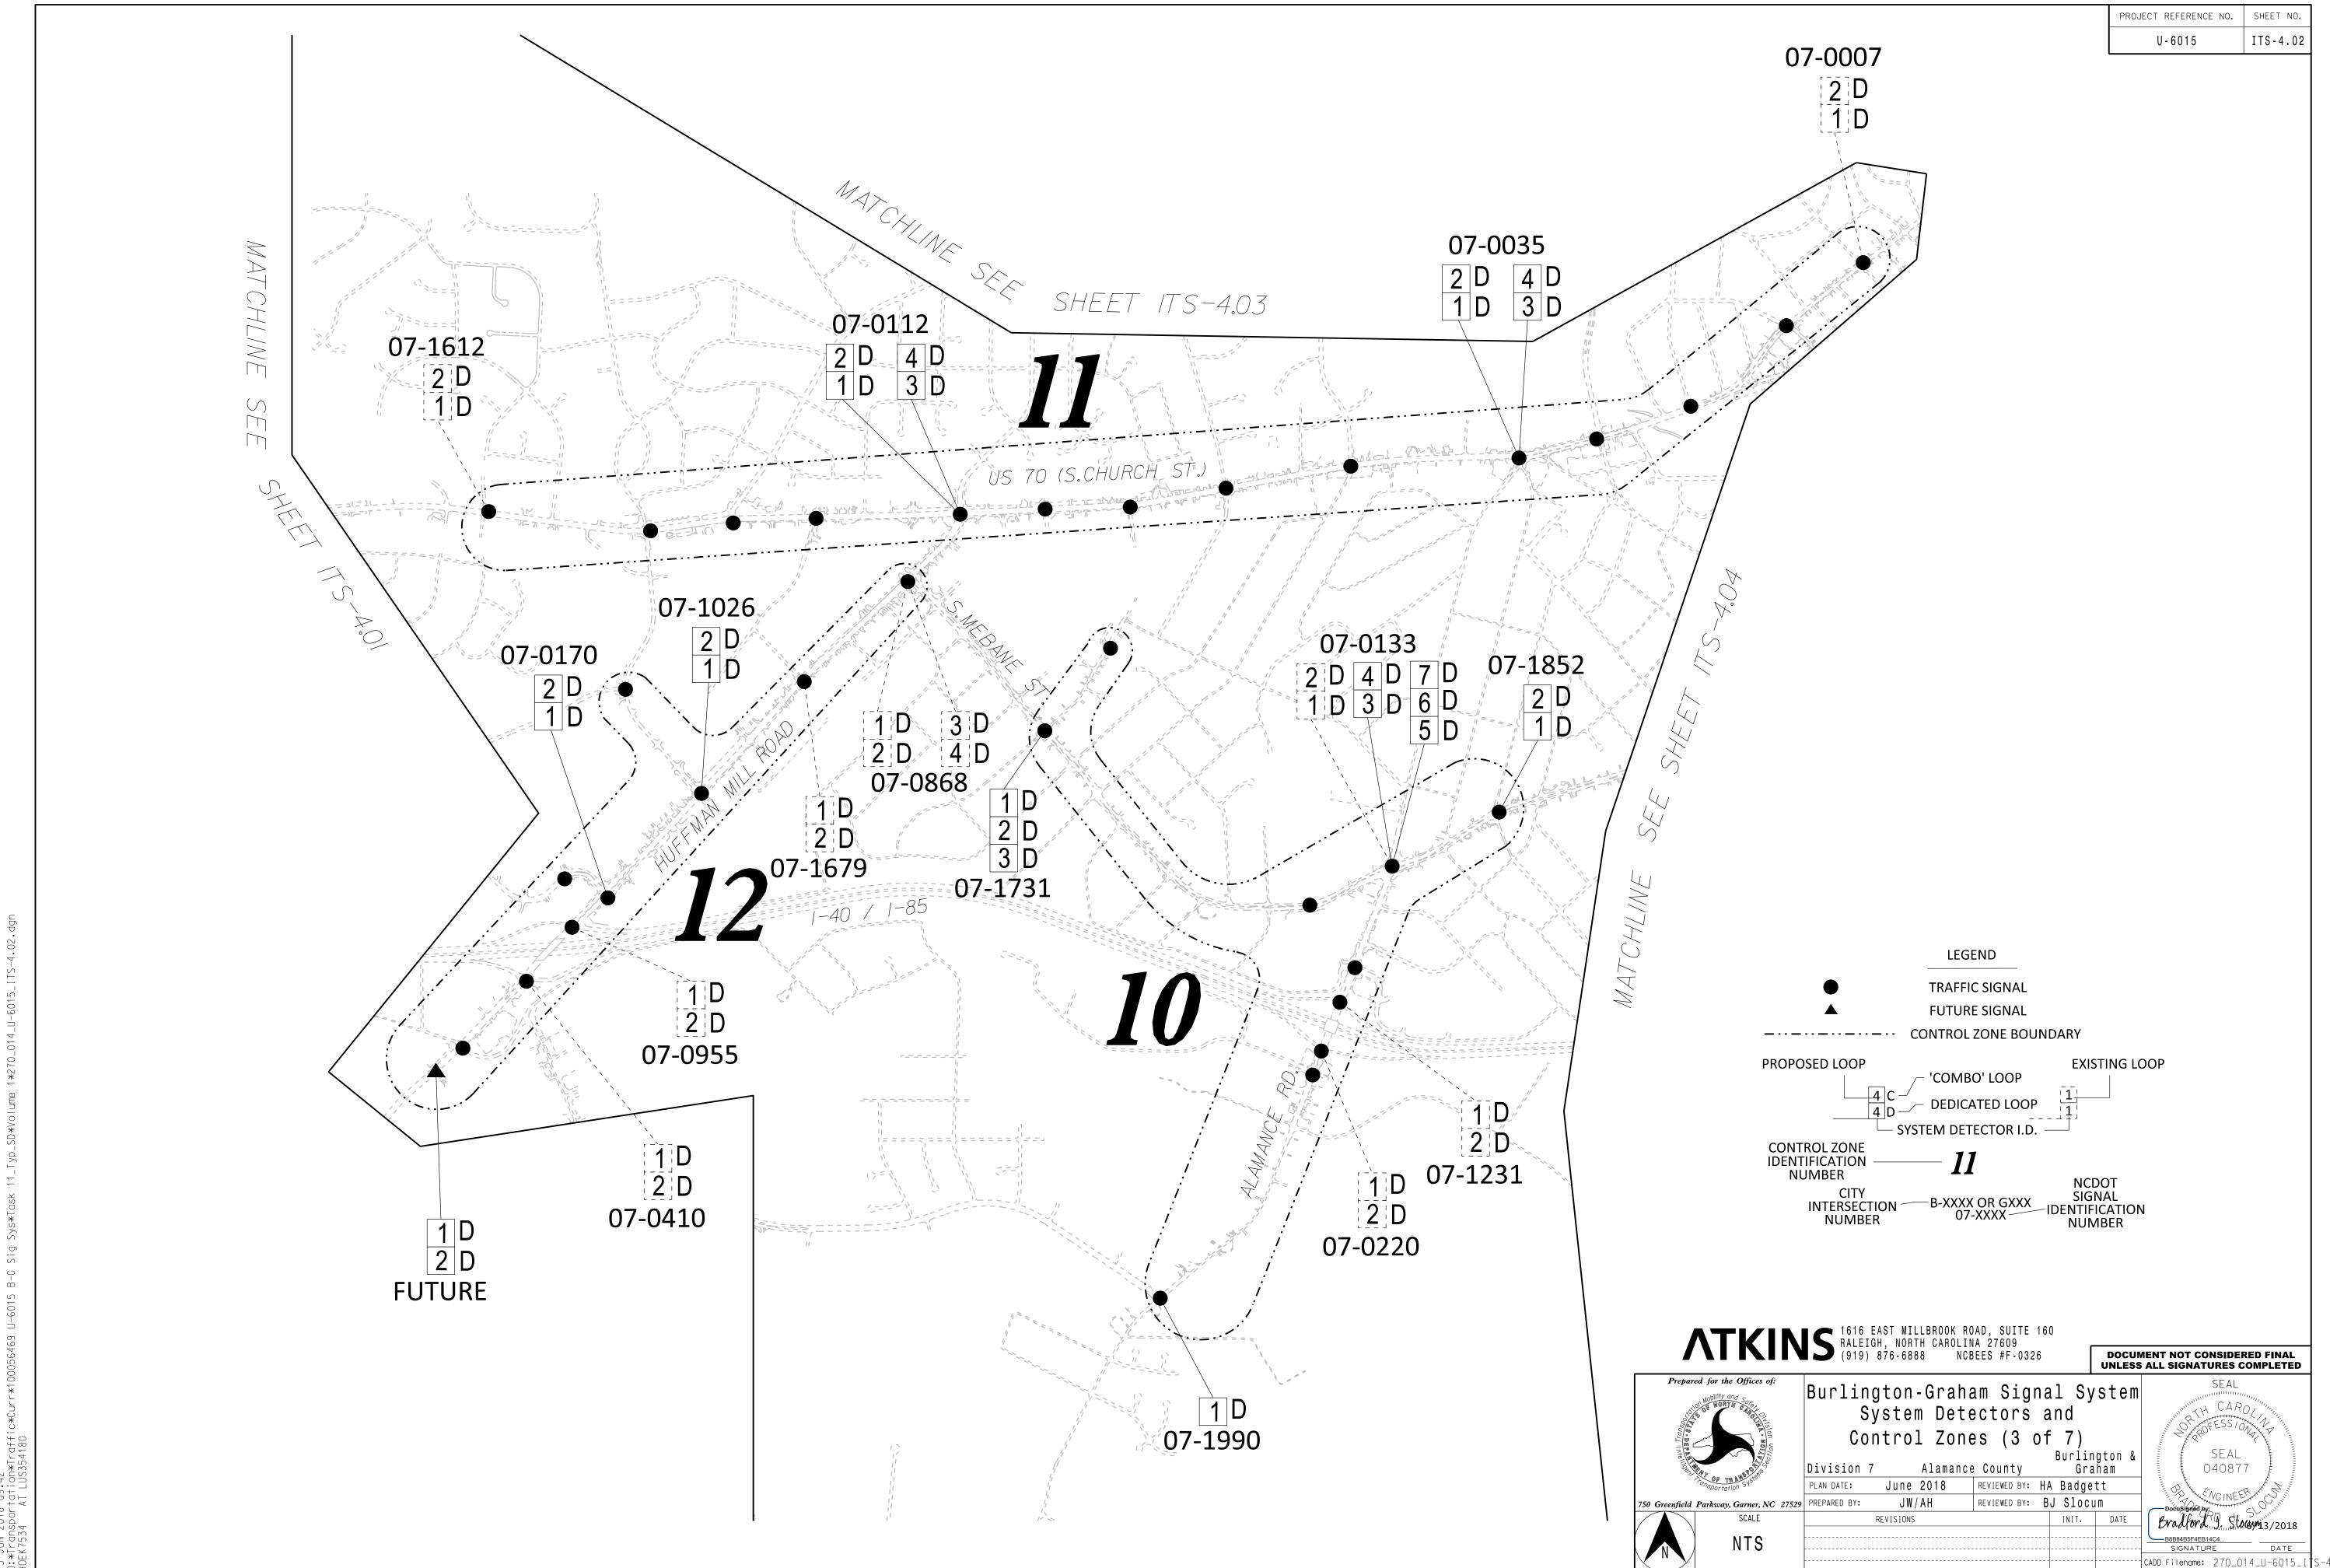PROJECT REFERENCE NO. SHEET NO U-6015 ITS-4.0

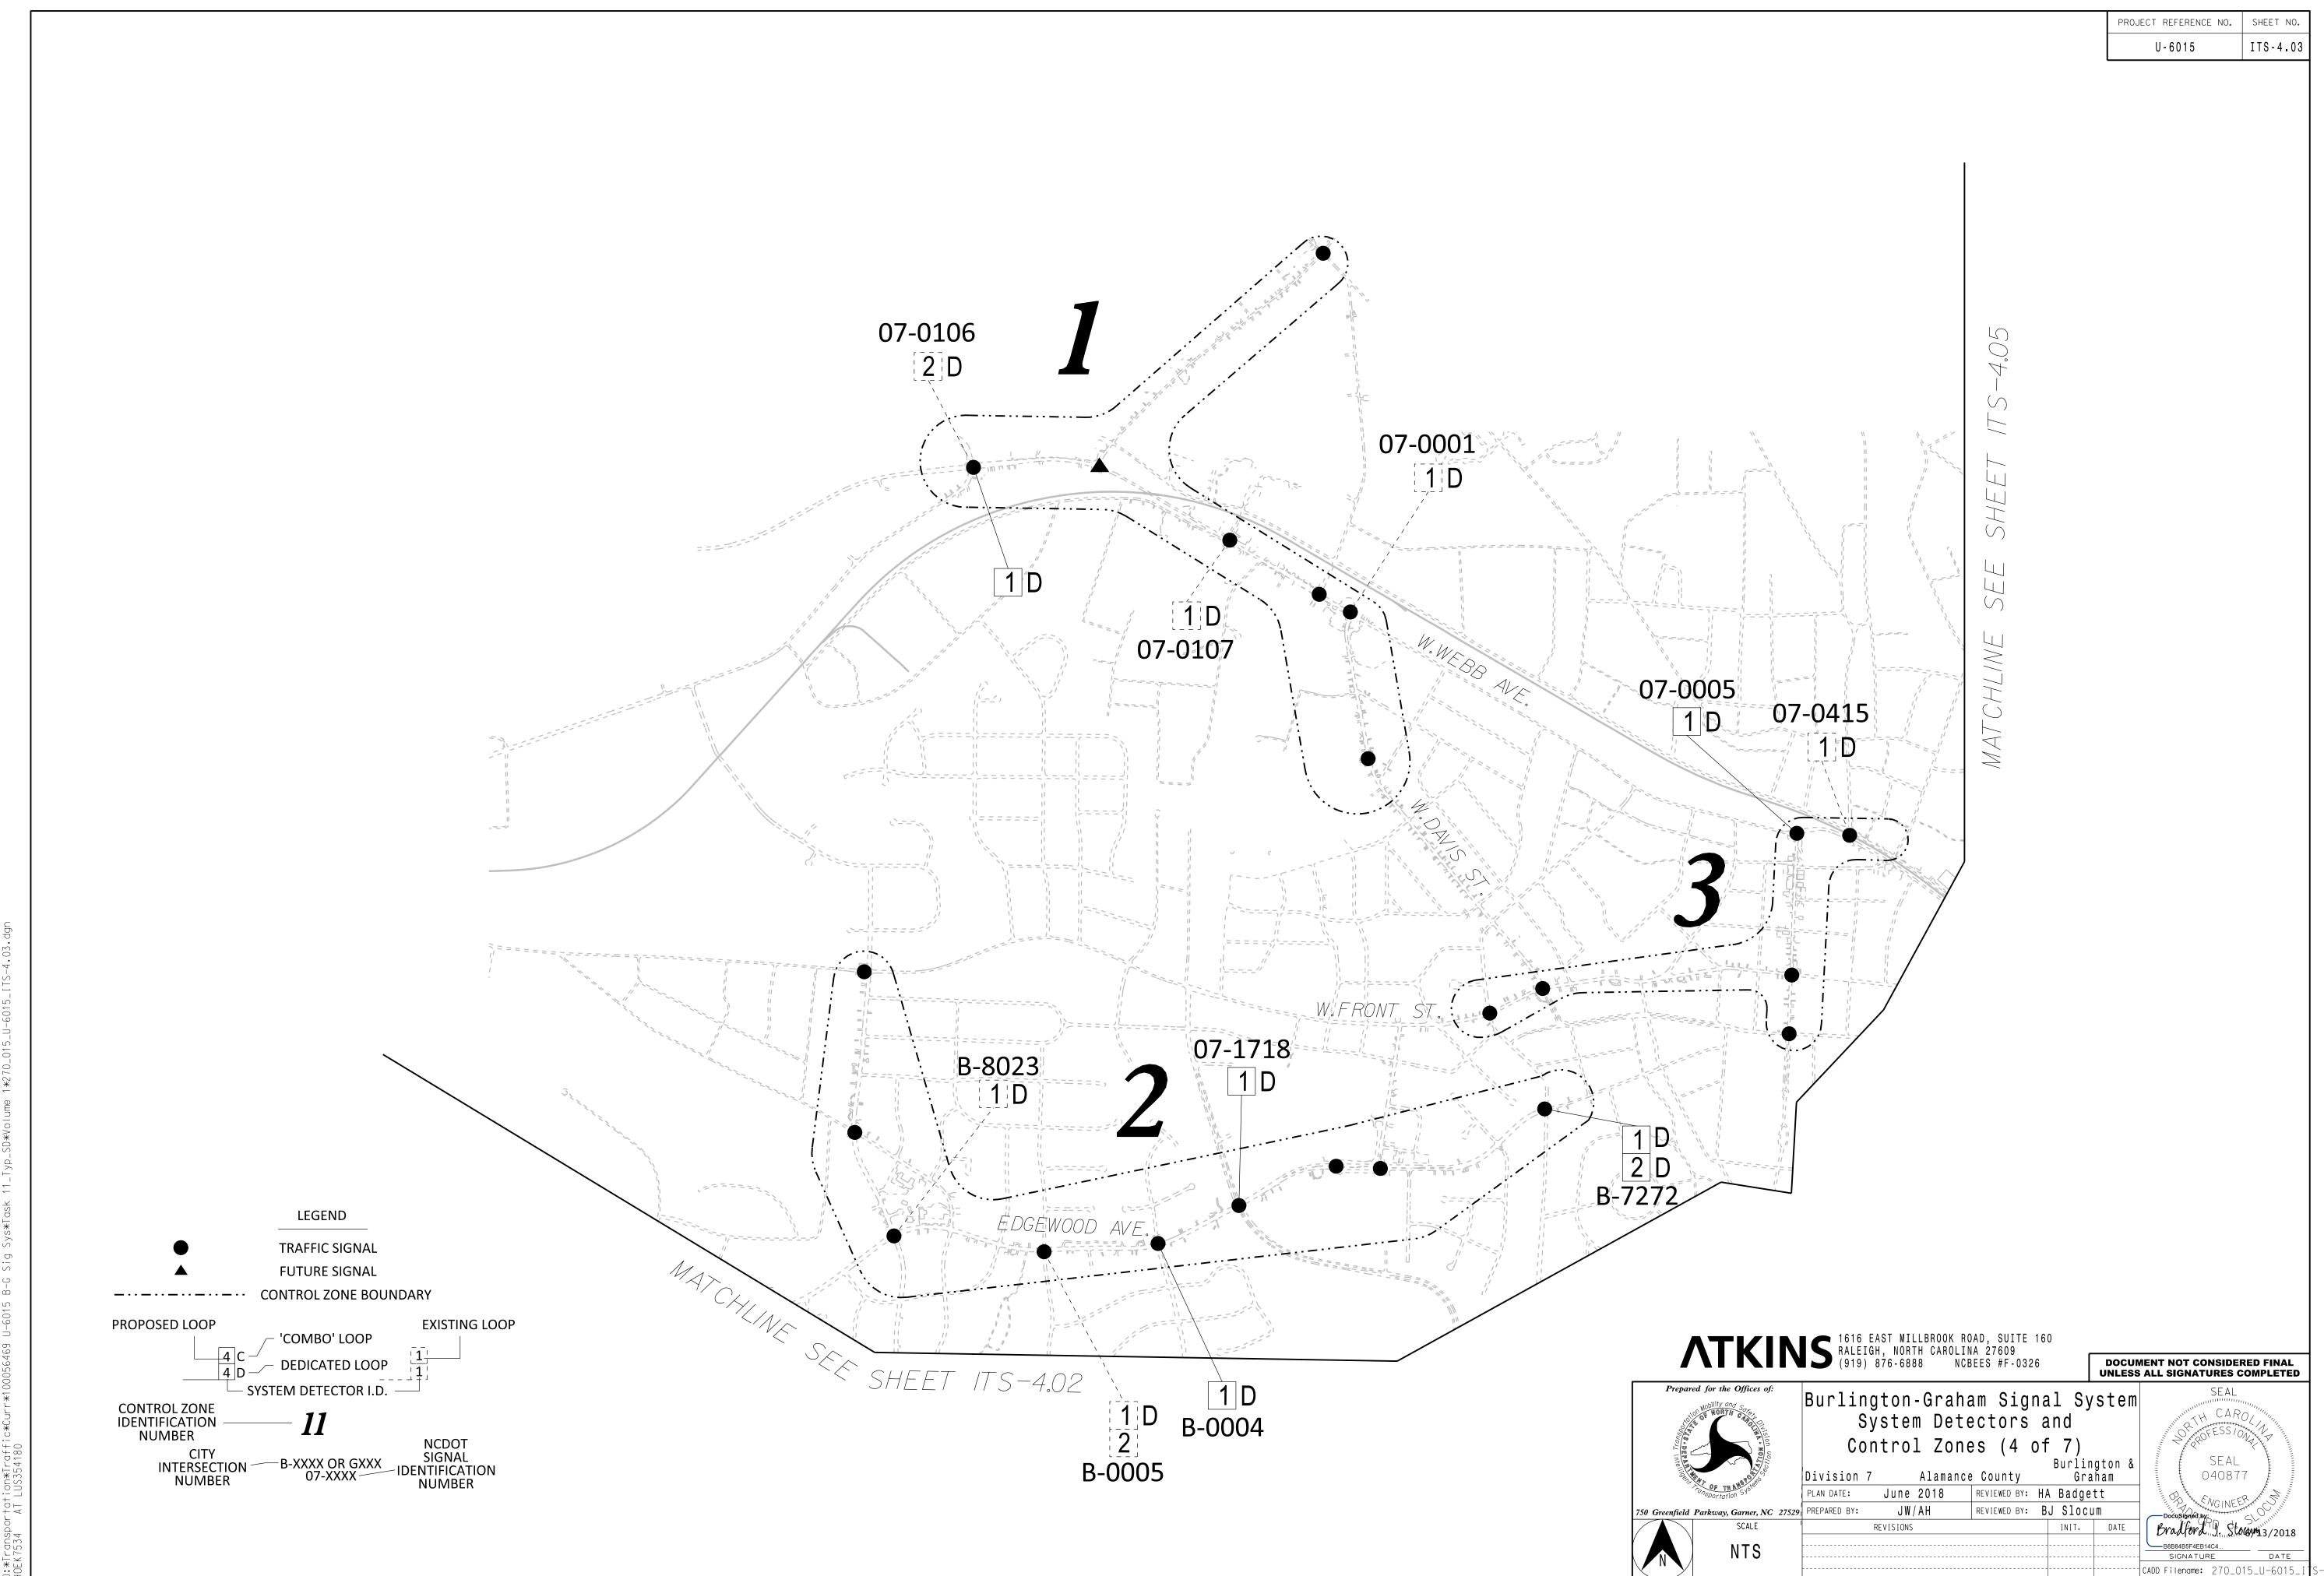

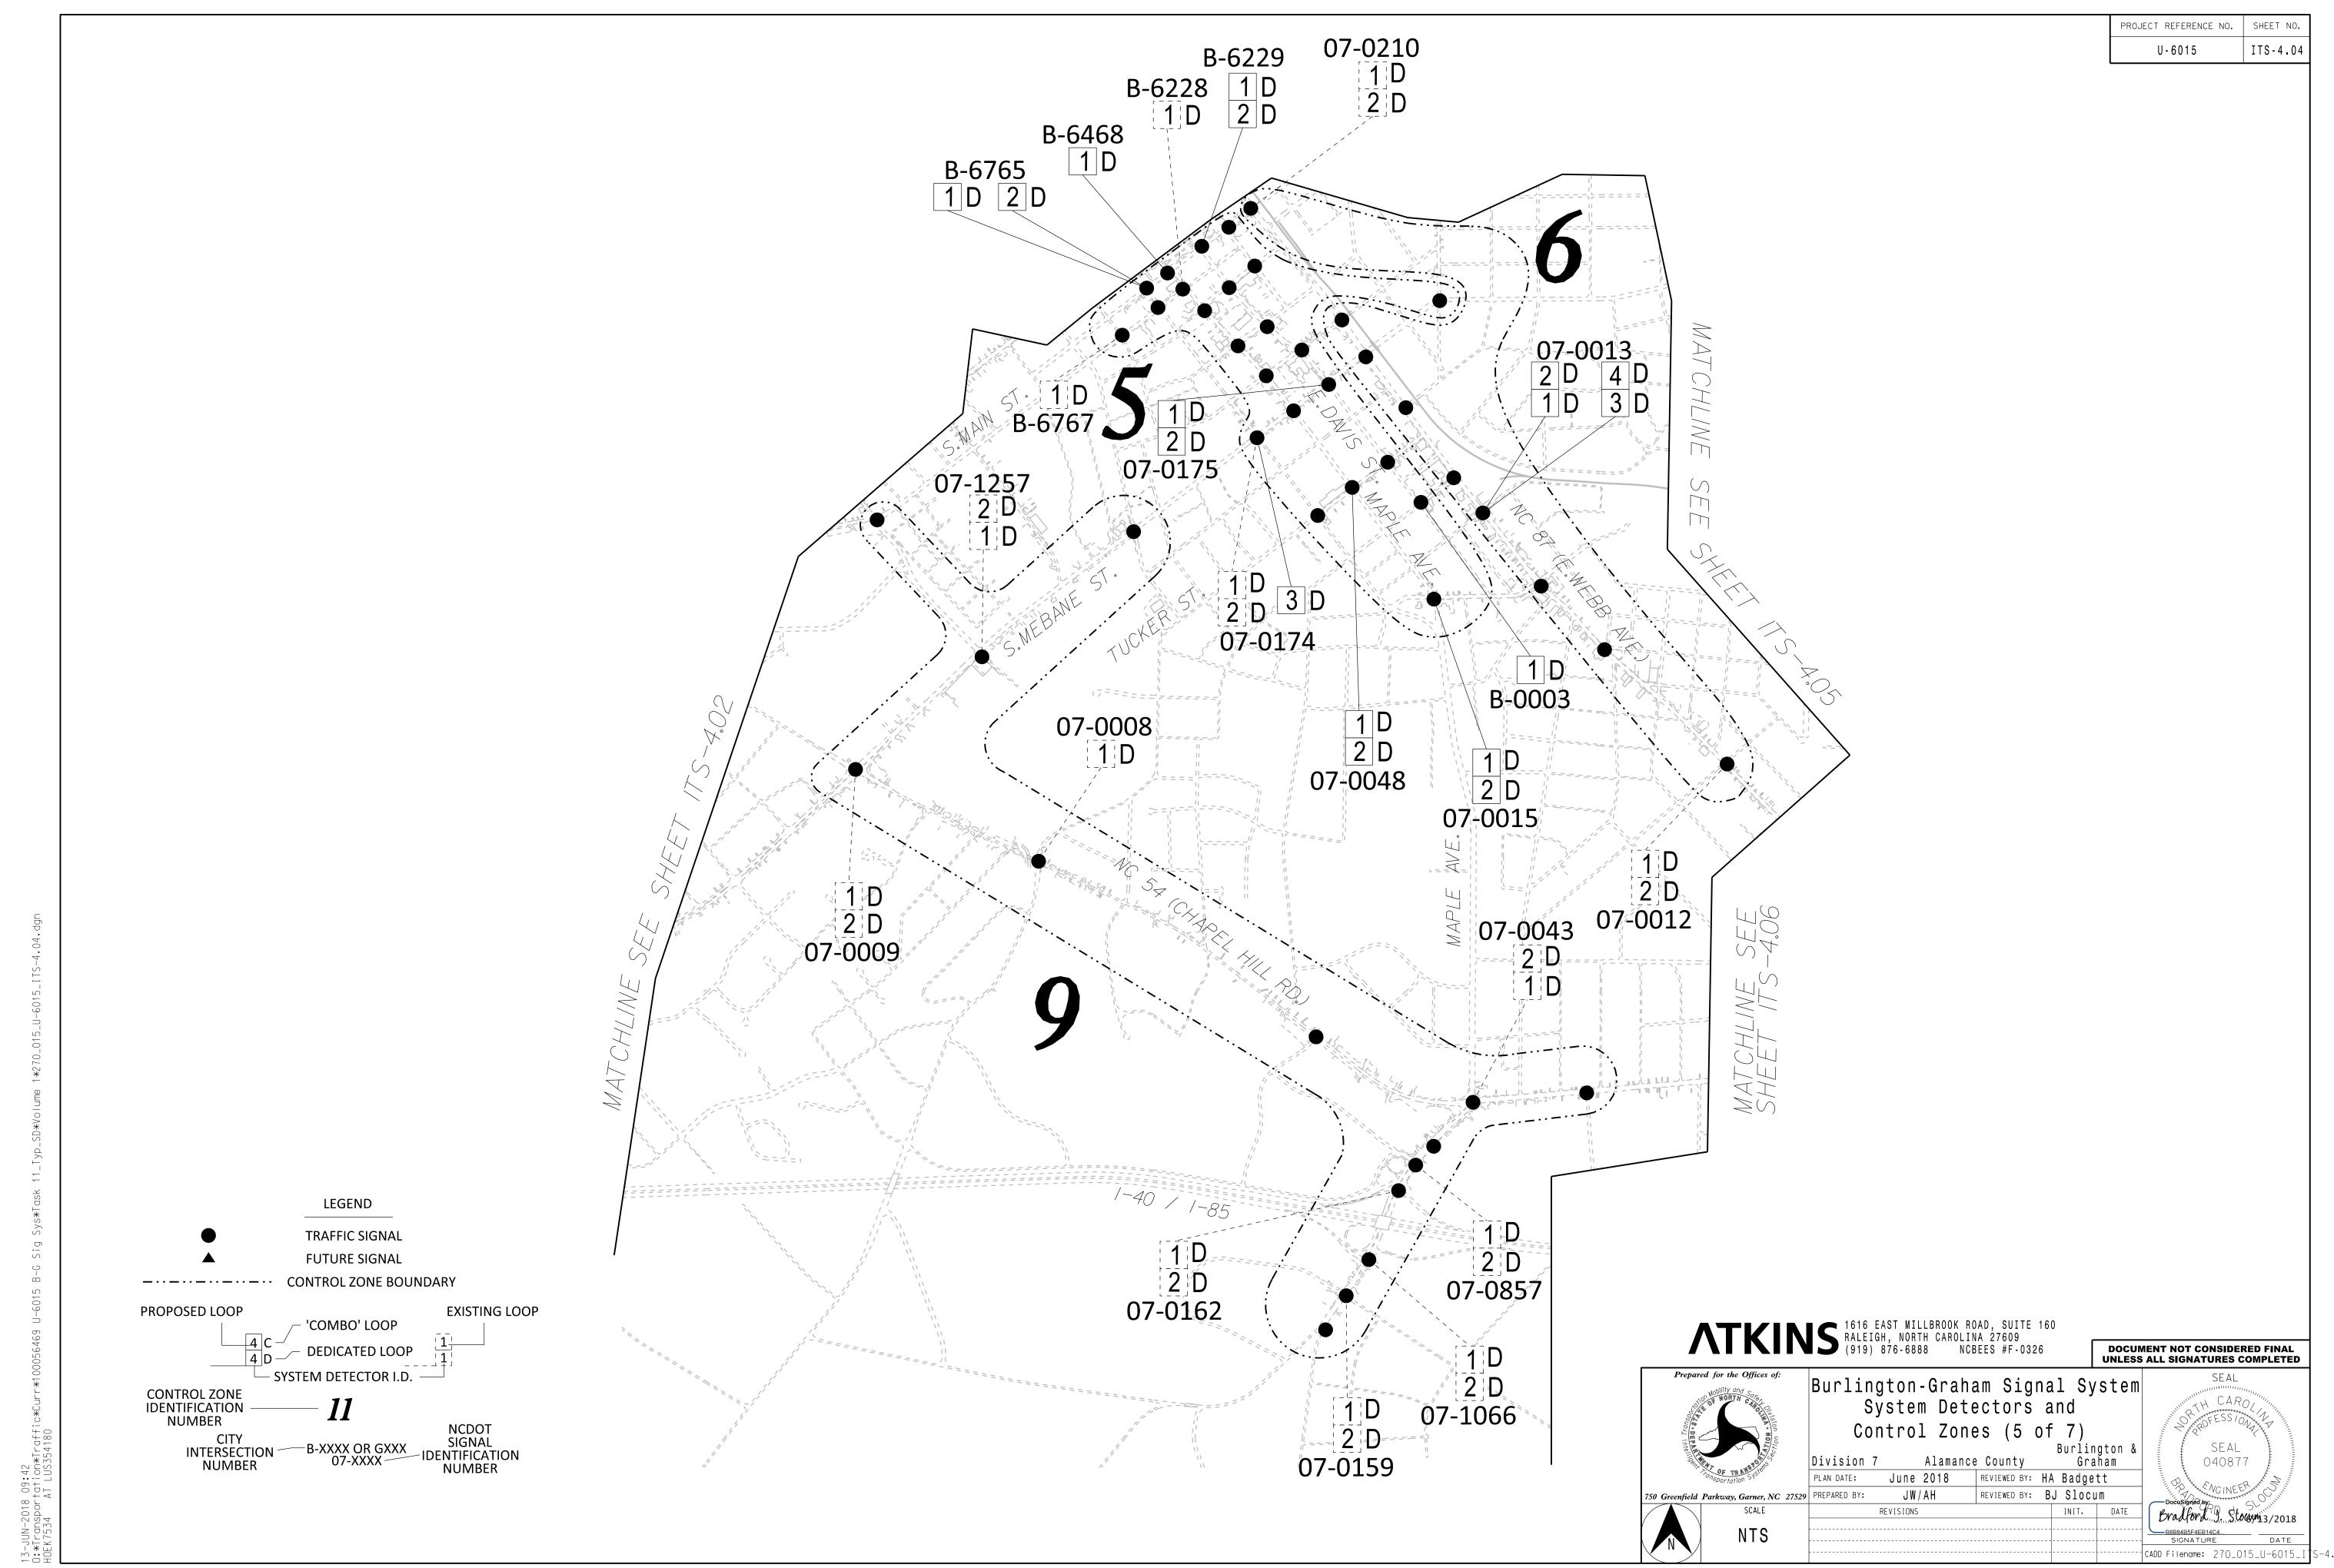

ATKINS 1616 EAST MILLBROOK ROAD, SUITE 160 RALEIGH, NORTH CAROLINA 27609 (919) 876-6888 NCBEES #F-0326

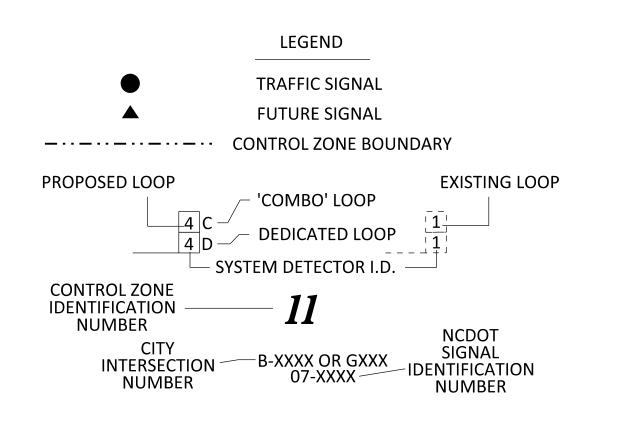Burlington-Graham Signal System
System Detectors and
Control Zones (6 of 7)

Division 7 Alamance County Graham

PLAN DATE: June 2018 REVIEWED BY: HA Badgett

750 Greenfield Parkway, Garner, NC 27529 PREPARED BY: JW/AH REVIEWED BY: BJ Slocum

REVISIONS INIT. DATE

Alamance County Graham

ne 2018 REVIEWED BY: HA Badgett

JW/AH REVIEWED BY: BJ Slocum

ONS INIT. DATE

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SIGNATURE DATE

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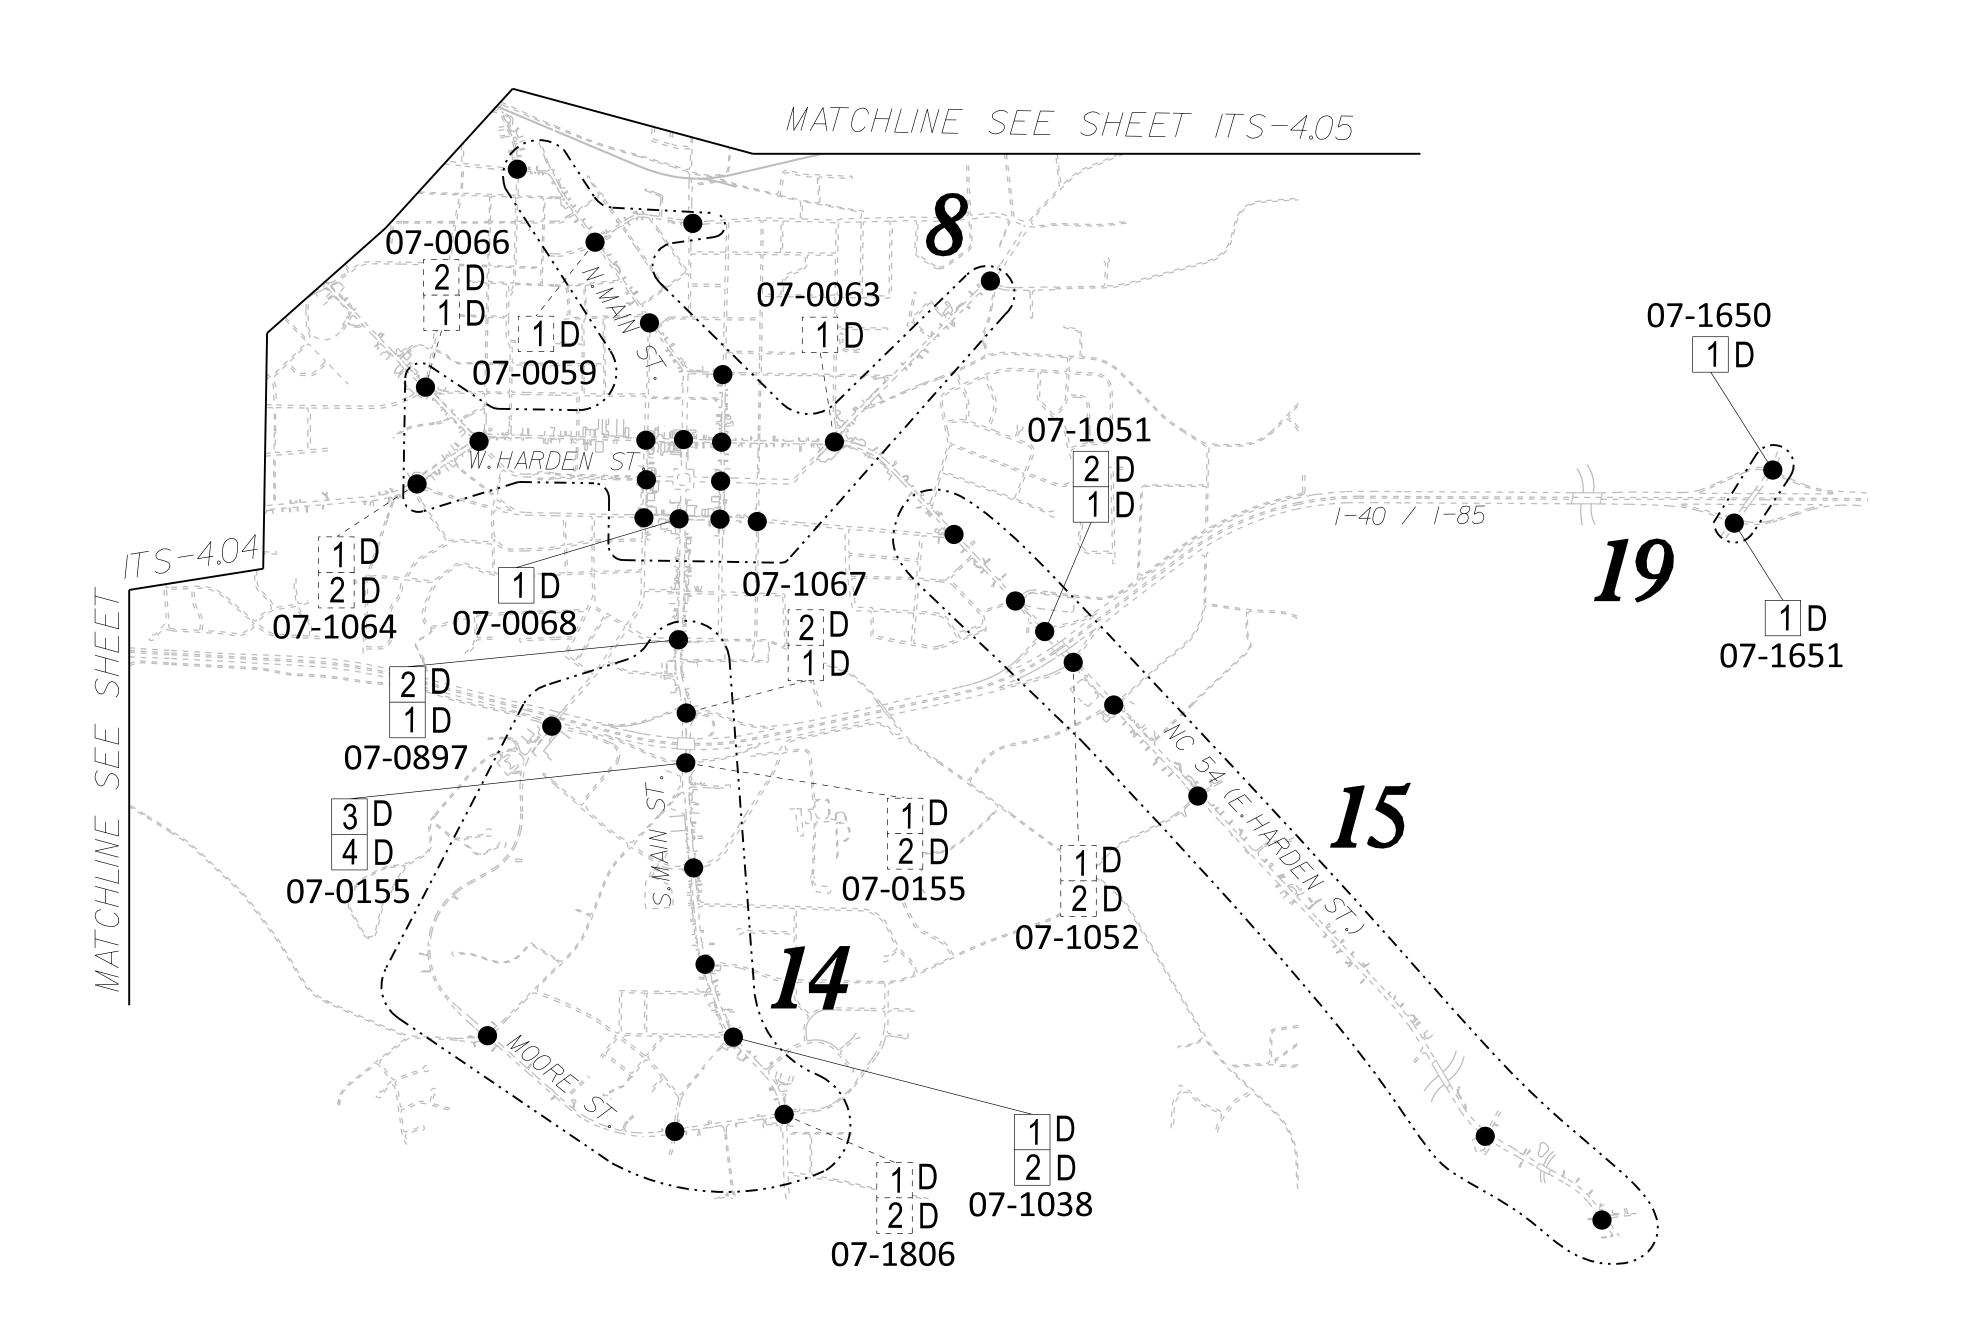
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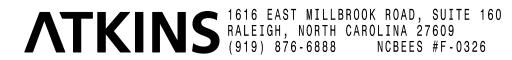
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PROJECT REFERENCE NO. SHEET NO.

U-6015 ITS-4.06





REVISIONS

ngton-Graham Signal System

DOCUMENT NOT CONSIDERED FINAL UNLESS ALL SIGNATURES COMPLETED

SEAL



Burlington-Graham Signal System
System Detectors and
Control Zones (7 of 7)

	Division 7	Alamance	c County	Burĺington & Graham	
	PLAN DATE:	June 2018	REVIEWED BY:	HA Badgett	
29	PREPARED BY:	JW/AH	REVIEWED BY:	BJ Slocum	٦

REVIEWED BY: HA Badgett
REVIEWED BY: BJ Slocum


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SIGNATURE DATE

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CADD Filename: 270\_030\_U-6015\_I S-5.(

10 FOOT RADIUS EACH "SPHERE OF INFLUENCE"

(TYPICAL)

GROUND ROD PLACEMENT DETAIL

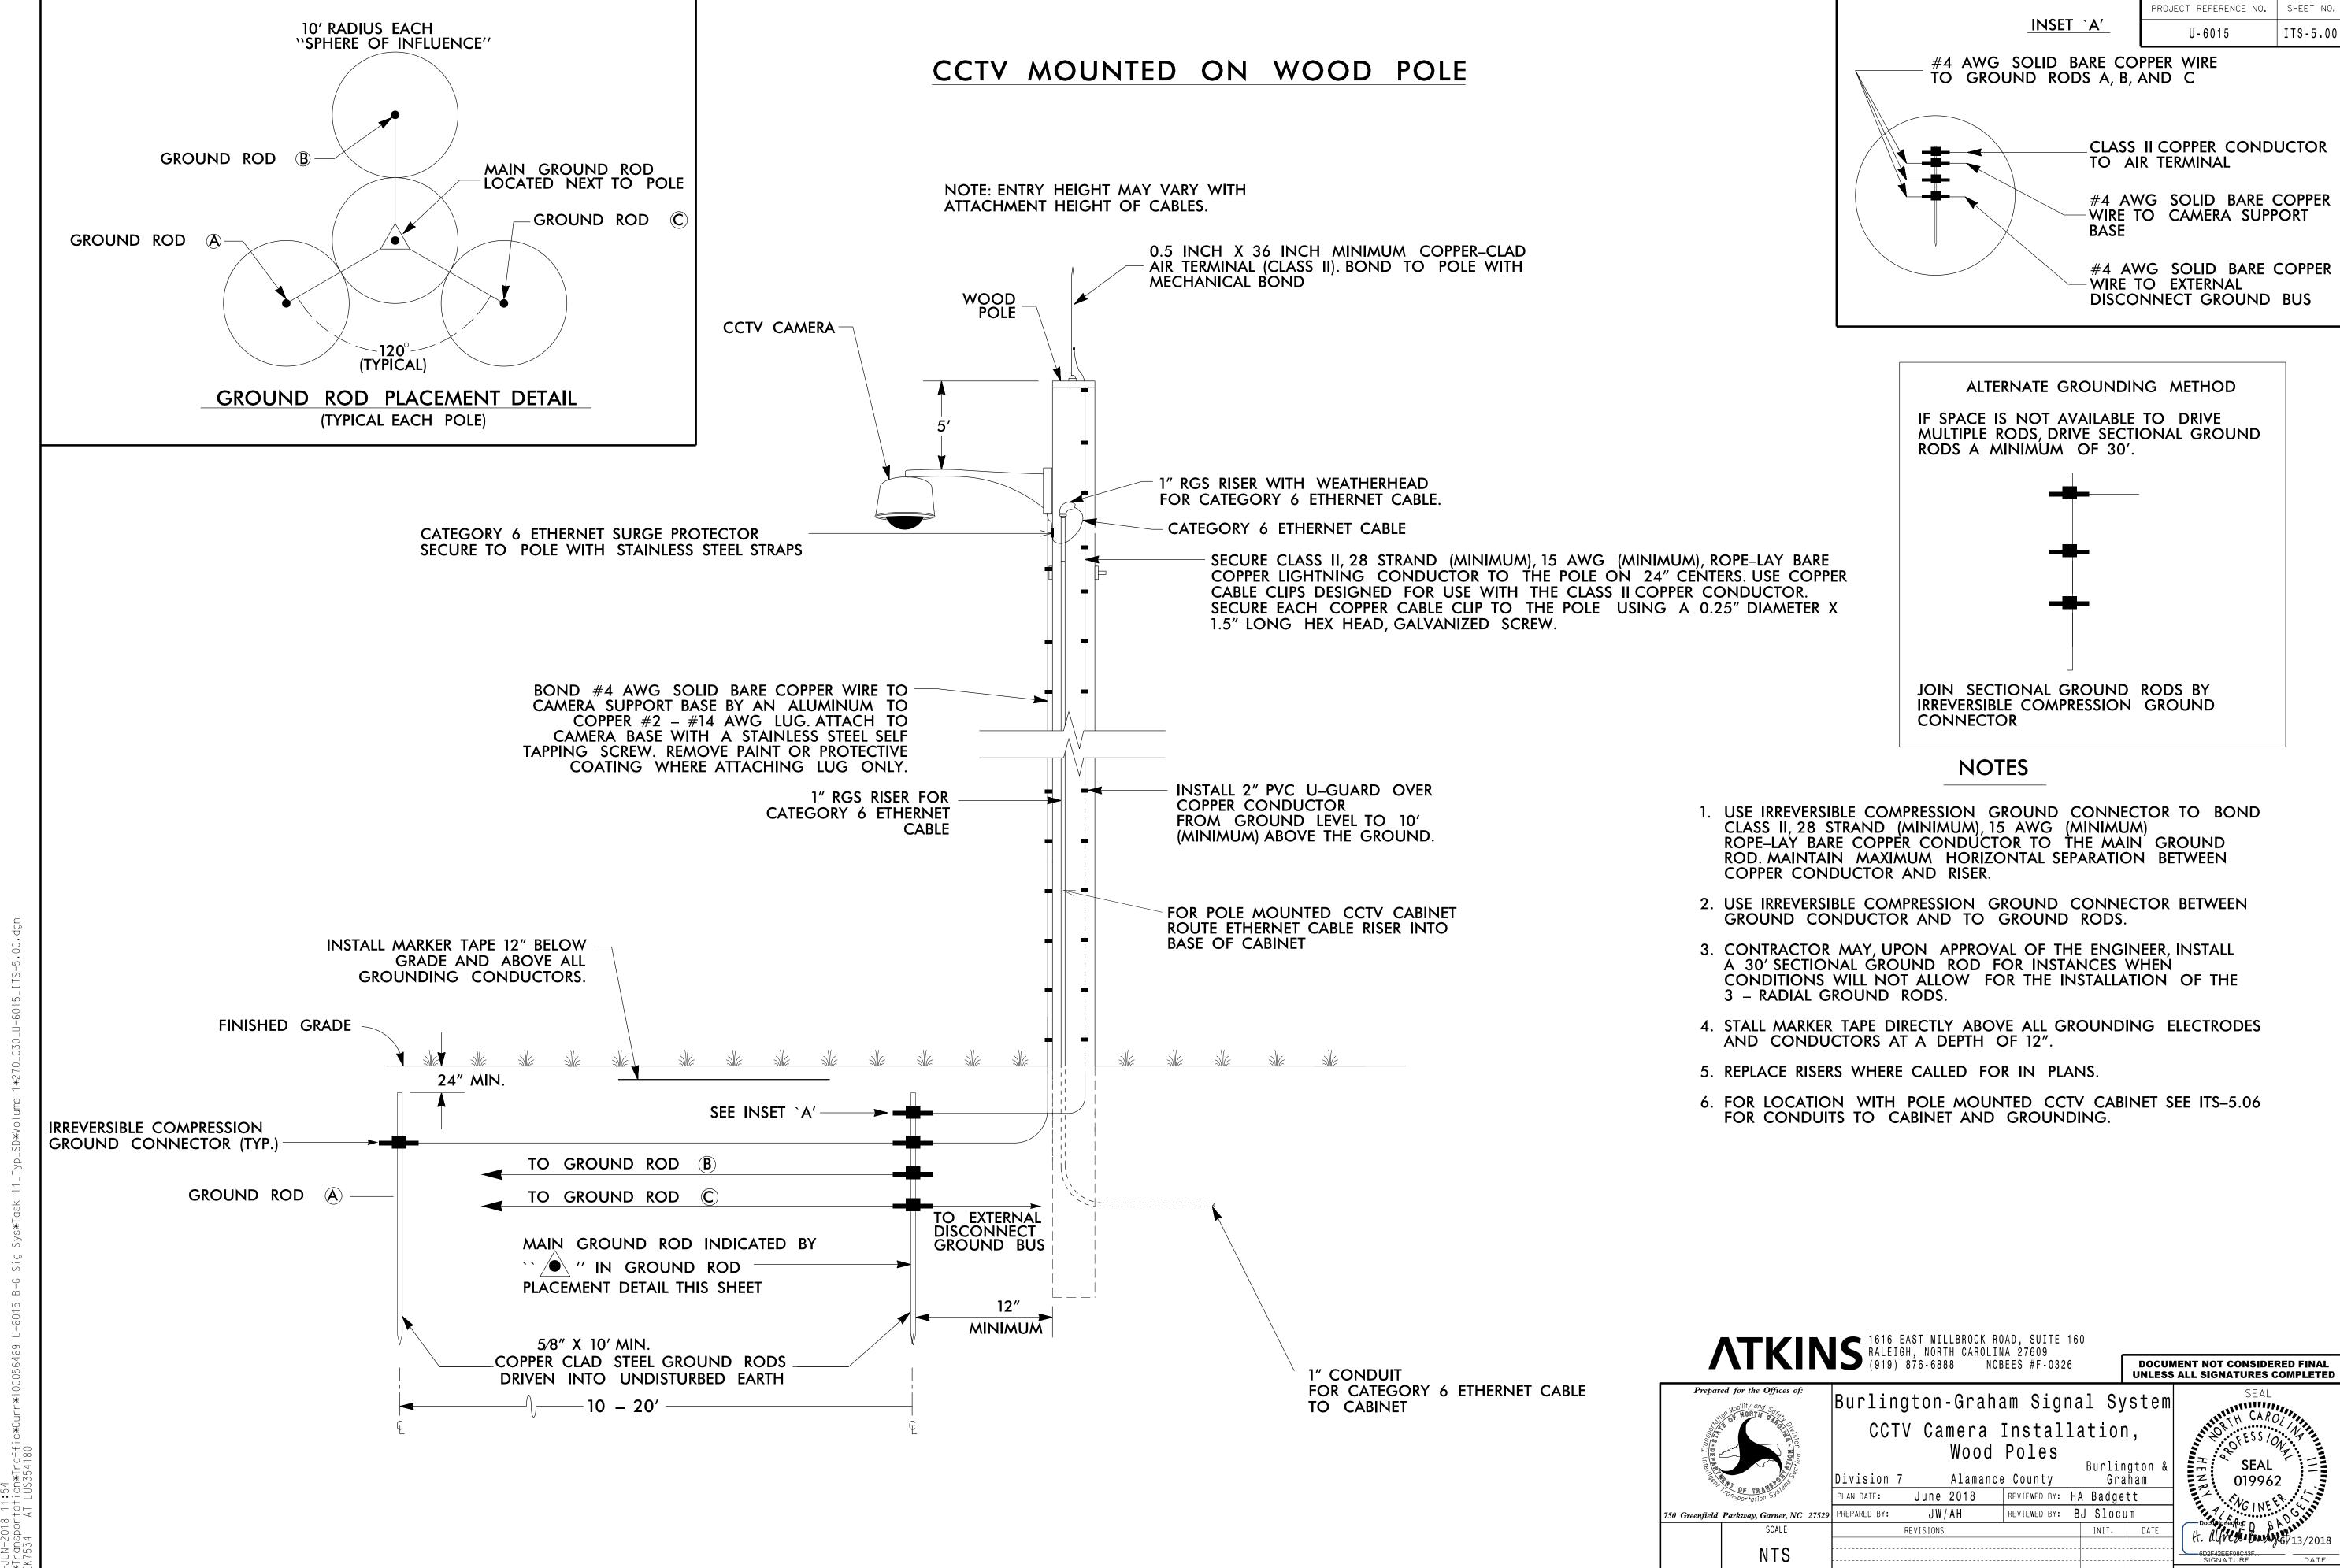BASE OF POLE

(TYPICAL EACH POLE)

0.5 INCH DIAMETER CLASS II COPPER CONDUCTOR TO

INSET `A'

INSTALL MARKER TAPE

CONDUCTORS.

GROUND ROD (A)

12 INCHES BELOW GRADE

AND ABOVE ALL GROUNDING

24 INCH MIN.

MAIN GROUND ROD

LOCATED NEXT TO POLE

-GROUND ROD (C)

GROUND BUS

SEE INSET A

TO GROUND ROD (B)

TO GROUND ROD (C)

5/8 INCH X 10 FOOT MIN.

COPPER CLAD STEEL GROUND RODS

DRIVEN INTO UNDISTURBED EARTH

\_\_\_\_ 10 - 20 FEET-

MAIN GROUND ROD INDICATED BY

● IN GROUND ROD

PLACEMENT DETAIL THIS SHEET

TO

**EXTERNAL** 

DISCONNECT GROUND BUS

- 12" MIN. —

GROUND ROD (B)

GROUND ROD A

#4 AWG SOLID BARE -

GROUND RODS A, B, AND C

FINISHED GRADE -

IRREVERSIBLE COMPRESSION

GROUND CONNECTOR (TYP.)

COPPER WIRE TO

ITS-5.01 U-6015

#### CCTV MOUNTED ON METAL POLE, POLE MOUNT CCTV CABINET


2 2-INCH PVC


CAP END OF

CONDUITS WITH

SWEEPING ELBOW,


UNUSED CONDUITS

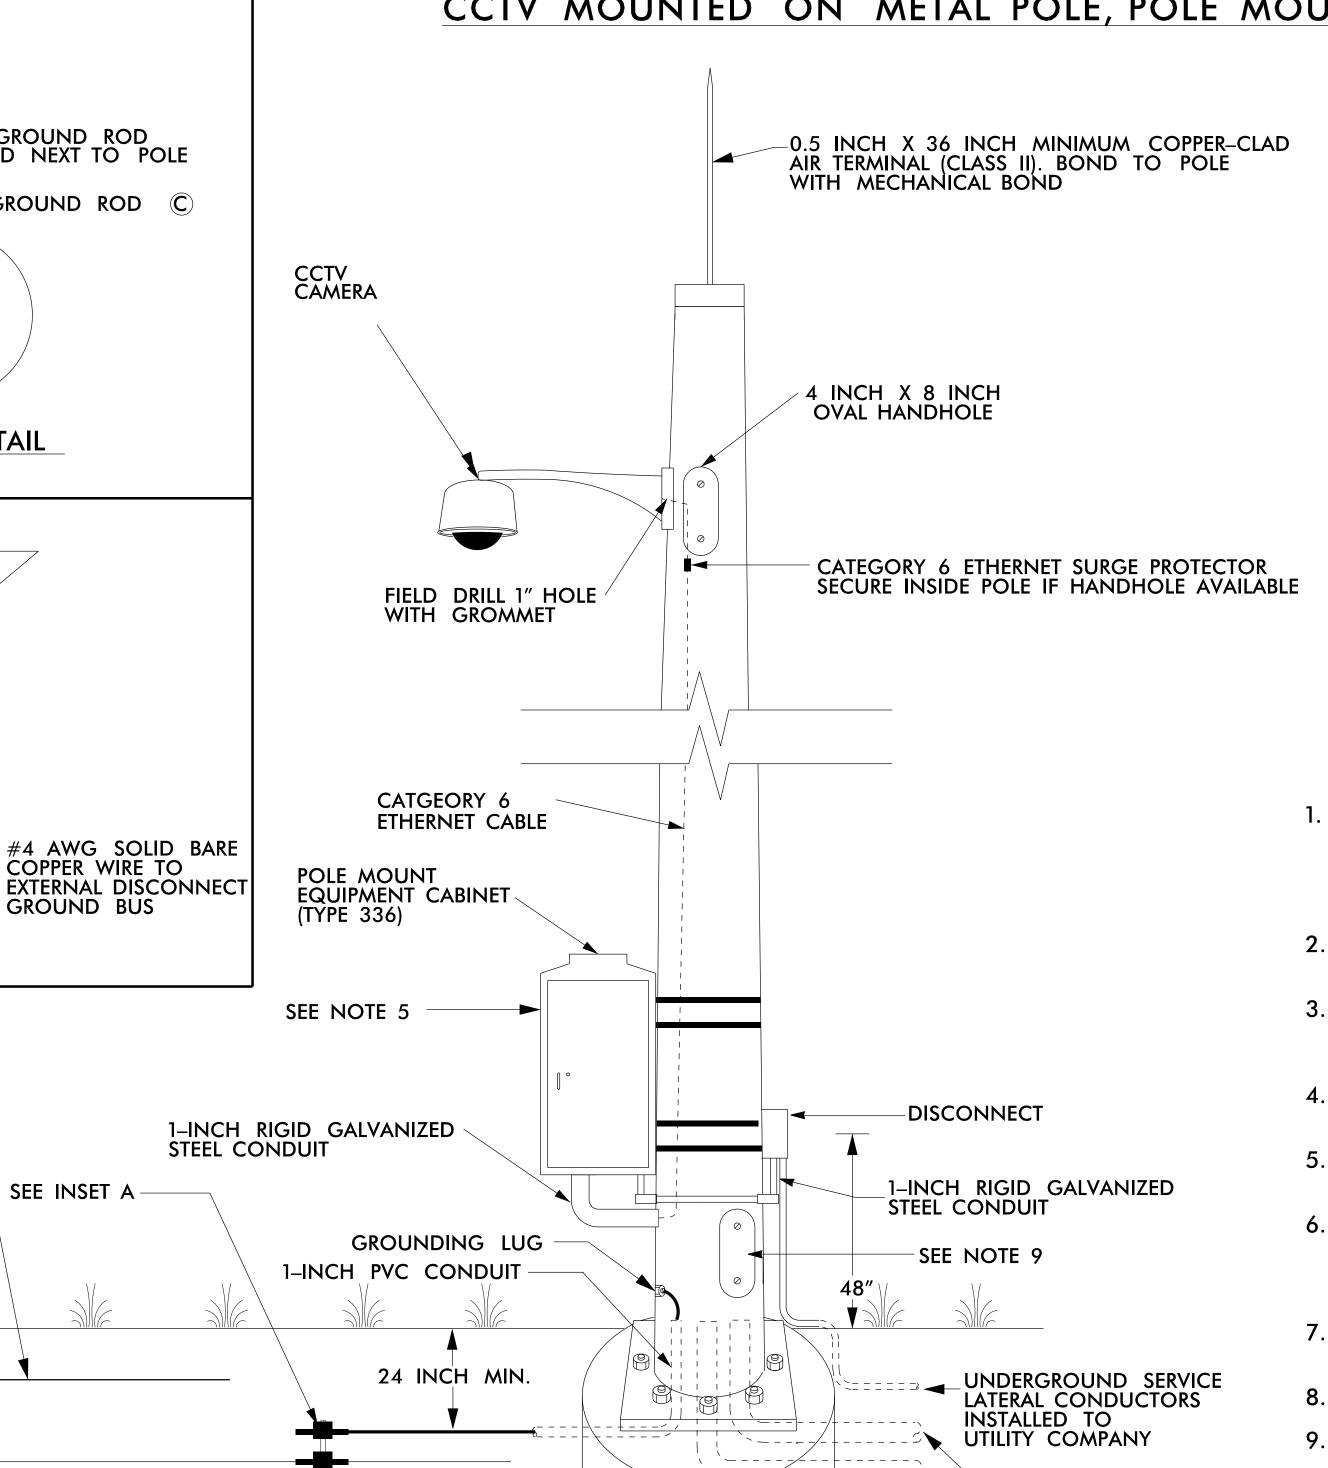

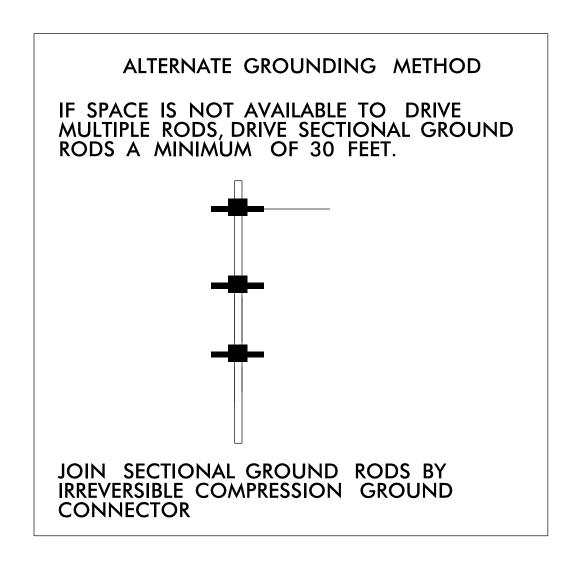

#### NOTES

- . USE IRREVERSIBLE COMPRESSION GROUND CONNECTOR TO BOND CLASS II, 28 STRAND (MINIMUM), 15 AWG (MINIMUM)
  ROPE-LAY BARE COPPER CONDUCTOR TO THE MAIN GROUND ROD. MAINTAIN MAXIMUM HORIZONTAL SEPARATION BETWEEN COPPER CONDUCTOR AND RISER.
- 2. USE IRREVERSIBLE COMPRESSION GROUND CONNECTOR BETWEEN GROUND CONDUCTOR AND TO GROUND RODS.
- 3. BOND #4 AWG SOLID BARE COPPER WIRE TO REBAR CAGE AND THE MAIN GROUND ROD BY AN IRREVERSIBLE COMPRESSION GROUND CONNECTOR.
- 4. ENSURE CAMERA HOUSING, CAMERA, AND PAN-TILT UNIT ARE BONDED TO POLE.
- 5. REMOVE BONDING JUMPER BETWEEN EQUIPMENT CABINET GROUND BUS AND NEUTRAL BUS.
- 6. THE CONTRACTOR MAY, UPON APPROVAL OF THE ENGINEER, INSTALL A 30-FOOT SECTIONAL GROUND ROD WHEN CONDITIONS WILL NOT ALLOW FOR THE INSTALLATION OF THE 3 - RADIAL GROUND RODS.
- 7. INSTALL MARKER TAPE DIRECTLY ABOVE ALL GROUNDING ELECTRODES AND CONDUCTORS AT A DEPTH OF 12 INCHES.
- 8. MOUNT DISCONNECT ON OPPOSITE SIDE OF POLE FROM CABINET.
- 9. FOR CCTV/SIGNAL POLES USE 8" X 27" TERMINAL COMPARTMENT FOR DEDICATED CCTV POLES USE 4" X 8" HANDHOLE.

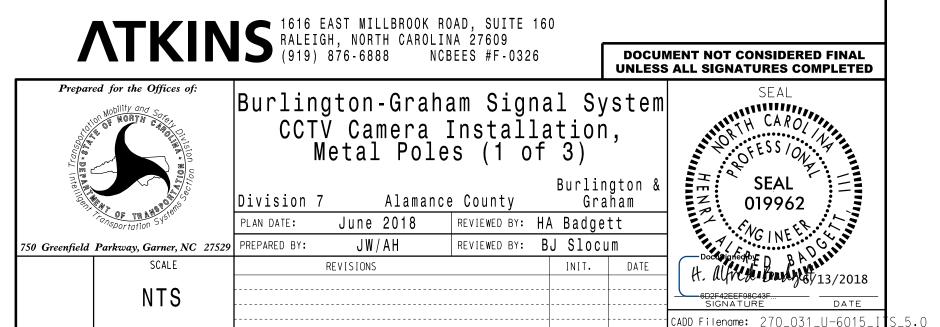

10 FOOT RADIUS EACH "SPHERE OF INFLUENCE"

INSET `A'

INSTALL MARKER TAPE

CONDUCTORS.

GROUND ROD (A)

FINISHED GRADE -

IRREVERSIBLE COMPRESSION

GROUND CONNECTOR (TYP.)

12 INCHES BELOW GRADE

AND ABOVE ALL GROUNDING

24 INCH MIN.

ITS-5.02 U-6015

#### CCTV MOUNTED ON METAL POLE GROUND MOUNT SHARED CABINET

SEE NOTE 5

**INSTALL BASE** 

2 2-INCH PVC

CAP END OF

CONDUITS WITH

SWEEPING ELBOW,

UNUSED CONDUITS

``====

**EXTENDER** 


CABINET

**FOUNDATION** 

1-INCH RIGID

STEEL CONDUIT

GALVANIZED

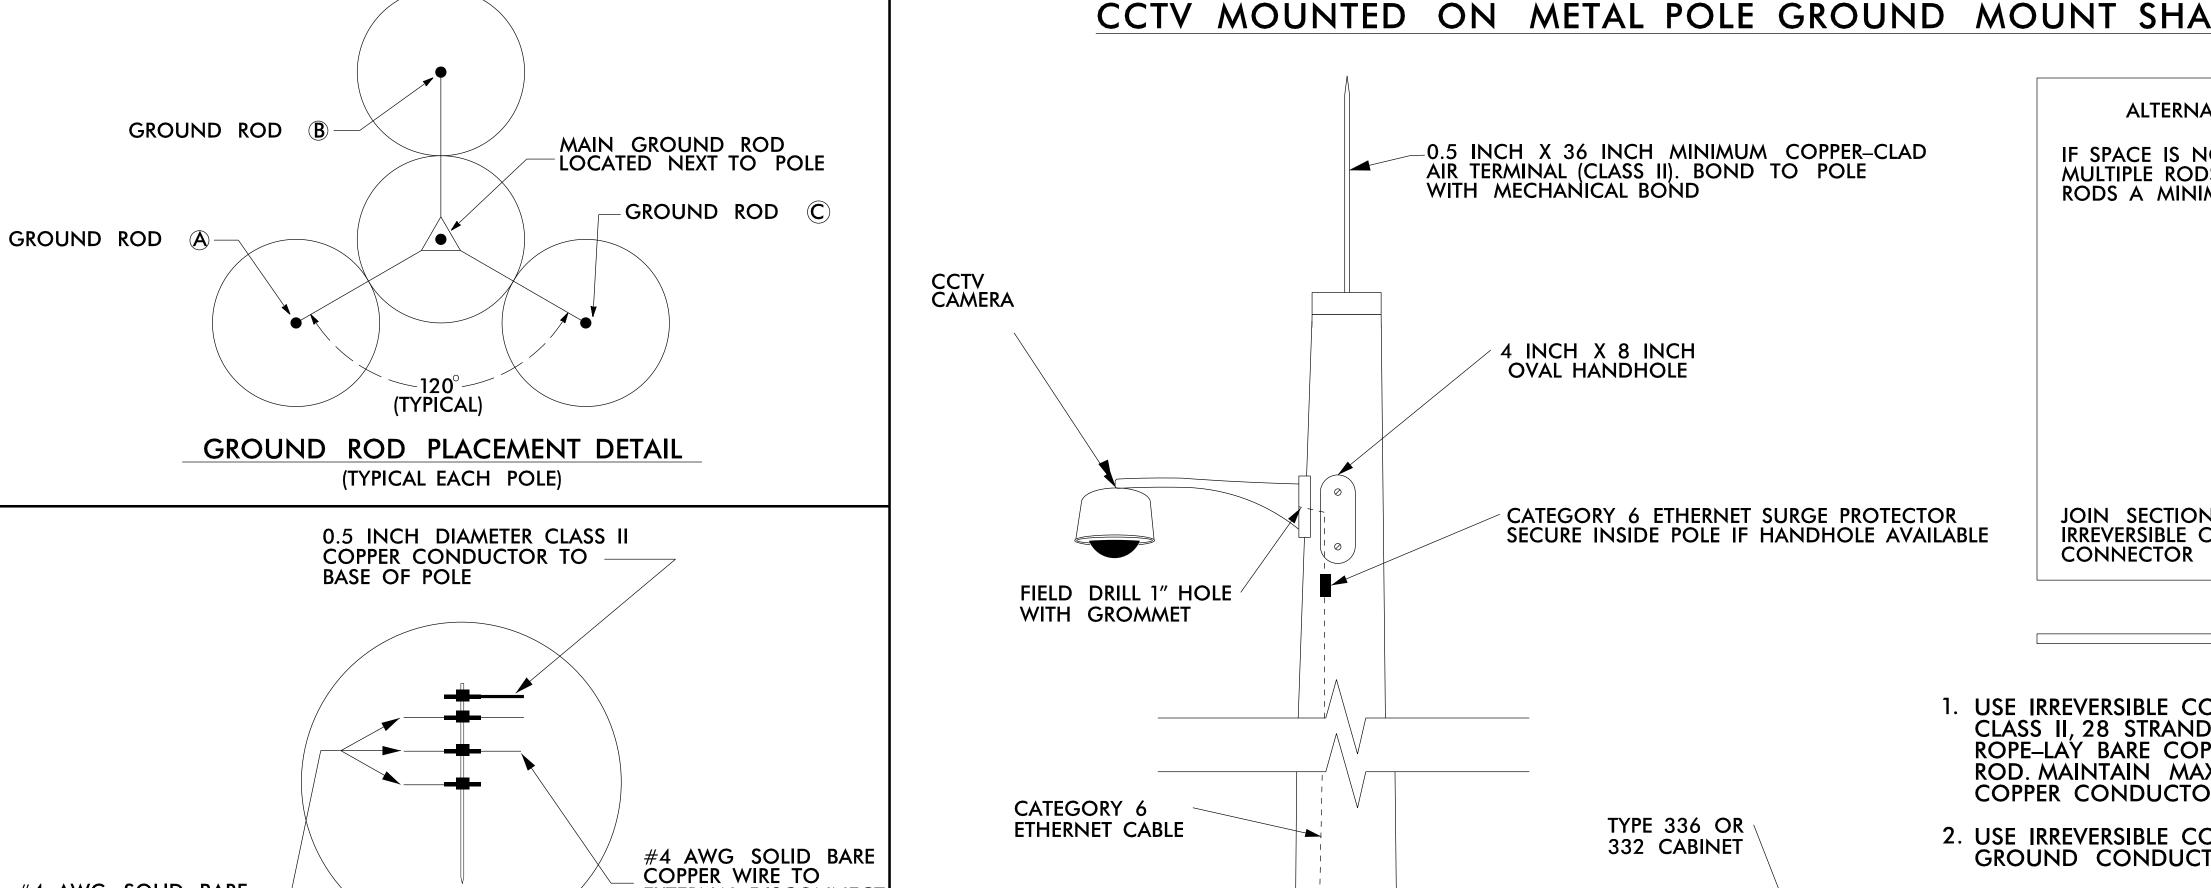

SEE NOTE 9

GROUNDING LUG

TO

**EXTERNAL** 

DISCONNECT

GROUND BUS

- 12" MIN. —

1-INCH PVC

CONDUIT

24" MIN.

**EXTERNAL DISCONNECT** 

GROUND BUS

SEE INSET A

TO GROUND ROD (B)

TO GROUND ROD (C)

5/8 INCH X 10 FOOT MIN.

COPPER CLAD STEEL GROUND RODS


DRIVEN INTO UNDISTURBED EARTH

— 10 – 20 FEET-

MAIN GROUND ROD INDICATED BY


✓ IN GROUND ROD

PLACEMENT DETAIL THIS SHEET

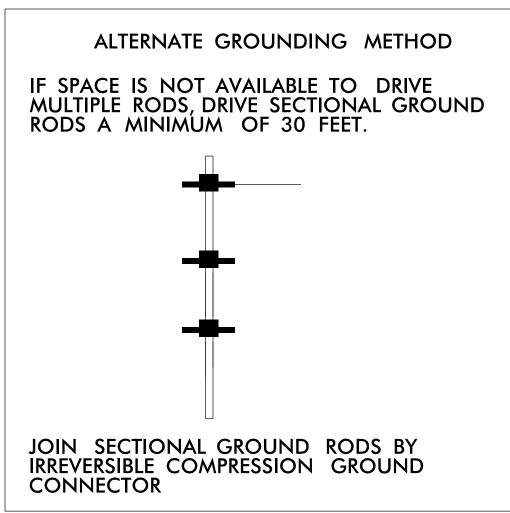

#### NOTES

- . USE IRREVERSIBLE COMPRESSION GROUND CONNECTOR TO BOND CLASS II, 28 STRAND (MINIMUM), 15 AWG (MINIMUM)
  ROPE-LAY BARE COPPER CONDUCTOR TO THE MAIN GROUND ROD. MAINTAIN MAXIMUM HORIZONTAL SEPARATION BETWEEN COPPER CONDUCTOR AND RISER.
- 2. USE IRREVERSIBLE COMPRESSION GROUND CONNECTOR BETWEEN GROUND CONDUCTOR AND TO GROUND RODS.
- 3. BOND #4 AWG SOLID BARE COPPER WIRE TO REBAR CAGE AND THE MAIN GROUND ROD BY AN IRREVERSIBLE COMPRESSION GROUND CONNECTOR.
- 4. ENSURE CAMERA HOUSING, CAMERA, AND PAN-TILT UNIT ARE BONDED TO POLE.
- 5. REMOVE BONDING JUMPER BETWEEN EQUIPMENT CABINET
- 6. THE CONTRACTOR MAY, UPON APPROVAL OF THE ENGINEER, INSTALL A 30-FOOT SECTIONAL GROUND ROD WHEN CONDITIONS WILL NOT ALLOW FOR THE INSTALLATION OF THE 3 - RADIAL GROUND RODS.
- 7. INSTALL MARKER TAPE DIRECTLY ABOVE ALL GROUNDING ELECTRODES AND CONDUCTORS AT A DEPTH OF 12 INCHES.
- 8. FOR EXISTING BASE MOUNTED CCTV CABINETS, INSTALL BASE EXTENDER UNDER NEW CABINET.
- 9. FOR CCTV/SIGNAL POLES USE 8" X 27" TERMINAL COMPARTMENT FOR DEDICATED CCTV POLES USE 4" X 8" HANDHOLE.

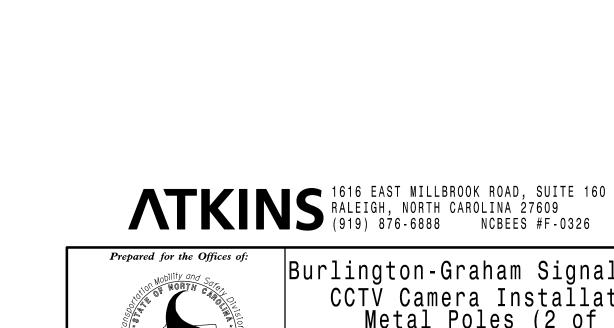

|Burlington-Graham Signal System| CCTV Camera Installation, Metal Poles (2 of 3)

DOCUMENT NOT CONSIDERED FINAL

**UNLESS ALL SIGNATURES COMPLETED** 

Burlington & Division 7 Alamance County Graham June 2018 REVIEWED BY: HA Badgett JW/AH REVIEWED BY: BJ Slocum 50 Greenfield Parkway, Garner, NC 275 REVISIONS INIT. DATE NTS CADD Filename: 270\_031\_U-6015

#4 AWG SOLID BARE -COPPER WIRE TO GROUND RODS A, B, AND C 10 FOOT RADIUS EACH "SPHERE OF INFLUENCE"

(TYPICAL)

GROUND ROD PLACEMENT DETAIL

BASE OF POLE

(TYPICAL EACH POLE)

0.5 INCH DIAMETER CLASS II COPPER CONDUCTOR TO

INSET `A'

INSTALL MARKER TAPE

CONDUCTORS.

GROUND ROD (A)

12 INCHES BELOW GRADE

AND ABOVE ALL GROUNDING

24 INCH MIN.

SEE INSET A

TO GROUND ROD (B)

TO GROUND ROD (C)

5/8 INCH X 10 FOOT MIN.

COPPER CLAD STEEL GROUND RODS

DRIVEN INTO UNDISTURBED EARTH

— 10 – 20 FEET

MAIN GROUND ROD INDICATED BY

◆ IN GROUND ROD

PLACEMENT DETAIL THIS SHEET

TO

**EXTERNAL** 

DISCONNECT

GROUND BUS

- 12" MIN. —

GROUND ROD (B)

GROUND ROD A

#4 AWG SOLID BARE -

GROUND RODS A, B, AND C

FINISHED GRADE -

IRREVERSIBLE COMPRESSION GROUND CONNECTOR (TYP.)

COPPER WIRE TO

ITS-5.03 U-6015

#### CCTV MOUNTED ON METAL POLE WITH SHARED GROUND MOUNT CABINET

2 2-INCH PVC

CAP END OF

CATEGORY 6 ETHERNET

CABLE TO CABINET


(UNDERGROUND

OPTION)

**CONDUITS WITH** 


SWEEPING ELBOW,

**UNUSED CONDUITS** 

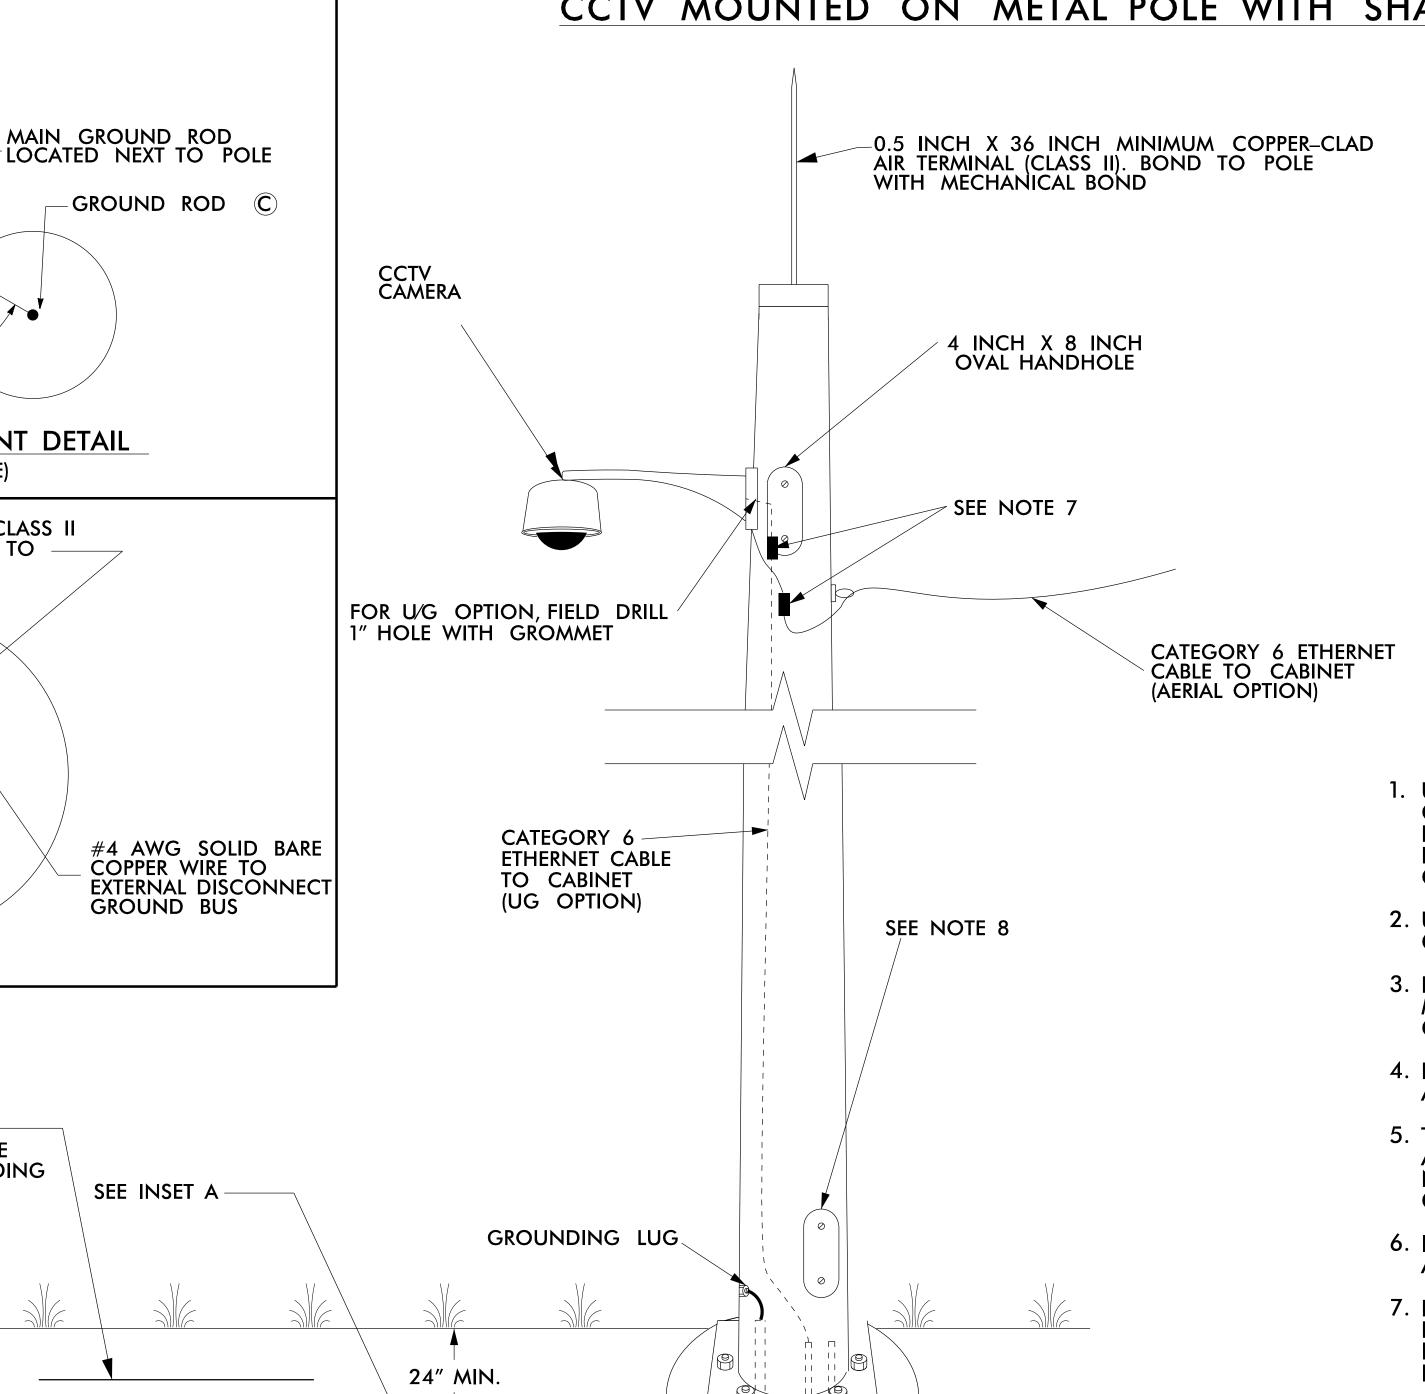


1-INCH PVC

CONDUIT

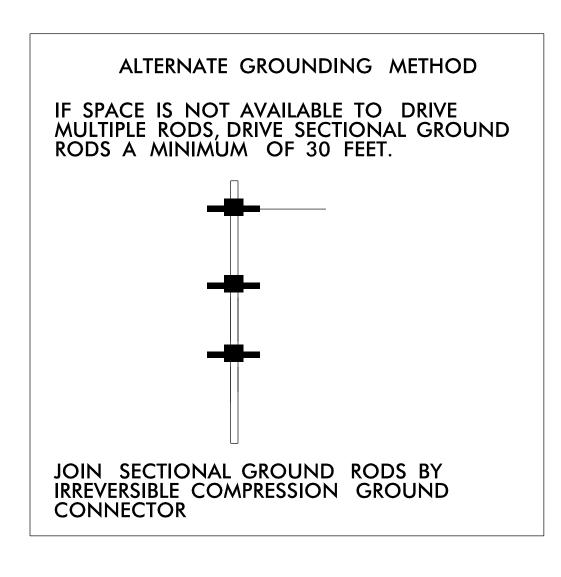


#### NOTES

- USE IRREVERSIBLE COMPRESSION GROUND CONNECTOR TO BOND CLASS II, 28 STRAND (MINIMUM), 15 AWG (MINIMUM) ROPE-LAY BARE COPPER CONDUCTOR TO THE MAIN GROUND ROD. MAINTAIN MAXIMUM HORIZONTAL SEPARATION BETWEEN COPPER CONDUCTOR AND RISER.
- 2. USE IRREVERSIBLE COMPRESSION GROUND CONNECTOR BETWEEN GROUND CONDUCTOR AND TO GROUND RODS.
- 3. BOND #4 AWG SOLID BARE COPPER WIRE TO REBAR CAGE AND THE MAIN GROUND ROD BY AN IRREVERSIBLE COMPRESSION GROUND CONNECTOR.
- 4. ENSURE CAMERA HOUSING, CAMERA, AND PAN-TILT UNIT ARE BONDED TO POLE.
- 5. THE CONTRACTOR MAY, UPON APPROVAL OF THE ENGINEER, INSTALL A 30-FOOT SECTIONAL GROUND ROD WHEN CONDITIONS WILL NOT ALLOW FOR THE INSTALLATION OF THE 3 - RADIAL GROUND RODS.
- 6. INSTALL MARKER TAPE DIRECTLY ABOVE ALL GROUNDING ELECTRODES AND CONDUCTORS AT A DEPTH OF 12 INCHES.
- 7. FOR AERIAL OPTION, INSTALL CATEGORY 6 ETHERNET CABLE SURGE PROTECTION DEVICE ON SIDE OF POLE. FOR UNDERGROUND OPTION, INSTALL CATEGORY 6 ETHERNET CABLE SURGE PROTECTION DEVICE INSIDE POLE.
- 8. FOR CCTV/SIGNAL POLES USE 8" X 27" TERMINAL COMPARTMENT FOR DEDICATED CCTV POLES USE 4" X 8" HANDHOLE.

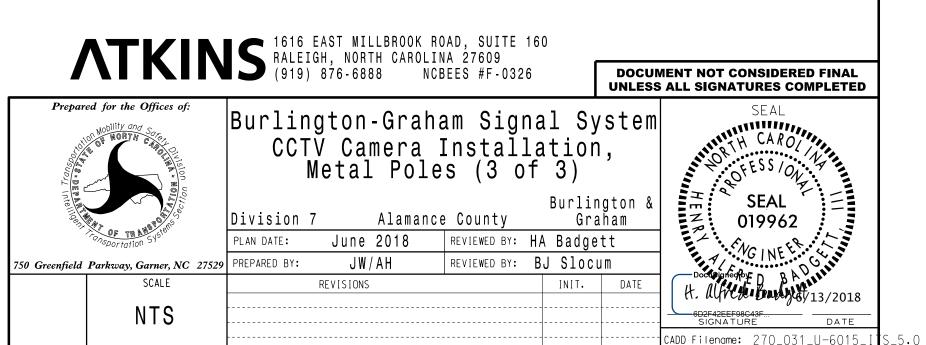



1-18 STATE OF
NORTH CAROLINA
DEPT. OF TRANSPORTATION
DIVISION OF HIGHWAYS
RALEIGH, N.C. MESSENGER CABLE\_ CONDUCTOR TO POWER GROUNDING CONNECTION SYSTEM POLE GROUND METER BASE CONNECTION LOCK NUT #8 AWG MIN #8 AWG MIN STRANDED COPPER (BLACK) STRANDED COPPER (WHITE) SERVICE DISCONNECT 120 V SINGLE POLE BREAKER - NEUTRAL BUS MAIN BONDING SCREW #8 AWG MIN \_ STRANDED COPPER (WHITE) #6 AWG MIN GREEN INSULATED TRICAL SERVICE GROUNDING
GROUNDING AND BONDING #8 AWG MIN STRANDED COPPER (BLACK) STRANDED COPPER WIRE GROUNDING/BONDING BUSHING-#4 AWG SOLID BARE - COPPER WIRE TO GROUNDING ELECTRODE LOCK NUTS -FOR JOINT USE POLES ONLY, #6 AWG MIN SOLID BARE COPPER WITH SPLIT BOLT CONNECTORS OR SYSTEM PARALLEL GROOVE CLAMPS ON EACH END (CONNECTION TO BE MADE ABOVE SPECIAL ROUTING SHOWN BELOW) WIRE STAPLES, 24" SPACING ABOVE 8 FEET AND 12" SPACING BELOW 8 FEET ABOVE GROUND (TYP) PROVIDE WIRING ROUTING AND STAPLING SO THAT STAPLES MAY BE TEMPORARILY REMOVED AND GROUNDING WIRES CAN BE PULLED MIN 1.5" OFF POLE & SPACED MAX 0.75" APART TO ENABLE TESTING OF GROUNDING ELECTRICAL SERVICE
TO CABINET ELECTRODE RESISTANCE BY CLAMP ON TESTER S Щ 5/8" DIA COPPER CLAD STEEL GROUNDING ELECTRODES, WITH П IRREVERSIBLE COMPRESSION GROUND CONNECTOR SHEET 1 OF 1 1700D01

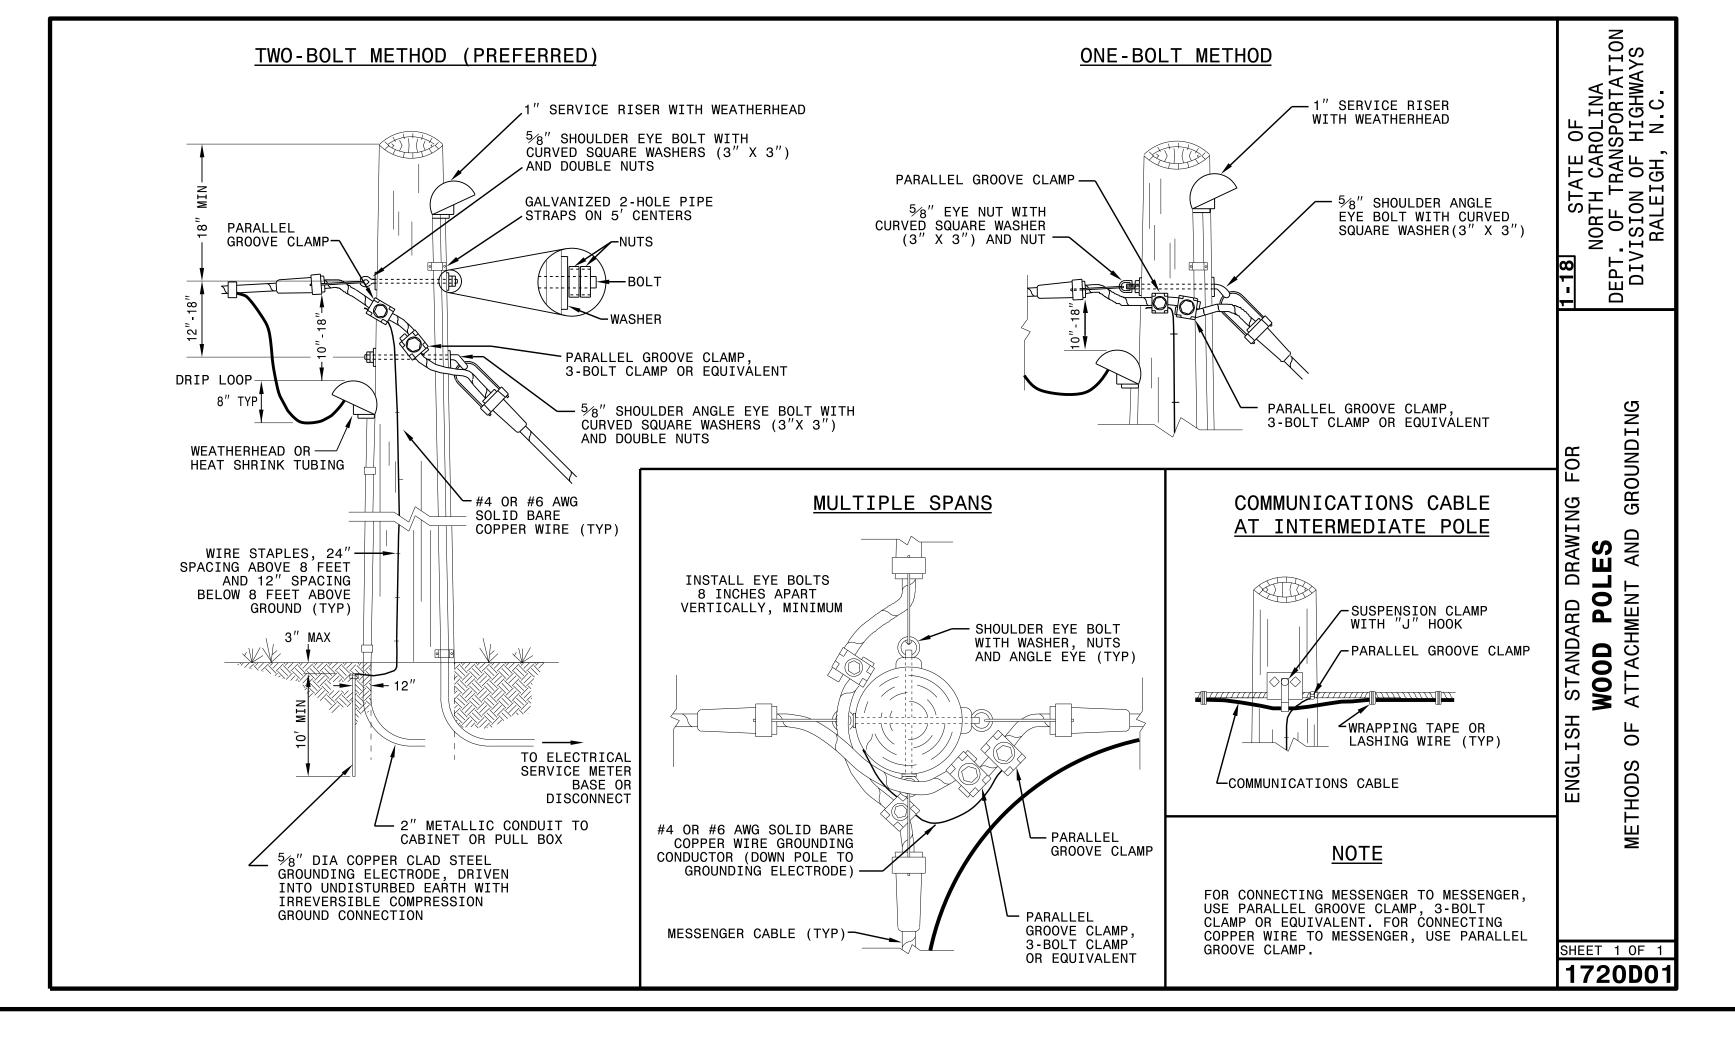

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#### See Plate for Title



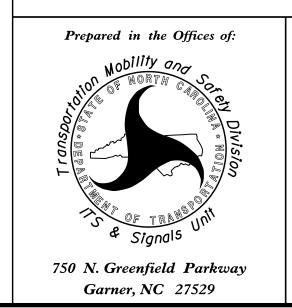

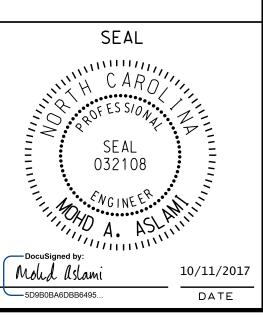
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U-6015

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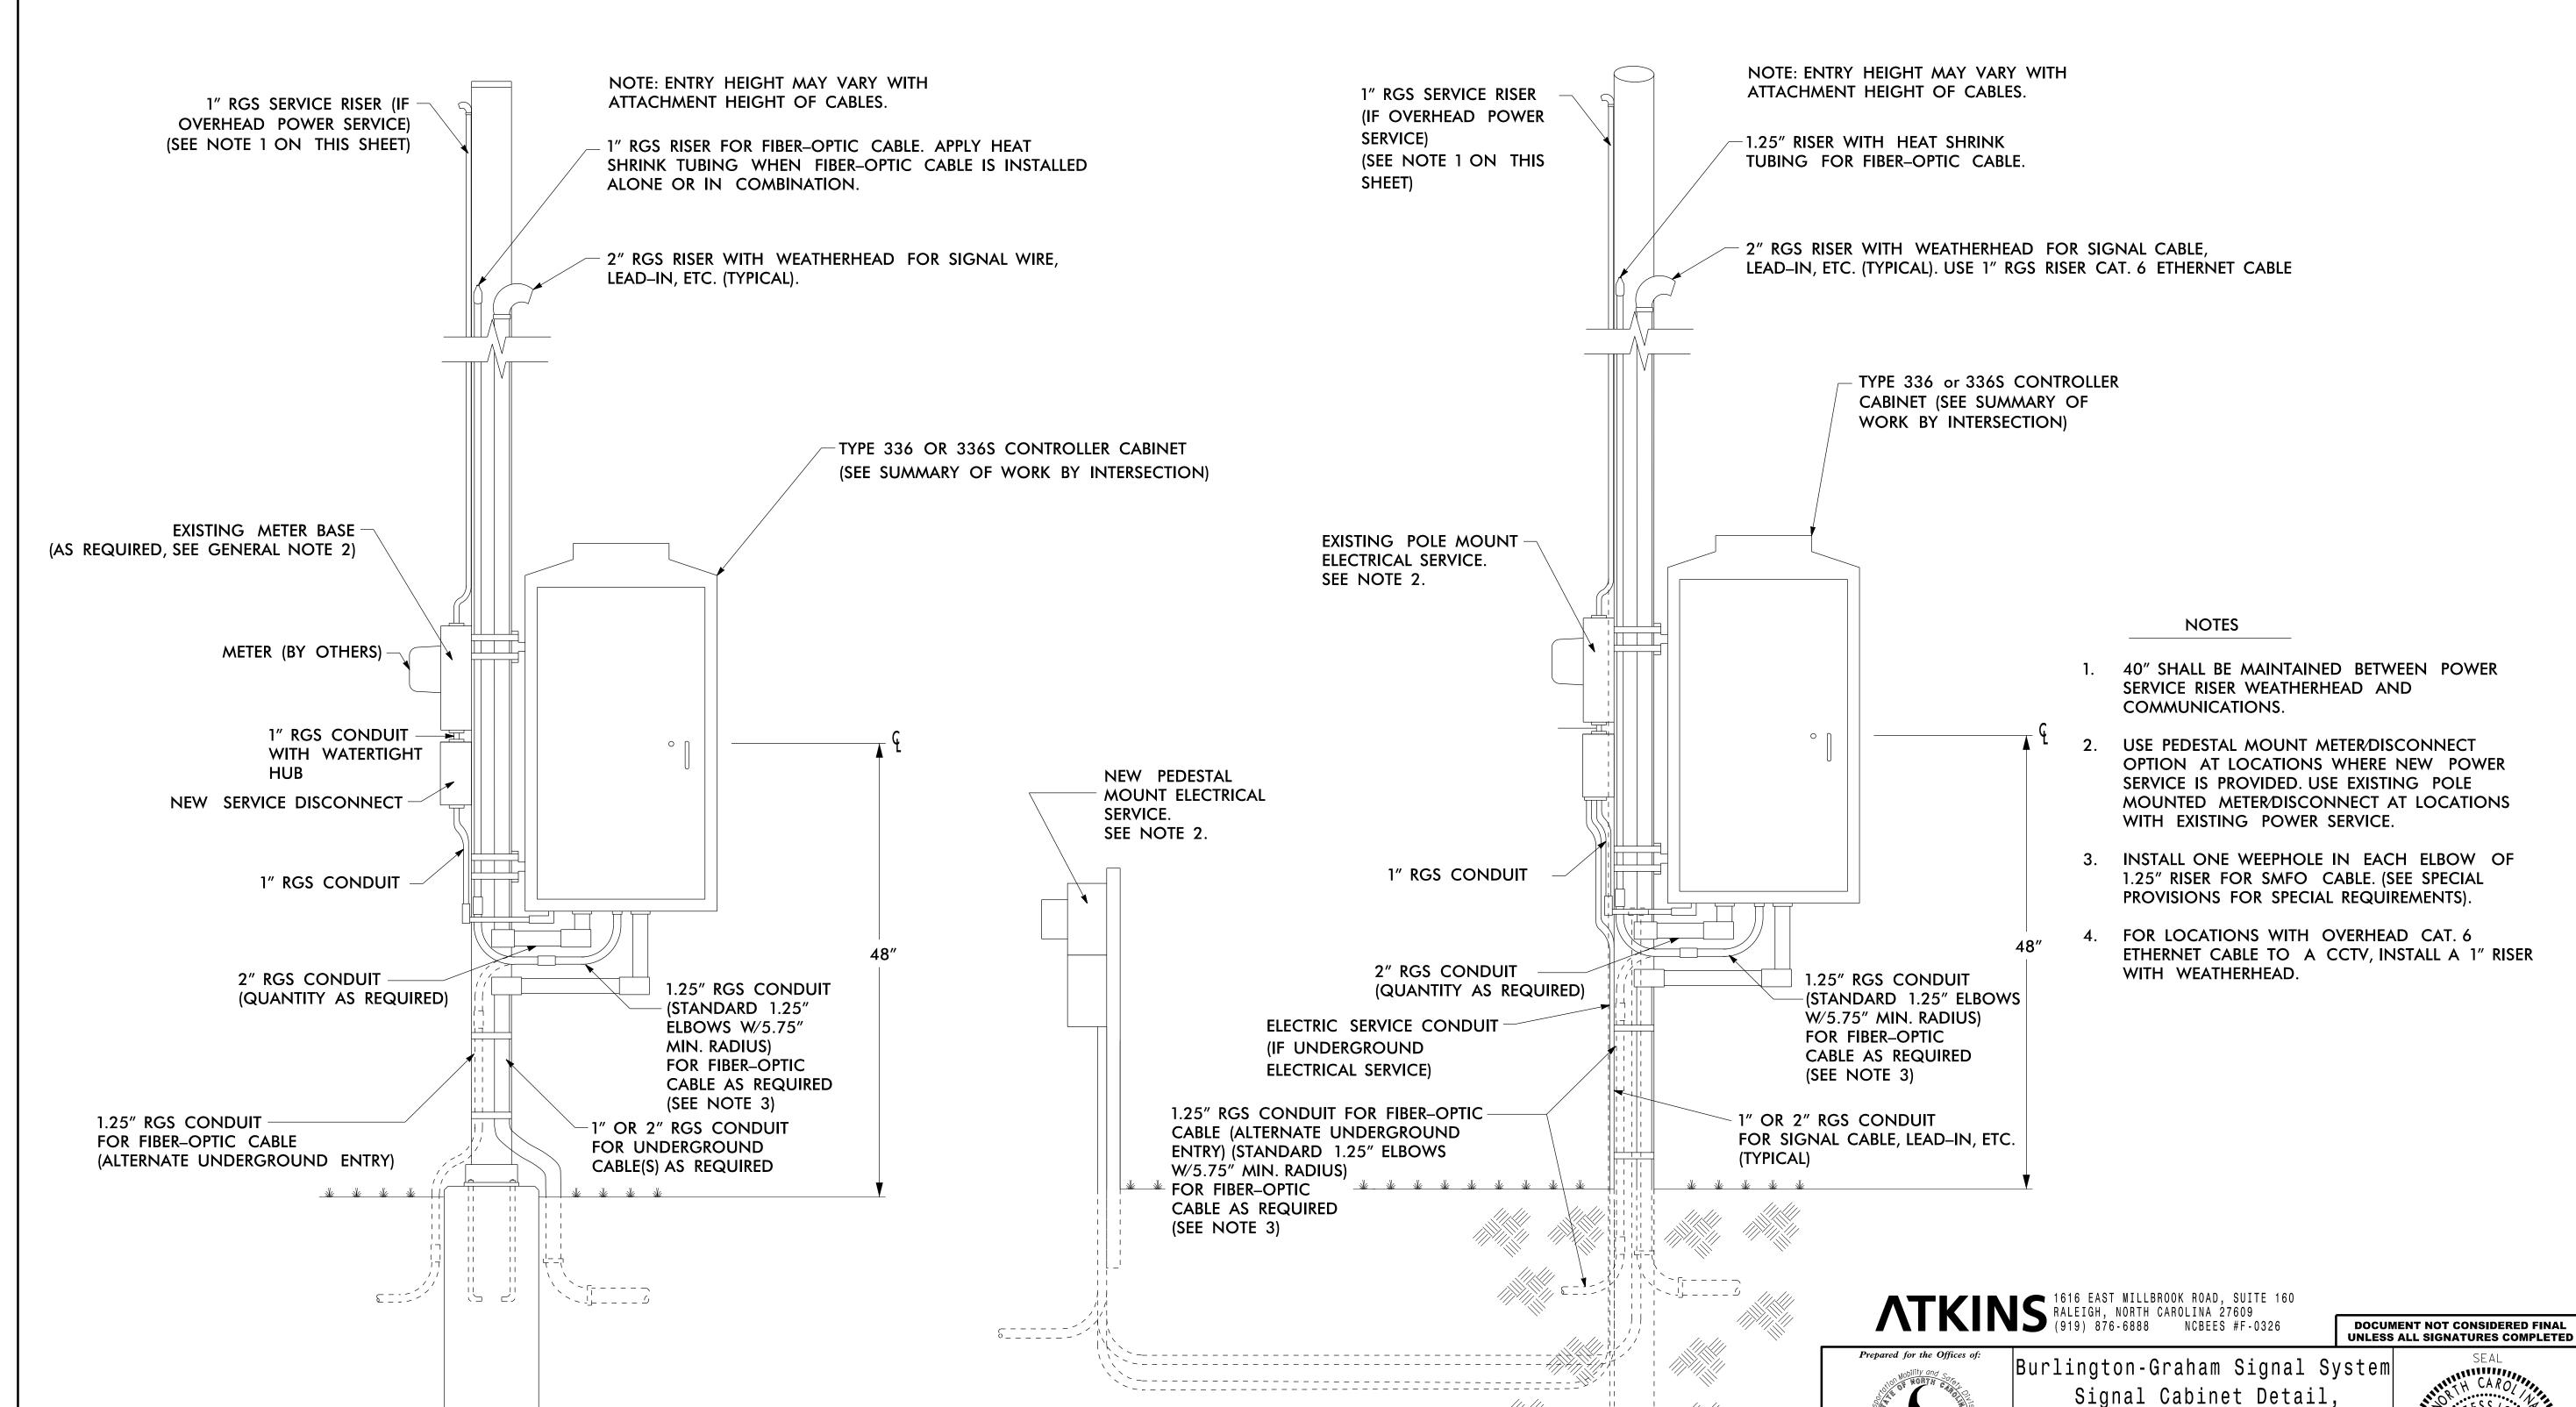


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ROJECT REFERENCE NO. SHEET NO. U-6015 ITS-5.06

#### POLE-MOUNTED SIGNAL CABINET DETAIL

METAL POLE WOOD POLE

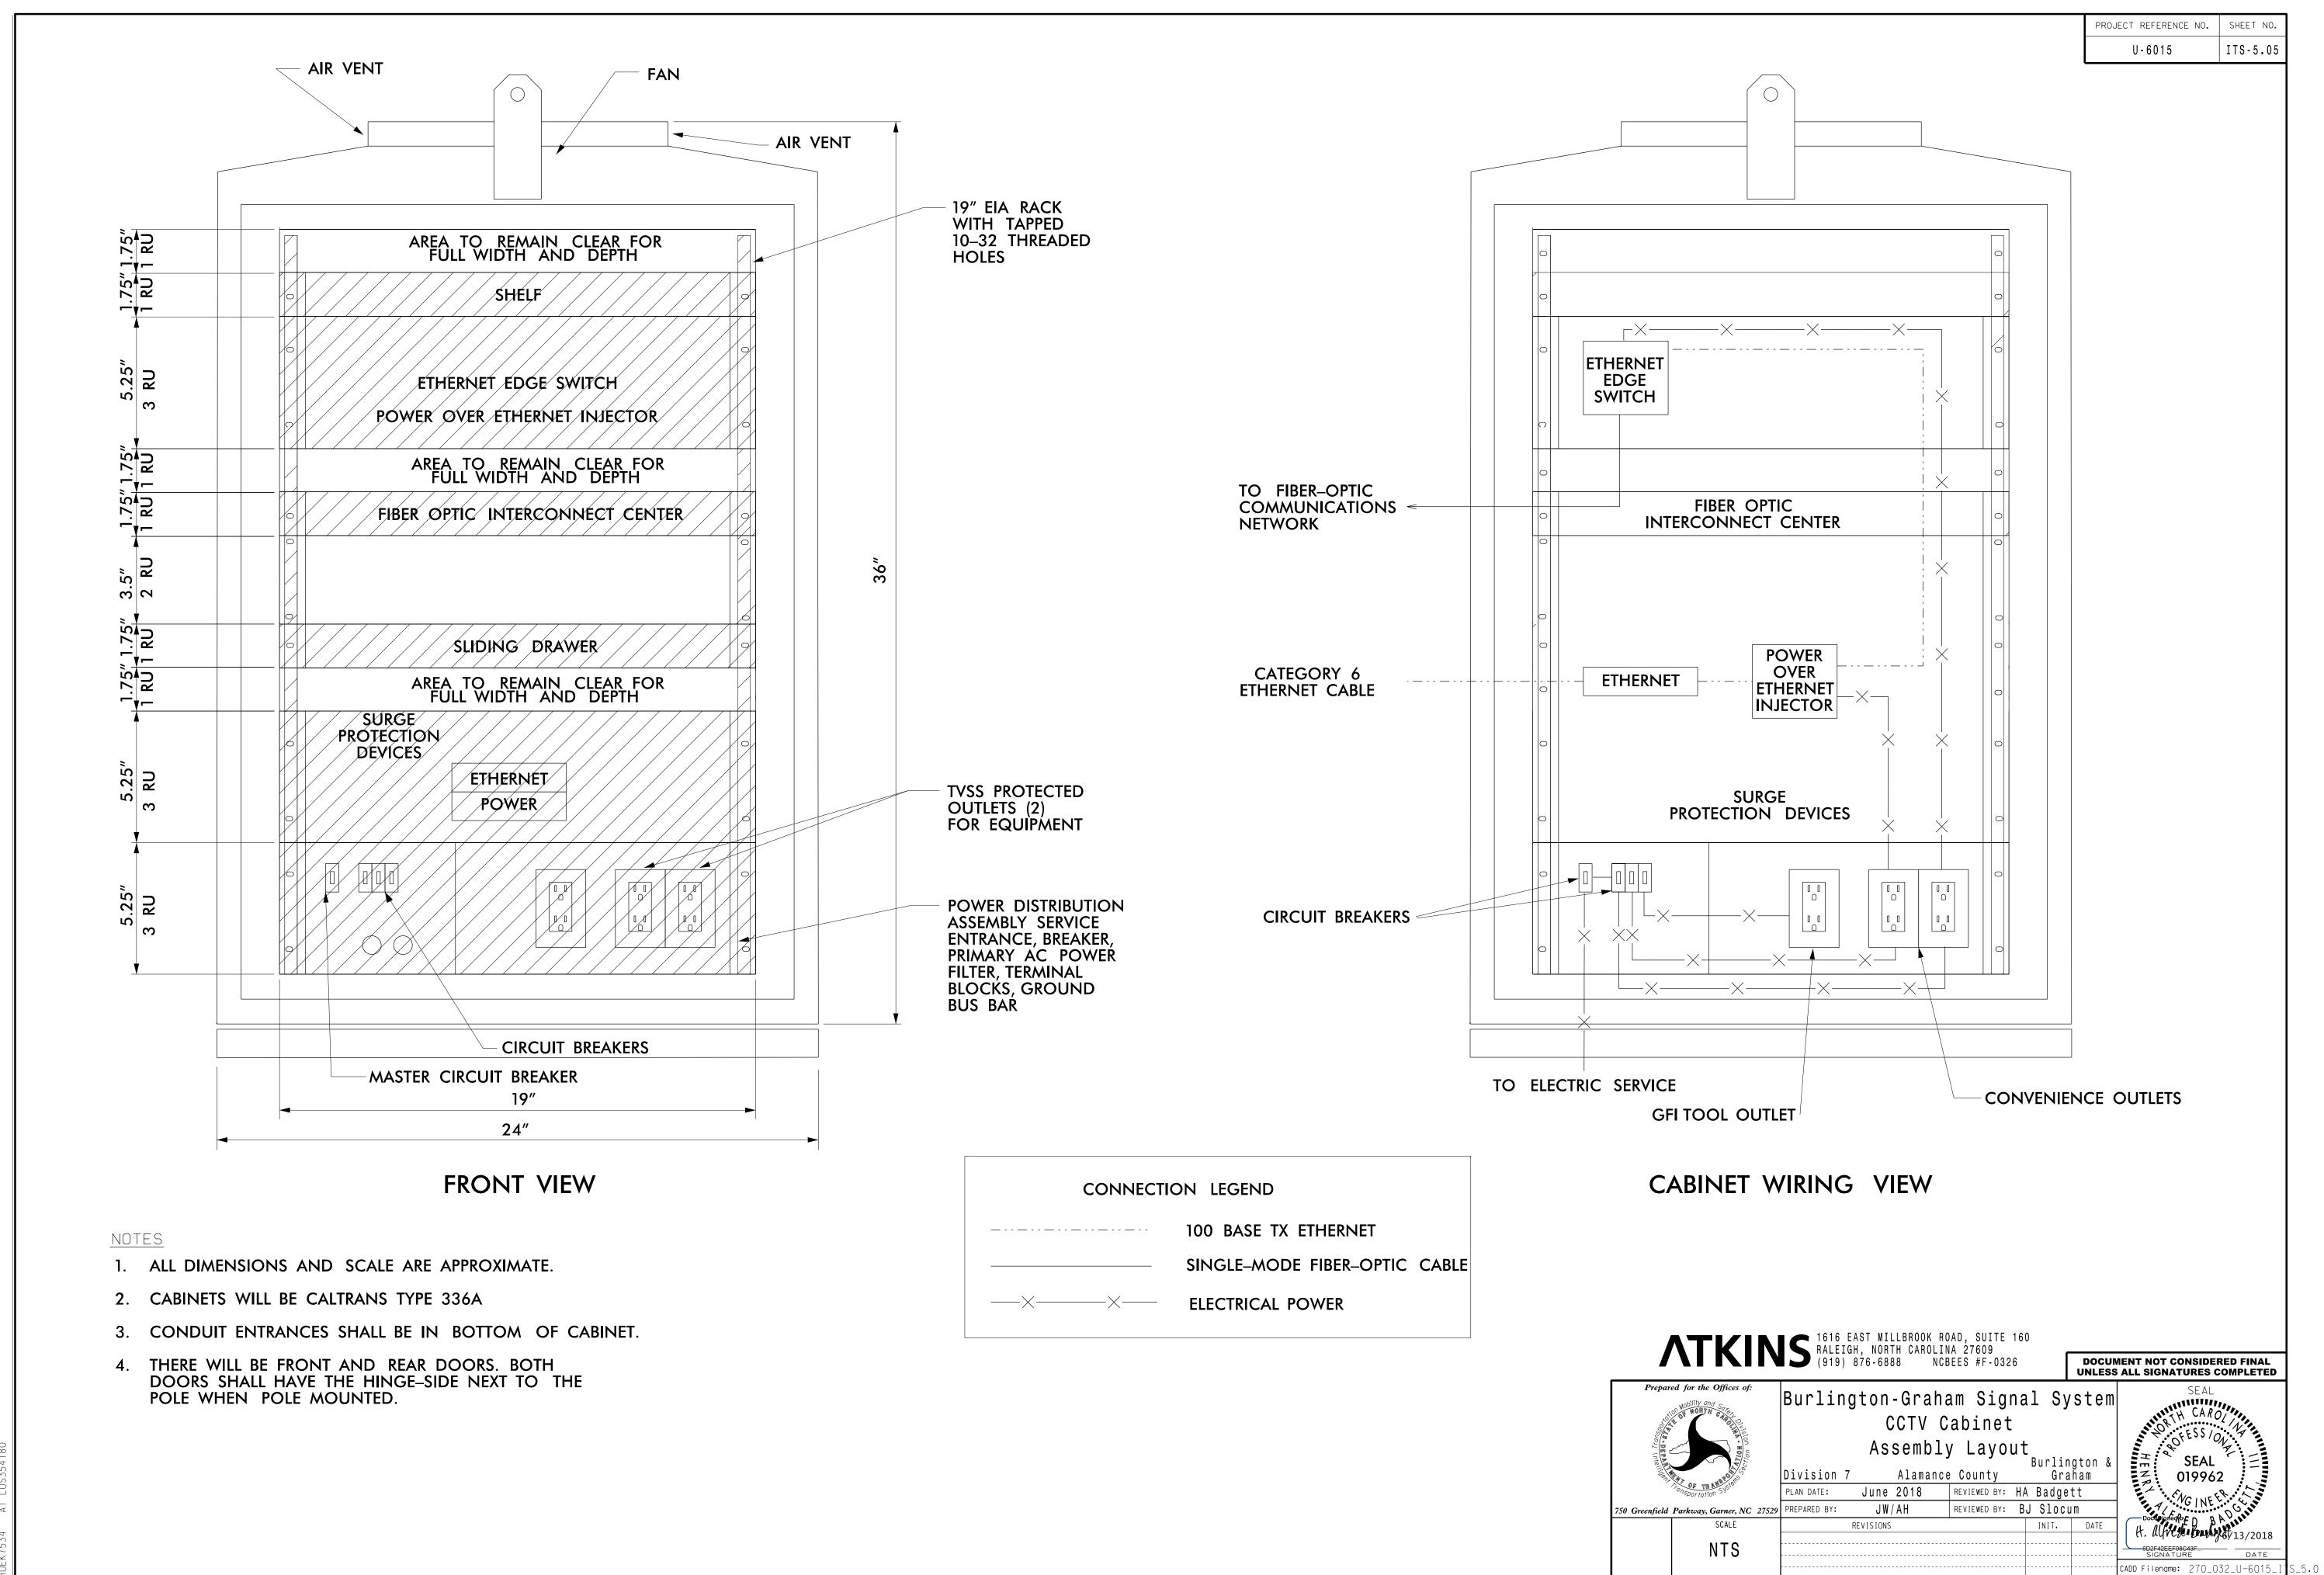

13-JUN-2018 11:54 0:\*Transportation\*Traffic\*Curr\*100056469 U-6015 B-G Sig Sys\*Task 1

DATE
033\_U-6015\_I S-5.

Pole-Mounted

June 2018 REVIEWED BY: HA Badgett

REVIEWED BY: BJ Slocum

Alamance County

JW/AH

REVISIONS

PREPARED BY:

'50 Greenfield Parkway, Garner, NC 27529


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Burlington & Graham

INIT. DATE


ITS-5.07 U-6015


#### TYPICAL RISER DETAILS

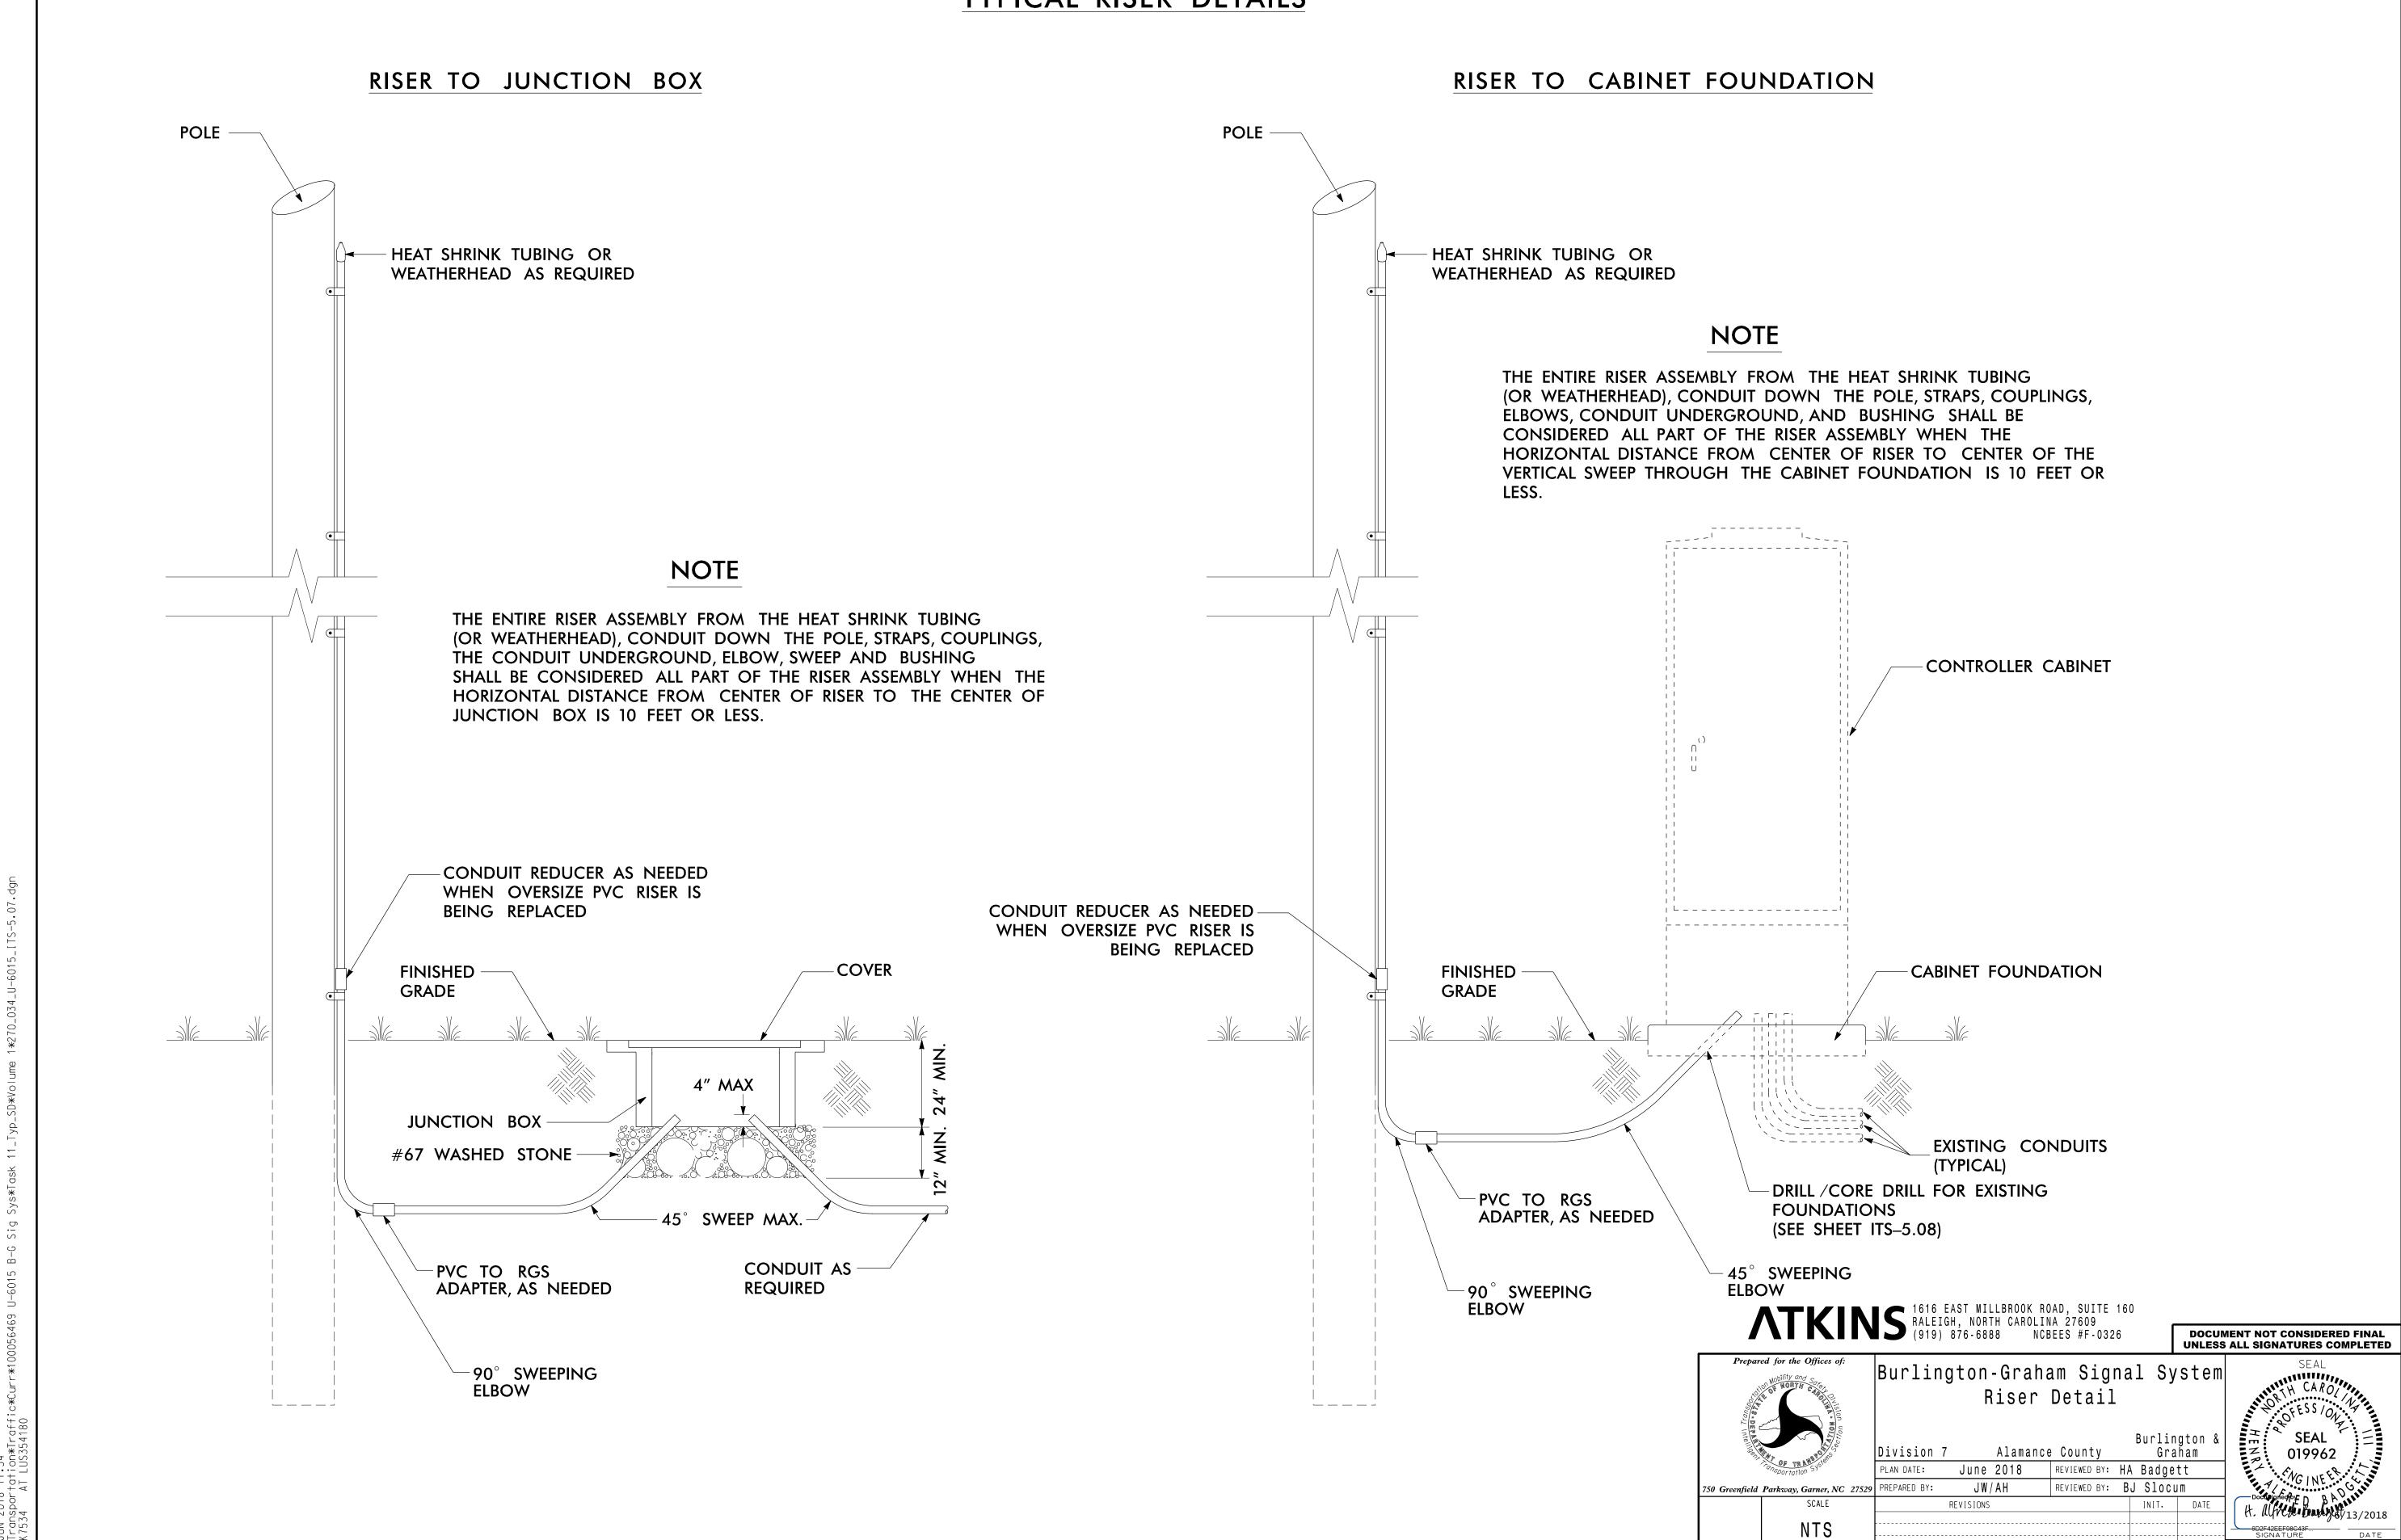

CADD Filename: 270\_034\_U-6015.

#### TYPICAL FOUNDATION MODIFICATIONS

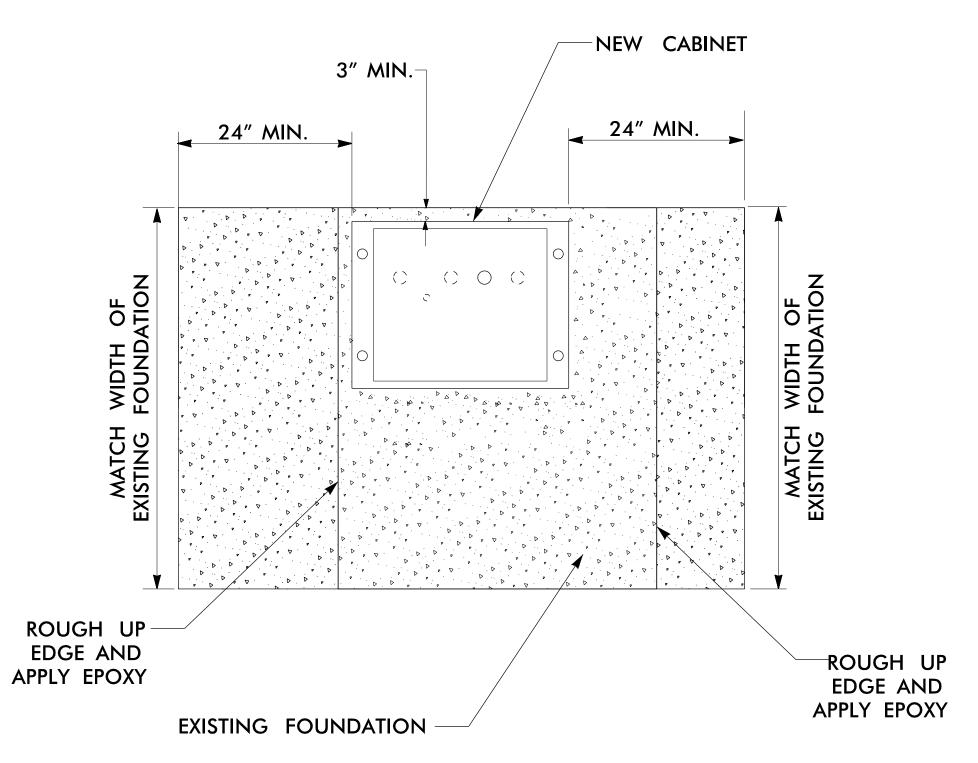

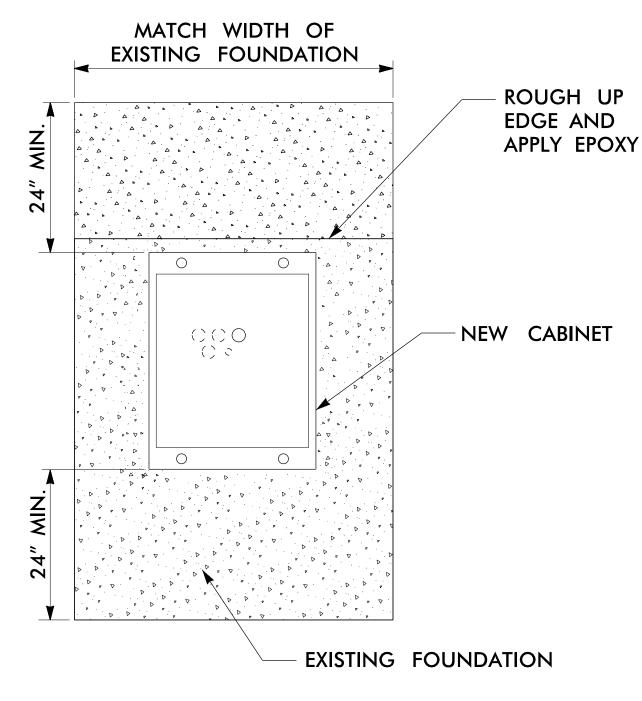

FOUNDATION	LENGTH
EXTENSION	OF DOWEL
>16"	18"
>6' AND <16"	11"
= 6"	8"

#### NOTES

#### FOR FOUNDATION MODIFICATIONS:

- A. MAINTENANCE TECHNICIAN PADS SHALL BE ADDED TO THE FOUNDATION TO PROVIDE A MINIMUM PAD AREA THAT EXTENDS 24" FROM THE FRONT AND BACK OF THE CABINET, AND MATCHES THE WIDTH OF THE EXISTING FOUNDATION.
- B. EXCAVATE THE GROUND AROUND THE EXISTING FOUNDATION TO A DEPTH SUFFICIENT TO EXPOSE A MINIMUM OF 4" OF THE FOUNDATION BELOW EXISTING GRADE.
- C. ROUGH THE SIDES OF THE EXISTING FOUNDATION FROM THE TOP TO A POINT FOUR INCHES BELOW GRADE BY MEANS OF A CHISEL OR OTHER METHOD APPROVED BY THE ENGINEER.
- D. WASH THE SIDES OF THE FOUNDATION WITH WATER PRESSURIZED AT 50 PSI AND THOROUGHLY DRY WITH COMPRESSED AIR.
- E. DRILL HOLES APPROXIMATELY 6" DEEP ON 12-INCH CENTERS INTO THE EXISTING FOUNDATION. INSTALL #4 DOWELS AND EPOXY INTO PLACE. DOWELS SHALL BE THE LENGTH SHOWN IN THE TABLE ABOVE.
- F. FORM THE SIDES OF THE MODIFIED FOUNDATION TO A MINIMUM DEPTH OF 4" BELOW GRADE.
- G. POSITION FORMS SO THAT ALL EXISTING EXPOSED FOUNDATION SURFACES AT OR ABOVE GRADE LEVEL WILL BE MATCHED.
- H. APPLY A COATING OF APPROVED EPOXY BONDING AGENT TO ALL EXPOSED ROUGHENED CONCRETE SURFACES AS RECOMMENDED BY THE MANUFACTURER.
- I. PROVIDE A ONE INCH CHAMFER ON ALL NEW OUTSIDE EDGES.
- J. USE CONCRETE TO INSTALL THE MAINTENANCE TECHNICIAN PAD.
- K. WHERE CABINETS ARE RELOCATED OR ROTATED ON EXISTING FOUNDATION, CUT OFF ANY EXISTING CABINET MOUNTING BOLTS AND GRIND FLUSH WITH THE PAD SURFACE.

#### **NOTES**

#### FOR DRILL AND CORE DRILLING:

- A. A MINIMUM OF 3" OF COVER SHALL BE MAINTAINED BETWEEN NEW CONDUIT AND EDGE OF EXISTING FOUNDATION.
- B. MINIMUM CLEARANCES OF 1" FROM THE FLANGE OF THE BASE ADAPTER AND 2" FROM EXISTING CONDUITS SHALL BE MAINTAINED.
- C. AVOID DAMAGING EXISTING CONDUIT, CONDUCTORS, AND ANCHOR BOLTS. CONTRACTOR SHALL REPAIR SUCH DAMAGES.
- D. WHERE APPROVED BY THE ENGINEER, EXISTING FOUNDATION MAY BE CHIPPED INSTEAD OF DRILLED FOR CONDUIT ENTRANCE.
- E. BOND NEW METALLIC CONDUIT TO THE CABINET GROUNDING SYSTEM.
- F. AFTER INSTALLATION OF CONDUIT, PLACE GROUT TO SEAL AROUND CONDUIT, AND RETURN EXISTING FOUNDATION TO NORMAL APPEARANCE.


#### LEGEND EXISTING CONDUIT/RISER PROPOSED CONDUIT/RISER 30" FOOTPRINT OF 332 TYPE CABINET WITH BASE EXTENDER

ATKINS 1616 EAST MILLBROOK ROAD, SUITE 160 RALEIGH, NORTH CAROLINA 27609 (919) 876-6888 NCBEES #F-0326

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|Burlington-Graham Signal System| Foundation Modification Detail Burlington & Division 7 Alamance County June 2018 REVIEWED BY: HA Badgett JW/AH REVIEWED BY: BJ Slocum 50 Greenfield Parkway, Garner, NC 27529 REVISIONS INIT. DATE NTS

U-6015 ITS-5.09

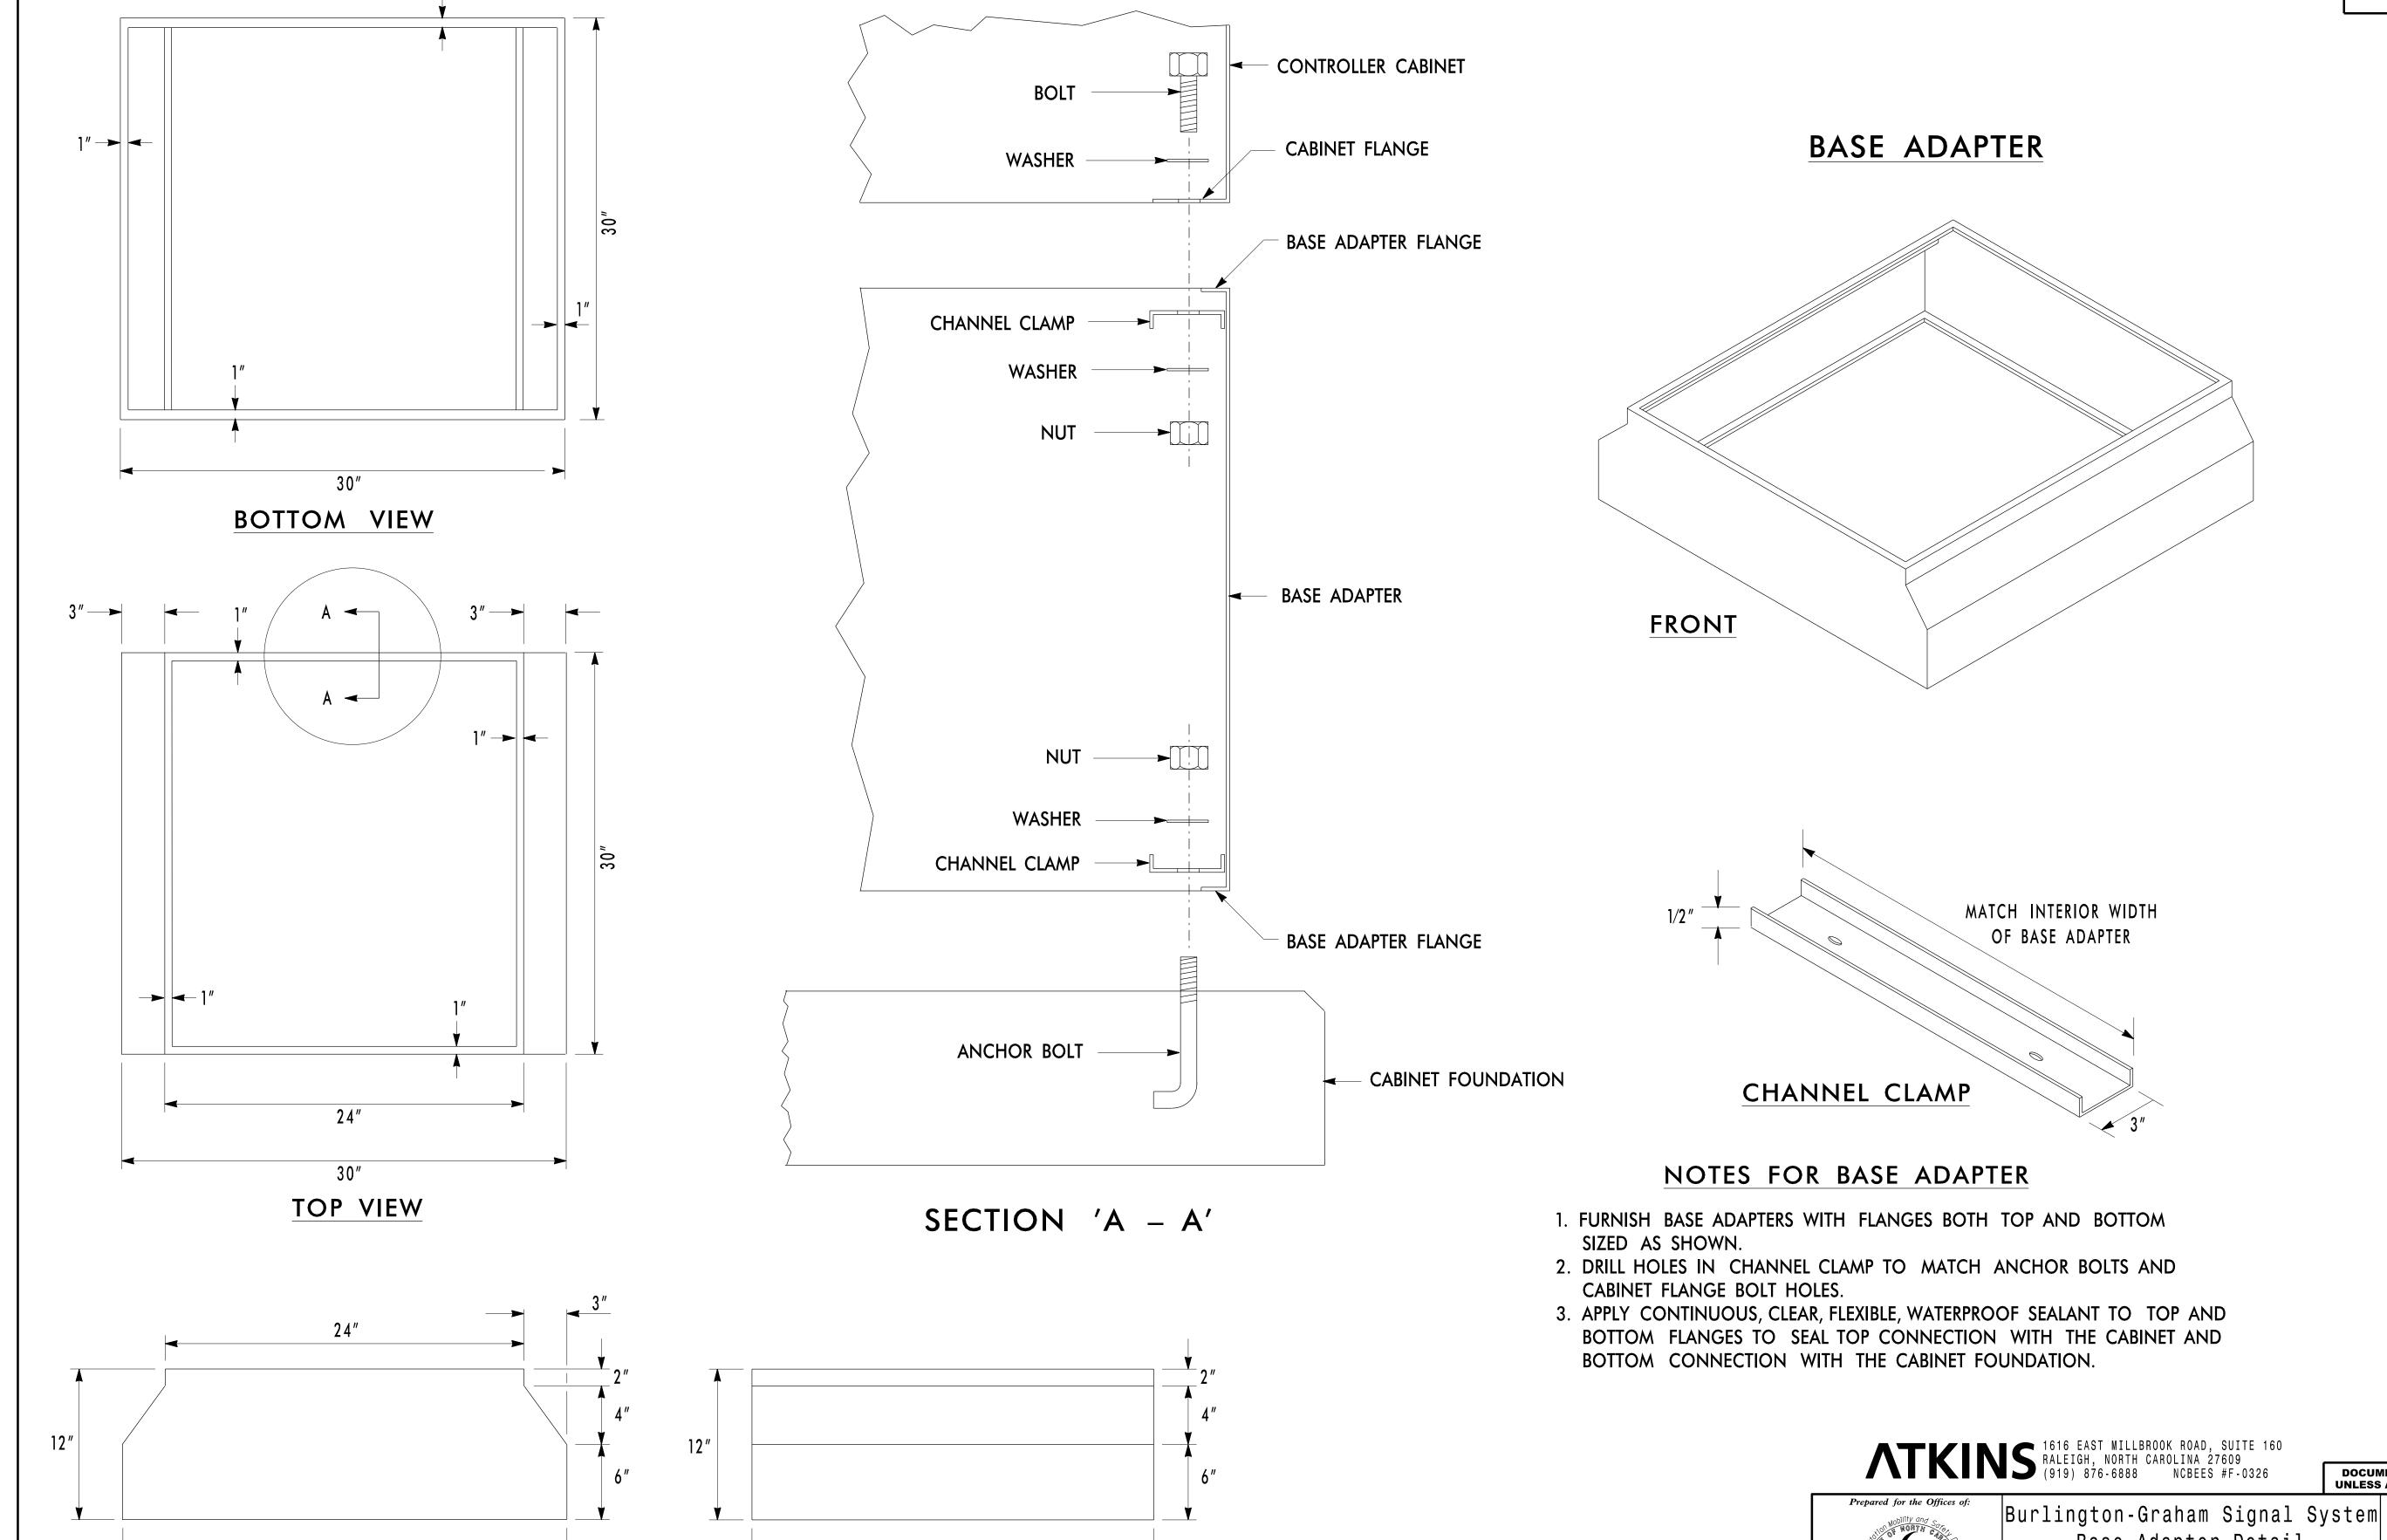

RIGHT SIDE VIEW

FRONT VIEW


Base Adapter Detail Burlington & Graham Division 7 Alamance County June 2018 REVIEWED BY: HA Badgett REVIEWED BY: BJ Slocum JW/AH REVISIONS INIT. DATE

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U-6015 ITS-5.10

#### GROUND MOUNTED ELECTRICAL SERVICE DETAIL



#### **NOTES**

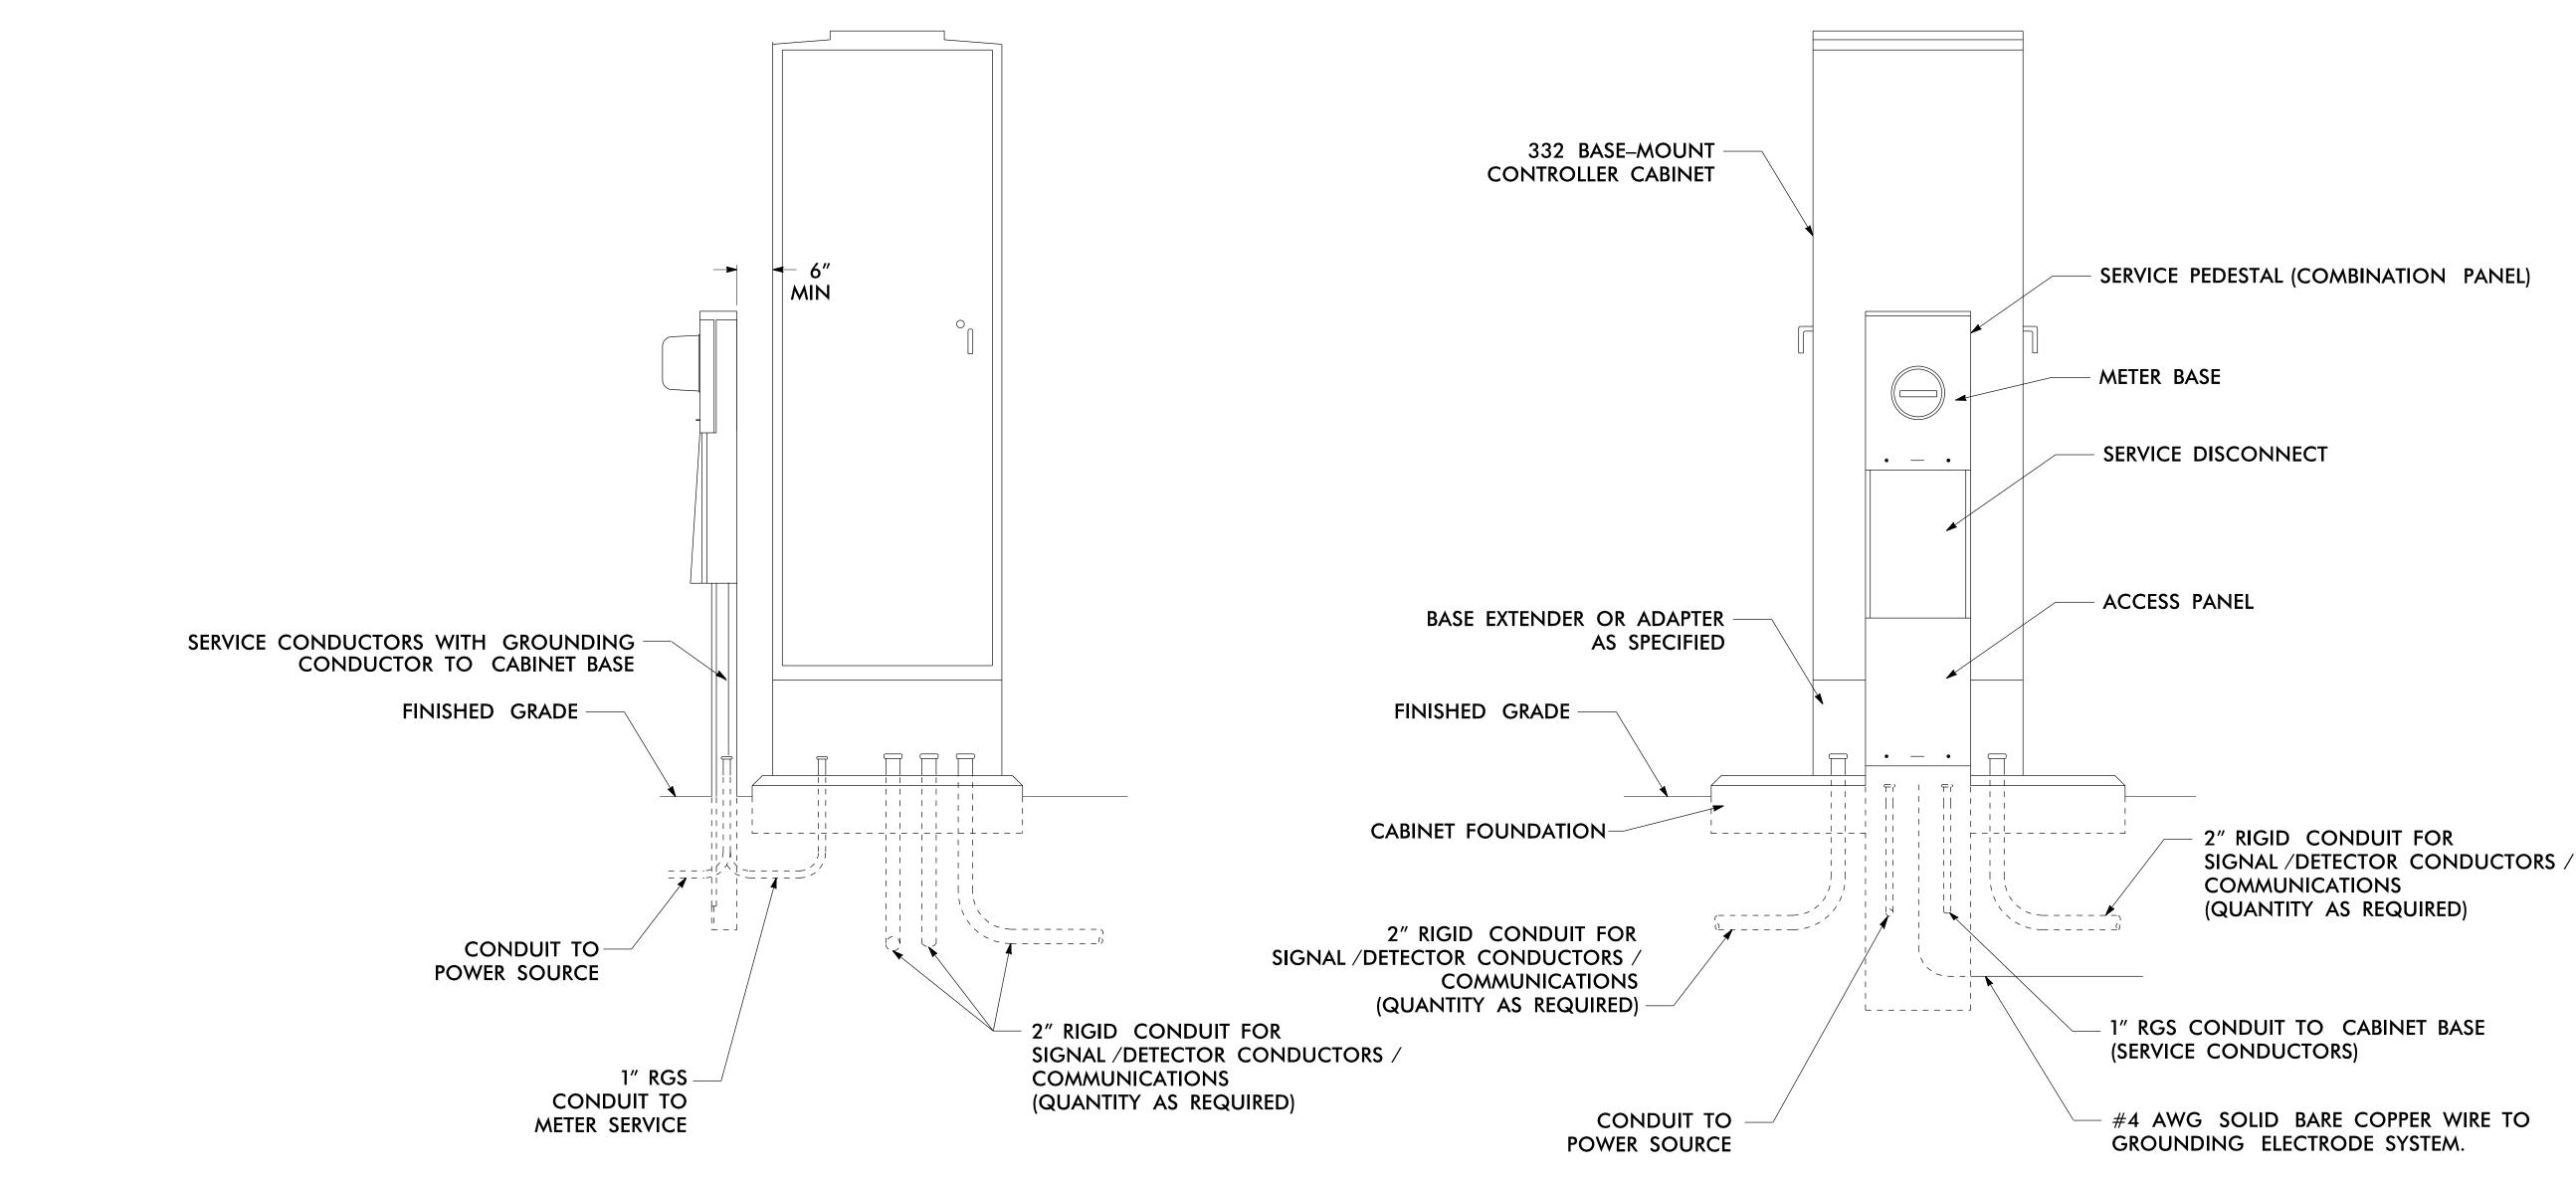- 1. TEST GROUNDING SYSTEM USING AN APPROVED METHOD IN ACCORDANCE WITH SPECIAL PROVISIONS. INSTALL GROUND RODS AS DIRECTED BY THE ENGINEER TO MEET THIS REQUIREMENT.
- 2. REMOVE ANY EXISTING GROUND RODS IN CONCRETE CABINET FOUNDATION BY CUTTING OFF FLUSH WITH FOUNDATION SURFACE.
- 3. REMOVE BONDING JUMPER IN EQUIPMENT CABINET IF INSTALLED BETWEEN AC NEUTRAL AND EQUIPMENT GROUND.
- 4. BOND ALL RIGID GALVANIZED STEEL CONDUITS ENTERING THE CABINET TO "EQUIPMENT GROUND".
- 5. INSTALL RIGID GALVANIZED STEEL CONDUIT (MINIMUM 1") BETWEEN DISCONNECT AND CABINET.
- 6. SERVICE DISCONNECT GROUND BUS BAR SHALL PROVIDE FOR 2 #4 AWG CONNECTIONS.
- 7. IF CONDITIONS REQUIRE SERVICE PEDESTAL TO BE INSTALLED IN FRONT OR REAR OF CABINET, MAINTAIN SUFFICIENT CLEARANCE FOR DOOR TO FULLY OPEN.



Ground Mounted Electrical
Service Detail
Division 7 Alamance County Graham
PLAN DATE: June 2018 REVIEWED BY: HA Badgett

Division 7 Alamance County Graham
PLAN DATE: June 2018 REVIEWED BY: HA Badgett

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Reviewed By: BJ Slocum


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#### OVERHEAD ELECTRICAL SERVICE DETAIL



#### **NOTES**

- 1. TEST GROUNDING SYSTEM USING AN APPROVED METHOD IN ACCORDANCE WITH SPECIAL PROVISIONS. INSTALL GROUND RODS AS DIRECTED BY THE ENGINEER TO MEET THIS REQUIREMENT.
- 2. REMOVE BONDING JUMPER IN EQUIPMENT CABINET IF INSTALLED BETWEEN AC NEUTRAL AND EQUIPMENT GROUND.
- 3. BOND ALL RIGID GALVANIZED STEEL CONDUITS ENTERING THE CABINET TO "EQUIPMENT GROUND".
- 4. INSTALL RIGID GALVANIZED STEEL CONDUIT (MINIMUM 1") BETWEEN DISCONNECT AND CABINET UNLESS OTHERWISE NOTED ON THE PLANS.
- 5. SERVICE DISCONNECT GROUND BUS BAR SHALL PROVIDE FOR 2 #4 AWG CONNECTIONS.
- 6. ENSURE EQUIPMENT GROUND IS ELECTRONICALLY BONDED TO CABINET.

ATKINS 1616 EAST MILLBROOK ROAD, SUITE 160 RALEIGH, NORTH CAROLINA 27609 (919) 876-6888 NCBEES #F-0326
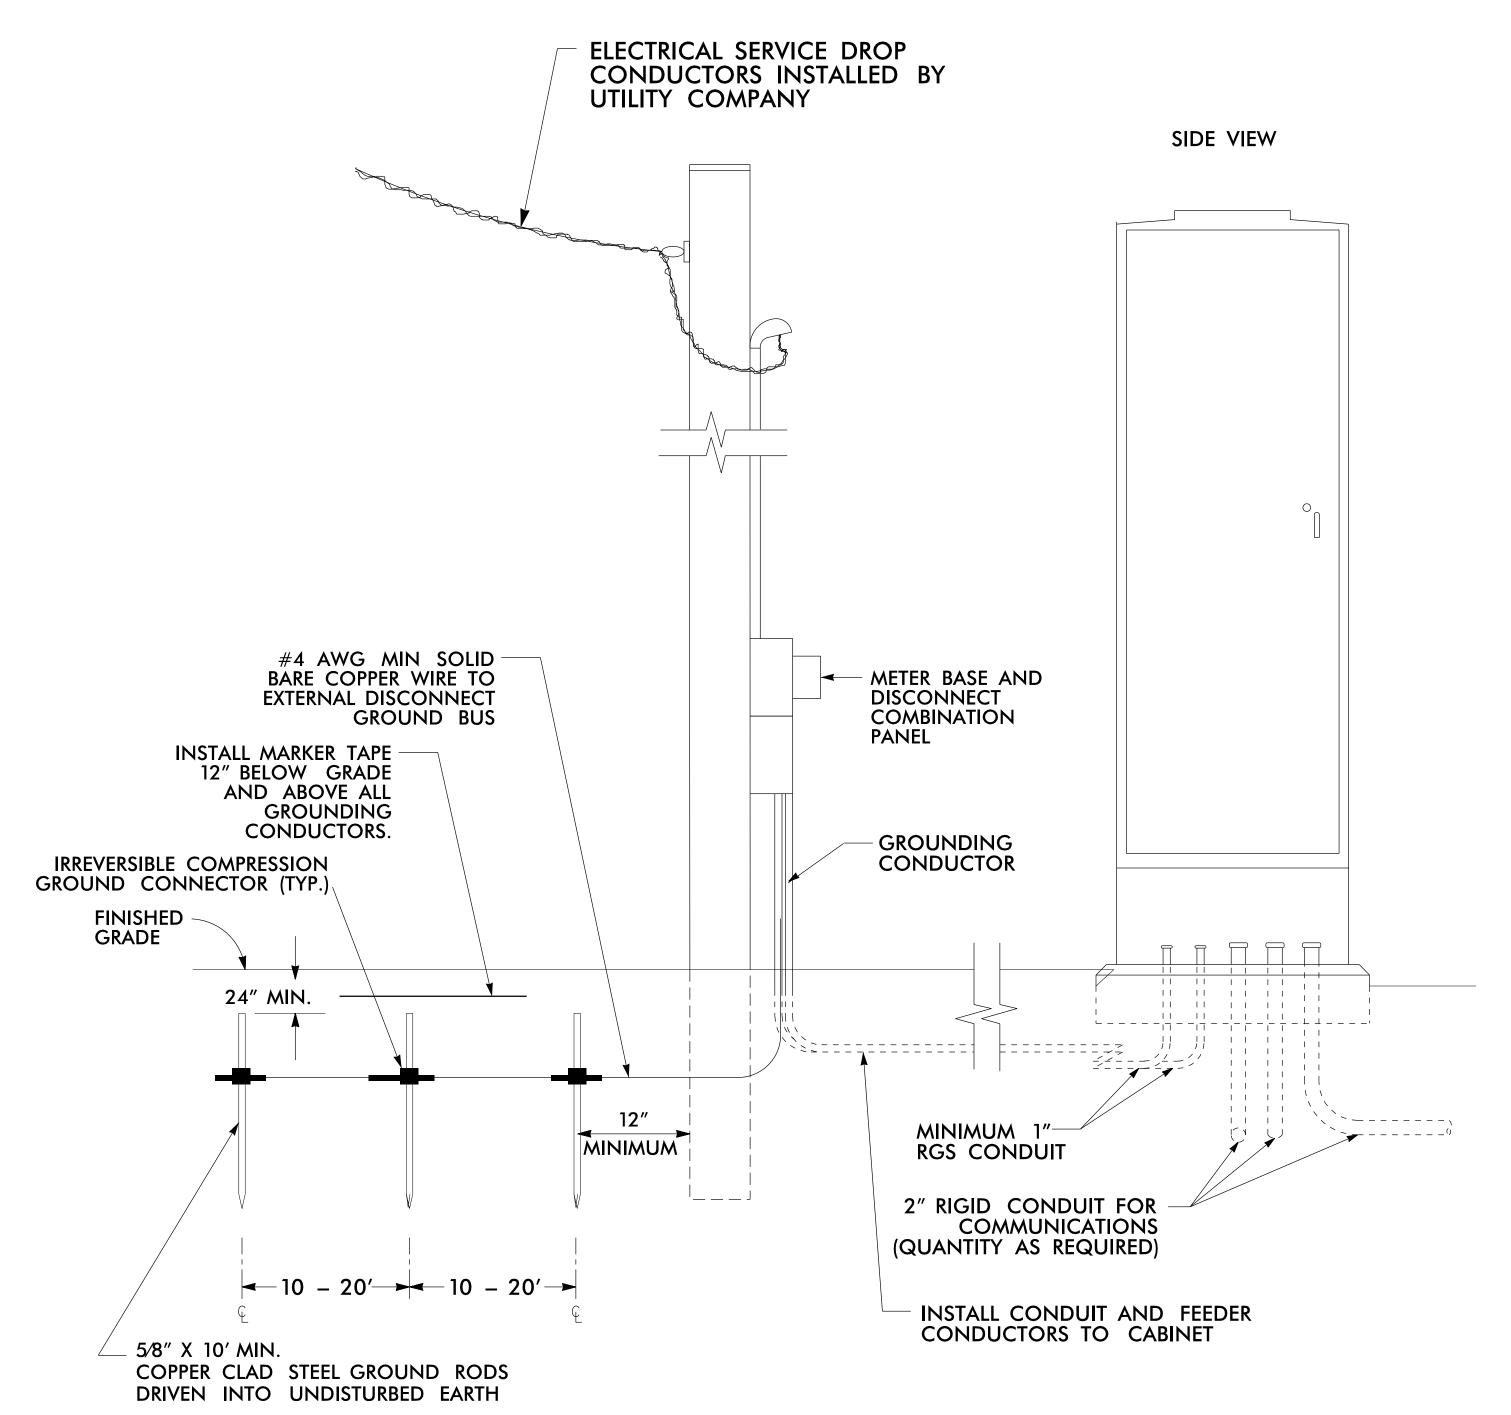
|Burlington-Graham Signal System|

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Overhead Electrical Service Detail


Burlington & Graham Division 7 Alamance County June 2018 REVIEWED BY: HA Badgett REVIEWED BY: BJ Slocum JW/AH '50 Greenfield Parkway, Garner, NC 27529 PREPARED BY:

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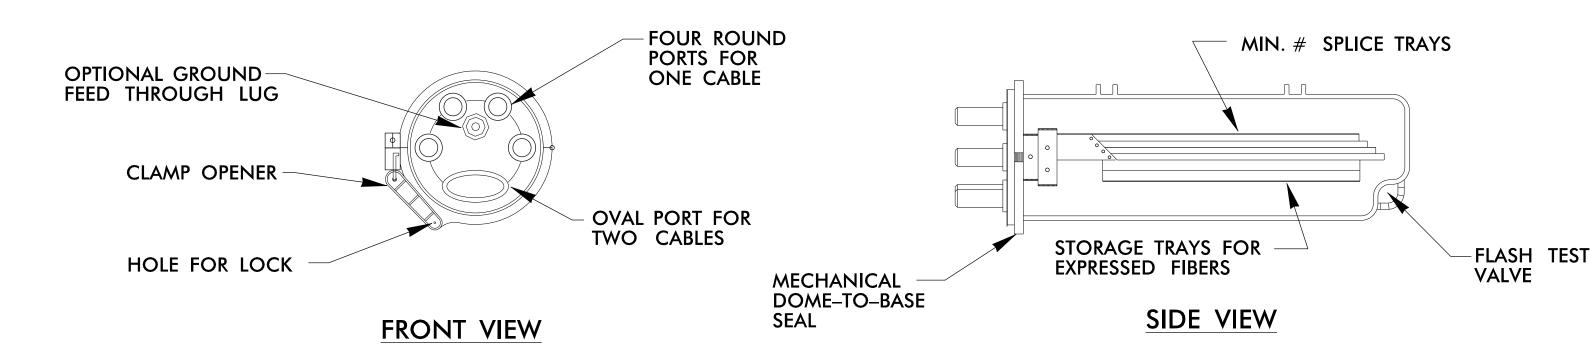
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OJECT REFERENCE NO. SHEET NO. U-6015 ITS-5.12

#### SPARE CABLE STORAGE TYP. DETAIL



#### SPLICE ENCLOSURE DETAILS

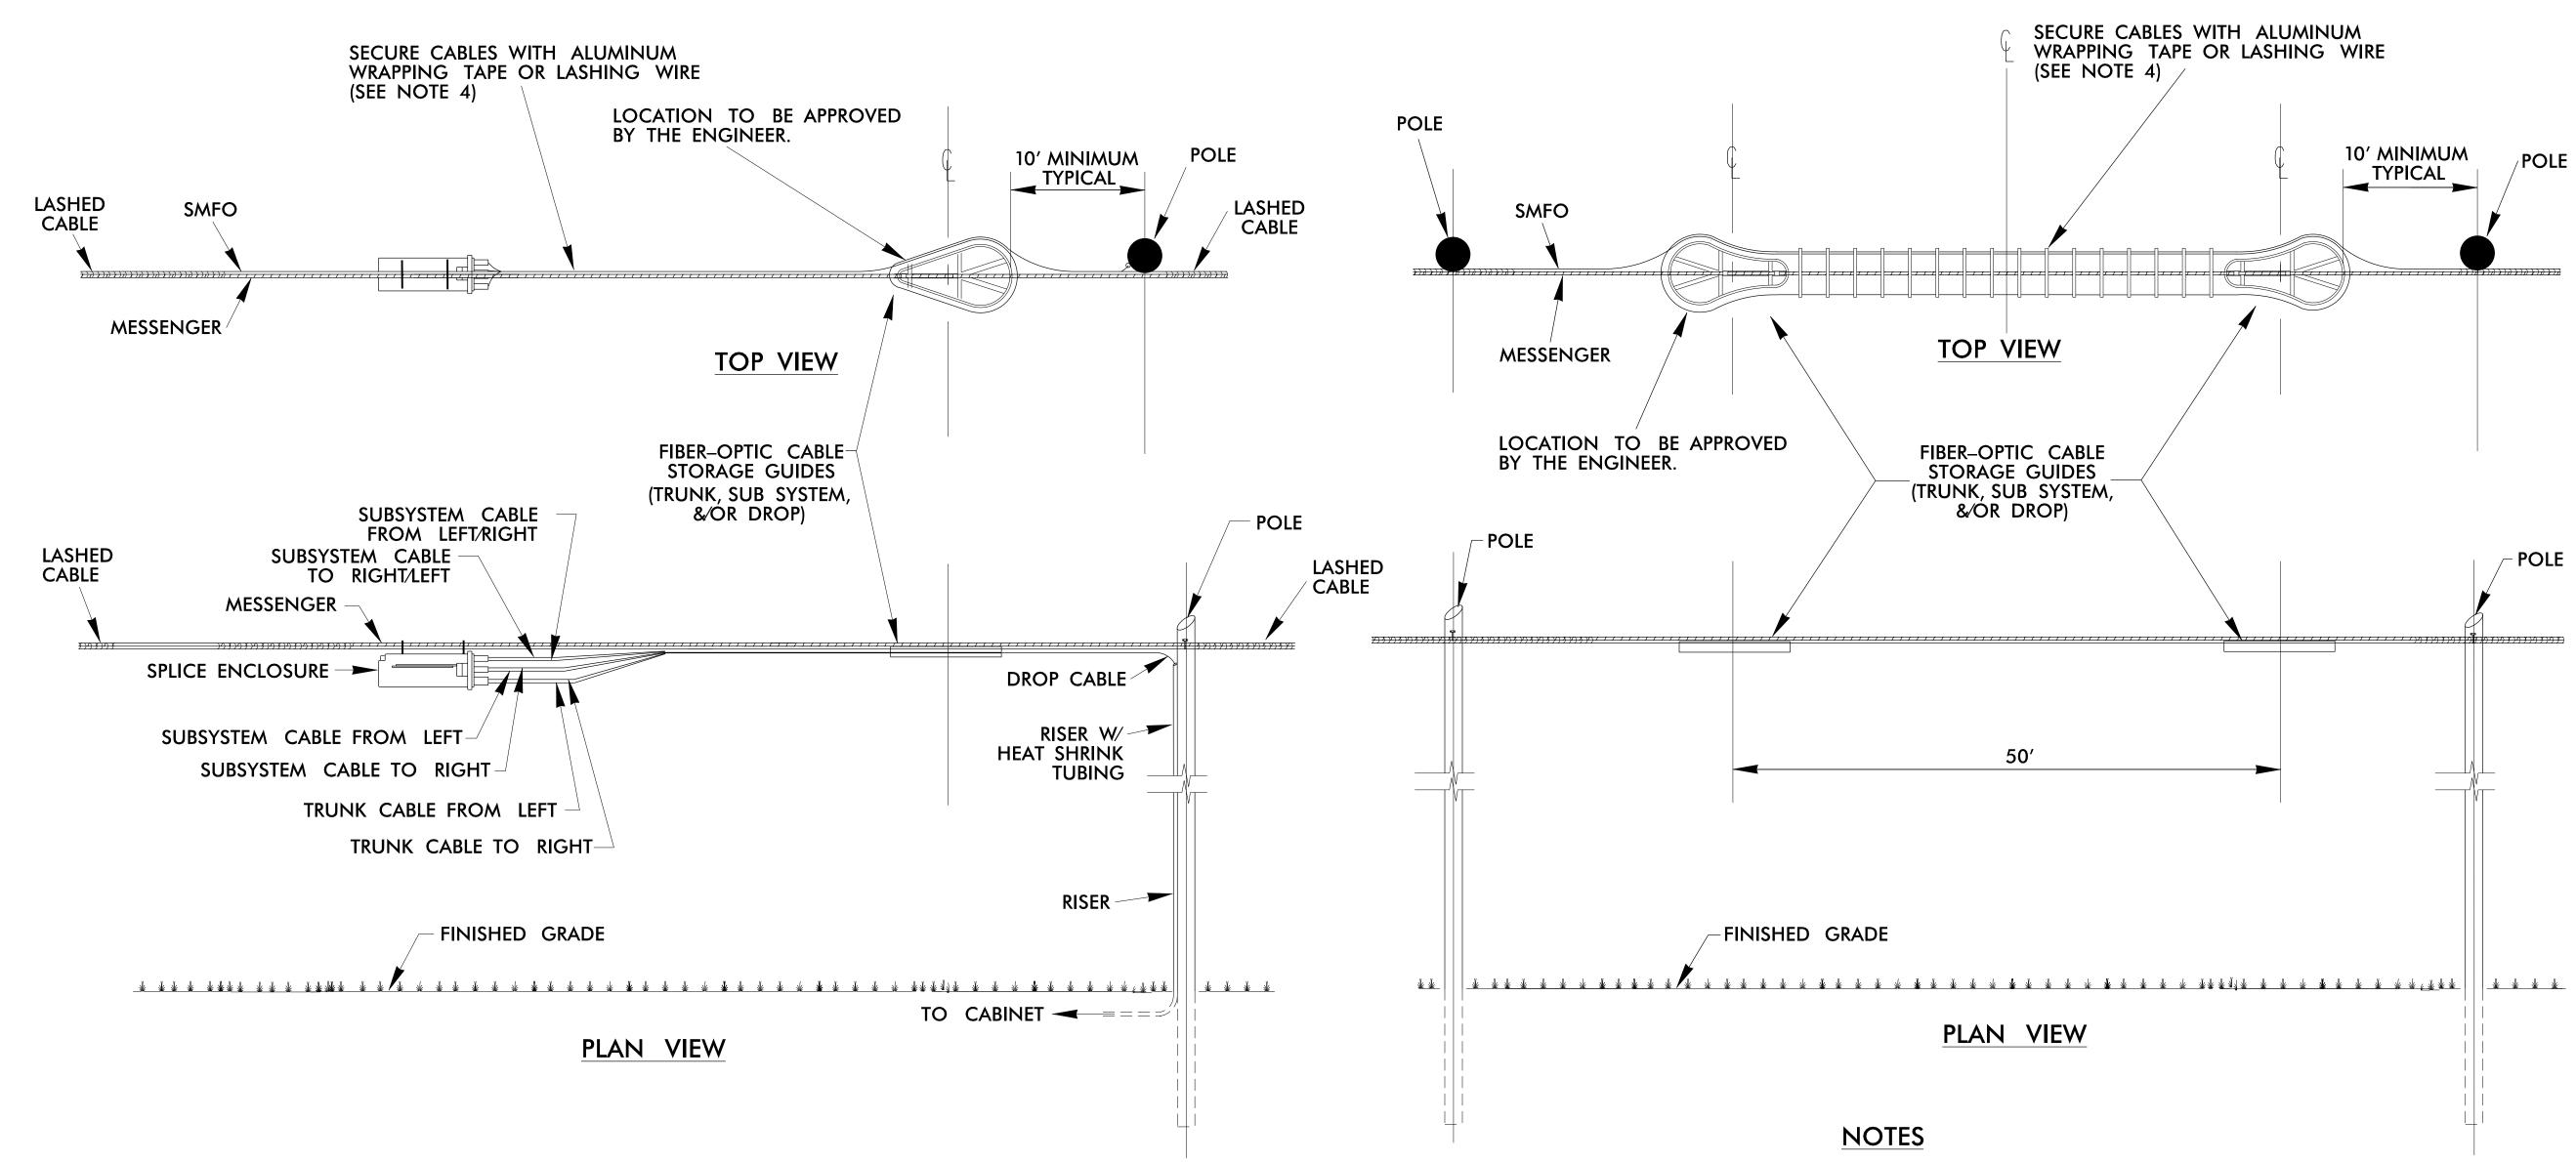

SPLICE ENCLOSURE WITH STORAGE TYP. DETAIL

- 1. SPARE FIBER-OPTIC CABLE SHALL NOT BE STORED OVER ROADWAYS OR DRIVEWAYS.
- 2. STORE 100' OF SPARE FIBER-OPTIC CABLE WHERE SHOWN ON PLANS.
- 3. FIBER-OPTIC CABLE STORAGE GUIDE MATERIAL AND SIZE SHALL BE AS INDICATED IN THE PROJECT SPECIAL PROVISIONS.
- 4. 0.05" THICK BY 0.3" WIDE ALUMINUM WRAPPING TAPE (FOUR TURNS MINIMUM)
  AT 6" ON CENTER OR .061" LASHING WIRE WITH ONE 360 DEGREE SPIRAL PER FOOT.
- 5. FOR SPLICE ENCLOSURES:
  - A) APPLY A HEAT SOURCE, AS RECOMMENDED BY THE MANUFACTURER, TO SHRINK THE HEAT SHRINKABLE TUBING TO PROVIDE A SECURE FIT AROUND THE CABLES AND PORTS.

    B) PERFORM A PRESSURIZATION FLASH TEST UPON CONCLUSION OF THE SPLICING AND PRIOR TO THE FINAL PLACEMENT OF THE ENCLOSURE.

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Burlington-Graham Signal System
Aerial Fiber-Optic Cable
Storage & Splice Enclosures

Burlington & Burlington & SEAL

Division 7 Alamance County Graham

PLAN DATE: June 2018 REVIEWED BY: HA Badgett

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Division 7 Alamance County Graham

PLAN DATE: June 2018 REVIEWED BY: HA Badgett

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PLAN DATE: JW/AH REVIEWED BY: BJ Slocum


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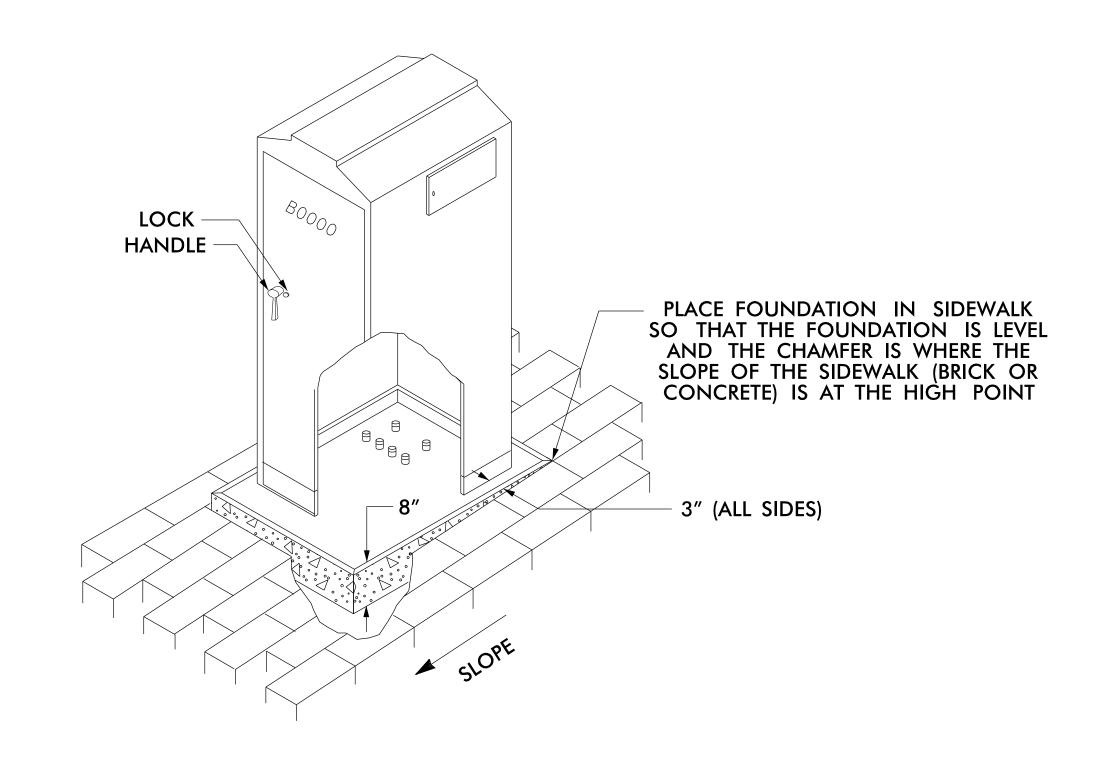
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ITS-5.13 U-6015

#### TYPICAL BASE-MOUNTED CABINET NEW STANDARD FOUNDATION

#### TYPICAL BASE-MOUNTED CABINET NEW FOUNDATION IN SIDEWALK



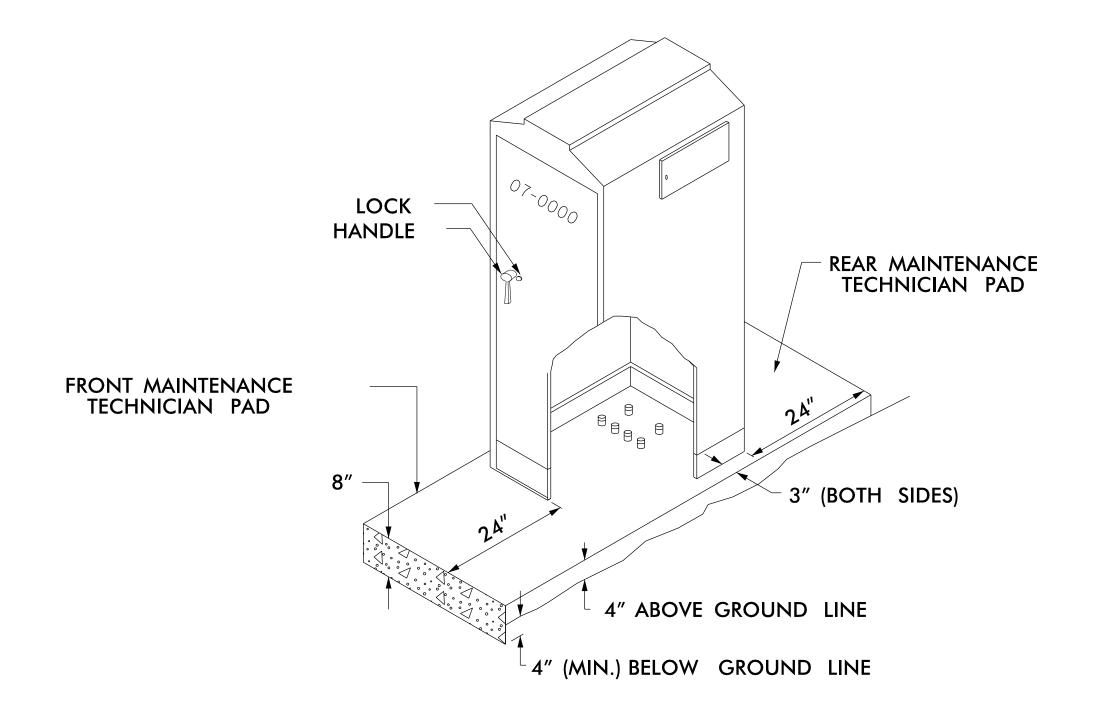

#### **NOTES**

- 1. STUB OUT SPARE 2" CONDUIT TO 12" BEYOND EDGE OF CABINET FOUNDATION.
- 2. SEAL SPARE CONDUIT WITH REMOVABLE CAP.
- 3. TOPS OF CONDUIT SHALL BE NO LESS THAN 2" AND NO MORE THAN 3" ABOVE FOUNDATION.



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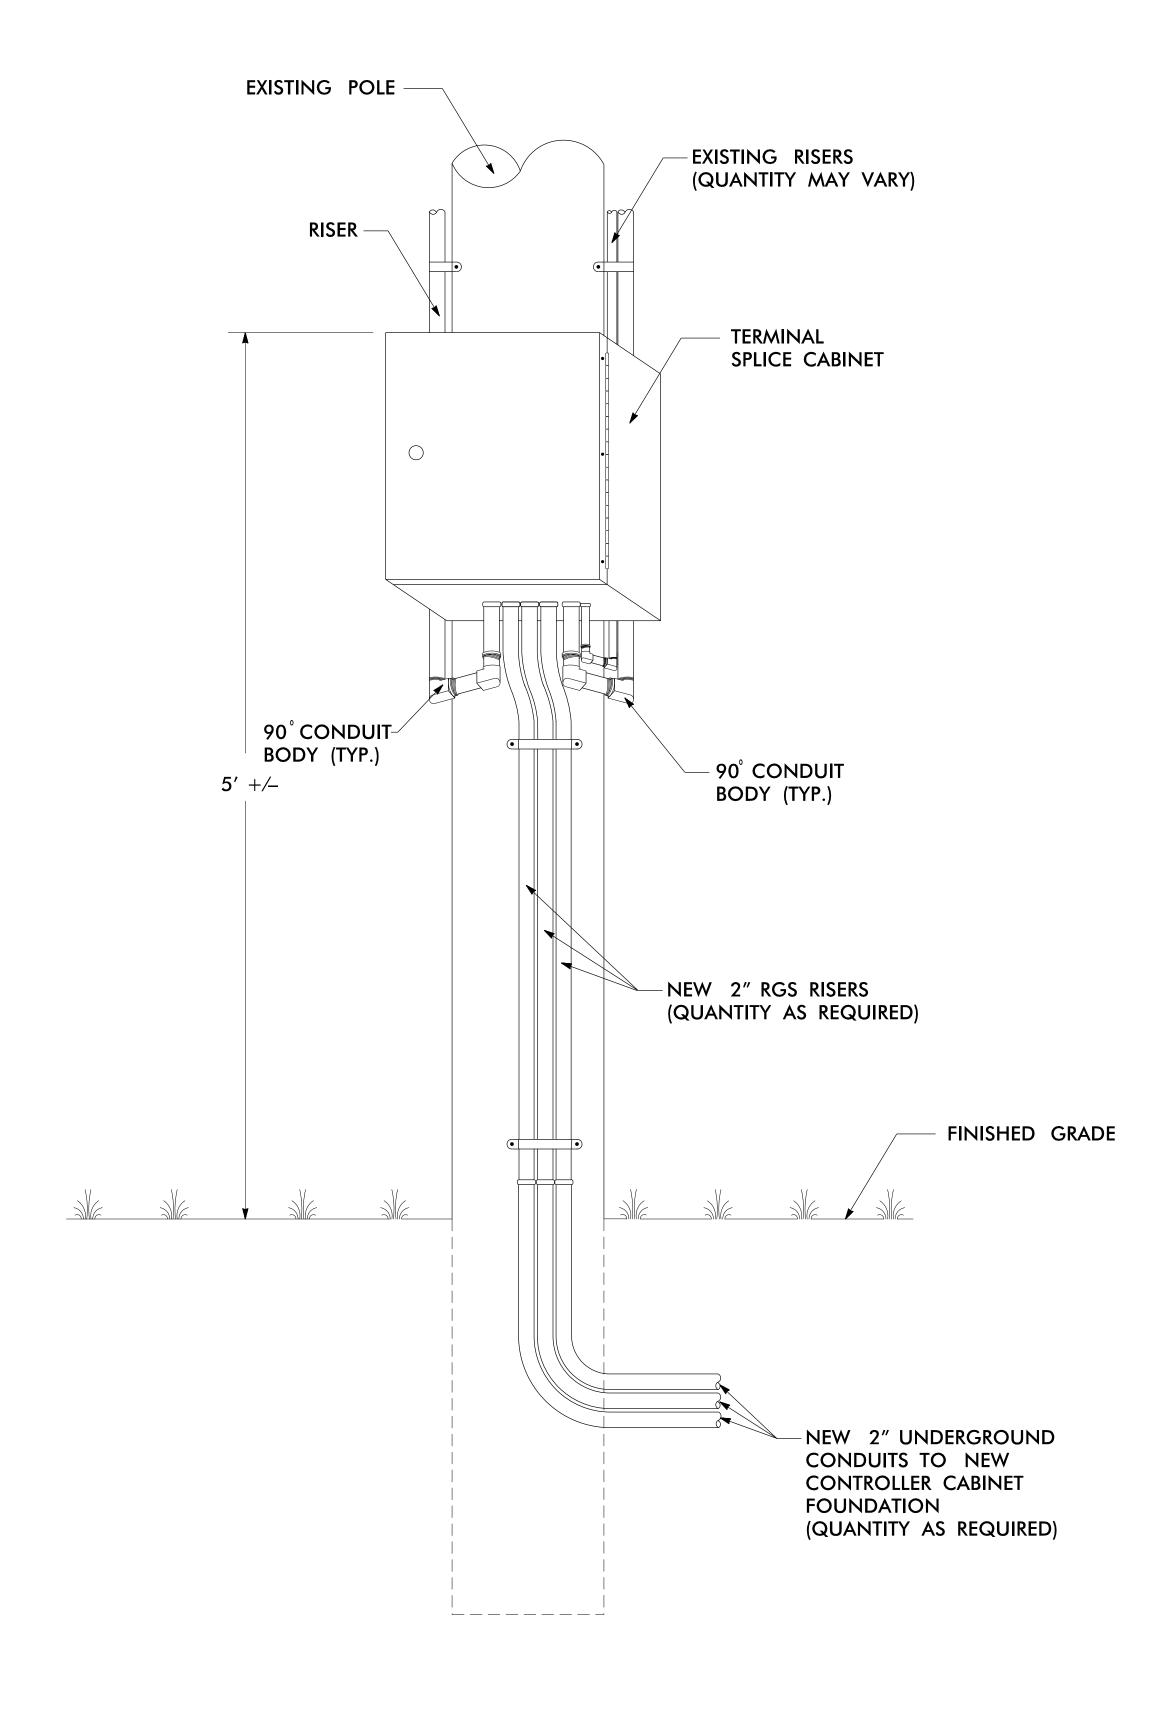
Burlington-Graham Signal System Base-Mounted Cabinet Foundation Details

Burlington & Graham Division 7 Alamance County June 2018 REVIEWED BY: HA Badgett

REVIEWED BY: BJ Slocum JW/AH REVISIONS NTS

PROJECT REFERENCE NO. SHEET NO. U-6015 ITS-5.14

#### TERMINAL SPLICE CABINET DETAIL



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#F-0326

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Burlington-Graham Signal System
Terminal Splice
Cabinet Detail

Division 7 Alamance County Graham

PLAN DATE: June 2018 REVIEWED BY: HA Badgett

PREPARED BY: JW/AH REVIEWED BY: BJ Slocum

Greenfield Parkway, Garner, NC 27529 PREPARED BY: JW/AH REVIEWED BY: BJ Slocum

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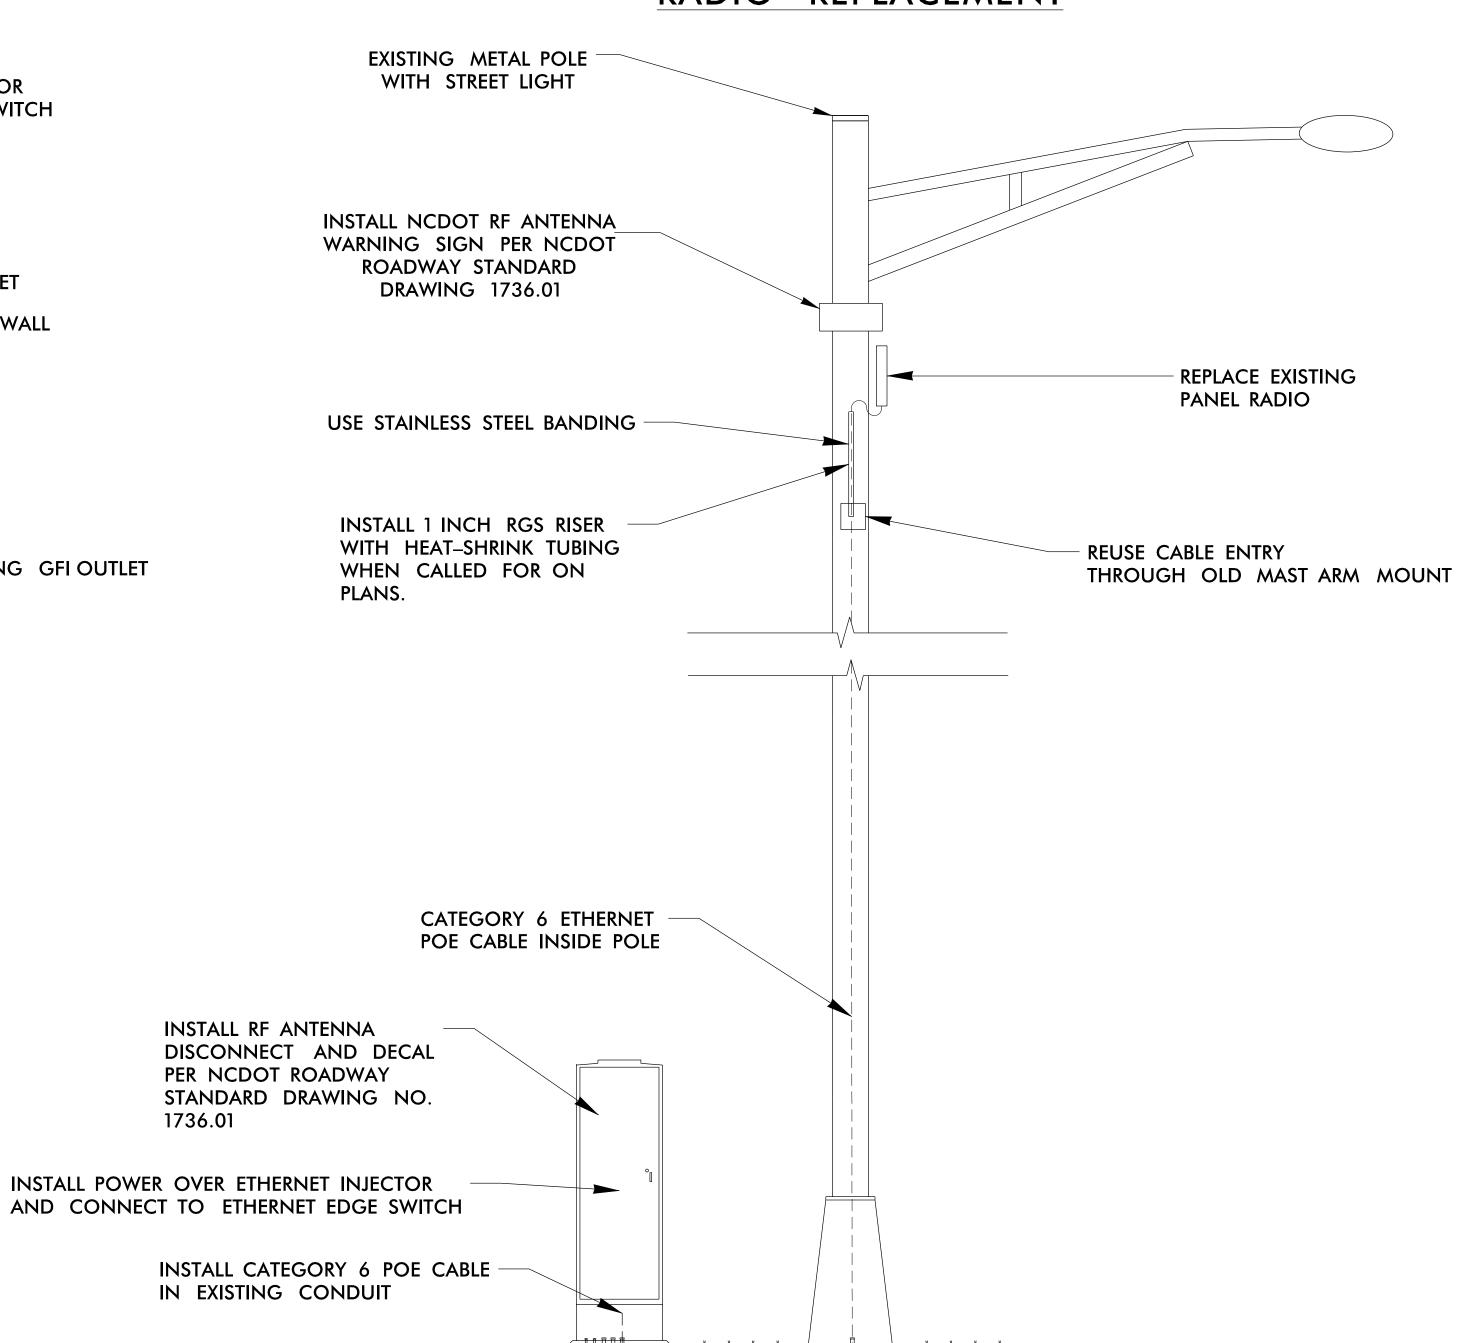
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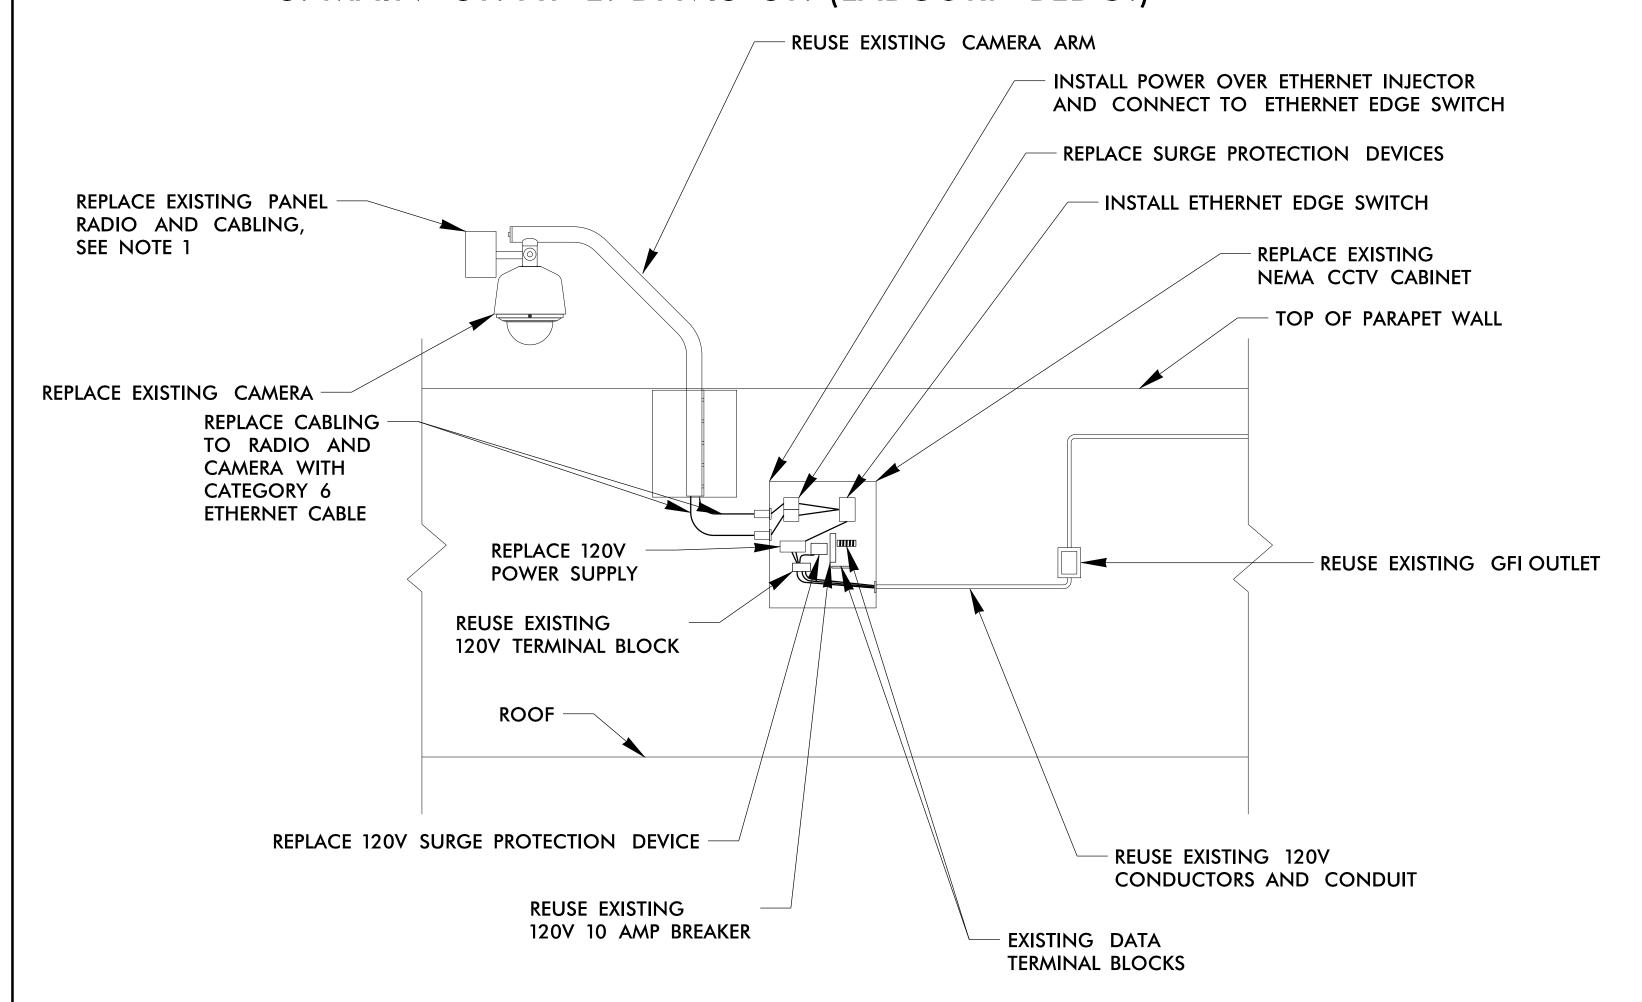
#### B6228 S. MAIN ST. AT MAPLE AVE. RADIO REPLACEMENT



1736.01

#### CAMERA 12 REPLACEMENT ELEVATION VIEW

S. MAIN ST. AT E. DAVIS ST. (LABCORP BLDG.)



#### **NOTES**

- 1. USE INTEGRATED PANEL RADIO BANDED TO ARM AND CAMERA MOUNTING BRACKET. RADIOS ARE AS INDICATED IN PROJECT SPECIAL PROVISIONS AND PLANS.
- 2. INSTALL 1 INCH RISER WITH HEAT-SHRINK TUBING ON POLE. ROUTE COAXIAL ANTENNA CABLE FROM CABINET THROUGH RISER TO RADIO/ANTENNA.
- 3. COMPLY WITH NESC CLEARANCE REQUIREMENTS. MAINTAIN 12" CLEARANCE BETWEEN NON-POWER ATTACHMENTS (COMMUNICATIONS CABLES, CATV, ETC.) AND THE TOP OF NEW RISER, SIGN, AND ANTENNAS.
- 4. IF STREET LIGHT BRACKET IS NOT EFFECTIVELY GROUNDED, THE MINIMUM CLEARANCE REQUIREMENT IS INCREASED TO 40" BELOW DRIP LOOP.



|Burlington-Graham Signal System| CCTV and Radio Building Mounting


Burlington & Graham Division 7 Alamance County

June 2018 REVIEWED BY: HA Badgett JW/AH REVIEWED BY: BJ Slocum '50 Greenfield Parkway, Garner, NC 27529 REVISIONS INIT. DATE NTS

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U-6015

## CABLE ENTRANCE PLAN VIEW

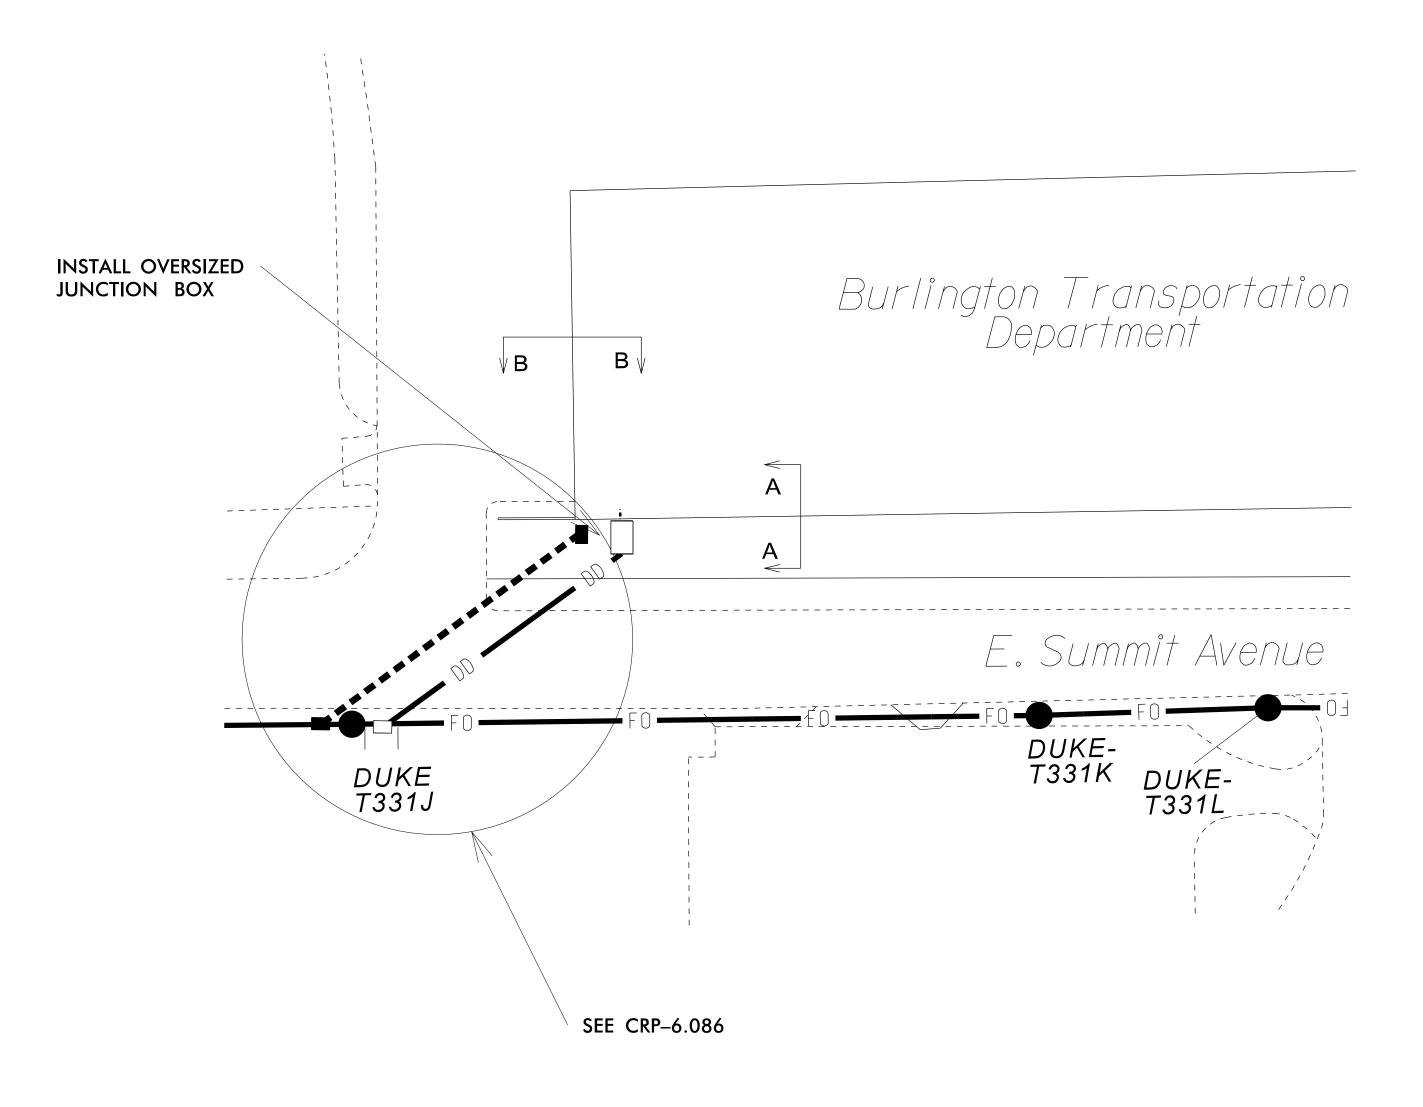

- SEE ITS-5.17 FOR CONDUIT ENTRANCE DETAILS.
- 2. SEE ITS-5.17 FOR SECTION A-A AND B-B VIEWS.

ATKINS 1616 EAST MILLBROOK ROAD, SUITE 160 RALEIGH, NORTH CAROLINA 27609 (919) 876-6888 NCBEES #F-0326

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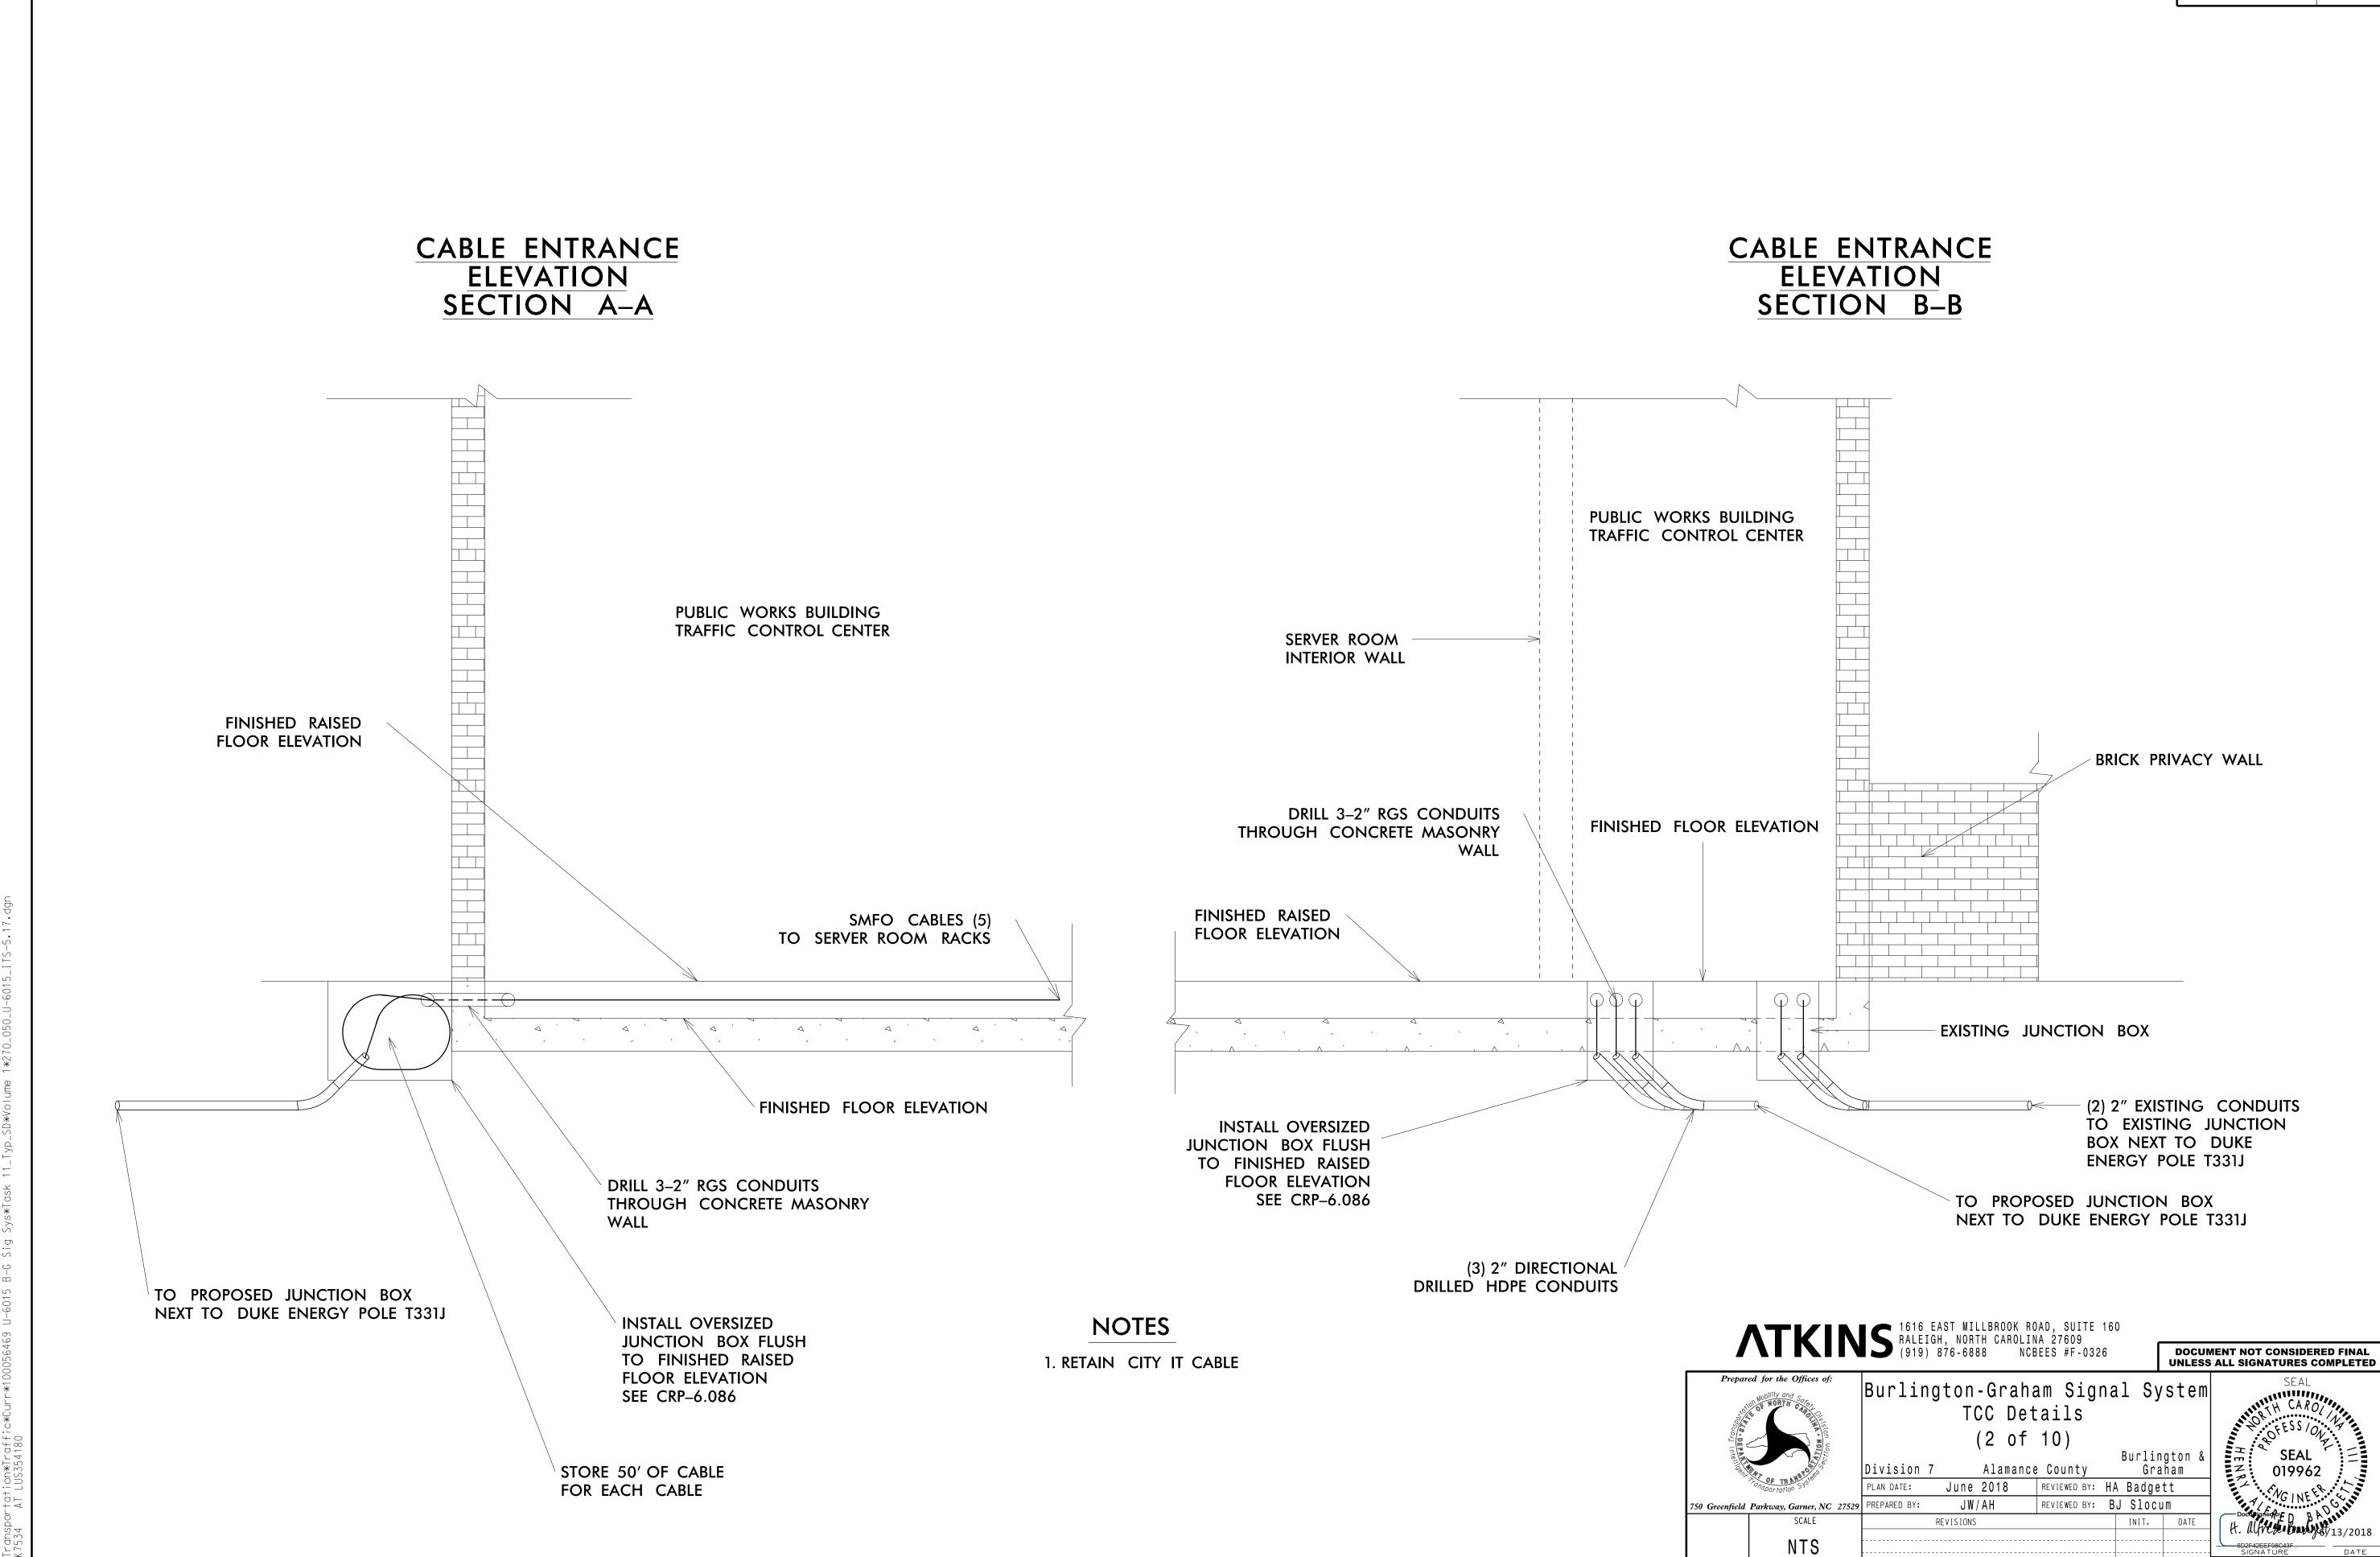
Burlington-Graham Signal System TCC Details

(1 of 10)

Burlington & Graham Division 7 Alamance County June 2018 REVIEWED BY: HA Badgett


REVIEWED BY: BJ Slocum JW/AH REVISIONS

ITS-5.17 U-6015 BRICK PRIVACY WALL (2) 2" EXISTING CONDUITS TÓ EXISTING JUNCTION BOX NEXT TO DUKE ENERGY POLE T331J DOCUMENT NOT CONSIDERED FINAL UNLESS ALL SIGNATURES COMPLETED Burlington & Graham



U-6015 ITS-5.18

#### CONDUIT PLAN VIEW

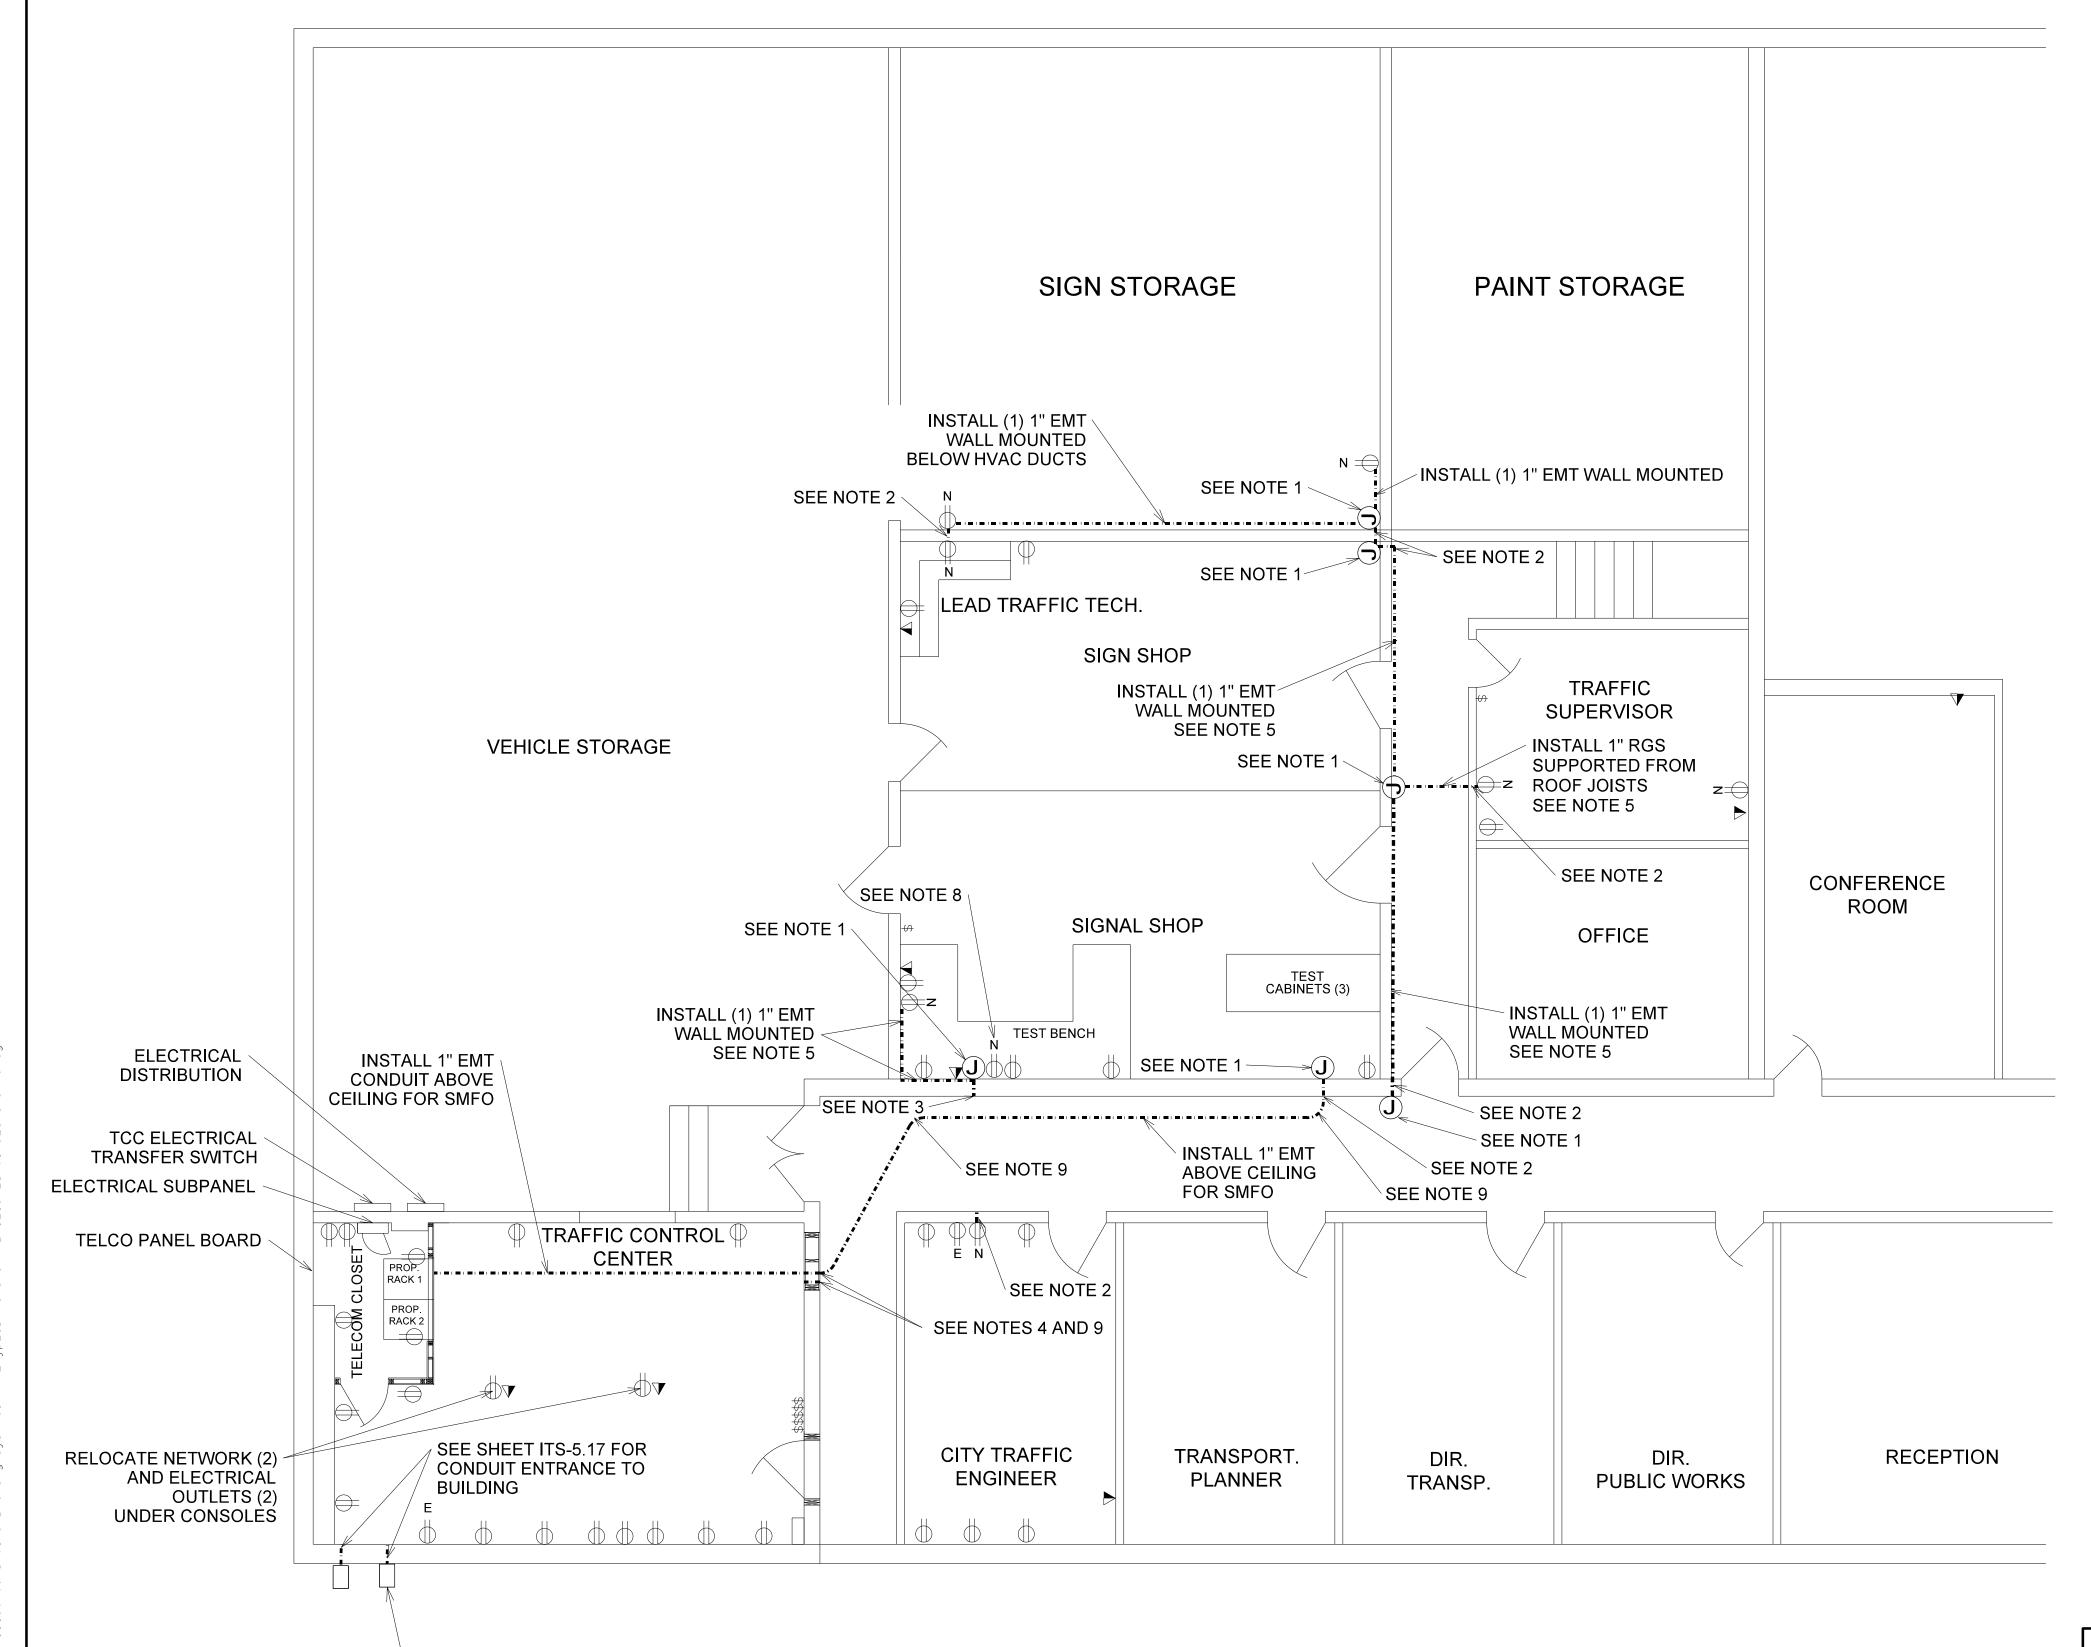

PROPOSED OVERSIZED JUNCTION BOX

#### **NOTES:**

- 1. INSTALL WALL MOUNT JUNCTION BOX.
- 2. INSTALL 1" EMT CONDUIT THROUGH WALL, SEAL WITH FIRESTOP.
- 3. INSTALL 2" EMT CONDUIT THROUGH WALL, SEAL WITH FIRESTOP.
- 4. INSTALL 1–1" AND 1–2" EMT CONDUIT THROUGH WALL, SEAL WITH FIRESTOP.
- 5. INSTALL CONDUIT 9' ABOVE FINISHED FLOOR.
- 6. INSTALL ALL CABLING SUPPORTED BY CABLE HANGERS ATTACHED TO ROOF JOISTS.
- 7. SEAL CONDUIT SLEEVES THROUGH WALLS WITH FIRESTOP AFTER ALL CABLE INSTALLATION.
- 8. INSTALL QUAD NETWORK OUTLET BOX.
- 9. INSTALL EMT CONDUIT FOR FIBER OPTIC CABLE WITH BEND RADIUS OF AT LEAST 6".

#### LEGEND

- EXIST. ELECTRICAL OUTLET
- ▼ EXIST. NETWORK OUTLET
- \$ EXIST. ELECTRICAL SWITCH
- ⇒

  □ PROP. ELECTRICAL OUTLET
- (J) PROP. JUNCTION BOX
- PROP. WALL
  - PROP. VIDEO WALL
- ⇒z PROP. NETWORK OUTLET
- --- EXIST. NETWORK CABLING
- TWIST PR- PROP. NETWORK CABLING
- —F0 PROP. FIBER-OPTIC CABLING
- EXIST. FIBER-OPTIC CABLING

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Burlington-Graham Signal System
TCC Details
(3 of 10)

Burlington & Sion 7 Alamance County Graham

ATE: June 2018 REVIEWED BY: HA Badgett

PREPARED BY: JW/AH REVIEWED BY: BJ Slocum

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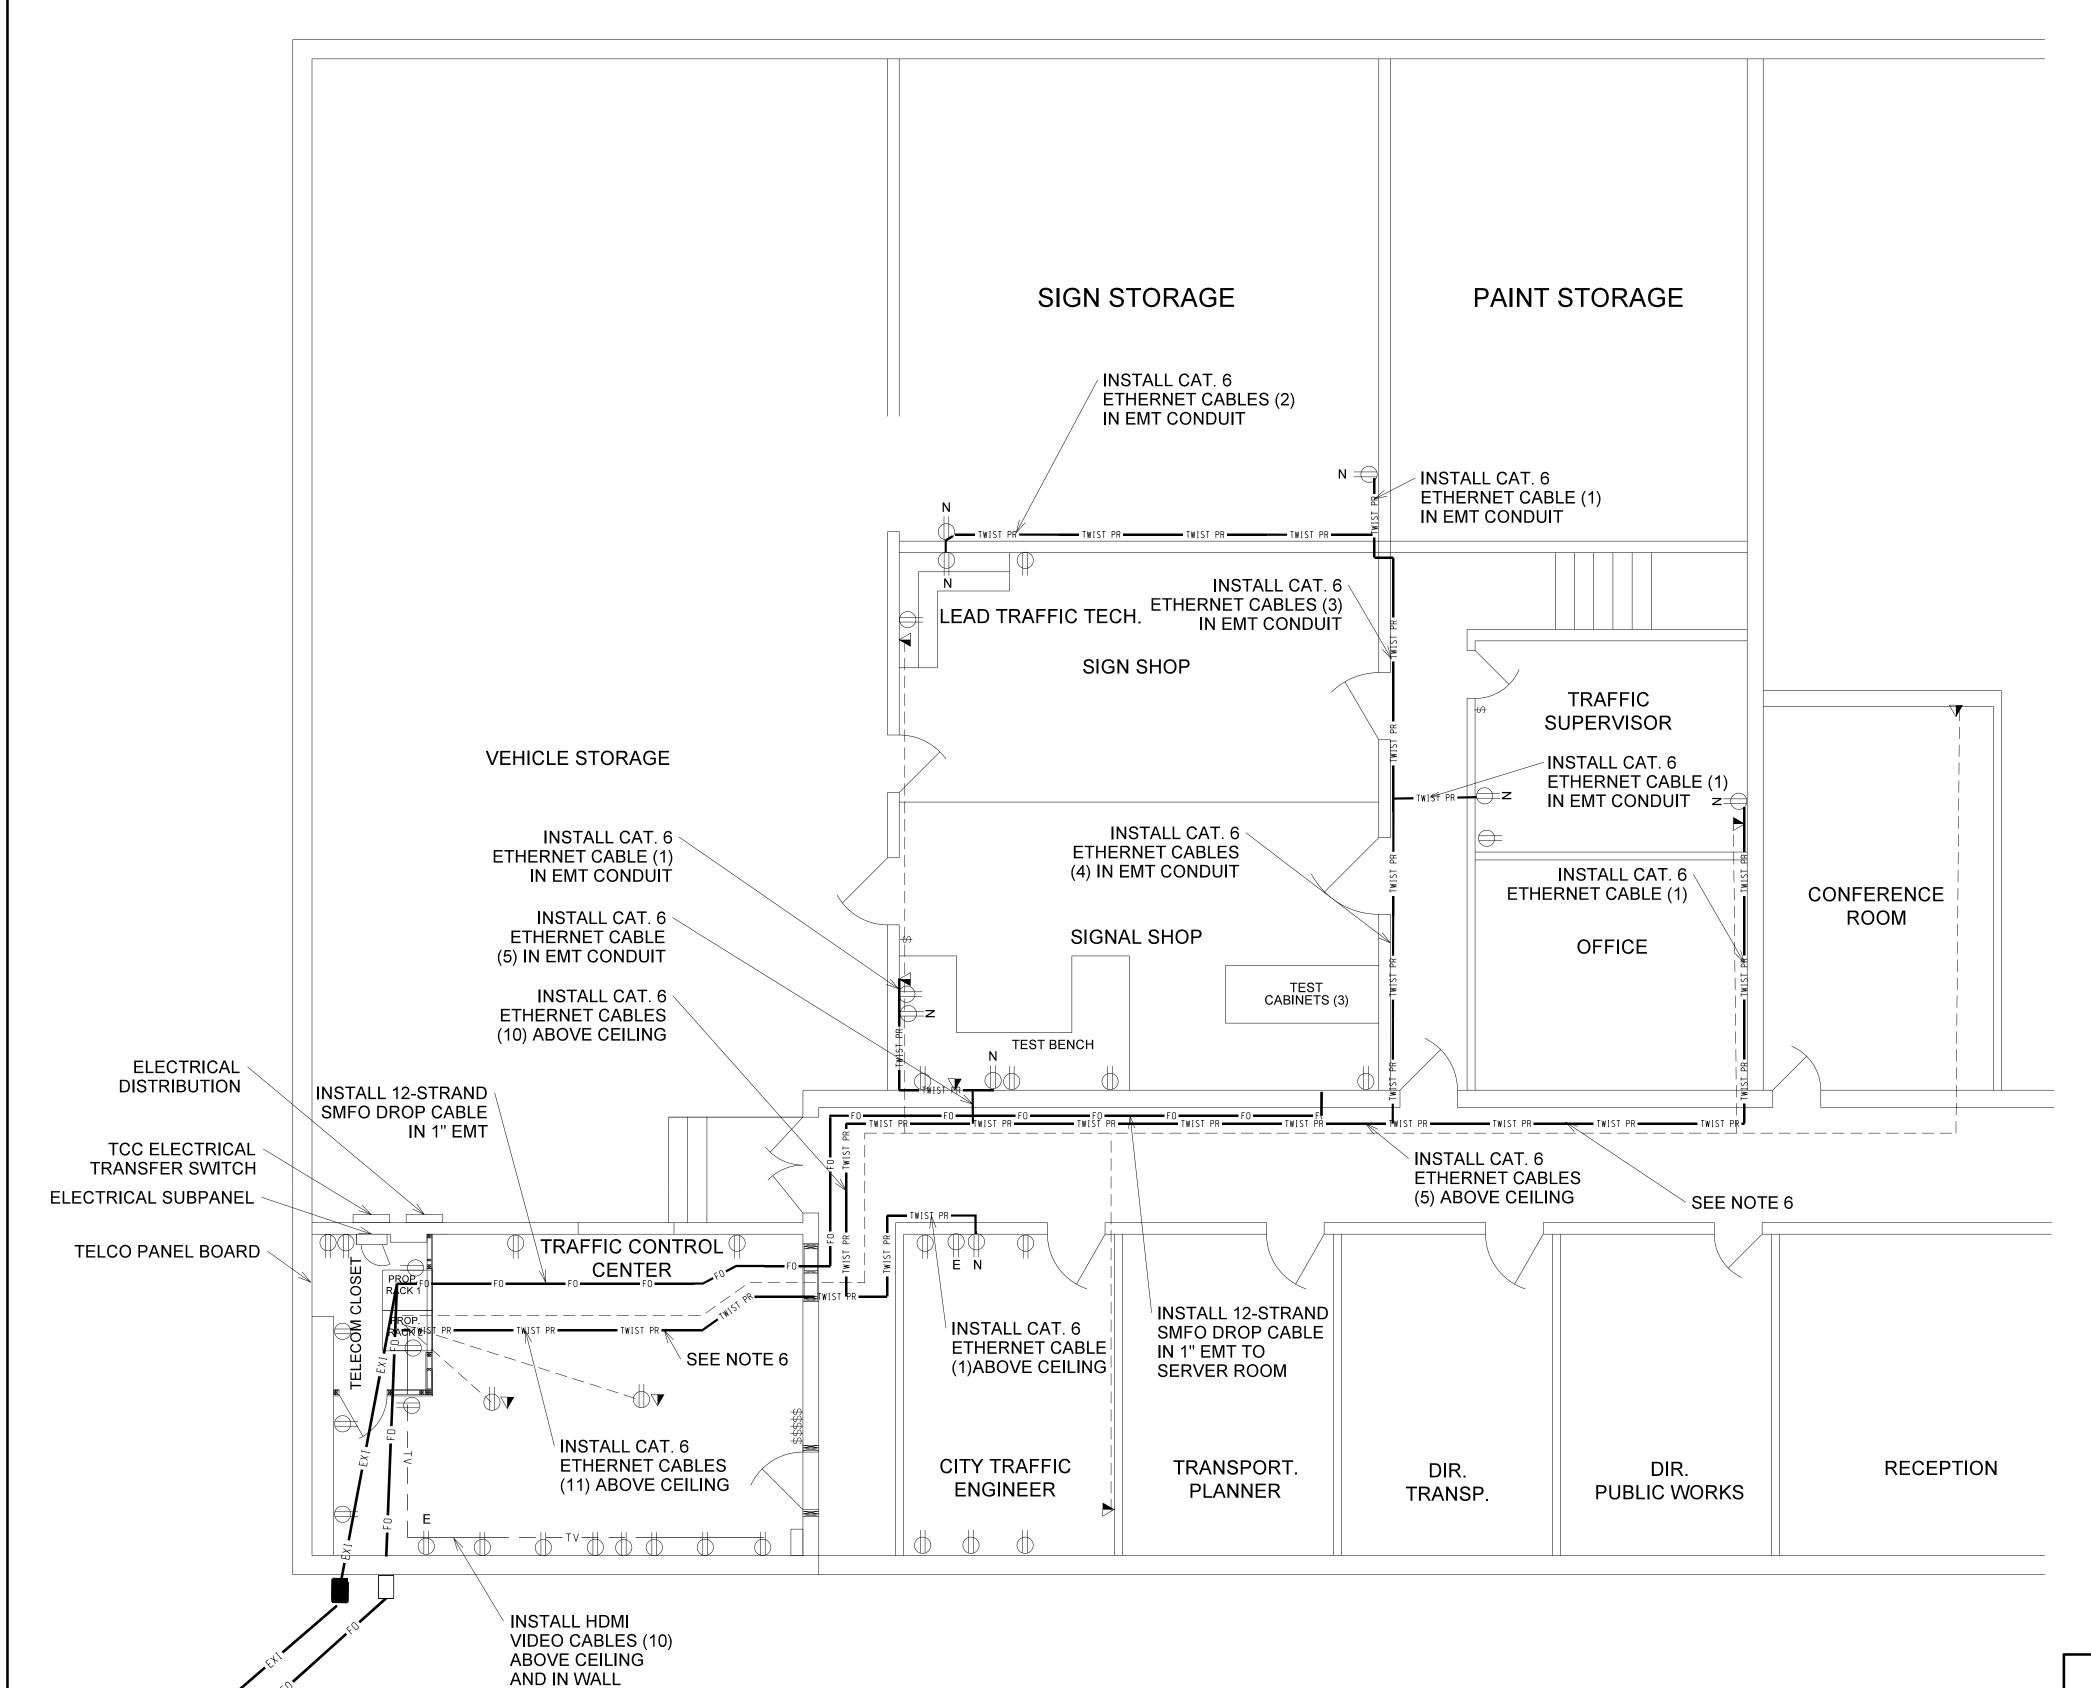
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#### CABLING PLAN VIEW

PROJECT REFERENCE NO. ITS-5.19 U-6015



#### **NOTES:**

- 1. INSTALL WALL MOUNT JUNCTION BOX.
- 2. INSTALL 1" EMT CONDUIT THROUGH WALL, SEAL WITH FIRESTOP.
- 3. INSTALL 2" EMT CONDUIT THROUGH WALL, SEAL WITH FIRESTOP.
- 4. INSTALL 2-2" EMT CONDUIT THROUGH WALL, SEAL WITH FIRESTOP.
- 5. INSTALL CONDUIT 9' ABOVE FINISH FLOOR.
- 6. INSTALL ALL CABLING SUPPORTED BY CABLE HANGERS ATTACHED TO ROOF JOISTS.
- 7. SEAL CONDUIT SLEEVES THROUGH WALLS WITH FIRESTOP AFTER ALL CABLE INSTALLATION.
- 8. INSTALL CABLING TO CONSOLES UNDER EXISTING RAISED FLOOR.
- 9. INSTALL VIDEO WALL CABLING ABOVE CEILING.


#### LEGEND

- EXIST. ELECTRICAL OUTLET
- EXIST. NETWORK OUTLET
- EXIST. ELECTRICAL SWITCH
- ⇒

  □ PROP. ELECTRICAL OUTLET
- PROP. JUNCTION BOX
- PROP. WALL
- PROP. VIDEO WALL
- ⇒z PROP. NETWORK OUTLET
- EXIST. NETWORK CABLING
- TWIST PR- PROP. NETWORK CABLING
- TV— PROP. VIDEO CABLING
  - PROP. FIBER-OPTIC CABLING
- EXIST. FIBER-OPTIC CABLING

ATKINS 1616 EAST MILLBROOK ROAD, SUITE 160 RALEIGH, NORTH CAROLINA 27609 (919) 876-6888 NCBEES #F-0326

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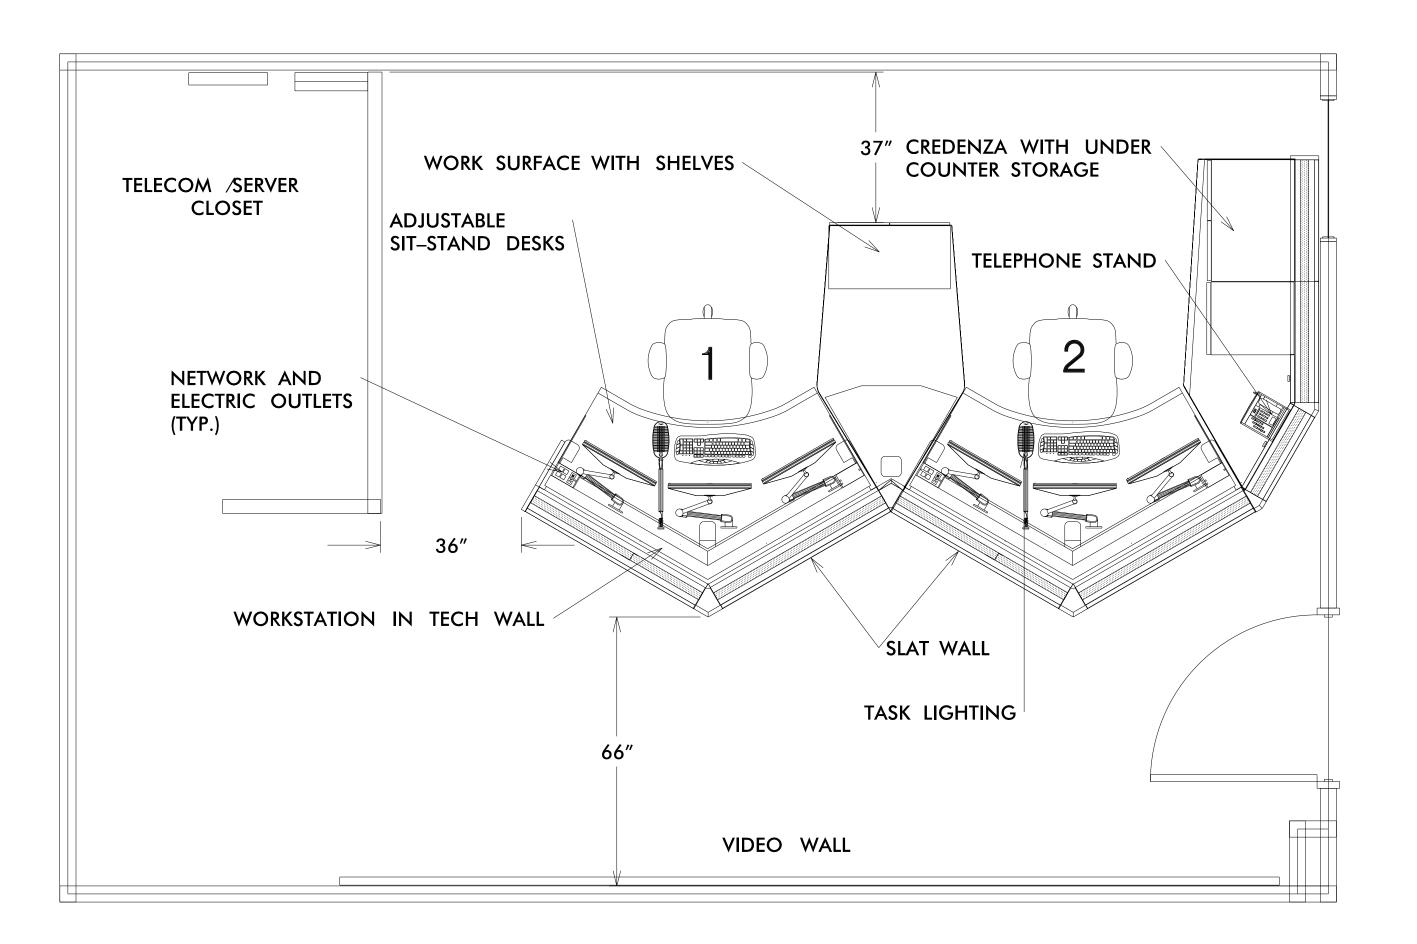
Burlington-Graham Signal System TCC Details

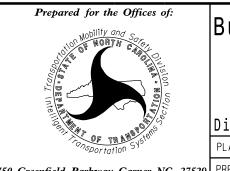(4 of 10) Burlington & Division 7 Alamance County Graħam June 2018 REVIEWED BY: HA Badgett

REVIEWED BY: BJ Slocum 50 Greenfield Parkway, Garner, NC 27529 PREPARED BY: JW/AH REVISIONS INIT. DATE CADD Filename: 270\_051\_U-6015.

U-6015 ITS-5.20

#### CONSOLE LAYOUT




ATKINS 1616 EAST MILLBROOK ROAD, SUITE 160 RALEIGH, NORTH CAROLINA 27609 (919) 876-6888 NCBEES #F-0326 DOCUMENT NOT CONSIDERED FINAL UNLESS ALL SIGNATURES COMPLETED Burlington-Graham Signal System TCC Details (5 of 10)

Burlington & Graham Alamance County June 2018 REVIEWED BY: HA Badgett JW/AH REVIEWED BY: BJ Slocum

REVISIONS INIT. DATE

PROJECT REFERENCE NO. ITS-5.21 U-6015

#### EQUIPMENT PLAN VIEW

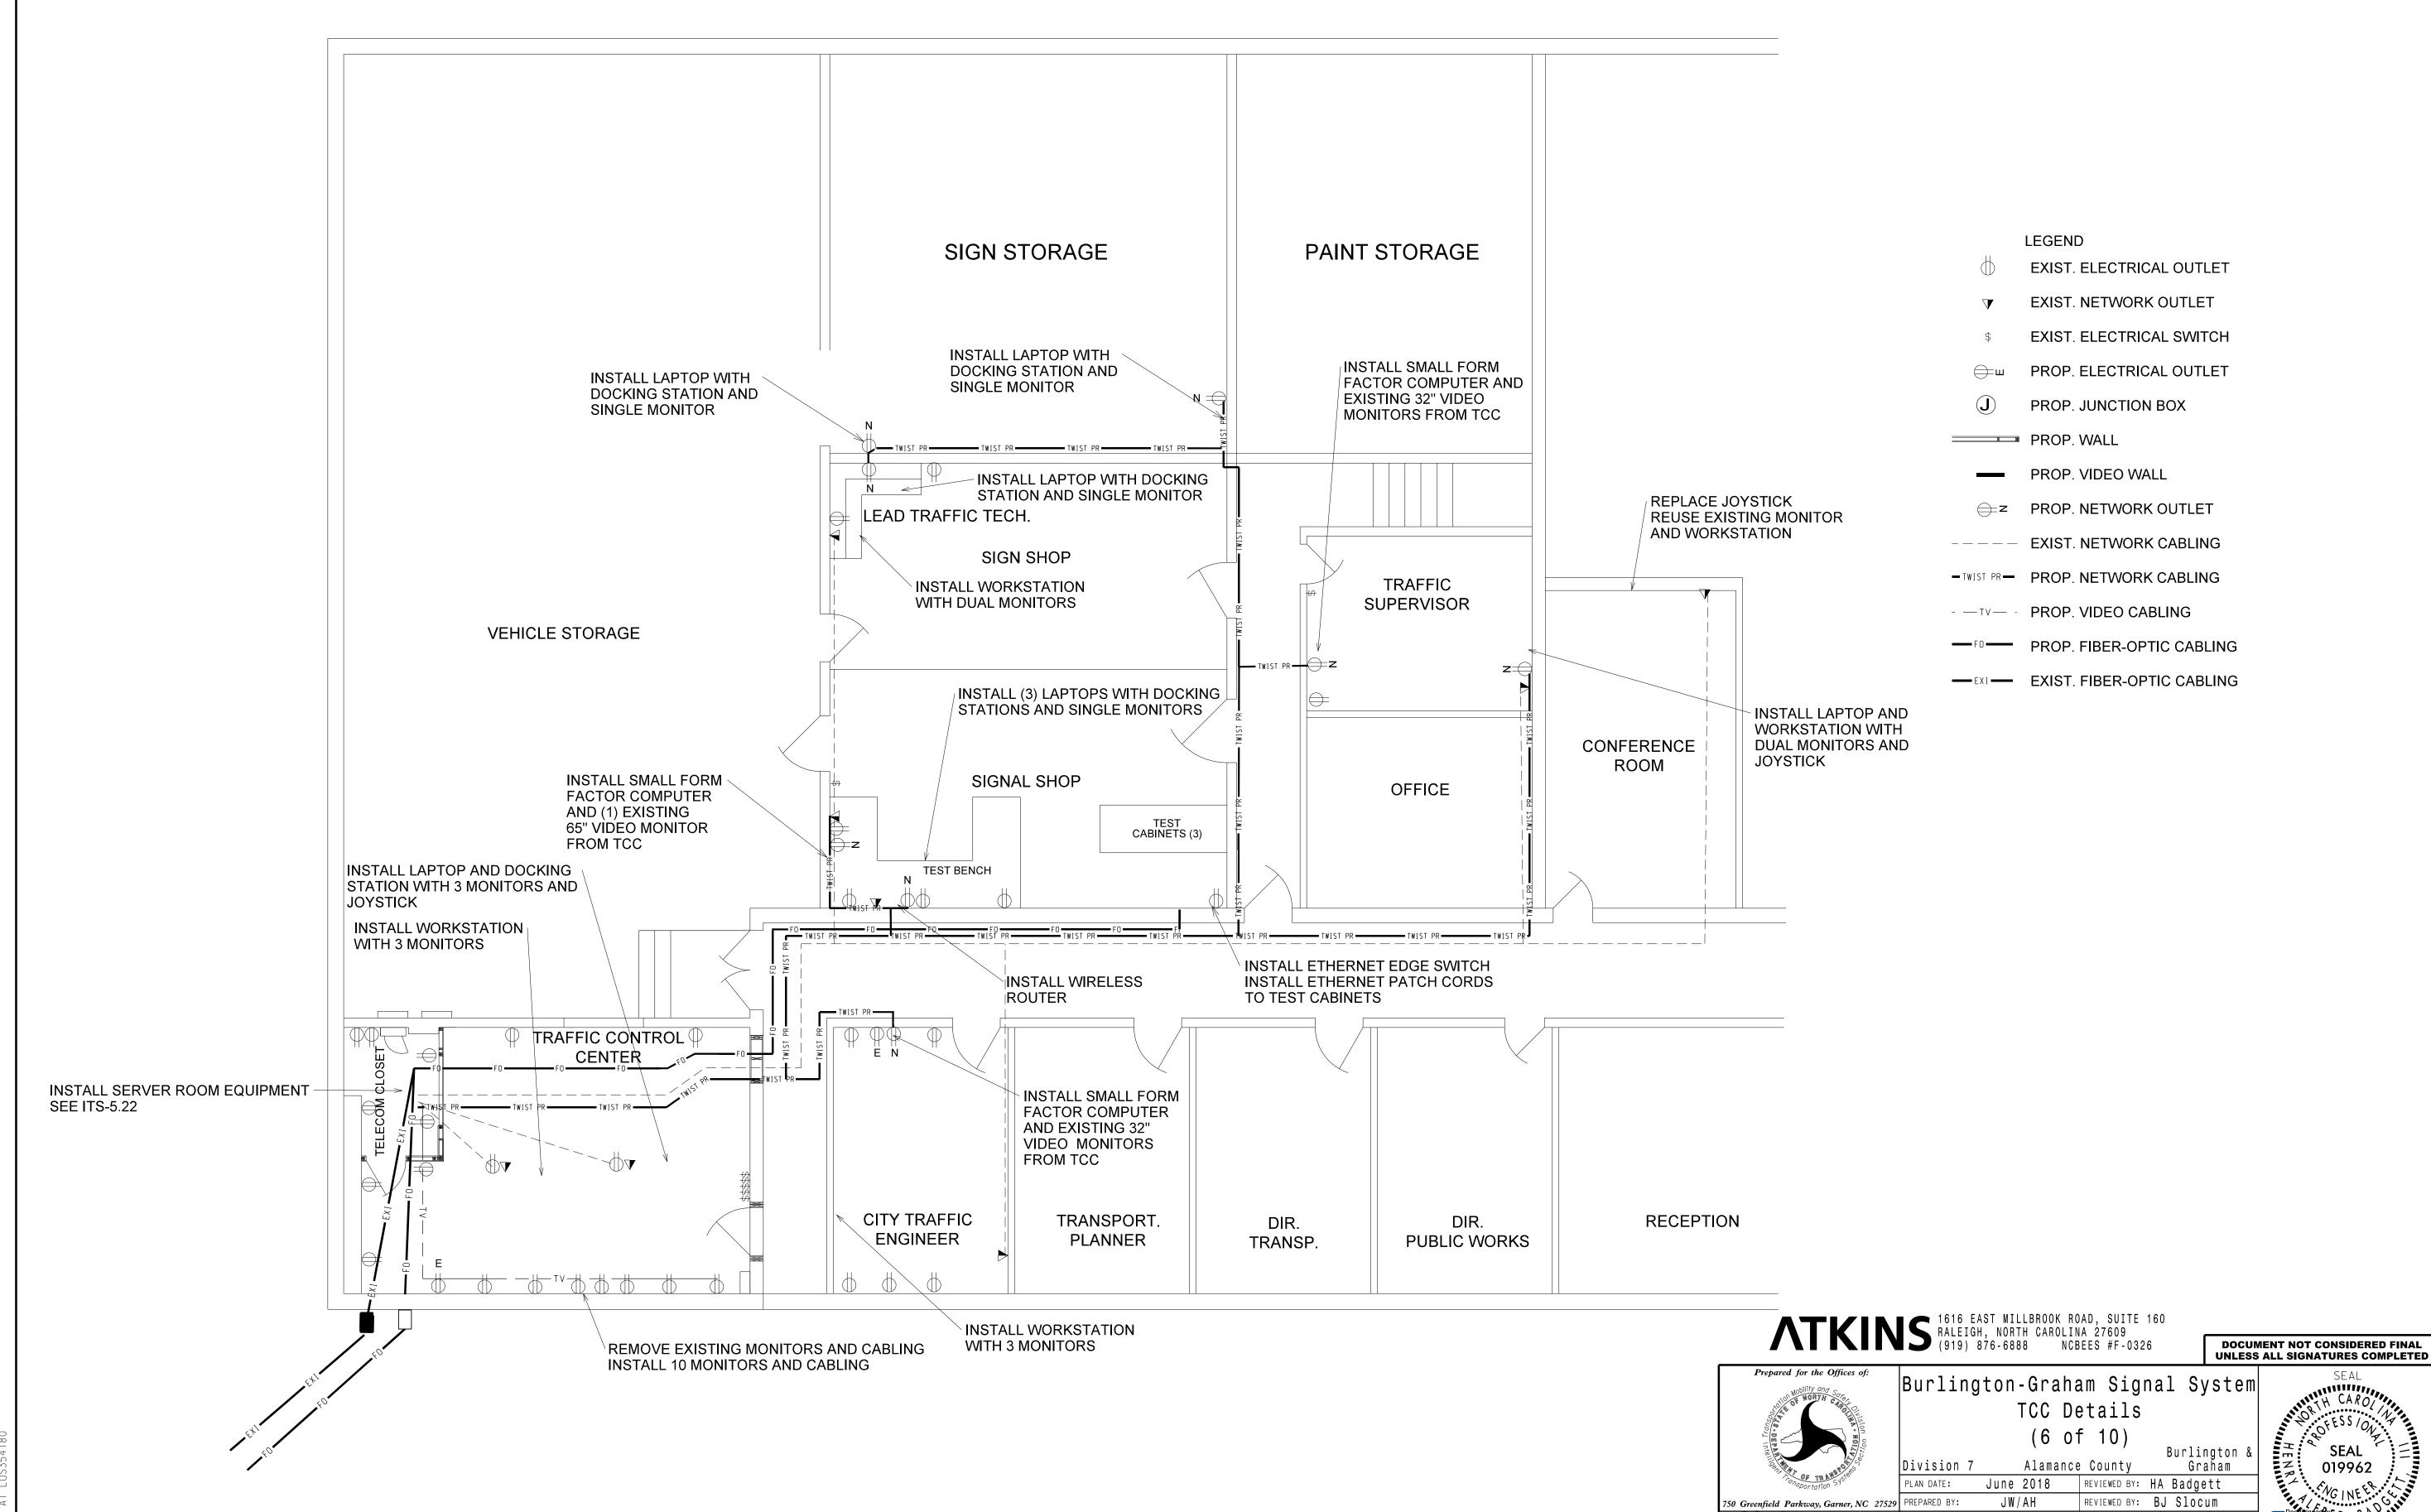


CADD Filename: 270\_053\_U-6015.

REVISIONS

INIT. DATE


U-6015

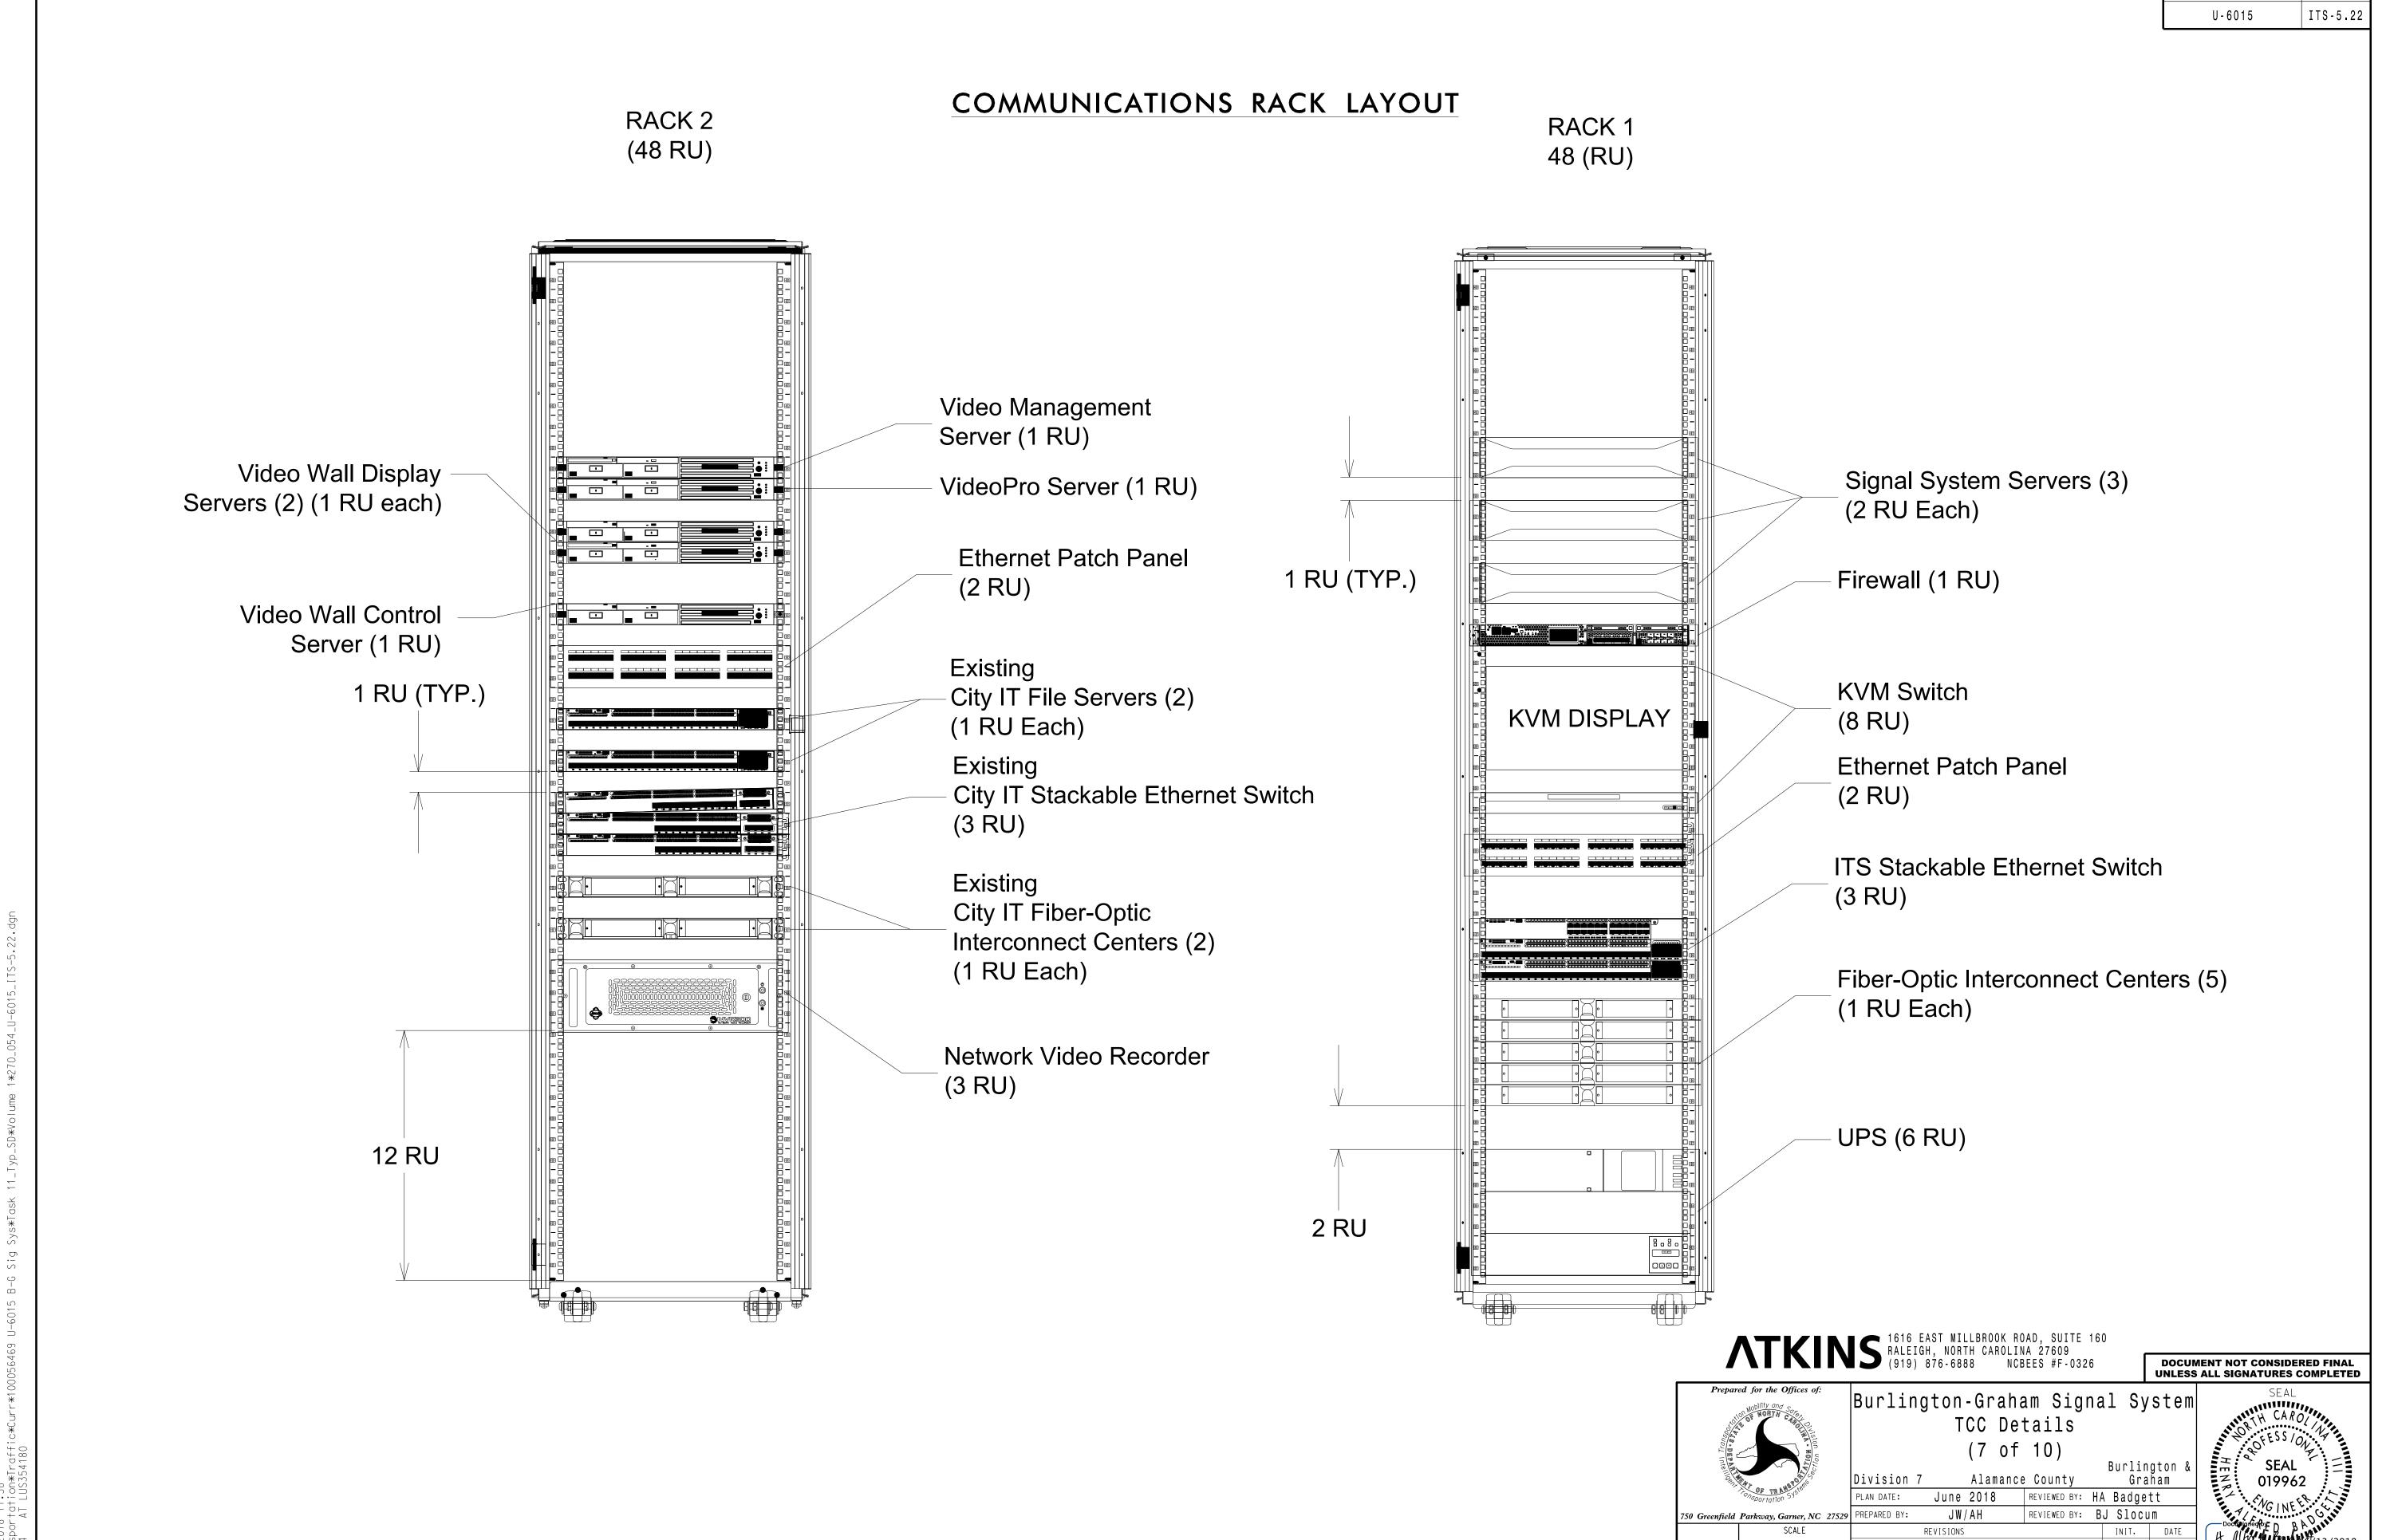

NTS

ITS-5.23 U-6015

#### VIDEO WALL ELEVATION VIEW

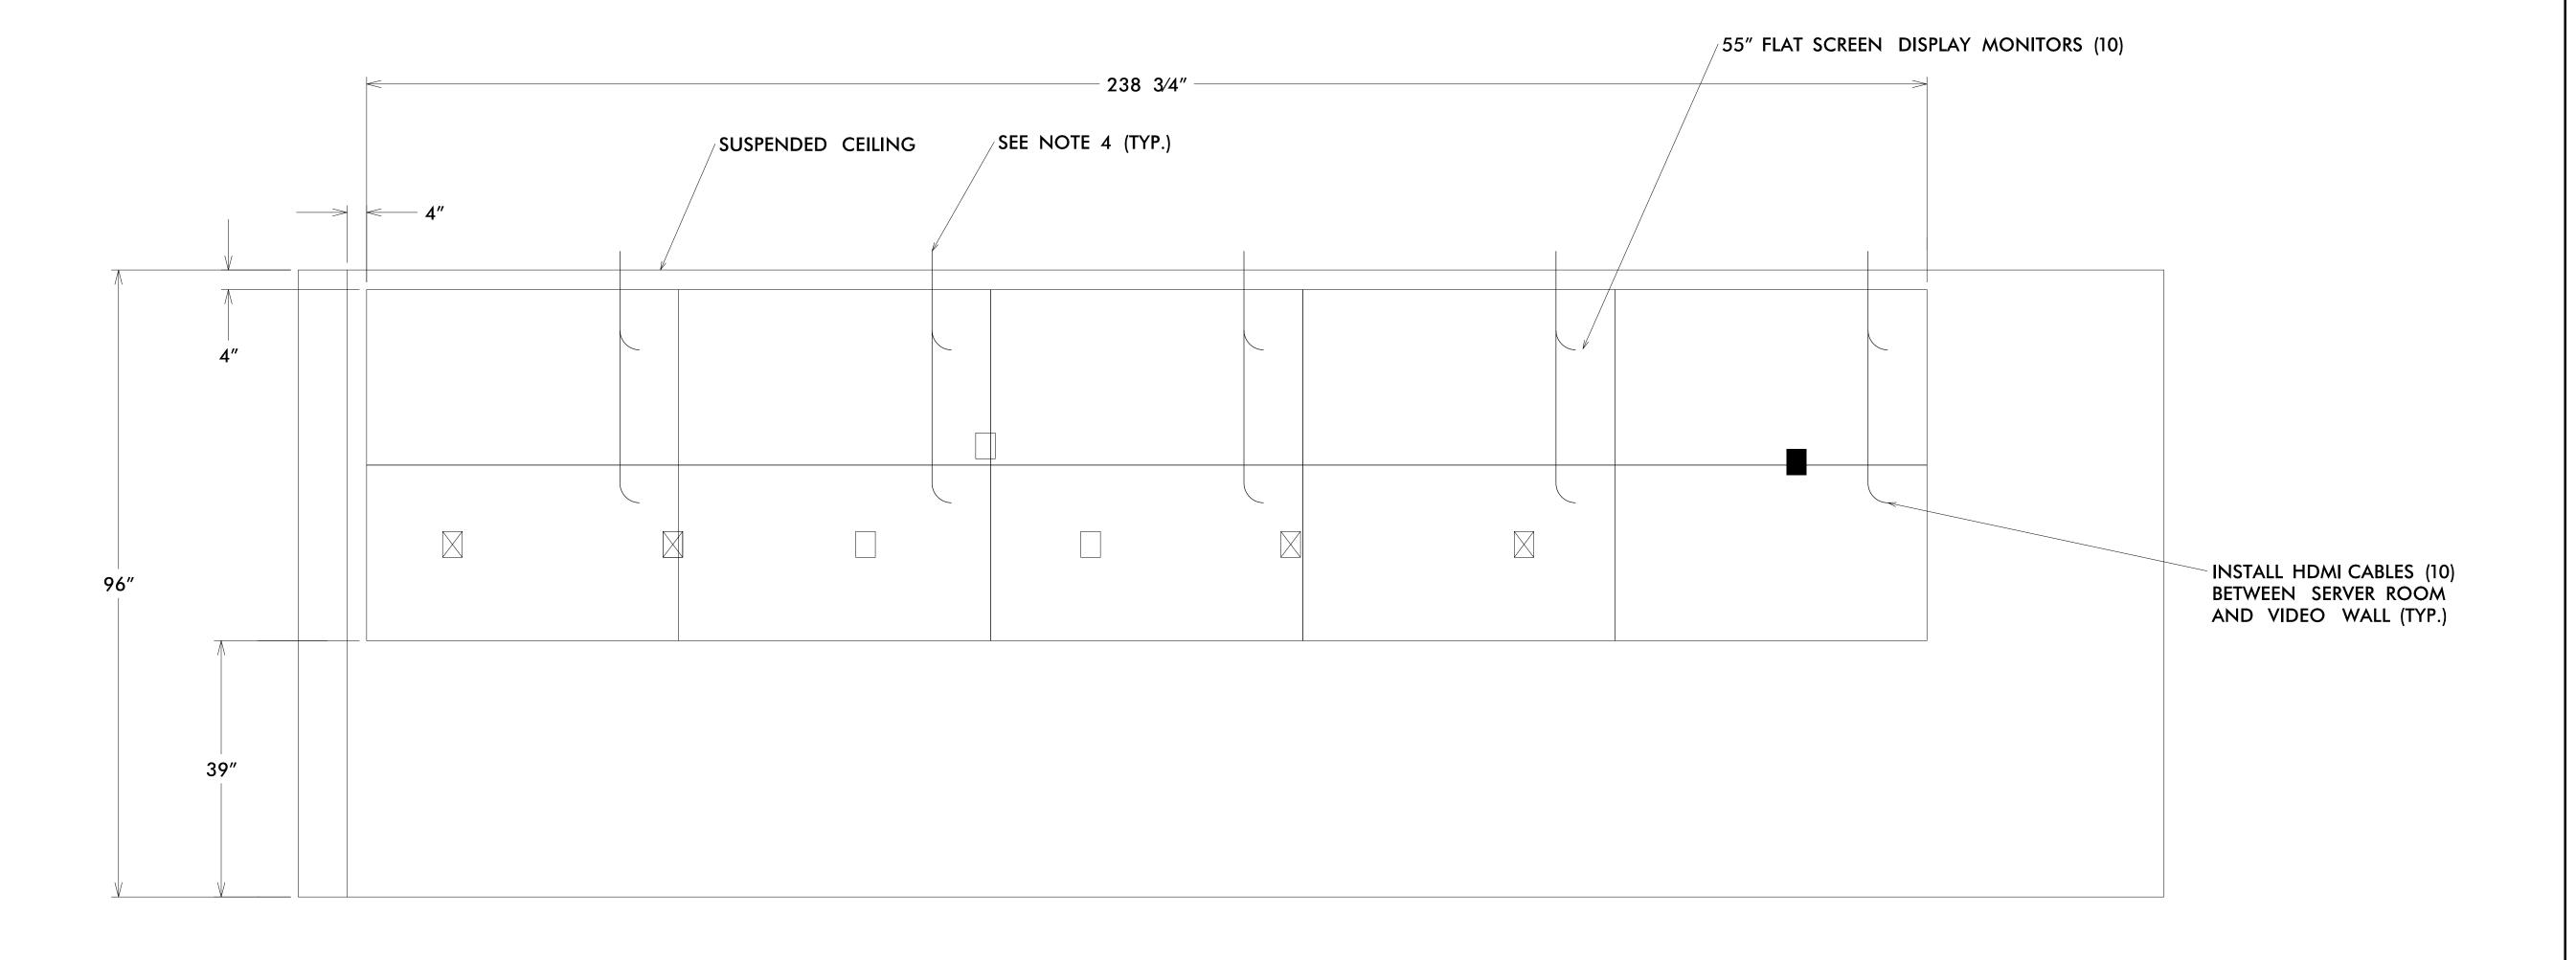

LEGEND

EXISTING ELECTRICAL QUAD OUTLET BOX

EXISTING ELECTRICAL DUPLEX OUTLET BOX

PROPOSED ELECTRICAL DUPLEX OUTLET BOX (BY OTHERS)

1. ELECTRICAL OUTLETS TO BE INSTALLED BY OTHERS.

2. REMOVE OLD MONITORS AND MOUNTING BRACKETS, REUSE AS SHOWN IN PLANS.

3. REMOVE OLD VIDEO CABLE AND MONITOR POWER CORDS BEFORE INSTALLING NEW MONITORS. 4. INSTALL NEW HDMI VIDEO CABLING ABOVE SUSPENDED CEILING TO SERVER RACKS.

5. INSTALL NEW MONITORS FROM LEFT TO RIGHT. 6. ALIGN MONITORS VERTICALLY AND HORIZONTALLY FOR ZERO CLEARANCE.

7. UTILIZE EXISTING AND PROPOSED ELECTRICAL OUTLETS.

8. INSTALL HDMI CABLE BETWEEN DISPLAY SERVER OUTPUT AND RESPECTIVE MONITOR.

ATKINS 1616 EAST MILLBROOK ROAD, SUITE 160 RALEIGH, NORTH CAROLINA 27609 (919) 876-6888 NCBEES #F-0326

DOCUMENT NOT CONSIDERED FINAL UNLESS ALL SIGNATURES COMPLETED



Burlington-Graham Signal System TCC Details (8 of 10)


Burlington & Graham Alamance County June 2018 REVIEWED BY: HA Badgett


JW/AH REVIEWED BY: BJ Slocum REVISIONS NTS

ITS-5.24 U-6015

#### CITY TRAFFIC ENGINEER MONITOR WALL ELEVATION VIEW

#### TRAFFIC SUPERVISOR MONITOR WALL ELEVATION VIEW

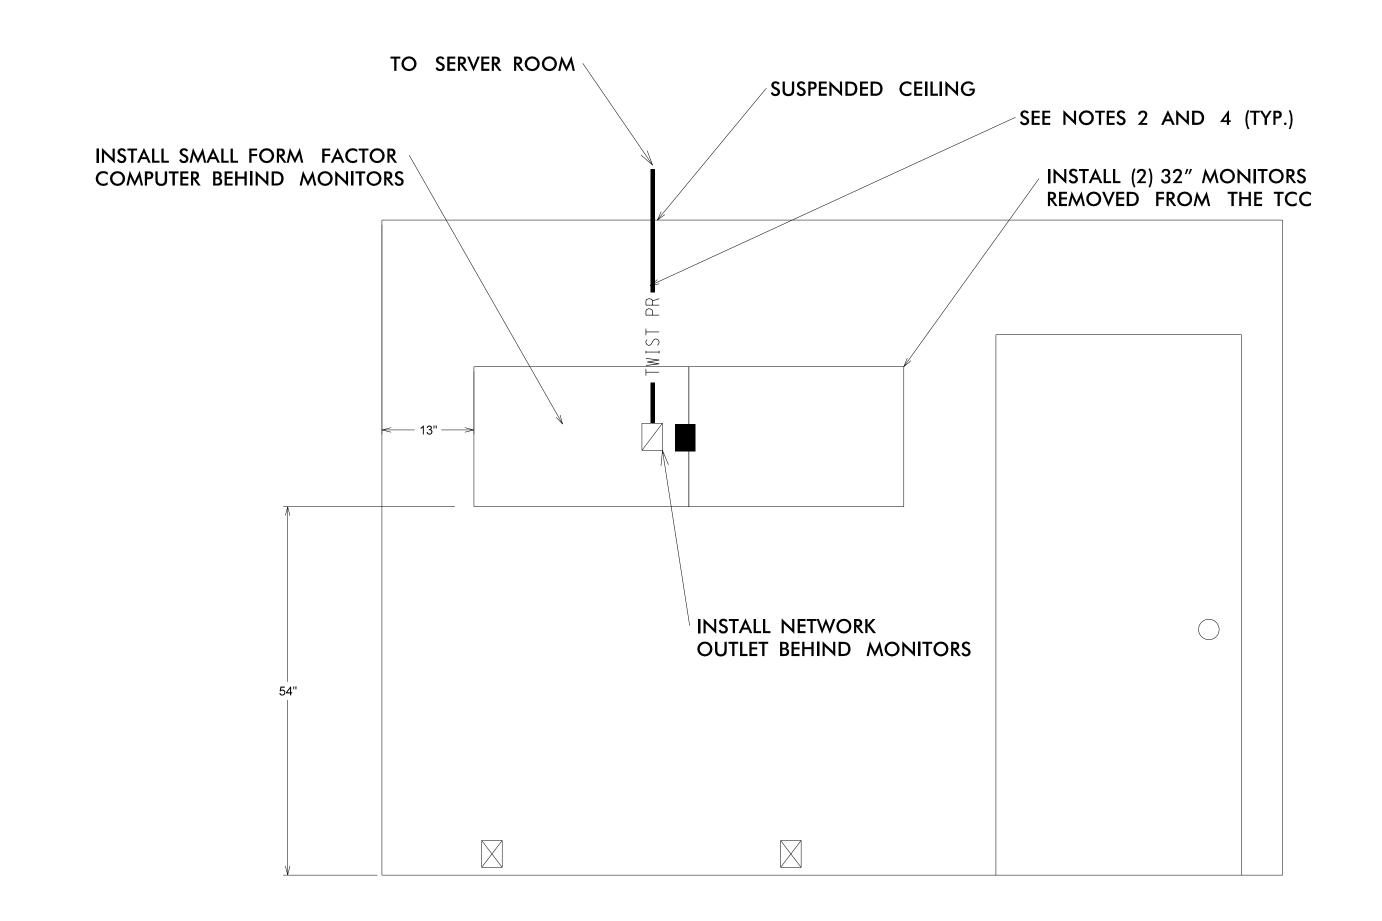

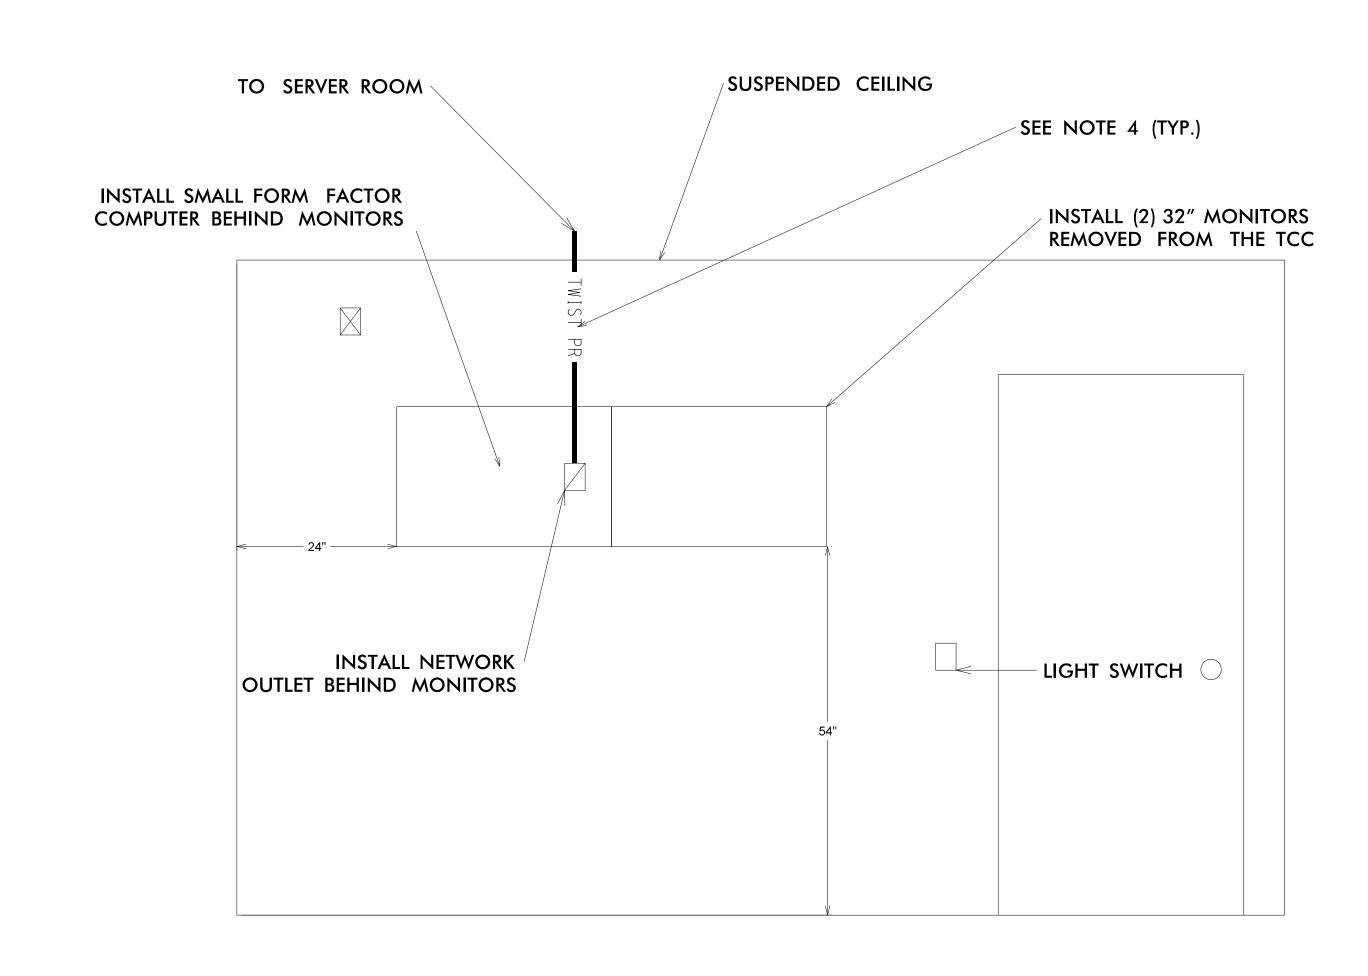

LEGEND

EXISTING ELECTRICAL QUAD OUTLET BOX

EXISTING ELECTRICAL DUPLEX OUTLET BOX

PROPOSED ELECTRICAL DUPLEX OUTLET BOX (BY OTHERS)

PROPOSED NETWORK OUTLET

NOTES

1. ELECTRICAL OUTLETS TO BE INSTALLED BY OTHERS.

2. INSTALL NEW NETWORK CABLING ABOVE SUSPENDED CEILING TO

SERVER RACKS.

3. INSTALL NETWORK OUTLETS BEHIND MONITORS

4. INSTALL NEW NETWORK CABLING FROM ABOVE CEILING THROUGH

WALL TO NETWORK OUTLET. SEE ITS-5.19.

5. ALIGN MONITORS HORIZONTALLY.

6. UTILIZE EXISTING AND PROPOSED ELECTRICAL OUTLETS.

7. INSTALL SMALL FORM FACTOR COMPUTER ON WALL BEHIND MONITORS TO DRIVE WALL MONITORS.

8. INSTALL HDMI CABLING BETWEEN EACH MONITOR AND SMALL FORM FACTOR COMPUTER.


ATKINS 1616 EAST MILLBROOK ROAD, SUITE 160 RALEIGH, NORTH CAROLINA 27609 (919) 876-6888 NCBEES #F-0326

DOCUMENT NOT CONSIDERED FINAL **UNLESS ALL SIGNATURES COMPLETED** 

Burlington-Graham Signal System TCC Details (9 of 10) Burlington & Graham Alamance County June 2018 REVIEWED BY: HA Badgett JW/AH REVIEWED BY: BJ Slocum REVISIONS NTS

ITS-5.25 U-6015

#### SIGNAL SHOP MONITOR NORTHWEST ELEVATION VIEW

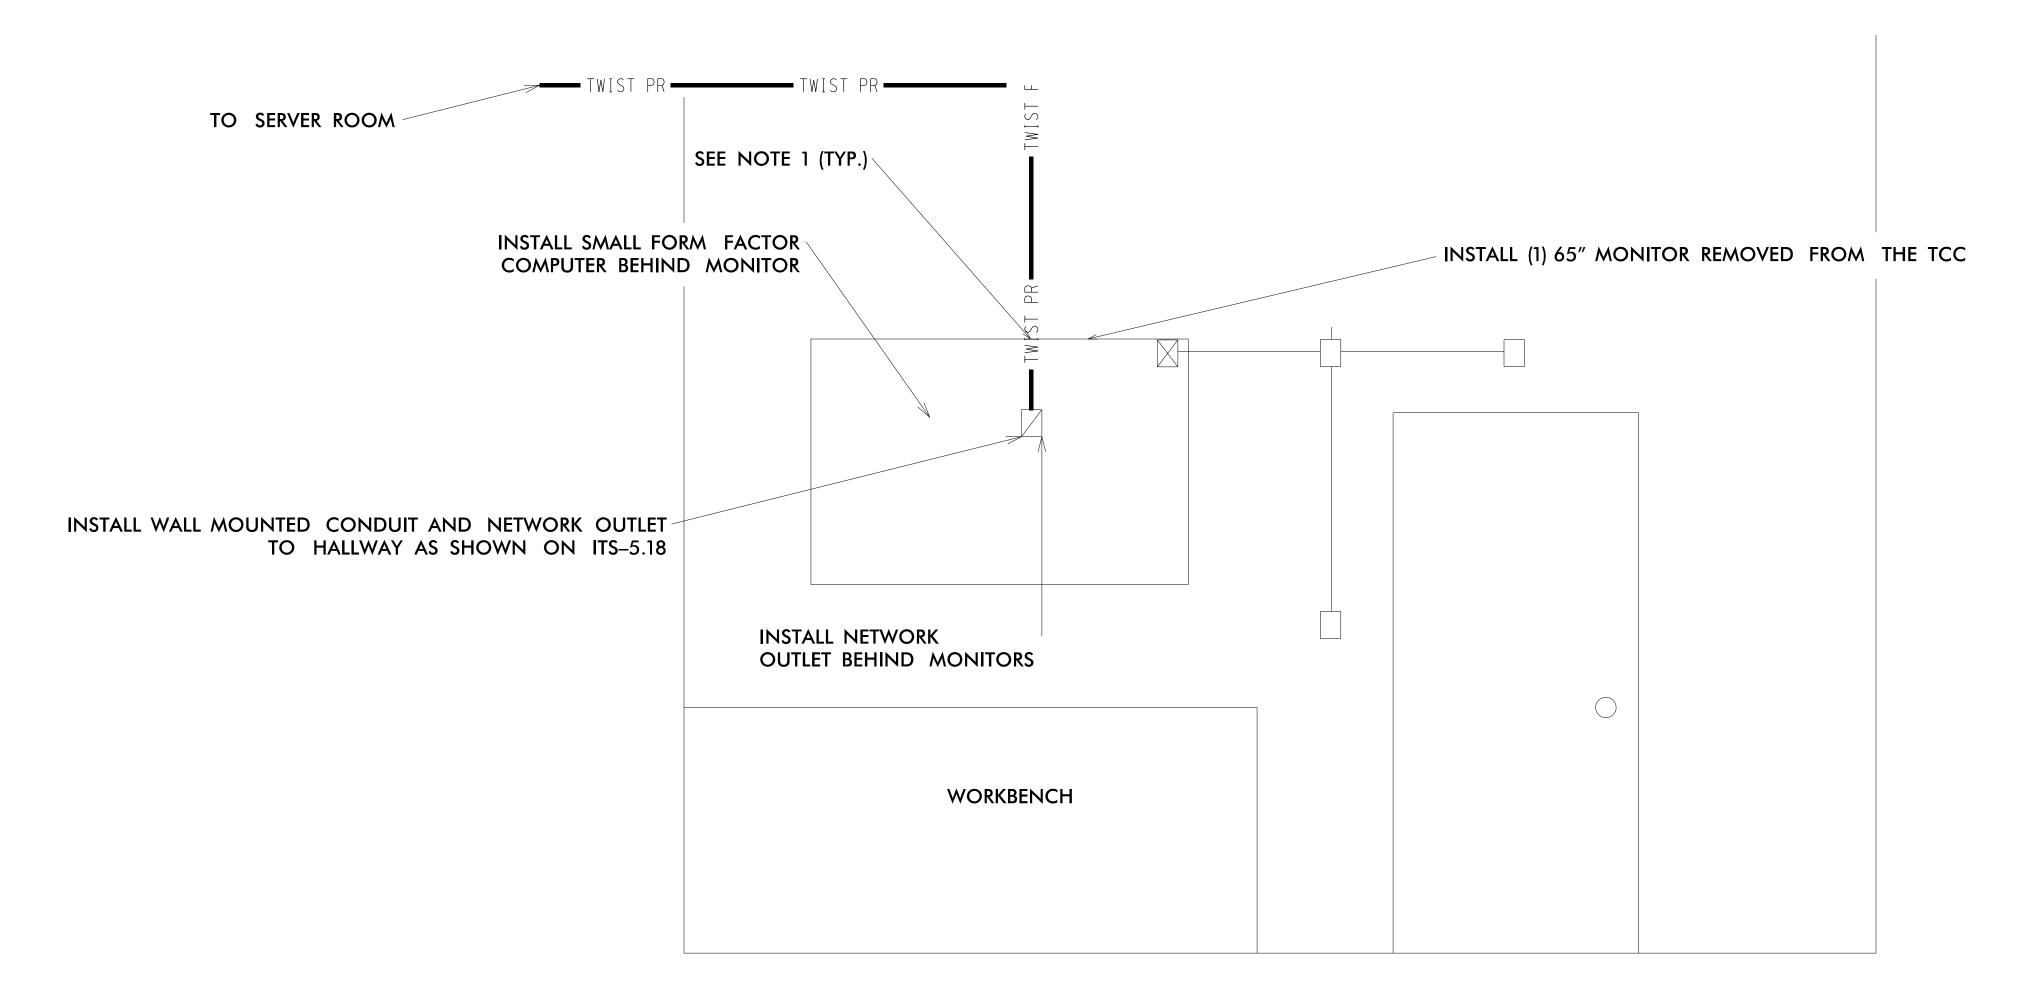

LEGEND

EXISTING ELECTRICAL SWITCH OR JUNCTION BOX

EXISTING ELECTRICAL DUPLEX OUTLET BOX

PROPOSED ELECTRICAL DUPLEX OUTLET BOX (BY OTHERS)


PROPOSED NETWORK OUTLET

#### NOTES

- 1. INSTALL NEW NETWORK CABLING IN WALL MOUNTED CONDUIT AND NETWORK OUTLET TO SERVER ROOM AS SHOWN ON ITS-5.18.
- 2. UTILIZE EXISTING AND PROPOSED ELECTRICAL OUTLETS.
- 3. INSTALL SMALL FORM FACTOR COMPUTER BEHIND PROPOSED MONITOR.
- 4. INSTALL HDMI CABLE BETWEEN EACH MONITOR AND SMALL FORM FACTOR COMPUTER.

ATKINS 1616 EAST MILLBROOK ROAD, SUITE 160 RALEIGH, NORTH CAROLINA 27609 (919) 876-6888 NCBEES #F-0326

DOCUMENT NOT CONSIDERED FINAL UNLESS ALL SIGNATURES COMPLETED

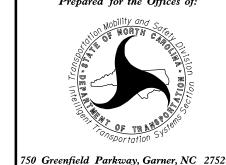

Burlington-Graham Signal System TCC Details (10 of 10)

Burlington & Graham Alamance County June 2018 REVIEWED BY: HA Badgett

JW/AH REVIEWED BY: BJ Slocum REVISIONS NTS

	MESSENGER CABLE (1/4")	BOND MESSENGER CABLE	TRACER WIRE	UNDERGROUND CONDUIT (1 CONDUIT, 1 INCH)	UNDERGROUND CONDUIT (1 CONDUIT, 2 INCH)	UNDERGROUND CONDUIT (2 CONDUIT, 2 INCH)	DIRECTIONAL DRILL (2 CONDUIT, 2 INCH)					REMOVE EXISTING JUNCTION BOX	DELINEATOR MARKER	STANDARD GUY ASSEMBLY	AERIAL GUY ASSEMBLY	SIDEWALK GUY ASSEMBLY	1" RISER WITH WEATHERHEAD FOR CCTV ELEC SERVICE	1" RISER WITH WEATHERHEAD FOR CAT 6	1.25" RISER WITH HEAT SHRINK TUBING	2" RISER WITH HEAT SHRINK TUBING	HEAT SHRINK TUBING KIT		DRILL/ CORE DRILL EXIST FOUNDATION
	LF	EA	LF	LF	LF	LF	LF	LF	EA	EA	EA	EA	EA	EA	EA	EA	EA	EA	EA	EA	EA	EA	EA
CRP-6.001	1,355	1	-	-	-	-	-	-	-	-	-	-	-	4	-	-	-	-	-	-	1	-	-
CRP-6.002	1,350	1	-	•	-	-	-	-	-	-	-	-	-	3	-	-	-	-	-	•	-	-	-
CRP-6.003	1,165	1	200	-	-	200	-	-	1	-	-	-	-	1	-	-	-	-	-	1	-	-	-
CRP-6.004	785	1	505	•	-	505	-	-	1	-	-	-	-	2	-	-	-	-	-	1	-	-	-
CRP-6.005	365	2	1,530	-	65	-	-	-	1	-	-	-	-	3	-	-	-	-	-	2	1	-	-
CRP-6.006	-	-	1,405	-	-	-	-	-	-	-	-	-	-	-	-	-	-	-	-	-	-	-	-
CRP-6.007	-	2	560	-	-	-	-	200	-	-	3	-	-	-	-	-	-	-	-	-	3	-	1
CRP-6.008	-	1	-	•	-	-	-	-	-	-	-	-	-	-	-	-	-	-	-	-	-	-	-
CRP-6.009	-	1	-	•	-	-	-	-	-	-	-	-	-	-	-	-	-	-	-	-	-	-	-
CRP-6.010	-	1	-	•	-	-	-	-	-	-	-	-	-	1	-	-	-	-	-	-	1	-	-
CRP-6.011	-	1	130	•	-	-	130	-	-	-	2	-	-	-	-	-	-	-	-	-	1	-	1
CRP-6.012	-	1	-	•	-	-	-	-	-	-	-	-	-	-	-	-	-	-	-	-	1	-	-
CRP-6.013	-	1	-	•	-	-	-	-	-	-	-	-	-	-	-	-	-	-	-	-	1	-	-
CRP-6.014	100	1	180	•	-	-	-	-	1	-	-	-	-	4		-	-	-	-	-	1	-	-
CRP-6.015	-	3	-	•	-	-	-	-	-	-	-	-	-	4	-	-	-	-	-	1	2	-	-
CRP-6.016	-	1	-	•	-	-	-	-	-	-	-	-	-	-	-	-	-	-	-	-	1	-	-
CRP-6.017	-	1	-	•	-	-	-	-	-	-	-	-	-	-	-	-	-	-	-	1	-	1	-
CRP-6.018	-	1	-	•	-	-	-	-	-			-	-	-	-	-	-	-	-	-	-	-	-
CRP-6.019	-	3	-	•	-	-	-	-	-	-	-	-	-	1	-	-	-	-	-	-	3	-	-
CRP-6.020	-	1	45	•	45	-	-	-	1	-	-	-	-	2	2	1	-	-	-	1	-	1	-
CRP-6.021	95	1	-	-	-	-	-	-	-	-	-	-	-	2	2	-	-	-	-	-	1	-	-
CRP-6.022	-	1	-	-	-	-	-	-	-	-	-	-	-	-	-	-	-	-	-	-	1	-	-
CRP-6.023	-	1	-	•	-	-	-	-	-	-	-	-	-	-	-	-	-	-	-	-	-	-	-
CRP-6.024	210	5	1,200	•	25	-	-	165	-	-	1	-	-	-	-	1	-	-	1	•	3	1	-
CRP-6.025	-	3	-	•	-	-	-	-	-	-	-	-	-	-	-	-	-	-	-	1	2	1	-
CRP-6.026	-	1	-	-	-	-	-	-	-	-	-	-	-	-	-	-	-	-	1	-	-	-	-
CRP-6.027	-	2	15	-	15	-	-	-	-	-	-	-	-	-	-	-	-	2	1	-	-	-	-
CRP-6.028	210	6	60	-	-	-	60	-	-	-	2	-	-	1	-	-	-	1	-	1	2	1	-
CRP-6.029	-	3	-	-	-	-	-	-	-	-	-	-	-	-	-	-	-	-	-	-	3	-	-
CRP-6.030	-	1	-	-	-	-	-	-	-	-	-	-	-	-	-	-	-	-	-	-	1	-	-
CRP-6.031	135	2	-	-	-	-	-	-	-	-	-	-	-	1	-	-	-	-	-	-	1	-	-

- Work shown on this sheet is a summary of work for the installation of the fiber-optic cable and CCTV installations that are shown on the cable routing plans (i.e. CRP sheets). Work to be done for traffic signals is shown separately on the signal designs and the "Summary of Work by Intersection" sheets in Volume III of III.
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DOCUMENT NOT CONSIDERED FINAL UNLESS ALL SIGNATURES COMPLETED



NTS

Burlington-Graham Signal System
Summary of Work by
Cable Routing Plans
(Sheet 1 of 18) Burlington & Graham

PLAN DATE: December 2017 REVIEWED BY: HA Badgett

CABLE ROUTING SHEET NUMBER	COMMUNICATIONS CABLI (12-FIBER)	E COMMUNICATIONS CABLE (24-FIBER)	CITY IT COMMUNICATIONS CONTROL CABLE (24-FIBER)	OMMUNICATIONS CABLE (36-FIBER)	COMMUNICATIONS CABLE (48-FIBER)	DROP CABLE (12- FIBER)	HANDLASH & AERIAL CABLE PROTECTOR	SPLICE ENCLOSURE	MODIFY EXISTING SPLICE OR INTERCONNECT CENTER	INTERCONNECT CENTER, PATCH PANEL, JUMPERS, FUSION SPLICE CABLE	ETHERNET EDGE SWITCH	REMOVE EXISTING COMMUNICATIONS CABLE	REMOVE CCTV CABINET	INSTALL CCTV CAMERA ASSEMBLY	REMOVE EX CCTV ASSEMBLY	POLE-MOUNTED CCTV CABINET (336)	POLE-MOUNTED CCTV CABINET (NEMA)	l l	WOOD POLE
	LF	LF	LF	LF	LF	LF	LF	EA	EA	EA	EA	LF	EA	EA	EA	EA	EA	EA	EA
CRP-6.001	-	-	1,415	1,515	-	400	-	1	-	1	1	-	-	1	•	-	-	-	-
CRP-6.002	-	-	1,350	1,450	-	-	-	-	-	-	-	-	-	-	-	-	-	-	-
CRP-6.003	-	-	1,425	1,425	-	-	-	-	-	-	-	-	-	-	-	-	-	-	-
CRP-6.004	-	-	1,350	1,350	-	-	-	-	-	-	-	-	-	-	-	-	-	-	-
CRP-6.005	-	935	1,640	1,800	-	450	-	1	-	1	1	1,470	-	1	-	-	-	-	-
CRP-6.006	-	-	1,495	1,495	-	-	-	-	-	-		1,405	-	-	-	-	-	-	-
CRP-6.007	460	-	1,385	1,675	-	790	-	2	-	2	2	360	-	1	1	-	-	-	-
CRP-6.008	-	-	-	1,535	-	-	-	-	-	-	-	-	-	-	-	-	-	-	-
CRP-6.009	-	-	-	1,540	-	-	-	-	-	-	-	-	-	-	-	-	-	-	-
CRP-6.010	-	-	-	1,625	-	330	-	1	-	1	1	-	-	-	-	-	-	-	-
CRP-6.011	-	-	-	1,680	-	465	-	1	-	1	1	-	-	1	-	-	-	-	-
CRP-6.012	-	-	-	1,575	-	290	-	1	-	1	1	-	-	-	-	-	-	-	-
CRP-6.013	-	-	-	1,480	-	325	-	1	-	1	1	-	-	-	-	-	-	-	-
CRP-6.014	-	670	-	1,685	-	395	-	1	-	1	1	105	-	1	1	-	-	-	-
CRP-6.015	-	-	-	1,585	-	935	-	2	-	3	3	-	-	1	-	1		-	-
CRP-6.016	-	-	-	1,585	-	390	-	1	-	1	1	-	-	-	-	-	-	-	-
CRP-6.017	-	-	-	1,475	-	330	-	1	-	1	1	-	-	-	-	-	-	-	-
CRP-6.018	-	-	-	1,275	-	-	-	-	-	-	-	-	-	-	-	-	-	-	-
CRP-6.019	-	-	-	1,580	-	1,070	-	2	-	3	3	-	-	1	1	-	-	-	-
CRP-6.020	-	-	-	1,495	-	360	-	1	-	1	1	75	-	-	-	-	-	-	-
CRP-6.021	-	-	-	1,535	-	740	-	1	-	1	1	205	-	-	-	-	-	-	-
CRP-6.022	-	-	-	3,465	-	345	-	1	-	1	1	-	-	-	-	-	-	-	-
CRP-6.023	-	-	-	2,990	-	-	-	-	-	-	-	-	-	-	-	-	-	-	-
CRP-6.024	-	-	-	3,855	-	2,900	-	2	-	5	5	1,220	-	1	-	-	-	-	-
CRP-6.025	640	745	-	1,995	-	1,700	-	4	-	3	3	115	-	-	-	-	-	-	-
CRP-6.026	-	-	-	1,285	-	320	-	1	-	1	1	-	-	-	-	-	-	-	-
CRP-6.027	690	-	430	1,550	-	305	-	1	-	1	1	-	-	1	-	-	-	-	-
CRP-6.028	-	-	-	745	-	3,090	-	1	-	3	3	125	-	1	-	-	-	-	-
CRP-6.029	555	-	-	1,870	-	1,315	-	1	-	3	3	-	-	-	-	-	-	-	-
CRP-6.030	1,105	-	-	-	-	710	-	1	-	1	1	-	-	-	-	-	-	-	-
CRP-6.031	885	-	-	1,045	-	235	-	1	-	1	1	130	-	-	-	-	-	-	-

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NTS

Burlington-Graham Signal System
Summary of Work by
Cable Routing Plans
(Sheet 2 of 18) Burlington & Graham

PLAN DATE: December 2017 REVIEWED BY: HA Badgett

CRP-1.002

### SUMMARY OF WORK BY CABLE ROUTING PLANS

CABLE ROUTING SHEET NUMBER	ETHERNET CABLE (CAT 6)	MODIFY ELEC SERVICE FOR CCTV	REMOVE EXISTING CABINET FOUNDATION	SERVICE CONDUCTORS	NEW ELEC SERVICE FOR CCTV OR RADIO	MODIFY ELEC SERVICE FOR CCTV OR RADIO	INSTALL CABINET FOUNDATION	BASE MOUNTED CCTV CABINET W/ EXTENDER	INSTALL CCTV METAL POLE	INSTALL 2.4 GHZ RADIO	REMOVE EX CCTV METAL POLE	REMOVE WIRELESS COMM EQUIPMENT	BACK PULL FIBER-OPTIC CABLE
	LF	EA	EA	LF	EA	EA	EA	EA	EA	EA	EA	EA	LF
CRP-6.001	155	-	-	-	-	-	-	-	-	-	-	-	-
CRP-6.002	-	-	-	-	-	-	-	-	-	-	-	-	-
CRP-6.003	-	-	-	-	-	-	-	-	-	-	-	-	-
CRP-6.004	-	-	-	-	-	-	-	-	-	-	-	-	-
CRP-6.005	70	-	-	-	-	-	-	-	1	-	-	-	-
CRP-6.006	-	-	-	-	-	-	-	-	-	-	-	-	-
CRP-6.007	270	-	-	-	-	-	-	-	1	-	-	-	-
CRP-6.008	-	-	-	-	-	-	-	-	-	-	-	-	-
CRP-6.009	-	-	-	-	-	-	-	-	-	-	-	-	-
CRP-6.010	-	-	-	-	-	-	-	-	•	-	-	-	-
CRP-6.011	190	-	-	-	-	-	-	-	1	-	-	-	-
CRP-6.012	-	-	-	-	-	-	-	-	•	-	-	-	-
CRP-6.013	-	-	-	-	-	-	-	-	•	-	-	-	-
CRP-6.014	250	-	-	-	-	-	-	-	•	-	-	-	105
CRP-6.015	50	-	-	-	1	-	-	-	1	-	-	-	-
CRP-6.016	-	-	-	-	-	-	-	-	•	-	-	-	-
CRP-6.017	-	-	-	-	-	-	1	-	•	-	-	-	-
CRP-6.018	-	-	-	-	-	-	-	-	-	-	-	-	-
CRP-6.019	60	-	-	-	-	-	-	1	•	-	-	-	-
CRP-6.020	•	-	-	-	-	-	1	-	1	-	-	-	-
CRP-6.021	-	-	-	-	-	-	-	-	1	-	-	-	205
CRP-6.022	-	-	-	-	-	-	-	-	1	-	-	-	-
CRP-6.023	-	-	-	-	-	-	-	-	•	-	-	-	-
CRP-6.024	250	-	-	-	-	-	1	-	1	-	-	-	210
CRP-6.025	-	-	-	-	-	-	1	-	-	-	-	-	-
CRP-6.026	-	-	-	-	-	-	-	-	-	-	-	-	-
CRP-6.027	230	-	-	-	-	-	-	-	1	-	-	-	-
CRP-6.028	255	-	-	-	-	-	1	-	1	-	-	-	-
CRP-6.029	-	-	-	-	-	-	-	-	-	-	-	-	-
CRP-6.030	-	-	-	-	-	-	-	-	-	-	-	-	-
CRP-6.031	-	-	-	-	-	-	-	-	-	-	-	-	-

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NTS

Burlington-Graham Signal System
Summary of Work by
Cable Routing Plans
(Sheet 3 of 18) Burlington & Graham

Division 7 Alamance County Graham

PLAN DATE: December 2017 REVIEWED BY: HA Badgett

CABLE ROUTING SHEET NUMBER	MESSENGER CABLE (1/4")	BOND MESSENGER CABLE	TRACER WIRE	UNDERGROUND CONDUIT (1 CONDUIT, 1 INCH)	UNDERGROUND CONDUIT (1 CONDUIT, 2 INCH)	UNDERGROUND CONDUIT (2 CONDUIT, 2 INCH)	DIRECTIONAL DRILL (2 CONDUIT, 2 INCH)				JUNCTION BOX STANDARD- SIZED)	REMOVE EXISTING JUNCTION BOX	DELINEATOR MARKER	STANDARD GUY ASSEMBLY	AERIAL GUY ASSEMBLY	SIDEWALK GUY ASSEMBLY	1" RISER WITH WEATHERHEAD FOR CCTV ELEC SERVICE	1" RISER WITH WEATHERHEAD FOR CAT 6	1.25" RISER WITH HEAT SHRINK TUBING	2" RISER WITH HEAT SHRINK TUBING	HEAT SHRINK TUBING KIT	NEW CABINET ENTRANCE INTO NEW FOUNDATION	DRILL/ CORE DRILL EXIST FOUNDATION
	LF	EA	LF	LF	LF	LF	LF	LF	EA	EA	EA	EA	EA	EA	EA	EA	EA	EA	EA	EA	EA	EA	EA
CRP-6.032	-	1	-	-	-	-	-	-	-	-	-	-	-	-	-	-	-	-	-	1	-	1	-
CRP-6.033	-	1	-	-	-	-	-	-	-	-	-	-	-	-	-	-	-	-	-	-	-	-	-
CRP-6.034	-	1	-	-	-	-	-	•	-	-	-	-	•	-	-	-	-	-	-	-	-	-	-
CRP-6.035	-	1	-	-	-	-	-	-	-	-	-	-	-	2	-	1	-	-	-	-	1	-	-
CRP-6.036	420	4	70	-	-	-	70	-	1	-	-	-	-	1	1	2	-	-	-	2	-	-	-
CRP-6.037	-	1	-	-	-	-	-	-	-	-	-	-	-	-	-	-	-	-	-	1	-	1	-
CRP-6.038	-	2	25	25	-	-	-	-	-	-	-	-	-	-	-	-	-	1	-	-	1	-	-
CRP-6.039	110	4	275	-	-	-	275	-	2	-	-	-	-	3	-	-	-	-	-	3	1	-	-
CRP-6.040	65	2	-	-	-	-	-	-	-	-	-	-	-	1	-	-	-	-	-	-	-	-	-
CRP-6.041	170	2	-	-	-	-	-	-	-	-	-	-	-	-	-	-	-	-	-	-	-	-	-
CRP-6.042	-	1	90	-	-	-	90	-	-	-	2	•	-	-	-	-	-	1	-	1	-	1	-
CRP-6.043	230	3	-	-	-	-	-	-	-	-	-	-	-	1	-	-	-	-	-	1	-	1	-
CRP-6.044	1,490	1	-	-	-	-	•	-	-	-	•	-	-	7	-	-	-	-	-	•	-	-	-
CRP-6.045	1,440	1	-	-	-	-	-	-	-	-	-	-	-	6	-	-	-	-	-	-	-	-	-
CRP-6.046	720	1	-	-	25	-	-	-	-	-	-	-	-	2	-	-	-	-	-	1	-	-	-
CRP-6.047	-	1	1,320	-	-	795	525	-	3	1	-	-	-	1	-	-	-	-	-	1	-	-	-
CRP-6.048	1,275	1	175	-	-	175	-	-	1	-	-	-	-	4		-	-	-	-	1	-	-	-
CRP-6.049	460	1	1,275	-	-	870	280	-	4	1	1	1	-	-	-	-	-	-	-	1	-	-	-
CRP-6.050	-	-	980	-	-	830	150	-	1	1	-	1	-	-	-	-	-	-	-	-	-	-	1
CRP-6.051	-	1	1,655	-	20	-	-	-	-	2	-	2	-	-	-	-	-	-	-	1	-	-	-
CRP-6.052	-	-	1,455	-	-	-	-	-	-	1	-	1	-	-	-	-	-	-	-	-	-	-	-
CRP-6.053	-	-	1,425	-	-	-	-	-	-	-	-	-	-	-	-	-	-	-	-	-	-	-	-
CRP-6.054	-	1	455	-	-	-	-	-	-	1	-	1	-	3	1	-	-	-	-	-	1	-	-
CRP-6.055	-	1	-	-	-	-	-	-	-	-	-	-	-	1	1	-	-	-	-	-	-	-	-
CRP-6.056	-	1	40	-	-	-	-	-	-	-	-	-	-	1	1	-	-	-	-	-	1	-	-
CRP-6.057	-	-	1,725	-	20	810	120	-	1	1	-	1	-	-	-	-	-	-	-	-	-	-	-
CRP-6.058	-	-	1,460	-	-	-	-	-	-	1	-	1	-	-	-	-	-	-	-	-	-	-	-
CRP-6.059	-	-	1,690	-	-	-	-	-	-	1	-	1	-	-	-	-	-	-	-	-	-	-	-
CRP-6.060	-	1	1,470	-	-	-	-	-	-	1	-	1	-	-	-	-	-	-	-	-	1	-	-
CRP-6.061	-	1	-	-	-	-	-	-	-	-	-	-	-	-	-	-	-	-	-	-	-	-	-
CRP-6.062	-	1	-	-	-	-	-	-	-	-	-	-	-	2	1	-	-	-	-	-	1	-	-
CRP-6.063	280	3	-	-	-	-	-	-	-	-	-	-	-	5	2	-	-	-	-	-	1	-	-
CRP-6.064	475	3	135	-	20	-	-	-	-	1	-	1	-	2	1	-	-	-	-	2	-	-	-
CRP-6.065	-	2	550	-	-	-	550	-	1	1	-	-	-	2	-	-	-	-	-	2	-	-	1
CRP-6.066	30	3	190	-	-	-	190	-	2	-	-	-	-	2	-	-	-	1	-	2	1	-	-

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Burlington-Graham Signal System
Summary of Work by
Cable Routing Plans
(Sheet 4 of 18) Burlington & Graham

Division 7 Alamance County Graham

PLAN DATE: December 2017 REVIEWED BY: HA Badgett AH/AW REVIEWED BY: BJ Slocum

CABLE ROUTING SHEET NUMBER	COMMUNICATIONS CABLE (12-FIBER)	COMMUNICATIONS CABLE (24-FIBER)	CITY IT COMMUNICATIONS CABLE (24-FIBER)	COMMUNICATIONS CABLE (36-FIBER)	COMMUNICATIONS CABLE (48-FIBER)	DROP CABLE (12- FIBER)	HANDLASH & AERIAL CABLE PROTECTOR	SPLICE ENCLOSURE	MODIFY EXISTING SPLICE OR INTERCONNECT CENTER	INTERCONNECT CENTER, PATCH PANEL, JUMPERS, FUSION SPLICE CABLE	ETHERNET EDGE SWITCH	REMOVE EXISTING COMMUNICATIONS CABLE	REMOVE CCTV CABINET	INSTALL CCTV CAMERA ASSEMBLY	REMOVE EX CCTV ASSEMBLY	POLE-MOUNTED CCTV CABINET (336)	POLE-MOUNTED CCTV CABINET (NEMA)	CCTV WOOD POLE	WOOD POL
	LF	LF	LF	LF	LF	LF	LF	EA	EA	EA	EA	LF	EA	EA	EA	EA	EA	EA	EA
CRP-6.032	1,300	-	-	-	-	265	-	1	-	1	1	-	-	-	-	-	-	-	-
CRP-6.033	-	-	-	1,470	-	-	-	-	-	-	-	-	-	-	-	-	-	-	-
CRP-6.034	-	-	-	1,525	-	-	-	-	-	-	-	-	-	-	-	-	-	-	-
CRP-6.035	-	-	-	1,795	-	335	-	1	-	1	1	-	-	-	-	-	-	-	-
CRP-6.036	1,185	-	-	1,535	-	280	-	1	-	1	1	425	-	-	-	-	-	-	1
CRP-6.037	-	-	-	1,535	-	480	-	1	-	1	1	-	-	-	-	-	-	-	-
CRP-6.038	280	1,185	-	1,640	-	550	-	1	-	1	1	120	1	1	1	-	-	-	-
CRP-6.039	-	1,660	-	-	-	1,470	-	1	-	2	2	465	-	-	-	-	-	-	-
CRP-6.040	-	1,515	-	-	-	-	-	-	-	-	-	65	-	-	-	-	-	-	-
CRP-6.041	-	1,495	-	-	-	-	-	-	-	-	-	170	-	-	-	-	-	-	-
CRP-6.042	-	1,610	-	-	-	300	-	1	-	1	1	-	-	1	-	-	-	1	-
CRP-6.043	-	1,910	-	-	-	300	-	1	-	1	1	220	-	-	-	-	-	-	-
CRP-6.044	-	1,590	-	-	-	-	-	-	-	-	-	-	-	-	-	-	-	-	-
CRP-6.045	-	1,540	-	-	-	-	-	-	-	-	-	-	-	-	-	-	-	-	-
CRP-6.046	-	710	-	-	-	310	-	1	-	1	1	15	-	1	-	-	-	-	-
CRP-6.047	-	1,560	-	-	-	65	-	1	-	1	1	400	-	-	-	-	-	-	-
CRP-6.048	-	1,610	-	-	-	-	-	-	-	-	-	-	-	-	-	-	-	-	-
CRP-6.049	-	1,660	-	-	-	205	-	1	-	1	1	1,140	-	1	-	-	-	-	-
CRP-6.050	-	1,815	-	-	-	45	-	1	-	1	1	-	-	1	1	-	-	-	-
CRP-6.051	-	1,960	-	-	-	765	-	2	-	3	3	1,680	-	1	1	-	-	-	-
CRP-6.052	-	1,575	-	-	-	60	-	1	-	1	1	1,480	-	-	-	-	-	-	-
CRP-6.053	-	1,545	-	-	-	-	-	-	-	-	-	1,425	-	-	-	-	-	-	-
CRP-6.054	-	1,775	-	-	-	75	-	1	-	1	1	455	-	-	-	-	-	-	-
CRP-6.055	-	1,525	-	-	-	-	-	-	-	-	-	-	-	-	-	-	-	-	-
CRP-6.056	-	1,010	-	-	-	535	-	1	-	1	1	40	-	-	-	-	-	-	-
CRP-6.057	330	1,555	-	-	-	45	-	1	-	1	1	780	-	1	-	-	-	-	-
CRP-6.058	-	1,545	-	-	-	100	-	1	-	1	1	1,460	-	-	-	-	-	-	-
CRP-6.059	-	1,520	-	-	-	320	-	1	-	1	1	1,690	-	-	-	-	-	-	-
CRP-6.060	-	1,585	-	-	-	175	-	1	-	1	1	1,470	-	-	-	-	-	-	-
CRP-6.061	-	1,360	-	-	-	-	-	-	-	-	-	-	-	-	-	-	-	-	-
CRP-6.062	-	1,270	-	-	-	260	-	1	-	1	1	-	-	-	-	-	-	-	-
CRP-6.063	1,240	800	-	-	-	360	-	1	-	1	1	50	-	-	-	-	-	-	-
CRP-6.064	450	1,360	-	-	-	120	-	1	1	3	2	610	-	1	1	-	-	-	-
CRP-6.065	-	1,930	-	-	-	70	-	1	-	1	1	550	-	-	-	-	-	-	-
CRP-6.066	465	1,810	-	-	-	240	-	1	-	1	1	260	_	1	_	_	-	-	-

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Burlington-Graham Signal System
Summary of Work by
Cable Routing Plans
(Sheet 5 of 18) Burlington & Graham

Division 7 Alamance County Graham

PLAN DATE: December 2017 REVIEWED BY: HA Badgett

CABLE ROUTING SHEET NUMBER	ETHERNET CABLE (CAT 6)	MODIFY ELEC SERVICE FOR CCTV	REMOVE EXISTING CABINET FOUNDATION	SERVICE CONDUCTORS	NEW ELEC SERVICE FOR CCTV OR RADIO	MODIFY ELEC SERVICE FOR CCTV OR RADIO	INSTALL CABINET FOUNDATION	BASE MOUNTED CCTV CABINET W/ EXTENDER	INSTALL CCTV METAL POLE	INSTALL 2.4 GHZ RADIO	REMOVE EX CCTV METAL POLE	REMOVE WRELESS COMM EQUIPMENT	BACK PULL FIBER-OPTIC CABLE
	LF	EA	EA	LF	EA	EA	EA	EA	EA	EA	EA	EA	EA
CRP-6.032	-	-	-	-	-	-	1	-	-	-	-	-	-
CRP-6.033	-	-	-	-	-	-	-	-	-	-	-	-	-
CRP-6.034	-	-	-	-	-	-	-	-	-	-	-	-	-
CRP-6.035	-	-	-	-	-	-	-	-	-	-	-	-	-
CRP-6.036	-	-	-	-	-	-	-	-	-	-	-	-	-
CRP-6.037	-	-	-	-	-	-	1	-	-	-	-	-	-
CRP-6.038	265	-	-	-	-	-	-	-	1	-	1	-	-
CRP-6.039	-	-	-	-	-	-	-	-	-	-	-	-	265
CRP-6.040	-	-	-	-	-	-	-	-	-	-	-	-	-
CRP-6.041	-	-	-	-	-	-	-	-	-	-	-	-	65
CRP-6.042	145	-	-	-	-	-	1	-	-	-	-	-	170
CRP-6.043	-	-	-	-	-	-	1	-	-	-	-	-	220
CRP-6.044	-	-	-	-	-	-	-	-	-	-	-	-	-
CRP-6.045	-	-	-	-	-	-	-	-	-	-	-	-	-
CRP-6.046	70	-	-	-	-	-	-	-	1	-	-	-	-
CRP-6.047	-	-	-	-	-	-	-	-	-	-	-	-	-
CRP-6.048	-	-	-	-	-	-	-	-	-	-	-	-	-
CRP-6.049	180	-	-	-	-	-	-	-	-	-	-	-	1,010
CRP-6.050	55	-	-	-	-	-	-	-	-	-	-	-	-
CRP-6.051	60	-	-	-	-	-	-	-	-	-	-	-	-
CRP-6.052	-	-	-	-	-	-	-	-	-	-	-	-	-
CRP-6.053	-	-	-	-	-	-	-	-	-	-	-	-	-
CRP-6.054	-	-	-	-	-	-	-	-	-	-	-	-	-
CRP-6.055	-	-	-	-	-	-	-	-	-	-	-	-	-
CRP-6.056	-	-	-	-	-	-	-	-	-	-	-	-	-
CRP-6.057	80	-	-	-	-	-	-	-	1	-	-	-	-
CRP-6.058	-	-	-	-	-	-	-	-	-	-	-	-	-
CRP-6.059	-	-	-	-	-	-	-	-	-	-	-	-	_
CRP-6.060	-	-	-	-	-	-	-	-	-	-	-	-	-
CRP-6.061	-	-	-	-	-	-	-	-	-	-	-	-	-
CRP-6.062	_	-	-	-	-	-	-	_	-	-	-	-	-
CRP-6.063	-	_	-	_	-		-	_	-	-	-	-	-
CRP-6.064	210	_	-	_	-		_	_	-	-	-	_	_
CRP-6.065	-	_	-	-	-		_	_	-	-	-	_	_
CRP-6.066	165	_	1	_	_	_	1	_	_	_	-	_	_

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Burlington-Graham Signal System
Summary of Work by
Cable Routing Plans
(Sheet 6 of 18) Burlington & Graham

Division 7 Alamance County Graham

NTS

PLAN DATE: December 2017 REVIEWED BY: HA Badgett

CRP-1.006 U-6015

NEW CABINET

## SUMMARY OF WORK BY CABLE ROUTING PLANS

CABLE ROUTING SHEET NUMBER	MESSENGER CABLE (1/4")	BOND MESSENGER CABLE	TRACER WIRE	UNDERGROUND CONDUIT (1 CONDUIT, 1 INCH)	UNDERGROUND CONDUIT (1 CONDUIT, 2 INCH)	UNDERGROUND CONDUIT (2 CONDUIT, 2 INCH)	DIRECTIONAL DRILL (2 CONDUIT, 2 INCH)	DIRECTIONAL DRILL (1 CONDUIT, 2 INCH)	JUNCTION BOX (OVER-SIZED)	JUNCTION BOX (SPECIAL-SIZED)		REMOVE EXISTING JUNCTION BOX	DELINEATOR MARKER	STANDARD GUY ASSEMBLY	AERIAL GUY ASSEMBLY	SIDEWALK GUY ASSEMBLY	1" RISER WITH WEATHERHEAD FOR CCTV ELEC SERVICE	1" RISER WITH WEATHERHEAD FOR CAT 6		2" RISER WITH HEAT SHRINK TUBING	HEAT SHRINK TUBING KIT		DRILL/ CORE DRILL EXIST FOUNDATION
	LF	EA	LF	LF	LF	LF	LF	LF	EA	EA	EA	EA	EA	EA	EA	EA	EA	EA	EA	EA	EA	EA	EA
CRP-6.067	-	1	-	-	-	-	-	-	-	-	-	-	-	-	-	-	-	-	-	-	1	-	-
CRP-6.068	-	2	390	-	-	-	390	-	2	-	-	-	-	2	-	-	-	-	-	2	-	-	-
CRP-6.069	-	1	-	-	-	-	-	-	-	-	-	-	-	3	-	-	-	-	-	1	-	-	-
CRP-6.070	-	-	890	-	-	-	-	-	-	1	-	1	-	-	-	-	-	-	-	-	-	-	-
CRP-6.071	-	1	-	-	-	-	-	-	-	-	-	-	-	2	-	-	-	-	1	-	-	-	-
CRP-6.072	-	1	-	-	-	-	-	-	-	-	-	-	-	-	-	-	-	-	-	-	-	-	-
CRP-6.073	-	1	-	-	-	-	-	-	-	-	-	-	-	1	1	-	-	-	-	-	-	-	-
CRP-6.074	125	2	235	-	-	-	235	-	1	-	-	-	-	4	2	-	-	•	-	1	1	-	-
CRP-6.075	-	1	-	-	-	-	-	-	-	-	-	-	-	-	-	-	-	-	-	-	-		-
CRP-6.076	-	1	-	-	-	-	-	-	-	-	-	-	-	-	-	-	-	-	-	-	-	-	-
CRP-6.077	-	1	-	-	20	-	-	-	-	-	-	-	-	4	4	-	-	-	-	-	1	-	1
CRP-6.078	-	1	-	-	-	-	-	-	-	-	-	-	-	3	2	-	-	-	-	-	1	-	-
CRP-6.079	-	1	-	-	-	-	-	-	-	-	-	-	-	1	2	-	-	-	-	-	-	-	-
CRP-6.080	-	1	-	-	-	-	-	-	-	-	-	-	-	4	3	-	-	-	-	-	-	-	-
CRP-6.081	-	1	-	-	25	-	-	-	-	-	-	-	-	3	3	-	-	-	-	-	1	-	1
CRP-6.082	-	1	-	-	-	-	-	-	-	-	-	-	-	1	1	-	-	-	-	-	-	-	-
CRP-6.083	-	1	-	-	-	-	-	-	-	-	-	-	-	1	1	-	-	-	-	-	1	-	-
CRP-6.084	840	3	-	-	-	-	-	-	-	-	-	-	-	3	1	-	-	-	-	-	1	-	-
CRP-6.085	-	1	-	-	-	-	-	-	-	-	-	-	-	1	-	-	-	-	-	1	-	1	-
CRP-6.086	-	1	90	-	-	-	90	90	-	2	-	-	-	-	-	-	-	-	-	2	-	-	-
CRP-6.087	-	1	-	-	-	-	-	-	-	-	-	-	-	3	2	-	-	-	-	-	1	-	-
CRP-6.088	-	1	-	-	-	-	•	-	-	-	-	-	•	1	1	-	-	-	-	-	-	-	-
CRP-6.089	-	4	450	-	30	230	-	-	-	1	-	1	-	1	-	-	-	1	-	1	3	-	-
CRP-6.090	250	3	-	-	-	-	-	-	-	-	-	-	-	2	-	-	-	-	-	-	1	-	-
CRP-6.091	-	1	-	-	-	-	-	-	-	-	-	-	-	1	1	-	-	•	-	-	-	-	-
CRP-6.092	-	1	-	-	-	-	-	-	-	-	-	-	-	-	-	-	-	1	-	-	1	-	
CRP-6.093	-	1	-	-	-	-	-	-	-	-	-	-	-	1	1	-	-	-	-	-	-	-	-
CRP-6.094	-	1	-	-	-	-	-	-	-	-	-	-	-	-	-	-	-	•	-	-	1	-	-
CRP-6.095	-	1	-	-	-	-	-	-	-	-	-	-	-	3	3	-	-	•	-	-	•	-	-
CRP-6.096	-	2	-	-	20	-	-	-	-	-	-	-	-	-	-	-	-	-	-	-	2	-	-
CRP-6.097	-	1	-	-	-	-	-	-	-	-	-	-	-	-	-	-	-	•	-	-	1	-	-
CRP-6.098	-	1	-	-	-	-	-	-	-	-	-	-	-	-	-	-	-	-	-	-	-	-	-
CRP-6.099	-	1	-	-	-	-	-	-	-	-	-	-	-	-	-	-	-	-	-	-	1	-	-
CRP-6.100	-	2	-	-	-	-	-	-	-	-	-	-	-	-	-	-	-	1	-	-	1	<u> </u>	-
CRP-6.101	-	2	275	-	-	-	275	-	3	-	-	-	-	-	-	1	-	-	-	2	-	-	-

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Summary of Work by
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(Sheet 7 of 18) Burlington & Graham

PLAN DATE: December 2017 REVIEWED BY: HA Badgett

CABLE ROUTING SHEET NUMBER	COMMUNICATIONS CABLE (12-FIBER)	COMMUNICATIONS CABLE (24-FIBER)	CITY IT COMMUNICATIONS CABLE (24-FIBER)	COMMUNICATIONS CABLE (36-FIBER)	COMMUNICATIONS CABLE (48-FIBER)	DROP CABLE (12- FIBER)	HANDLASH & AERIAL CABLE PROTECTOR	SPLICE ENCLOSURE	MODIFY EXISTING SPLICE OR INTERCONNECT CENTER	INTERCONNECT CENTER, PATCH PANEL, JUMPERS, FUSION SPLICE CABLE	ETHERNET EDGE SWITCH	REMOVE EXISTING COMMUNICATIONS CABLE	REMOVE CCTV CABINET	INSTALL CCTV CAMERA ASSEMBLY	REMOVE EX CCTV ASSEMBLY	POLE-MOUNTED CCTV CABINET (336)	POLE-MOUNTED CCTV CABINET (NEMA)		WOOD POLE
	LF	LF	LF	LF	LF	LF	LF	EA	EA	EA	EA	LF	EA	EA	EA	EA	EA	EA	EA
CRP-6.067	-	1,630	-	-	-	230	-	1	-	1	1	-	-	-	-	-	-	-	-
CRP-6.068	-	1,980	-	-	-	290	-	1	-	1	1	620	-	-	-	-	-	-	-
CRP-6.069	860	-	-	-	-	590	-	1	-	1	1	-	-	-	-	-	-	-	-
CRP-6.070	940	-	-	-	-	70	-	1	-	1	1	885	-	-	-	-	-	-	-
CRP-6.071	1,120	-	-	-	-	410	-	1	-	1	1	-	-	-	-	-	-	-	-
CRP-6.072	-	1,525	-	-	-	-	-	-	-	-	-	-	-	-	-	-	-	-	-
CRP-6.073	-	1,520	-	-	-	-	-	-	-	-	-	-	-	-	-	-	-	-	-
CRP-6.074	580	1,485	-	-	-	190	-	1	-	1	1	-	-	-	-	-	-	-	-
CRP-6.075	-	1,630	-	-	-	-	-	-	-	-	-	-	-	-	-	-	-	-	-
CRP-6.076	-	1,490	-	-	-	-	-	-	-	-	-	-	-	-	-	-	-	-	-
CRP-6.077	-	1,520	-	-	710	450	-	2	-	2	2	-	-	1	-	-	-	-	-
CRP-6.078	-	-	-	-	1,600	370	-	1	-	1	1	30	-	-	-	-	-	-	-
CRP-6.079	-	-	-	-	1,490	-	-	-	-	-	-	-	-	-	-	-	-	-	-
CRP-6.080	-	-	-	-	1,390	-	-	-	-	-	-	-	-	-	-	-	-	-	-
CRP-6.081	-	-	-	-	2,030	190	-	1	-	1	1	20	-	1	-	-	-	-	-
CRP-6.082	-	-	-	-	3,130	-	-	-	-	-	-	-	-	-	-	-	-	-	-
CRP-6.083	-	-	-	-	2,830	270	-	1	-	1	1	-	-	-	-	-	-	-	-
CRP-6.084	-	-	-	-	2,380	980	-	1	-	1	1	820	-	-	-	-	-	-	1
CRP-6.085	-	-	-	-	-	660	-	-	-	1	1	-	-	-	-	-	-	-	-
CRP-6.086	-	-	-	4,150	990	-	-	-	-	-	-	90	-	-	-	-	-	-	-
CRP-6.087	-	1,320	-	-	-	410	-	1	-	1	1	20	-	-	-	-	-	-	-
CRP-6.088	-	1,480	-	-	-	-	-	-	-	-	-	-	-	-	-	-	-	-	-
CRP-6.089	-	1,450	-	-	430	1,320	-	2	-	3	3	230	-	1	1	-	-	-	-
CRP-6.090	-	-	-	-	1,180	200	-	-	-	1	1	250	-	-	-	-	-	-	-
CRP-6.091	-	-	-	-	1,540	-	-	-	-	-	-	-	-	-	-	-	-	-	-
CRP-6.092	-	-	-	-	1,530	320	-	1	-	1	1	-	-	1	-	-	-	-	-
CRP-6.093	-	-	-	-	1,580	-	-	-	-	-	-	-	-	-	-	-	-	-	-
CRP-6.094	-	-	-	-	1,550	230	-	-	-	1	1	-	-	-	-	-	-	-	-
CRP-6.095	-	-	-	-	1,570	330	-	1	-	-	-	-	-	-	-	-	-	-	1
CRP-6.096	-	620	-	-	1,875	365	-	1	-	1	1	-	-	1	-	-	-	-	-
CRP-6.097	-	-	-	-	1,570	405	-	1	-	1	1	-	-	-	-	-	-	-	-
CRP-6.098	-	-	-	-	1,570	-	-	-	-	-	-	-	-	-	-	-	-	-	-
CRP-6.099	-	-	-	-	1,545	330	-	1	-	1	1	-	-	-	-	-	-	-	-
CRP-6.100	-	-	-	680	1,475	225	-	1	-	1	1	-	-	1	-	-	-	-	-
CRP-6.101	-	-	-	-	1,535	1,685	-	1	-	1	1	200	-	-	-	-	-	-	-

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DOCUMENT NOT CONSIDERED FINAL UNLESS ALL SIGNATURES COMPLETED



NTS

Burlington-Graham Signal System
Summary of Work by
Cable Routing Plans
(Sheet 8 of 18) Burlington & Graham

Division 7 Alamance County Graham

PLAN DATE: December 2017 REVIEWED BY: HA Badgett

CABLE ROUTING SHEET NUMBER	ETHERNET CABLE (CAT 6)	MODIFY ELEC SERVICE FOR CCTV	REMOVE EXISTING CABINET FOUNDATION	SERVICE CONDUCTORS	NEW ELEC SERVICE FOR CCTV OR RADIO	MODIFY ELEC SERVICE FOR CCTV OR RADIO	INSTALL CABINET FOUNDATION	BASE MOUNTED CCTV CABINET W/ EXTENDER	INSTALL CCTV METAL POLE	INSTALL 2.4 GHZ RADIO	REMOVE EX CCTV METAL POLE	REMOVE WRELESS COMM EQUIPMENT	BACK PULL FIBER-OPTIC CABLE
	LF	EA	EA	LF	EA	EA	EA	EA	EA	EA	EA	EA	EA
CRP-6.067	-	-	-	-	-	-	-	-	-	-	-	-	-
CRP-6.068	-	•	-	-	-	-	-	-	-	-	-	-	-
CRP-6.069	-	•	-	-	-	-	-	-	-	-	-	-	-
CRP-6.070	-	•	-	-	-	-	-	-	-	-	-	-	-
CRP-6.071	-	•	-	-	-	-	-	-	-	-	-	-	-
CRP-6.072	-	-	-	-	-	-	-	-	-	-	-	-	-
CRP-6.073	-	-	-	-	-	-	-	-	-	-	-	-	-
CRP-6.074	-	-	-	-	-	-	-	-	-	-	-	-	-
CRP-6.075	-	•	-	-	-	-	-	-	-	-	-	-	-
CRP-6.076	-	•	-	-	-	-	-	-	-	-	-	-	-
CRP-6.077	260	-	-	-	-	-	-	-	-	-	-	-	-
CRP-6.078	-	-	-	-	-	-	-	-	-	-	-	-	-
CRP-6.079	-	-	-	-	-	-	-	-	-	-	-	-	-
CRP-6.080	-	-	-	-	-	-	-	-	-	-	-	-	-
CRP-6.081	190	-	-	-	-	-	-	-	-	-	-	-	-
CRP-6.082	-	-	-	-	-	-	-	-	-	-	-	-	-
CRP-6.083	-	-	-	-	-	-	-	-	-	-	-	-	-
CRP-6.084	-	-	-	-	-	-	-	-	-	-	-	-	320
CRP-6.085	-	-	-	-	-	-	1	-	-	-	-	-	-
CRP-6.086	-	-	-	-	-	-	-	-	-	-	-	-	-
CRP-6.087	-	-	-	-	-	-	-	-	-	-	-	-	-
CRP-6.088	-	-	-	-	-	-	-	-	-	-	-	-	-
CRP-6.089	310	-	-	-	-	-	-	-	-	-	-	-	-
CRP-6.090	-	-	-	-	-	-	-	-	-	-	-	-	-
CRP-6.091	-	-	-	-	-	-	-	-	-	-	-	-	-
CRP-6.092	130	-	-	-	-	-	-	-	-	-	-	-	-
CRP-6.093	-	-	-	-	-	-	-	-	-	-	-	-	-
CRP-6.094	-	-	-	-	-	-	-	-	-	-	-	-	-
CRP-6.095	-	-	-	-	-	-	-	-	-	-	-	-	-
CRP-6.096	220	-	-	-	-	-	-	-	1	-	-	-	-
CRP-6.097	-	-	-	-	-	-	-	-	-	-	-	-	-
CRP-6.098	-	-	-	-	-	-	-	-	-	-	-	-	-
CRP-6.099	-	-	-	-	-	-	-	-	-	-	-	-	-
CRP-6.100	225	-	-	-	-	-	-	-	1	-	-	-	-
CRP-6.101	_	-	-	_	_	-	_	_	-	_	-	_	90

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Burlington-Graham Signal System
Summary of Work by
Cable Routing Plans
(Sheet 9 of 18) Burlington & Graham

Division 7 Alamance County Graham

PLAN DATE: December 2017 REVIEWED BY: HA Badgett

CABLE ROUTING SHEET NUMBER	MESSENGER CABLE (1/4")	BOND MESSENGER CABLE	TRACER WIRE	UNDERGROUND CONDUIT (1 CONDUIT, 1 INCH)	UNDERGROUND CONDUIT (1 CONDUIT, 2 INCH)	UNDERGROUND CONDUIT (2 CONDUIT) 2 INCH)	DIRECTIONAL DRILL (2 CONDUIT, 2 INCH)	DIRECTIONAL DRILL (1 CONDUIT, 2 INCH)	JUNCTION BOX (OVER-SIZED)	JUNCTION BOX (SPECIAL-SIZED)		REMOVE EXISTING JUNCTION BOX	DELINEATOR MARKER	STANDARD GUY ASSEMBLY	AERIAL GUY ASSEMBLY	SIDEWALK GUY ASSEMBLY	1" RISER WITH WEATHERHEAD FOR CCTV ELEC SERVICE	1" RISER WITH WEATHERHEAD FOR CAT 6	1.25" RISER WITH HEAT SHRINK TUBING	2" RISER WITH HEAT SHRINK TUBING	HEAT SHRINK Tubing Kit		DRILL/ CORE DRILL EXIST FOUNDATION
	LF	EA	LF	LF	LF	LF	LF	LF	EA	EA	EA	EA	EA	EA	EA	EA	EA	EA	EA	EA	EA	EA	EA
CRP-6.102	-	3	520	-	-	-	520	-	2	1	-	-	-	1	-	-	-	-	-	2	1	-	-
CRP-6.103	305	1	-	-	-	-	-	-	-	-	-	-	-	1	-	-	-	-	-	-	1	-	-
CRP-6.104	-	1	75	-	-	75	-	-	2	-	-	-	-	-	-	-	-	-	-	1		-	-
CRP-6.105	-	1	-	-	-	-	-	-	-	-	-	-	-	-	-	-	-	-	-	-	1	-	-
CRP-6.106	-	4	535	-	-	50	-	-	1	2	-	2	-	1	-	-	-	-	-	-	4	-	-
CRP-6.107	295	1	-	-	-	-	-	-		-	-	-	-	-	-	-	-	-	-	-	1	-	-
CRP-6.108	1,565	1	-	-	-	-	-	-	-	-	-	-	-	4	-	-	-	-	-	-	1	-	-
CRP-6.109	1,465	1	-	-	-	-	-	-		-	-	-	-	-	-	-	-	-	-	-	-	-	-
CRP-6.110	1,440	1	-	-	-	-	-	-	-	-	-	-	-	1	-	-	-	-	-	-	•	-	-
CRP-6.111	1,405	1	-	-	-	-	-	-	-	-	-	-	-	2	-	-	-	-	-	-	-	-	-
CRP-6.112	1,430	1	-	-	-	-	-	-	-	-	-	-	-	1	-	-	-	-	-	1	-	-	-
CRP-6.113	985	1	-	-	-	-	-	-	-	-	-	-	-	2	-	-	-	-	-	1	-	-	-
CRP-6.114	-	3	-	-	-	-	-	-	-	-	-	-	-	-	-	-	-	-	-	-	3	-	-
CRP-6.115	-	7	595	-	-	40	-	-	-	1	-	1	-	2	-	-	-	-	-	1	6	-	-
CRP-6.116	-	-	2,090	-	-	-	-	-	-	2	-	2	-	-	-	-	-	-	-	-	•	-	-
CRP-6.117	-	-	1,390	-	-	-	-	-	-	1	-	1	-	-	-	-	-	-	-	-	-	-	-
CRP-6.118	-	-	1,405	-	-	55	410	-	3	1	-	1	-	-	-	-	-	-	-	-	-	-	-
CRP-6.119	110	5	320	-	-	320	-	-	3	-	-	-	-	4	-	-	-	-	1	1	3	-	-
CRP-6.120	-	4	-	-	-	-	-	-	-	-	-	-	-	-	-	-	1	-	-	1	3	1	-
CRP-6.121	-	4	-	-	-	-	-	-	-	-	-	-	-	1	1	-	-	-	-	-	4	-	-
CRP-6.122	-	2	140	-	20	-	140	-	2	-	-	-	-	1	1	1	1	-	-	1	-	1	-
CRP-6.123	75	1	-	-	-	-	-	-	-	-	-	-	-	-	-	-	-	-	-	1	-	1	-
CRP-6.124	-	1	-	-	-	-	-	-	-	-	-	-	-	-	-	-	-	-	-	-	1	-	-
CRP-6.125	-	1	-	-	-	-	-	-	-	-	-	-	-	-	-	-	-	-	-	-	-	-	-
CRP-6.126	-	1	-	-	-	-	-	-	-	-	-	-	-	-	-	-	-	-	-	-	1	-	-
CRP-6.127	-	2	1,710	-	-	-	-	-	-	2	-	2	-	-	-	-	-	-	-	-	2	-	-
CRP-6.128	-	2	175	-	-	-	175	-	2	-	-	-	-	1	-	-	-	-	-	1	1	-	-
CRP-6.129	-	1	-	-	-	-	-	-	-	-	-	-	-	1	1	-	-	-	-	1	-	1	-
CRP-6.130	1,070	3	120	-	-	-	120	-	1	-	-	-	-	4	1	-	-	2	-	1	1	-	-
CRP-6.131	1,270	2	800	-	-	-	800	-	3	1	-	-	-	7	1	-	-	-	-	2	-	-	-
CRP-6.132	600	1	-	-	-	-	-	-	-	-	-	-	-	-	-	-	-	-	-	-	1	-	-
CRP-6.133	165	2	-	-	-	-	-	-	-	-	-	-	-	1	-	-	-	1	1	-	1	-	-
CRP-6.134	-	1	-	-	-	-	-	-	-	-	-	-	-	-	-	-	-	-	-	1	-	1	-
CRP-6.135	-	1	-	-	-	-	-	-	-	-	-	-	-	-	-	-	-	-	-	-	-	-	-
CRP-6.136	-	1	-	-	-	-	-	-	-	-	-	-	-	-	-	-	-	-	-	-	-	-	-

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NTS

Burlington-Graham Signal System
Summary of Work by
Cable Routing Plans
(Sheet 10 of 18)
Burlington & Graham

Division 7 Alamance County Graham

PLAN DATE: December 2017 | REVIEWED BY: HA Badgett

REVIEWED BY: BJ Slocum AH/AW

CABLE ROUTING SHEET NUMBER	COMMUNICATIONS CABLE (12-FIBER)	COMMUNICATIONS CABLE (24-FIBER)	CITY IT COMMUNICATIONS CABLE (24-FIBER)	COMMUNICATIONS CABLE (36-FIBER)	COMMUNICATIONS CABLE (48-FIBER)	DROP CABLE (12- FIBER)	HANDLASH & AERIAL CABLE PROTECTOR	SPLICE ENCLOSURE	MODIFY EXISTING SPLICE OR INTERCONNECT CENTER	INTERCONNECT CENTER, PATCH PANEL, JUMPERS, FUSION SPLICE CABLE	ETHERNET EDGE SWITCH	REMOVE EXISTING COMMUNICATIONS CABLE	REMOVE CCTV CABINET	INSTALL CCTV CAMERA ASSEMBLY	REMOVE EX CCTV ASSEMBLY	POLE-MOUNTED CCTV CABINET (336)	POLE-MOUNTED CCTV CABINET (NEMA)		WOOD POLE
	LF	LF	LF	LF	LF	LF	LF	EA	EA	EA	EA	LF	EA	EA	EA	EA	EA	EA	EA
CRP-6.102	-	910	-	325	245	280	-	1	-	2	2	170	•	-	-	-	-	-	-
CRP-6.103	605	1,690	-	-	-	350	-	1	-	1	1	-	•	-	-	-	-	-	-
CRP-6.104	-	1,475	-	-	-	405	-	1	-	1	1	80	-	-	-	-	-	-	-
CRP-6.105	-	1,460	-	-	-	470	-	1	-	1	1	-	-	-	-	-	-	-	-
CRP-6.106	-	1,690	-	-	-	785	-	2	-	2	2	-	-	1	1	-	-	-	-
CRP-6.107	-	1,645	-	-	-	430	-	1	-	1	1	355	-	-	-	-	-	-	-
CRP-6.108	-	1,565	-	-	-	595	-	1	-	1	1	265	-	-	-	-	-	-	-
CRP-6.109	-	1,565	-	-	-	-	-	-	-	-	-	-	-	-	-	-	-	-	-
CRP-6.110	-	1,540	-	-	-	-	25	-	-	-	-	-	-	-	-	-	-	-	-
CRP-6.111	-	1,505	-	-	-	-	-	-	-	-	-	-	-	-	-	-	-	-	-
CRP-6.112	-	1,490	-	-	-	310	-	1	-	1	1	-	-	-	-	-	-	-	-
CRP-6.113	-	715	-	-	-	590	-	1	-	1	1	-		-	-	-	-	-	-
CRP-6.114	-	750	-	-	-	1,920	-	1	-	3	3	-		-	-	-	-	-	-
CRP-6.115	-	1,745	-	-	-	1,535	-	2	-	4	4	-		1	1	-	-	-	-
CRP-6.116	330	-	-	740	-	2,000	-	2	-	5	6	2,090	1	1	1	-	1	-	-
CRP-6.117	-	-	-	590	-	1,570	-	1	-	3	3	540	-	-	-	-	-	-	-
CRP-6.118	775	-	-	1,080	-	530	-	2	-	2	2	810	-	-	-	-	-	-	-
CRP-6.119	1,120	-	-	1,160	-	2,570	-	2	-	5	5	70	-	-	-	-	-	-	-
CRP-6.120	-	-	-	1,190	-	1,560	-	1	-	3	3	-	-	1	1	-	-	-	-
CRP-6.121	720	-	-	1,760	-	2,220	-	3	-	4	4	-		-	-	-	-	-	-
CRP-6.122	500	-	-	1,470	-	440	-	1	-	1	1	-	-	1	-	-	-	1	-
CRP-6.123	-	-	-	1,570	-	360	-	1	-	1	1	-	-	-	-	-	-	-	-
CRP-6.124	-	-	-	1,500	-	390	-	1	-	1	1	-		-	-	-	-	-	-
CRP-6.125	-	-	-	1,540	-	-	-	-	-	-	-	-	-	-	-	-	-	-	-
CRP-6.126	-	-	-	1,540	-	280	-	1	-	1	1	-	-	-	-	-	-	-	-
CRP-6.127	1,025	-	-	-	-	2,950	-	1	-	6	6	1,755	-	-	-	-	-	-	-
CRP-6.128	360	-	-	-	-	1,620	-	1	-	2	2	240		-	-	-	-	-	-
CRP-6.129	580	-	-	-	-	700	-	1	-	1	1	-		-	-	-	-	-	-
CRP-6.130	-	1,230	-	-	-	280	-	1	-	1	1	-		1	-	-	-	-	-
CRP-6.131	710	1,600	-	-	-	-	-	1	-	-	-	-	-	-	-	-	-	-	-
CRP-6.132	-	1,630	-	-	-	300	-	1	-	1	1	-	-	-	-	-	-	-	-
CRP-6.133	-	1,310	-	-	-	980	-	1	-	2	2	300	-	1	-	-	-	-	-
CRP-6.134	-	1,510	-	-	-	210	-	1	-	1	1	-	-	-	-	-	-	-	-
CRP-6.135	-	1,440	-	-	-	-	-	-	-	-	-	-	-	-	-	-	-	-	-
CRP-6.136	-	1,490	-	-	-	-	-	-	-	-	-	-	-	-	-	-	-	-	-

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DOCUMENT NOT CONSIDERED FINAL UNLESS ALL SIGNATURES COMPLETED



NTS

Burlington-Graham Signal System
Summary of Work by
Cable Routing Plans
(Sheet 11 of 18)
Burlington & Graham

Division 7 Alamance County Graham


PLAN DATE: December 2017 REVIEWED BY: HA Badgett AH/AW REVIEWED BY: BJ Slocum

CABLE ROUTING SHEET NUMBER	ETHERNET CABLE (CAT 6)	MODIFY ELEC SERVICE FOR CCTV	REMOVE EXISTING CABINET FOUNDATION	SERVICE CONDUCTORS	NEW ELEC SERVICE FOR CCTV OR RADIO	MODIFY ELEC SERVICE FOR CCTV OR RADIO	INSTALL CABINET FOUNDATION	BASE MOUNTED CCTV CABINET W/ EXTENDER	INSTALL CCTV METAL POLE	INSTALL 2.4 GHZ RADIO	REMOVE EX CCTV METAL POLE	REMOVE WRELESS COMM EQUIPMENT	BACK PULL FIBER-OPTIC CABLE
	LF	EA	EA	LF	EA	EA	EA	EA	EA	EA	EA	EA	EA
CRP-6.102	-	-	-	-	-	-	-	-	-	-	-	-	-
CRP-6.103	-	-	-	-	-	-	-	-	-	-	-	-	-
CRP-6.104	-	-	-	-	-	-	-	-	-	-	-	-	-
CRP-6.105	-	-	-	-	-	-	-	-	-	-	-	-	-
CRP-6.106	135	-	-	-	-	-	-	-	-	-	-	-	-
CRP-6.107	-	-	-	-	-	-	-	-	-	-	-	-	-
CRP-6.108	-	-	-	-	-	-	-	-	-	-	-	-	-
CRP-6.109	-	-	-	-	-	-	-	-	-	-	-	-	-
CRP-6.110	-	-	-	-	-	-	-	-	-	-	-	-	-
CRP-6.111	-	-	-	-	-	-	-	-	-	-	-	-	-
CRP-6.112	-	-	-	-	-	-	-	-	-	-	-	-	-
CRP-6.113	-	-	-	-	-	-	-	-	-	-	-	-	-
CRP-6.114	-	-	-	-	-	-	-	-	-	-	-	-	-
CRP-6.115	60	-	-	-	-	-	-	1	-	-	-	-	-
CRP-6.116	100	-	-	-	-	-	-	-	-	2	-	2	-
CRP-6.117	_	-	-	-	-	-	-	-	-	-	-	-	-
CRP-6.118	-	-	-	-	-	-	-	-	-	-	-	-	-
CRP-6.119	_	-	-	-	-	-	-	-	-	-	-	-	-
CRP-6.120	270	-	-	-	-	-	1	-	-	-	-	-	-
CRP-6.121	-	-	-	-	-	-	-	-	-	-	-	-	-
CRP-6.122	190	-	-	-	-	-	1	-	-	-	-	-	-
CRP-6.123	-	-	-	-	-	-	1	-	-	-	-	-	-
CRP-6.124	-	-	-	-	-	-	-	-	-	-	-	-	-
CRP-6.125	-	-	-	-	-	-	-	-	-	-	-	-	-
CRP-6.126	-	-	-	-	-	-	_	_	-	-	-	-	_
CRP-6.127	-	-	-	-	-	-	-	_	-	-	-	-	-
CRP-6.128	-	-	-	-	-	-	-	-	-	-	-	-	-
CRP-6.129	-	-	-	-	-	-	1	-	-	-	-	-	-
CRP-6.130	200	-	_	<u> </u>	_	-	-	_	1	_	-	-	-
CRP-6.131	-	_	-		-	-	-	-	-	-	-	_	_
CRP-6.132	_	_	-		-	-	-	-	-	-	-	_	_
CRP-6.133	55	_	-		-	-	_	_	_	-	-	_	_
CRP-6.134	_	_	-	_	-	-	1	_	-	-	-	_	-
CRP-6.135	_	_	-	<u>-</u>	-	-	<u> </u>	_	-	-	-	_	-
CRP-6.136		_	-	<u> </u>	-	-	<u> </u>	-	-	<u> </u>	_	_	-

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Burlington-Graham Signal System
Summary of Work by
Cable Routing Plans
(Sheet 12 of 18)
Burlington & Graham

Division 7 Alamance County Graham

PLAN DATE: December 2017 | REVIEWED BY: HA Badgett

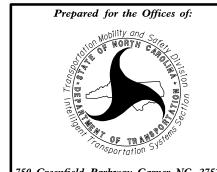CRP-1.012 U-6015

## SUMMARY OF WORK BY CABLE ROUTING PLANS

CABLE ROUTING SHEET NUMBER	MESSENGER CABLE (1/4")	BOND MESSENGER CABLE	TRACER WIRE	UNDERGROUND CONDUIT (1 CONDUIT, 1 INCH)	UNDERGROUND CONDUIT (1 CONDUIT, 2 INCH)	UNDERGROUND CONDUIT (2 CONDUIT 2 INCH)	T, DIRECTIONAL DRILL (2 CONDUIT, 2 INCH)	DIRECTIONAL DRILL (1 CONDUIT, 2 INCH)	JUNCTION BOX (OVER-SIZED)	JUNCTION BOX (SPECIAL-SIZED)	JUNCTION BOX STANDARD- SIZED)	REMOVE EXISTING JUNCTION BOX	DELINEATOR MARKER	STANDARD GUY ASSEMBLY	AERIAL GUY ASSEMBLY	SIDEWALK GUY ASSEMBLY	1" RISER WITH WEATHERHEAD FOR CCTV ELEC SERVICE	1" RISER WITH WEATHERHEAD FOR CAT 6	1.25" RISER WITH HEAT SHRINK TUBING	2" RISER WITH HEAT SHRINK TUBING	HEAT SHRINK TUBING KIT		DRILL/ CORE DRILL EXIST FOUNDATION
	LF	EA	LF	LF	LF	LF	LF	LF	EA	EA	EA	EA	EA	EA	EA	EA	EA	EA	EA	EA	EA	EA	EA
CRP-6.137	-	1	-	-	-	-	-	-	-	-	-	-	-	1	-	-	-	-	-	-	1	-	-
CRP-6.138	290	3	-	-	-	-	-	-	-	-	-	-	-	3	-	-	-	-	-	-	1	-	-
CRP-6.139	-	1	-	-	-	-	-	-	-	-	-	-	-	1	1	-	-	-	-	-	-	-	-
CRP-6.140	-	2	240	-	10	-	240	-	-	1	-	-	-	-	-	-	-	-	-	1	1	1	-
CRP-6.141	-	1	1,200	-	-	-	1,200	-	3	-	-	-	-	-	-	-	-	-	-	1	-	-	-
CRP-6.142	-	2	120	-	-	-	-	-	-	-	-	-	-	2	2	-	-	-	-	-	2	-	-
CRP-6.143	-	1	-	-	-	-	-	-	-	-	-	-	-	-	-	-	-	-	-	-	-	-	-
CRP-6.144	-	-	920	-	-	-	920	-	3	1	-	-	-	-	-	-	-	-	-	-	-	1	-
CRP-6.145	-	1	-	-	-	-	-	•	-	-	-	-	-	-	-	-	-	-	-	-	1	-	-
CRP-6.146	-	1	-	-	-	-	-	-	-	-	-	-	-	-	-	-	-	-	-	1	-	1	-
CRP-6.147	-	2	-	-	25	-	-	-	-	-	-	-	-	2	2	-	-	1	-	-	1	-	1
CRP-6.148	140	1	-	-	-	-	-	-	-	-	-	-	-	5	1	-	-	-	-	1	-	1	-
CRP-6.149	-	1	-	-	-	-	-	-	-	-	-	-	-	-	-	-	-	-	-	1	-	1	-
CRP-6.150	-	1	-	-	-	-	-	•	-	-	-	-	-	1	-	-	-	-	-	-	1	-	-
CRP-6.151	-	2	-	-	-	-	-	-	-	-	-	-	-	2	-	-	-	1	-	-	2	-	-
CRP-6.152	-	1	-	-	-	-	-	-	-	-	-	-	-	-	-	-	-	-	-	-	-	-	-
CRP-6.153	-	1	-	-	-	-	-	-	-	-	-	-	-	-	-	2	-	-	-	-	1	-	-
CRP-6.154	-	1	-	-	-	-	-	-	-	-	-	-	-	-	-	-	-	-	-	-	-	-	-
CRP-6.155	1,480	1	-	-	-	-	-	-	-	-	-	-	-	-	-	-	-	-	-	-	-	-	-
CRP-6.156	1,470	1	-	-	-	-	-	-	-	-	-	-	-	1	-	-	-	-	1	-	-	-	-
CRP-6.157	445	2	695	-	-	-	-	-	-	-	-	-	-	3	-	-	-	-	-	1	2	-	-
CRP-6.158	1,425	1	-	-	-	-	-	-	-	-	-	-	-	-	-	-	-	-	-	-	-	-	-
CRP-6.159	1,430	1	-	-	-	-	-	-	-	-	-	-	-	-	-	-	-	-	-	-	-	-	-
CRP-6.160	625	1	-	-	-	-	-	-	-	-	-	-	-	2	-	-	-	-	-	1	-	1	-
CRP-6.161	-	1	-	-	-			-		-	-	-	-	-	-	-	-	-	-	-	1	-	-
CRP-6.162	-	-	1,440	-	-	-	975	-	1	1	-	-	1	-	-	-	-	-	-	-	-	-	1
CRP-6.163	-	-	1,465	-	-	1,190	275	•	4	-	-	-	1	-	-	-	-	-	-	-	-	-	-
CRP-6.164	-	-	1,180	-	-	1,180	-	-	1	-	-	-	1	-	-	-	-	-	-	-	-	-	-
CRP-6.165	-	-	230	-	-	105	125	•	1	1	-	-	-	-	-	-	-	-	-	-	-	-	-
CRP-6.166	365	2	1,040	-	-	255	790	-	4	1	-	1	-	2	-	-	-	-	-	2	-	-	-
CRP-6.167	-	-	1,440	-	-	680	-	-	-	-	-	-	-	-	-	-	-	-	-	-	-	-	-
CRP-6.168	-	-	1,480	-	-	-	-	-	-	-	-	-	-	-	-	-	-	-	-	-	-	-	-
CRP-6.169	-	2	1,020	-	-	-	-	-	-	-	-	-	-	-	-	-	-	-	-	-	2	-	-
CRP-6.170	510	1	150	-	-	-	-	-	1	-	-	-	-	1	-	-	-	-	-	1	-	-	-
CRP-6.171	-	1	1,120	-	-	-	-	-	-	-	-	-	-	-	-	-	-	-	-	-	2	-	-

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Burlington-Graham Signal System
Summary of Work by
Cable Routing Plans
(Sheet 13 of 18)
Burlington & Graham

Division 7 Alamance County Graham

PLAN DATE: December 2017 | REVIEWED BY: HA Badgett

CABLE ROUTING SHEET NUMBER	COMMUNICATIONS CABL (12-FIBER)	E COMMUNICATIONS CABLE (24-FIBER)	CITY IT COMMUNICATIONS CABLE (24-FIBER)	COMMUNICATIONS CABLE (36-FIBER)	COMMUNICATIONS CABLE (48-FIBER)	DROP CABLE (12- FIBER)	HANDLASH & AERIAL CABLE PROTECTOR	SPLICE ENCLOSURE	MODIFY EXISTING SPLICE OR INTERCONNECT CENTER	INTERCONNECT CENTER, PATCH PANEL, JUMPERS, FUSION SPLICE CABLE	ETHERNET EDGE SWITCH	REMOVE EXISTING COMMUNICATIONS CABLE	REMOVE CCTV CABINET	INSTALL CCTV CAMERA ASSEMBLY	REMOVE EX CCTV ASSEMBLY	POLE-MOUNTED CCTV CABINET (336)	POLE-MOUNTED CCTV CABINET (NEMA)		WOOD POLI
	LF	LF	LF	LF	LF	LF	LF	EA	EA	EA	EA	LF	EA	EA	EA	EA	EA	EA	EA
CRP-6.137	1,430	-	-	-	-	180	-	1	-	1	1	-	-	-	-	-	-	-	-
CRP-6.138	440	1,690	-	-	-	180	-	1	-	1	1	290	-	-	-	-	-	-	-
CRP-6.139	-	1,460	-	-	-	-	-	-	-	-	-	-	-	-	-	-	-	-	-
CRP-6.140	-	540	-	-	-	715	-	1	-	2	2	-	-	-	-	-	-	-	-
CRP-6.141	-	1,380	-	-	-	-	-	-	-	-	-	-	-	-	-	-	-	-	-
CRP-6.142	-	1,830	-	-	-	980	-	1	-	2	2	110	-	-	-	-	-	-	-
CRP-6.143	-	1,470	-	-	-	-	-	-	-	-	-	-	-	-	-	-	-	-	-
CRP-6.144	-	1,040	-	-	-	45	-	1	-	1	1	-	-	-	-	-	-	-	-
CRP-6.145	1,430	-	-	-	-	260	-	1	-	1	1	-	-	-	-	-	-	-	-
CRP-6.146	1,060	-	-	-	-	200	-	1	-	1	1	-	-	-	-	-	-	-	-
CRP-6.147	1,280	-	-	-	-	605	-	1	-	1	1	-	-	1	-	-	-	1	-
CRP-6.148	1,400	-	-	-	-	420	-	1	-	1	1	-	-	-	-	-	-	-	-
CRP-6.149	1,620	-	-	-	-	270	-	1	-	1	1	-	-	-	-	-	-	-	-
CRP-6.150	1,570	-	-	-	-	415	-	1	-	1	1	-	-	-	-	-	-	-	-
CRP-6.151	2,315	-	-	-	-	815	-	1	-	2	2	-	-	1	-	-	-	-	-
CRP-6.152	1,390	-	-	-	-	-	-	-	-	-	-	-	-	-	-	-	-	-	-
CRP-6.153	490	-	-	-	-	290	-	1	-	1	1	-	-	-	-	-	-	-	-
CRP-6.154	1,430	-	-	-	-	-	-	-	-	-	-	-	-	-	-	-	-	-	-
CRP-6.155	1,580	-	-	-	-	-	-	-	-	-	-	-	-	-	-	-	-	-	-
CRP-6.156	1,380	-	-	-	-	330	-	1	-	1	1	-	-	-	-	-	-	-	1
CRP-6.157	1,860	-	1,760	-	-	1,385	-	1	-	2	2	-	-	-	-	-	-	-	-
CRP-6.158	1,525	-	1,525	-	-	-	-	-	-	-	-	-	-	-	-	-	-	-	-
CRP-6.159	1,530	-	1,530	-	-	-	-	-	-	-	-	-	-	-	-	-	-	-	-
CRP-6.160	580	-	595	-	-	450	-	1	-	1	1	-	-	-	-	-	-	-	-
CRP-6.161	1,205	-	-	-	-	320	-	1	-	1	1	-	-	-	-			-	-
CRP-6.162	1,530	-	-	-	-	65	-	1	-	1	1	470	-	-	-	-	-	-	-
CRP-6.163	1,585	-	-	-	-	-	-	-	-	-	-	-	-	-	-	-	-	-	-
CRP-6.164	1,210	-	-	-	-	-	-	-	-	-	-	-	-	-	-	-	-	-	-
CRP-6.165	290	-	-	-	-	45	-	1	-	1	1	-	-	-	-	-	-	-	-
CRP-6.166	-	1,615	-	-	-	690	-	1	-	1	1	-	-	-	-	-	-	-	-
CRP-6.167	-	1,500	-	-	-	-	-	-	-	-	-	760	-	-	-	-	-	-	-
CRP-6.168	-	1,540	-	-	-	-	-	-	-	-	-	1,480	-	-	-	-	-	-	-
CRP-6.169	-	1,600	-	-	-	220	-	1	-	1	1	1,015	-	-	-	-	-	-	-
CRP-6.170	-	1,580	-	-	-	-	-	-	-	-	-	145	-	-	-	-	-	-	-
CRP-6.171	_	1,640	-	-	-	290	10	1	-	1	1	-	-	-	-	-	-	-	-

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Burlington-Graham Signal System
Summary of Work by
Cable Routing Plans
(Sheet 14 of 18)
Burlington & Graham

Division 7 Alamance County Graham

PLAN DATE: December 2017 | REVIEWED BY: HA Badgett

AH/AW REVIEWED BY: BJ Slocum

NTS

CRP-1.014 U-6015


# SUMMARY OF WORK BY CABLE ROUTING PLANS

CABLE ROUTING SHEET NUMBER	ETHERNET CABLE (CAT 6)	MODIFY ELEC SERVICE FOR CCTV	REMOVE EXISTING CABINET FOUNDATION	SERVICE CONDUCTORS	NEW ELEC SERVICE FOR CCTV OR RADIO	MODIFY ELEC SERVICE FOR CCTV OR RADIO	INSTALL CABINET FOUNDATION	BASE MOUNTED CCTV CABINET W EXTENDER	INSTALL CCTV METAL POLE	INSTALL 2.4 GHZ RADIO	REMOVE EX CCTV METAL POLE	REMOVE WIRELESS COMM EQUIPMENT	BACK PULL FIBER-OPTIC CABLE
	LF	EA	EA	LF	EA	EA	EA	EA	EA	EA	EA	EA	EA
CRP-6.137	-	-	-	-	-	-	-	-	-	-	-	-	-
CRP-6.138	-	-	-	-	-	-	-	-	-	-	-	-	-
CRP-6.139	-	-	-	-	-	-	-	-	-	-	-	-	-
CRP-6.140	-	-	-	-	-	•	1	-	-	-	-	•	-
CRP-6.141	-	•	-	-	-	-	-	-	-	-	-	-	-
CRP-6.142	-	-	-	-	-	-	-	-	-	-	-	-	-
CRP-6.143	-	-	-	-	-	-	-	-	-	-	-	-	-
CRP-6.144	-	-	-	-	-	-	1	-	-	-	-	-	-
CRP-6.145	-	-	-	-	-	-	-	-	-	-	-	-	-
CRP-6.146	-	-	-	-	-	-	1	-	-	-	-	-	-
CRP-6.147	60	-	-	-	-	-	-	-	-	-	-	-	-
CRP-6.148	-	-	-	-	-	-	1	-	-	-	-	-	-
CRP-6.149	-	-	-	-	-	-	1	-	-	-	-	-	-
CRP-6.150	-	-	-	-	-	-	-	-	-	-	-	-	-
CRP-6.151	225	-	-	-	-	-	-	-	-	-	-	-	-
CRP-6.152	-	-	-	-	-	-	-	-	-	-	-	-	-
CRP-6.153	-	-	-	-	-	-	-	-	-	-	-	-	-
CRP-6.154	-	-	-	-	-	-	-	-	-	-	-	-	-
CRP-6.155	-	-	-	-	-	-	-	-	-	-	-	-	-
CRP-6.156	-	-	-	-	-	-	-	-	-	-	-	-	-
CRP-6.157	-	-	-	-	-	-	-	-	-	-	-	-	-
CRP-6.158	-	-	-	-	-	-	-	-	-	-	-	-	-
CRP-6.159	-	-	-	-	-	-	-	-	-	-	-	-	-
CRP-6.160	-	-	1	-	-	-	1	-	-	-	-	-	-
CRP-6.161	-	-	-	-	-	-	-	-	-	-	-	-	-
CRP-6.162	-	-	-	-	-	-	-	-	-	-	-	-	-
CRP-6.163	-	-	-	-	-	-	-	-	-	-	-	-	-
CRP-6.164	-	-	-	-	-	-	-	-	-	-	-	-	-
CRP-6.165	-	-	-	-	-	-	-	-	-	-	-	-	-
CRP-6.166	-	-	-	-	-	-	-	-	-	-	-	-	-
CRP-6.167	-	-	-	-	-	-	-	-	-	-	-	-	-
CRP-6.168	-	-	-	-	-	-	-	-	-	-	-	-	-
CRP-6.169	-	-	-	-	-	-	-	-	-	-	-	-	-
CRP-6.170	-	-	-	-	-	-	-	-	-	-	-	-	-
CRP-6.171	-	-	-	-	-	-	-	-	-	-	-	-	-

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Burlington-Graham Signal System
Summary of Work by
Cable Routing Plans
(Sheet 15 of 18)
Burlington & Graham

Olivision 7 Alamance County Graham

PLAN DATE: December 2017 | REVIEWED BY: HA Badgett

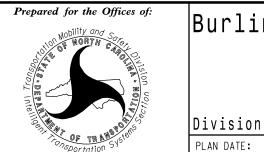CABLE ROUTING SHEET NUMBER	MESSENGER CABLE (1/4")	BOND MESSENGER CABLE	TRACER WIRE	UNDERGROUND CONDUIT (1 CONDUIT, 1 INCH)	UNDERGROUND CONDUIT (1 CONDUIT, 2 INCH)	UNDERGROUND CONDUIT (2 CONDUI 2 INCH)		DIRECTIONAL DRILL (1 CONDUIT, 2 INCH)	JUNCTION BOX (OVER-SIZED)	JUNCTION BOX (SPECIAL-SIZED)	JUNCTION BOX STANDARD- SIZED)	REMOVE EXISTING JUNCTION BOX	DELINEATOR MARKER	STANDARD GUY ASSEMBLY	AERIAL GUY ASSEMBLY	SIDEWALK GUY ASSEMBLY	1" RISER WITH WEATHERHEAD FOR CCTV ELEC SERVICE	1" RISER WITH WEATHERHEAD FOR CAT 6	1.25" RISER WITH HEAT SHRINK TUBING	2" RISER WITH HEAT SHRINK TUBING	HEAT SHRINK TUBING KIT		O DRILL/ CORE DRILL EXIST FOUNDATION
	LF	EA	LF	LF	LF	LF	LF	LF	EA	EA	EA	EA	EA	EA	EA	EA	EA	EA	EA	EA	EA	EA	EA
CRP-6.172	-	2	-	50	-	-	-	-	-	-	-	-	-	-	-	-	-	1	-	-	1	-	-
CRP-6.173	-	1	-	-	25	-	-	-	-	-	-	-	-	-	-	-	-	-	-	1	-	1	-
CRP-6.174	-	1	-	-	-	-	-	-	-	-	-	-	-	-	-	-	-	-	-	-	1	-	-
CRP-6.175	-	1	-	-	-	-	-	-	-	-	-	-	-	1	2	-	-	-	-	-	1	-	-
CRP-6.176	-	4	485	-	-	-	-	-	-	-	-	-	-	-	-	-	-	-	-	-	4	-	
CRP-6.177	-	1	-	-	-	-	-	-	-	-	-	-	-	-	-	-	-	-	-		1	-	-
CRP-6.178	-	2	170	-	-	-	170	-	1	-	-	-	-	-	-	-	-	-	-	1	1	-	-
CRP-6.179	-	1	1,115	-	-	-	1,115	-	5	1	-	-	-	-	-	-	-	1	-	-	-	-	-
CRP-6.180	-	3	-	-	-	-	-	-	-	-	-	-	-	-	-	-	-	-	-	-	3	-	-
CRP-6.181	-	1	660	-	-	-	660	-	2	-	-	-	-	-	-	-	-	-	1	1	-	-	-
CRP-6.182	20	1	-	-	-	-	-	-	-	-	•	-	-	2	4	-	-	-	-	-	1	-	-
CRP-6.183	710	1	-	-	-	-	-	-	-	-	•	-	-	-	-	-	-	-	1	-	-	-	-
CRP-6.184	925	2	620	-	-	115	505	-	3	1	-	-	-	3	-	1	-	-	-	2	-	-	-
CRP-6.185	2,210	1	-	-	-	-	-	-	-	-	-	-	-	7	2	1	-	-	-	1	-	1	-
CRP-6.186	525	1	-	-	-	-	-	-	-	-	-	-	-	1	1	-	-	-	-	-	-	-	-
CRP-6.187	-	2	-	-	-	-	-	-	-	-	-	-	-	-	-	-	-	-	-	-	2	-	-
CRP-6.188	-	-	-	-	-	-	-	-	-	-	-	-	-	-	-	-	-	-	-	-	-	-	-
CRP-6.189	-	1	-	-	-	-	-	-	-	-	-	-	-	-	-	-	-	-	-	-	1	-	-
CRP-6.190	1,345	1	-	-	-	-	-	-	-	-	-	-	-	3	-	-	-	-	1	-	-	-	-
CRP-6.191	1,565	3	300	-	20	-	300	-	2	-	-	-	-	4	1	-	-	-	-	3	-	1	-
CRP-6.192	1,435	-	-	-	-	-	-	-	-	-	-	-	-	1	-	-	-	-	-	-	-	-	-
CRP-6.193	880	1	-	-	-	-	-	-	-	-	•	-	-	5	-	-	-	-	1	-	-	-	-
CRP-6.194	120	1	-	-	-	-	-	-	-	-	-	-	-	2	2	-	-	-	-	-	1	-	-
CRP-6.195	1,390	1	-	-	-	-	-	-	-	-	-	-	-	-	-	-	-	-	-	-	-	-	-
CRP-6.196	1,205	1	-	-	-	-	-	-	-	-	-	-	-	1	-	-	-	-	-	-	1	-	-
CRP-6.197	1,055	3	180	-	20	180	-	-	-	1	2	1	-	6	-	-	-	-	-	3	-	-	-
CRP-6.198	-	-	115	-	175	-	-	95	-	1	2	1	-	-	-	-	1	-	-	-	-	-	-
CRP-6.199	-	-	240	-	250	240	-	-	1	1	2	1	-	-	-	-	-	-	-	-	-	-	-
TOTALS	47,895	280	52,120	75	875	8,900	12,870	550	78	38	17	26	3	217	63	11	3	16	11	77	130	24	8

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Burlington-Graham Signal System
Summary of Work by
Cable Routing Plans
(Sheet 16 of 18)
Burlington & Graham

Division 7 Alamance County Graham

PLAN DATE: December 2017 | REVIEWED BY: HA Badgett AH/AW REVIEWED BY: BJ Slocum

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CABLE ROUTING SHEET NUMBER	COMMUNICATIONS CABLE (12-FIBER)	COMMUNICATIONS CABLE (24-FIBER)	CITY IT COMMUNICATIONS CABLE (24-FIBER)	COMMUNICATIONS CABLE (36-FIBER)	COMMUNICATIONS CABLE (48-FIBER)	DROP CABLE (12- FIBER)	HANDLASH & AERIAL CABLE PROTECTOR	SPLICE ENCLOSURE	MODIFY EXISTING SPLICE OR INTERCONNECT CENTER	INTERCONNECT CENTER, PATCH PANEL, JUMPERS, FUSION SPLICE CABLE	ETHERNET EDGE SWITCH	REMOVE EXISTING COMMUNICATIONS CABLE	REMOVE CCTV CABINET	INSTALL CCTV CAMERA ASSEMBLY	REMOVE EX CCTV ASSEMBLY	POLE-MOUNTED CCTV CABINET (336)	POLE-MOUNTED CCTV CABINET (NEMA)		WOOD POLE
	LF	LF	LF	LF	LF	LF	LF	EA	EA	EA	EA	LF	EA	EA	EA	EA	EA	EA	EA
CRP-6.172	-	1,790	-	-	-	340	-	1	-	1	1	-	-	1	-	-	-	-	-
CRP-6.173	-	1,480	-	-	-	445	-	1	-	1	1	-	-	-	-	-	-	-	-
CRP-6.174	-	1,500	-	-	-	260	-	1	-	1	1	-	-	-	-	-	-	-	-
CRP-6.175	-	1,520	-	-	-	270	-	1	-	1	1	-	-	-	-	-	-	-	-
CRP-6.176	-	1,750	-	-	-	1,395	-	2	-	3	3	485	-	1	1	-	-	-	-
CRP-6.177	-	1,485	-	-	-	430	-	1	-	1	1	155	-	-	-	-	-	-	-
CRP-6.178	380	1,180	-	-	840	595	-	1	-	1	1	-	-	-	-	-	-	-	-
CRP-6.179	945	-	-	-	1,145	665	-	-	-	2	2	-	-	1	-	-	-	-	-
CRP-6.180	-	-	-	-	1,070	1,550	-	1	-	3	3	-	-	-	-	-	-	-	-
CRP-6.181	-	-	-	1,290	-	210	-	1	-	1	1	-	-	-	-	-	-	-	1
CRP-6.182	-	-	-	1,520	-	280	65	1	-	1	1	110	-	-	-	-	-	-	-
CRP-6.183	400	-	-	1,580	-	260	-	1	-	1	1	-	-	-	-	-	-	-	-
CRP-6.184	-	-	-	1,720	-	45	-	1	-	1	1	-	-	-	-	-	-	-	-
CRP-6.185	1,280	-	-	1,750	-	505	-	1	-	1	1	-	-	-	-	-	-	-	-
CRP-6.186	-	-	-	1,490	-	-	-	-	-	-	-	-	-	-	-	-	-	-	-
CRP-6.187	-	-	-	1,730	-	1,505	-	1	-	2	2	30	-	-	-	-	-	-	-
CRP-6.188	1,425	-	-	-	-	-	-	-	-	-	-	-	-	-	-	-	-	-	-
CRP-6.189	600	-	-	-	-	425	-	1	-	1	1	-	-	-	-	-	-	-	-
CRP-6.190	1,185	-	-	-	-	535	-	1	-	1	1	-	-	-	-	-	-	-	-
CRP-6.191	1,985	-	-	-	-	285	-	1	-	1	1	-	-	-	-	-	-	-	-
CRP-6.192	1,535	-	-	-	-	-	-	-	-	-	-	-	-	-	-	-	-	-	-
CRP-6.193	755	-	-	-	-	360	-	1	-	1	1	-	-	-	-	-	-	-	-
CRP-6.194	1,090	-	-	-	-	325	-	1	-	1	1	80	-	-	-	-	-	-	-
CRP-6.195	1,490	-	-	-	-	-	60	-	-	-	-	-	-	-	-	-	-	-	-
CRP-6.196	950	-	-	-	-	500	30	1	-	1	1	-	-	-	-	-	-	-	-
CRP-6.197	945	-	-	-	-	700	-	2	-	2	2	-	-	1	-	-	-	-	1
CRP-6.198	-	-	-	-	-	160	-	1	-	1	1	-	-	1	-	1	-	-	1
CRP-6.199	-	-	-	-	-	300	-	1	-	1	1	-	-	1	-	1	-	-	-
TOTALS	64,905	123,530	15,900	91,035	38,800	84,585	190	161	1	208	208	35,150	2	40	13	3	1	3	7

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(Sheet 17 of 18)
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Division 7 Alamance County Graham

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CABLE ROUTING SHEET NUMBER	ETHERNET CABLE (CAT 6)	MODIFY ELEC SERVICE FOR CCTV	REMOVE EXISTING CABINET FOUNDATION	SERVICE CONDUCTORS	NEW ELEC SERVICE FOR CCTV OR RADIO	MODIFY ELEC SERVICE FOR CCTV OR RADIO	INSTALL CABINET FOUNDATION	BASE MOUNTED CCTV CABINET W/ EXTENDER	INSTALL CCTV METAL POLE	INSTALL 2.4 GHZ RADIO	REMOVE EX CCTV METAL POLE	REMOVE WRELESS COMM EQUIPMENT	BACK PULL FIBER-OPTIC CABLE
	LF	EA	EA	LF	EA	EA	EA	EA	EA	EA	EA	EA	EA
CRP-6.172	270	-	-	-	-	-	-	-	1	-	-	-	-
CRP-6.173	-	-	-	-	-	-	1	-	-	-	-	-	-
CRP-6.174	-	-	-	-	-	-	-	-	-	-	-	-	-
CRP-6.175	-	-	-	-	-	-	-	-	-	-	-	-	-
CRP-6.176	70	-	-	-	-	-	-	1	-	-	-	-	-
CRP-6.177	-	-	-	-	-	-	-	-	-	-	-	-	-
CRP-6.178	-	-	-	-	-	-	-	-	-	-	-	-	-
CRP-6.179	110	-	-	-	-	-	-	-	-	-	-	-	-
CRP-6.180	-	-	-	-	-	-	-	-	-	-	-	-	-
CRP-6.181	-	-	-	-	-	-	-	-	-	-	-	-	-
CRP-6.182	-	-	-	-	-	-	-	-	-	-	-	-	-
CRP-6.183	-	-	-	-	-	-	-	-	-	-	-	-	-
CRP-6.184	-	-	-	-	-	-	-	-	-	-	-	-	-
CRP-6.185	-	-	-	-	-	-	1	-	-	-	-	-	-
CRP-6.186	-	-	-	-	-	-	-	-	-	-	-	-	-
CRP-6.187	-	-	-	-	-	-	-	-	-	-	-	-	-
CRP-6.188	-	-	-	-	-	-	-	-	-	-	-	-	-
CRP-6.189	-	-	-	-	-	-	-	-	-	-	-	-	-
CRP-6.190	-	-	-	-	-	-	-	-	-	-	-	-	-
CRP-6.191	-	-	1	-	-	-	1	-	-	-	-	-	-
CRP-6.192	-	-	-	-	-	-	-	-	-	-	-	-	-
CRP-6.193	-	-	-	-	-	-	-	-	-	-	-	-	-
CRP-6.194	-	-	-	-	-	-	-	-	-	-	-	-	-
CRP-6.195	-	-	-	-	-	-	-	-	-	-	-	-	-
CRP-6.196	-	-	-	-	-	-	-	-	-	-	-	-	-
CRP-6.197	-	-	-	-	-	-	-	-	1	-	-	-	-
CRP-6.198	45	-	-	155	2	-	-	-	1	-	-	-	-
CRP-6.199	-	1	-	250	1	1	-	-	1	-	-	-	-
TOTALS	6,135	1	3	405	4	1	25	3	17	2	1	2	2,660

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(Sheet 18 of 18)
Burlington & Graham

Division 7 Alamance County Graham

PLAN DATE: December 2017 | REVIEWED BY: HA Badgett



#### U-6015 CRP-2.000

#### CCTV INSTALLATION SUMMARY

					F	POLE				POWER SER	VICE		
SHEET REFERENCE	CCTV CAMERA NUMBER	LOCATION	QUADRANT	TYPE	STATUS	USE TYPE	LENGTH (FT)	CAMERA STATUS	CAMERA MOUNTING HEIGHT (FT)	TYPE	STATUS	CABINET TYPE	DIST. TO SIGNAL CABINET
CRP-064	CCTV-1	HUFFMAN MILL ROAD & I-85	SW	STEEL	EXIST.	CCTV ONLY	50'	REPLACE	45'	UNDERGROUND	EXIST.	TYPE 336 CCTV	n/a
CRP-014	CCTV-2	HUFFMAN MILL ROAD & CHURCH STREET	SE	STEEL	EXIST.	CCTV ONLY	50'	REPLACE	45'	UNDERGROUND	EXIST.	TYPE 336 CCTV	200'
CRP-089	CCTV-3	ALAMANCE ROAD & I-85	SW	STEEL	EXIST.	CCTV ONLY	50'	REPLACE	45'	UNDERGROUND	EXIST.	TYPE 336 CCTV	n/a
CRP-115	CCTV-4	MAPLE AVENUE & I-85	NW	STEEL	EXIST.	CCTV ONLY	50'	REPLACE	45'	UNDERGROUND	EXIST.	TYPE 336 CCTV	n/a
CRP-176	CCTV-5	MAIN STREET & I-85	NW	STEEL	EXIST.	CCTV ONLY	50'	REPLACE	45'	UNDERGROUND	EXIST.	TYPE 336 CCTV	n/a
CRP-106	CCTV-6	HARDEN STREET & I-85	SW	STEEL	EXIST.	CCTV ONLY	50'	REPLACE	45'	UNDERGROUND	EXIST.	TYPE 336 CCTV	n/a
CRP-120	CCTV-7	MEBANE STREET & WEBB AVENUE	SE	STEEL	EXIST.	CCTV ONLY	50'	REPLACE	45'	UNDERGROUND	EXIST.	TYPE 336 CCTV	100'
CRP-019	CCTV-8	CHURCH STREET & O'NEAL STREET	SW	STEEL	EXIST.	CCTV ONLY	50'	REPLACE	45'	UNDERGROUND	EXIST.	TYPE 336 CCTV	n/a
CRP-038	CCTV-9	US 70 (CHURCH STREET) & GRAHAM-HOPEDALE ROAD (REMOVE)	SE	STEEL	REMOVE	n/a	50'	REMOVE	n/a	REMOVE	REMOVE	REMOVE	n/a
CRP-051	CCTV-10	UNIVERSITY DRIVE & I-85	SW	WOOD	EXIST.	CCTV ONLY	50'	REPLACE	45'	UNDERGROUND	EXIST.	TYPE 332 CCTV	n/a
CRP-007	CCTV-11	US 70 (CHURCH STREET) & ST. MARKS CHURCH ROAD (REMOVE)	SE	WOOD	REMOVE	n/a	40'	REMOVE	n/a	REMOVE	REMOVE	REMOVE	n/a
CRP-116	CCTV-12	SOUTH MAIN STREET & EAST DAVIS STREET (LABCORP BLDG.)	NE	BUILD.	EXIST.	CCTV ONLY	n/a	REPLACE	SAME	BUILDING	EXIST.	NEMA 4	n/a
CRP-050	CCTV-13	UNIVERSITY DRIVE & BOONE STATION DRIVE	NW	STEEL	EXIST.	CCTV ONLY	35'	REPLACE	32'	PoE	EXIST.	TYPE 332 SIGNAL	0'
CRP-005	CCTV-14	US 70 (CHURCH STREET) & UNIVERSITY DRIVE	SE	STEEL	PROP.	CCTV ONLY	50'	PROPOSED	45'	PoE	EXIST.	TYPE 332 SIGNAL	280'
CRP-133	CCTV-15	NC 87 (WEBB AVE.) & GLEN RAVEN RD.	NW	WOOD	REPL.	JOINT	50'	PROPOSED	37'	PoE	EXIST.	TYPE 332 SIGNAL	55'
CRP-057	CCTV-16	ST. MARKS CHURCH ROAD/JAVA LANE & BOONE STATION DRIVE	NE	STEEL	PROP.	CCTV ONLY	50'	PROPOSED	45'	PoE	EXIST.	TYPE 332 SIGNAL	80'
CRP-081	CCTV-17	NC 54 (CHAPEL HILL ROAD) & S. MEBANE STREET	SE	STEEL	EXIST.	JOINT	35'	PROPOSED	30'	PoE	EXIST.	TYPE 332 SIGNAL	190'
CRP-122	CCTV-18	NC 87 (WEBB AVENUE) & NC 100 (ANTHONY STREET)	SE	WOOD	PROP.	CCTV ONLY	50'	PROPOSED	37'	PoE	EXIST.	TYPE 332 SIGNAL	190'
CRP-179	CCTV-19	PINE STREET & MAPLE STREET (CITY OF GRAHAM)	NW	WOOD	EXIST.	JOINT	40'	PROPOSED	27'	PoE	EXIST.	TYPE 332 SIGNAL	110'
CRP-172	CCTV-20	MOORE STREET & S. MAIN STREET (NC 87) (CITY OF GRAHAM)	NE	STEEL	PROP.	CCTV ONLY	50'	PROPOSED	45'	PoE	EXIST.	TYPE 332 SIGNAL	270'
CRP-027	CCTV-21	N. FISHER STREET & W. HOLT STREET/RAUHUT STREET	SW	STEEL	PROP.	CCTV ONLY	50'	PROPOSED	45'	PoE	EXIST.	TYPE 332 SIGNAL	230'
CRP-024	CCTV-22	US 70 (CHURCH STREET) & FISHER STREET	n/a	STEEL	PROP.	CCTV ONLY	50'	PROPOSED	45'	PoE	EXIST.	TYPE 332 SIGNAL	240'
CRP-100	CCTV-23	NC 54 (W. HARDEN STREET) & W. ELM STREET	n/a	STEEL	PROP.	CCTV ONLY	50'	PROPOSED	40'	PoE	EXIST.	TYPE 332 SIGNAL	225'
CRP-197	CCTV-24	JIMMIE KERR ROAD (SR 1928) & I-40/85 RAMPS	NE	STEEL	PROP.	CCTV ONLY	50'	PROPOSED	45'	PoE	EXIST.	TYPE 332 SIGNAL	240'
CRP-011	CCTV-25	US 70 (CHURCH STREET) & FORESTDALE DRIVE	SW	STEEL	PROP.	CCTV ONLY	50'	PROPOSED	40'	PoE	EXIST.	TYPE 332 SIGNAL	190'
CRP-015	CCTV-26	US 70 (CHURCH STREET) & GURNEY STREET	n/a	STEEL	PROP.	CCTV ONLY	50'	PROPOSED	45'	UNDERGROUND	PROP.	TYPE 336 CCTV	n/a
CRP-007	CCTV-27	US 70 (CHURCH STREET) & ST. MARKS CHURCH ROAD (RELOCATE/REPLACE CCTV 11)	NW	STEEL	PROP.	CCTV ONLY	50'	PROPOSED	45'	PoE	EXIST.	TYPE 332 SIGNAL	270'
CRP-038	CCTV-28	US 70 (CHURCH STREET) & GRAHAM-HOPEDALE ROAD (RELOCATE/REPLACE CCTV 9)	NW	STEEL	PROP.	CCTV ONLY	50'	PROPOSED	45'	PoE	EXIST.	TYPE 332 SIGNAL	265'
CRP-042	CCTV-29	US 70 (CHURCH STREET) & MCKINNEY STREET	SE	WOOD	PROP.	CCTV ONLY	50'	PROPOSED	37'	PoE	EXIST.	TYPE 332 SIGNAL	145'
CRP-147	CCTV-30	EDGEWOOD AVENUE & SHADOWBROOK DRIVE	NE	WOOD	PROP.	CCTV ONLY	50'	PROPOSED	37'	PoE	EXIST.	TYPE 332 SIGNAL	70'
CRP-151	CCTV-31	EDGEWOOD AVENUE & MEDICAL CENTER DRIVE	SW	WOOD	EXIST.	JOINT	40'	PROPOSED	27'	PoE	EXIST.	TYPE 332 SIGNAL	225
CRP-049	CCTV-32	UNIVERSITY DRIVE & RURAL RETREAT ROAD	NE	STEEL	PROP.	CCTV ONLY	50'	PROPOSED	45'	PoE	EXIST.	TYPE 332 SIGNAL	180'
CRP-066	CCTV-33	HUFFMAN MILL ROAD & FORESTDALE DRIVE	NE	STEEL	REPL.	JOINT	45'	PROPOSED	40'	PoE	EXIST.	TYPE 332 SIGNAL	165'
CRP-077	CCTV-34	ALAMANCE ROAD & MEBANE STREET	SE	STEEL	EXIST.	JOINT	33'	PROPOSED	30'	PoE	EXIST.	TYPE 332 SIGNAL	260'
CRP-198	CCTV-35	TUCKER STREET & I-40/85	NE	STEEL	PROP.	CCTV ONLY	50'	PROPOSED	45'	UNDERGROUND	PROP.	TYPE 336 CCTV	n/a
CRP-092	CCTV-36	TUCKER STREET & CHAPEL HILL ROAD	SW	STEEL	REPL.	JOINT	40'	PROPOSED	35'	PoE	EXIST.	TYPE 332 SIGNAL	130'
CRP-096	CCTV-37	MAPLE AVENUE & CHAPEL HILL ROAD	SE	STEEL	PROP.	CCTV ONLY	50'	PROPOSED	40'	PoE	EXIST.	TYPE 332 SIGNAL	220'
CRP-046	CCTV-38	UNIVERSITY DRIVE & WESTBROOK AVENUE	SE	STEEL	PROP.	CCTV ONLY	50'	PROPOSED	45'	PoE	EXIST.	TYPE 332 SIGNAL	70'
CRP-130	CCTV-39	UNIVERSITY DRIVE & HAGGARD AVENUE	NE	STEEL	PROP.	CCTV ONLY	50'	PROPOSED	45'	PoE	EXIST.	TYPE 332 SIGNAL	200'
CRP-001	CCTV-40	US 70 (CHURCH STREET) & SPRINGWOOD CHURCH ROAD	SE	STEEL	EXIST.	JOINT	33'	PROPOSED	30'	PoE	EXIST.	TYPE 332 SIGNAL	155'
CRP-028	CCTV-41	US 70 (CHURCH STREET) & TRADE STREET	NE	STEEL	PROP.	CCTV ONLY	50'	PROPOSED	45'	PoE	EXIST.	TYPE 332 SIGNAL	255'
CRP-199	CCTV-42	I-40/85 & MILE MARKER 146.16	n/a	STEEL	PROP.	CCTV ONLY	50'	PROPOSED	45'	UNDERGROUND	EXIST.	TYPE 336 CCTV	n/a
													_

\* MOUNT REPLACEMENT CCTV AT THE SAME HEIGHT AS THE EXISTING CCTV. NB = Northbound

BD = Bridge Deck EOC = Edge of Concrete ESS = Existing Sign GR = Guardrail

OR = Off Ramp EOP = Edge of Pavement TSCP = Traffic Signal Cabinet TSP = Traffic Signal Pole PoE = Power Over Ethernet from Signal Cabinet

SB = Southbound EB = Eastbound WB = Westbound ATKINS 1616 EAST MILLBROOK ROAD, SUITE 160 RALEIGH, NORTH CAROLINA 27609 (919) 876-6888 NCBEES #F-0326

DOCUMENT NOT CONSIDERED FINAL UNLESS ALL SIGNATURES COMPLETED



Burlington-Graham Signal System CCTV Installation Summary

Burlington & Graham Division 7 Alamance County

PLAN DATE: December 2017 REVIEWED BY: HA Badgett 750 Greenfield Parkway, Garner, NC 27529 PREPARED BY: AH / AW REVIEWED BY: BJ Slocum REVISIONS INIT. DATE


040877 CADD Filename: 270\_090\_U-6015\_

NTS

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CRP-3.000 U-6015 " W. FRONT WOODS 044 045 002 003 008 009 010 005 006 007 012 US 70 (BURLINGTON RD.) -\ 067 ATKINS 1616 EAST MILLBROOK ROAD, SUITE 160 RALEIGH, NORTH CAROLINA 27609 (919) 876-6888 NCBEES #F-0326 DOCUMENT NOT CONSIDERED FINAL UNLESS ALL SIGNATURES COMPLETED Burlington-Graham Signal System Cable Routing Plans Key Sheet (1 of 3) Burlington & Graham Alamance County PLAN DATE: April 2018 REVIEWED BY: MB Toth 750 Greenfield Parkway, Garner, NC 27529 PREPARED BY: JA Wiles REVIEWED BY: BJ Slocum REVISIONS Melissa B. Toth6/13/2018 NONE

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ATKINS 1616 EAST MILLBROOK ROAD, SUITE 160 RALEIGH, NORTH CAROLINA 27609 (919) 876-6888 NCBEES #F-0326

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Burlington-Graham Signal System Cable Routing Plans Key Sheet (3 of 3)

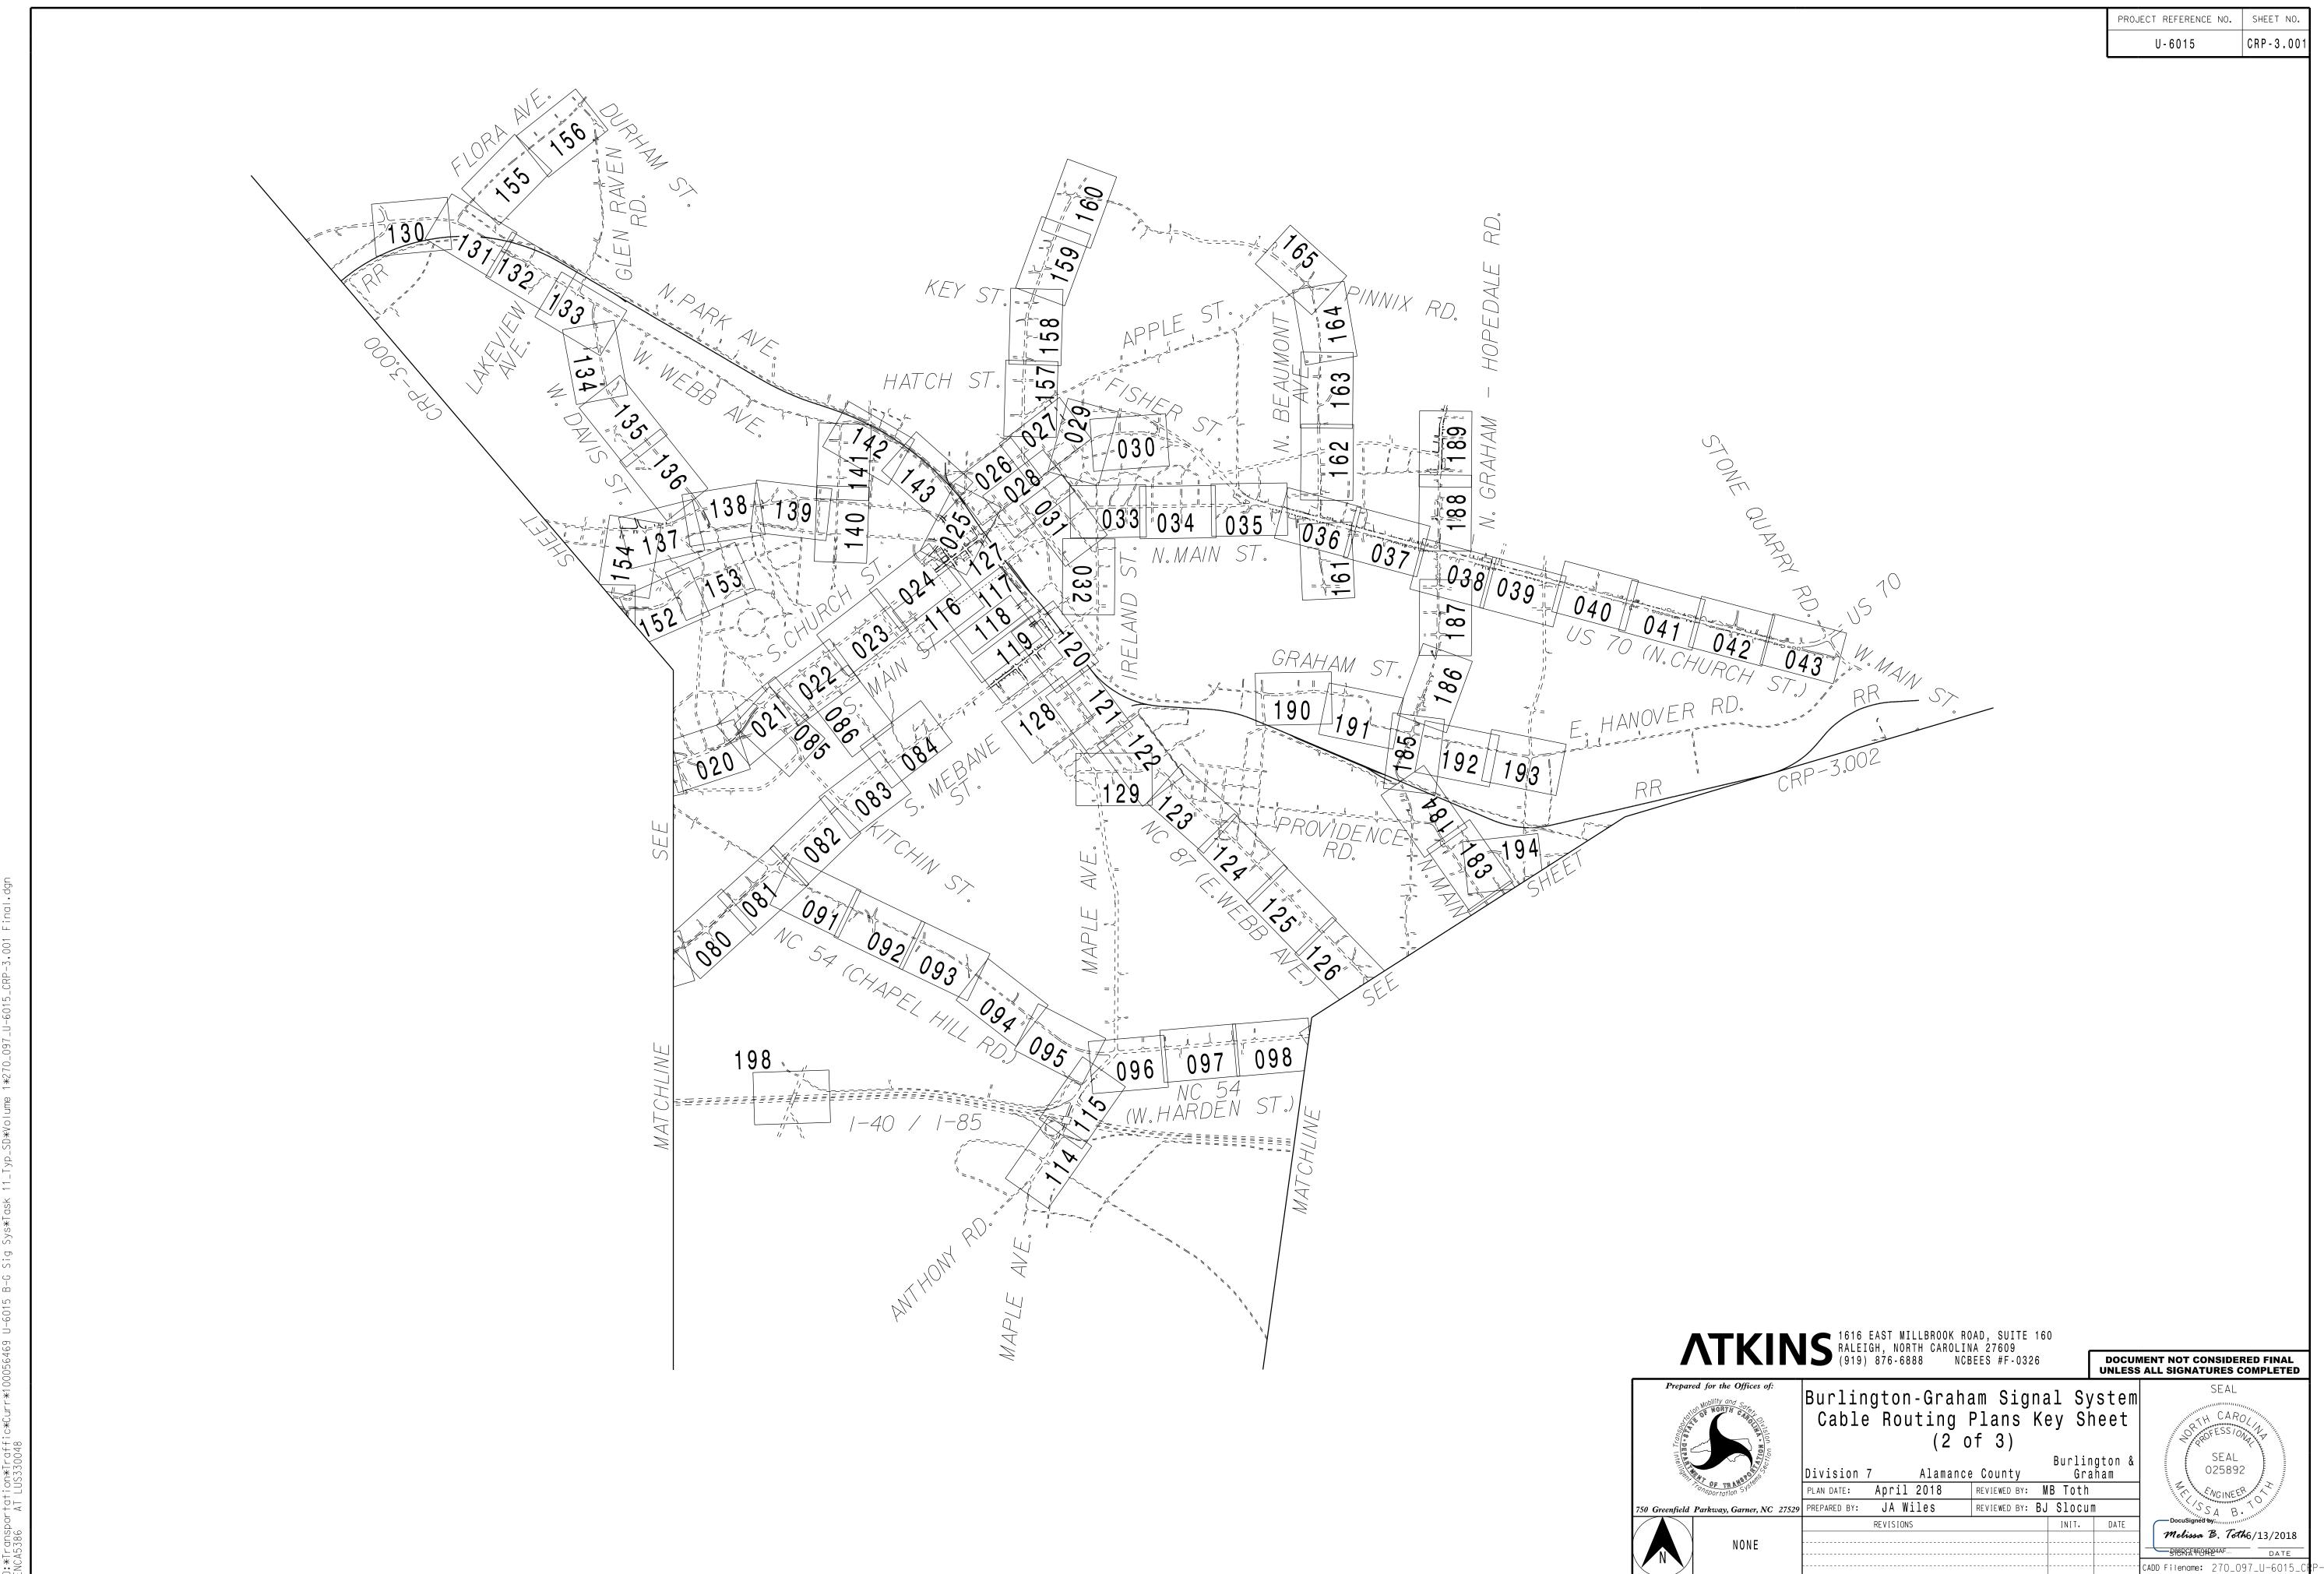PLAN DATE: April 2018 REVIEWED BY: MB Toth 750 Greenfield Parkway, Garner, NC 27529 PREPARED BY: JA Wiles REVIEWED BY: BJ Slocum REVISIONS NONE

Burlington & Graham Division 7 Alamance County Melissa B. Toth6/13/2018 CADD Filename: 270\_097\_U-6015\_

PROJECT REFERENCE NO. CRP-4.000 U-6015

#### LEGEND

#### **ABBREVIATIONS**

**AGUY** 

**Aerial Guy** 

**ARLT** Area Light AT&T AT&T **Bottom Attachment BOT Backside Attachment CATV** Cable Television (Spectrum) CAM Camera Bracket **CCTV** Closed-Circuit Television **CLINK** Century Link COB City of Burlington COG City of Graham COMM Communications Cable COMP Composite Cable Drip Loop DL DRP Drop **DNET DukeNet DUKE** Duke Energy EXI **Existing Communications Cable FLCAB** Flasher Cabinet FOC / FO Fiber Optic Cable Front Side Attachment Intermediate Metallic Conduit IMC LIC Lead-In Cable (Detector) **MSGR** Messenger NCDOT North Carolina Department of Transportation **NEUT** Neutral ОН Overhead OSS Overhead Sign Span Open Wire Secondary OWS **PNG** Piedmont Natural Gas **PWR** Power **RSR** Riser Same Elevation/Attachment Height SAME SEC Secondary Power Signal Riser **SGRSR** Signal Span SIG Signal Pole SO Standoff **STLT** Streetlight **SVRSR** Service Riser

TEL Telephone **TFMR** Transformer **TOP** 

Top of Pole or Top Attachment

**Triplex** TRI UG Underground VZN Verizon

Crossing Line, where "Any" is the X ANY

abbreviation for the overhead line that is crossing exist/prop. cable route

FO	NEW FIBER OPTIC COMMUNICATIONS CABLE
—— EXI ——	EXISTING COMMUNICATIONS CABLE
REM	EXISTING COMMUNICATIONS CABLE TO BE REMOVED
	NEW AND EXISTING AERIAL GUY ASSEMBLY
	NEW CONDUIT
	EXISTING CONDUIT
—— DD ——	NEW DIRECTIONAL DRILLED CONDUIT
B&J	NEW BORED AND JACKED CONDUIT
	RAILROAD TRACK
$\bigcirc$	NEW WOOD POLE
•	EXISTING WOOD POLE
	NEW METAL POLE
	EXISTING METAL POLE
	EXISTING CONCRETE POLE
——)	NEW STANDARD GUY ASSEMBLY
	EXISTING STANDARD GUY ASSEMBLY
	NEW SIDEWALK GUY ASSEMBLY
	EXISTING SIDEWALK GUY ASSEMBLY
	NEW HUB CABINET

EXISTING HUB CABINET

NEW CONTROLLER AND CABINET **EXISTING CONTROLLER AND CABINET** NEW SPLICE CABINET S **EXISTING SPLICE CABINET** (s)NEW AERIAL SPLICE ENCLOSURE EXISTING AERIAL SPLICE ENCLOSURE NEW UNDERGROUND SPLICE ENCLOSURE S IN NEW SPECIAL-SIZED JUNCTION BOX NEW UNDERGROUND SPLICE ENCLOSURE IN EXISTING SPECIAL-SIZED JUNCTION BOX EXISTING UNDERGROUND SPLICE ENCLOSURE IN EXISTING SPECIAL-SIZED JUNCTION BOX NEW CABLE STORAGE GUIDES (SNOW SHOES) **EXISTING CABLE STORAGE GUIDES** (SNOW SHOES) NEW CCTV CAMERA ASSEMBLY EXISTING CCTV CAMERA ASSEMBLY EXISTING ELECTRICAL JUNCTION BOX YAGI ANTENNA OMNI-DIRECTIONAL ANTENNA

EXISTING STANDARD JUNCTION BOX NEW OVER-SIZED OR SPECIAL-SIZED JUNCTION BOX EXISTING OVER-SIZED OR SPECIAL-SIZED JUNCTION BOX EXISTING UNDERGROUND VAULT EXISTING COMMUNICATIONS MANHOLE DESIGNATES UNFUSED POWER IN JUNCTION BOX, VAULT OR MANHOLE (07 - XXXX) NCDOT SIGNAL ID NUMBER CITY OF BURLINGTON SIGNAL INVENTORY NUMBER CITY OF GRAHAM SIGNAL INVENTORY NUMBER CCTV-XX) CCTV CAMERA ID NUMBER EDGE OF PAVEMENT EOP EDGE OF LANE BOC BACK OF CURB FACE OF CURB FOC NEW SYSTEM DETECTOR **EXISTING SYSTEM DETECTOR** 

NEW STANDARD JUNCTION BOX

#### GENERAL NOTES

900 MHZ RADIO / FLAT-PANEL ANTENNA

- 1. THESE PLANS WERE PREPARED FROM INVENTORIES AND FIELD DATA COLLECTED DURING JULY 2017 THRU DECEMBER 2017. ACTUAL CONDITIONS IN THE FIELD AT THE TIME OF CONSTRUCTION MAY BE DIFFERENT FROM THOSE SHOWN IN THE PLANS.
- 2. THE FIELD LOCATION OF ANY ITEM TO BE INSTALLED AS PART OF THIS PROJECT SHALL BE APPROVED BY THE ENGINEER PRIOR TO INSTALLATION.
- 3. NEW TRAFFIC SIGNAL CONTROLLER CABINETS ARE SPECIFIED ON THE SIGNAL PLANS.
- 4. BURIED UTILITIES AND STRUCTURES: PIPELINES, STORM SEWERS, POWER CABLES, UTILITY CABLES, BASEMENTS, AND OTHER PUBLICLY AND PRIVATELY OWNED UNDERGROUND OBSTRUCTIONS EXIST ADJACENT TO AND WITHIN THE STREET RIGHT-OF-WAY WITHIN THE CONSTRUCTION LIMITS OF THIS PROJECT. INVESTIGATE THE LOCATION OF SUCH BURIED UTILITIES AND STRUCTURES WITH PUBLIC AND PRIVATE UTILITIES.
- 5. THE PLAN SHEETS HAVE BEEN DEVELOPED AS CLOSE TO SCALE AS PRACTICAL. HOWEVER, ACTUAL FIELD CONDITIONS SHALL PROVIDE THE BASIS FOR APPLYING THE WORK SHOWN.
- 6. THE ROADWAY STANDARD DRAWINGS AND THE DETAILS PROVIDED IN THIS PLAN SET SHALL ALL APPLY TO ALL WORK REQUIRED IN THIS PROJECT, WHETHER A PARTICULAR DETAIL IS SPECIFICALLY REFERENCED TO A WORK ITEM OR NOT. IN THE EVENT OF A CONFLICT, THE ORDER OF PRECEDENCE SHALL BE: THE PROJECT SPECIAL PROVISIONS, THE PLAN SET - INCLUDING DETAILS - SUPPLEMENTAL SPECIFICATIONS, THE STANDARD SPECIFICATIONS, AND THEN THE ROADWAY STANDARD DRAWINGS. THE CONTRACTOR SHALL BE RESPONSIBLE FOR APPLYING THE PROPER DETAILS.

- 7. ANY OF THE CONTRACTOR'S WORK ACTIVITIES WHICH IMPACT ANY UTILITY FACILITY SHALL BE COORDINATED WITH THE OWNER OF THE AFFECTED UTILITIES. THE CONTRACTOR SHALL FOLLOW ANY AND ALL WORK PROCEDURES THE UTILITY OWNERS MAY REQUIRE.
- 8. ALL WORK SHOWN ON THESE PLANS SHALL BE PERFORMED BY THE CONTRACTOR UNLESS SPECIFICALLY NOTED TO BE PERFORMED BY OTHERS.
- 9. AREAS WITHIN THIS PROJECT HAVE BEEN DETERMINED TO CONTAIN PROPERTIES WITH DOCUMENTED HISTORICAL SIGNIFICANCE. IF IT IS NECESSARY TO DEVIATE FROM THE PLANS IN AN AREA IDENTIFIED TO CONTAIN PROPERTIES WITH HISTORIC SIGNIFICANCE. ALERT THE ENGINEER TO CONTACT ENVIRONMENTAL ANALYSIS UNIT - HISTORIC ARCHITECTURE GROUP OF NORTH CAROLINA DEPARTMENT OF TRANSPORTATION FOR AN EFFECTS DETERMINATION BEFORE PROCEEDING.

ATKINS 1616 EAST MILLBROOK ROAD, SUITE 160 RALEIGH, NORTH CAROLINA 27609 (919) 876-6888 NCBEES #F-0326

**DOCUMENT NOT CONSIDERED FINAL UNLESS ALL SIGNATURES COMPLETED** 



|Burlington-Graham Signal System| Legend/ General Notes/ Abbreviations

Burlington & Alamance County December 2017 | REVIEWED BY: HA Badgett AH/AWREVIEWED BY: BJ Slocum

REVISIONS INIT. DATE

Melissa B. Toth6/13/2018 CADD Filename: 270\_097\_U-6015\_

50 Greenfield Parkway, Garner, NC 27529 NTS

INSTALL CATEGORY 6 CABLE

INSTALL LOW VOLTAGE POWER CABLE (24VAC)

INSTALL COMPOSITE CCTV CABLE INSTALL SMFO CABLE

INSTALL COAXIAL ANTENNA CABLE

INSTALL FIBER-OPTIC DROP CABLE

INSTALL TRACER WIRE

INSTALL CONDUIT UNDERGROUND

INSTALL PVC CONDUIT

INSTALL RIGID, GALVANIZED STEEL CONDUIT

INSTALL RIGID, GALVANIZED STEEL RISER WITH WEATHERHEAD

INSTALL RIGID, GALVANIZED STEEL RISER WITH HEAT SHRINK TUBING

INSTALL HEAT SHRINK TUBING RETROFIT KIT

INSTALL HIGH DENSITY POLYETHYLENE CONDUIT

DIRECTIONAL DRILL CONDUIT

BORE AND JACK CONDUIT

INSTALL CABLE(S) IN EXISTING CONDUIT

INSTALL CABLE(S) IN NEW CONDUIT

INSTALL CABLE(S) IN EXISTING RISER(S)

INSTALL CABLE(S) IN NEW RISER(S)

INSTALL CABLE(S) IN EXISTING CABINET ENTRANCE

INSTALL NEW CONDUIT INTO CABINET BASE (USE EXISTING CONDUIT STUBOUTS WHEN AVAILABLE)

INSTALL NEW RISER INTO CABINET BASE

(USE EXISTING CONDUIT STUBOUTS WHEN AVAILABLE)

INSTALL NEW CONDUIT INTO POLE MOUNTED CABINET

INSTALL NEW RISER INTO POLE MOUNTED CABINET

INSTALL DIGITAL VIDEO ENCODER

INSTALL NEW ETHERNET EDGE SWITCH IN CABINET

INSTALL INTERCONNECT CENTER, PATCH PANEL, JUMPERS, AND FUSION SPLICE CABLE IN CABINET

INSTALL UNDERGROUND SPLICE ENCLOSURE

INSTALL AERIAL SPLICE ENCLOSURE

**INSTALL SPLICE CABINET** 

MODIFY EXISTING SPLICE ENCLOSURE OR INTERCONNECT CENTER

REMOVE EXISTING SPLICE / HUB / CCTV CABINET

INSTALL CABINET FOUNDATION

REMOVE EXISTING CABINET FOUNDATION

INSTALL CCTV CAMERA ASSEMBLY

INSTALL CCTV WOOD POLE

INSTALL STANDARD SIZE JUNCTION BOX

INSTALL SPECIAL-SIZED JUNCTION BOX

INSTALL OVER-SIZED JUNCTION BOX

REMOVE EXISTING JUNCTION BOX

INSTALL WOOD POLE

REMOVE EXISTING WOOD POLE

INSTALL AERIAL GUY ASSEMBLY

INSTALL STANDARD GUY ASSEMBLY

INSTALL SIDEWALK GUY ASSEMBLY

INSTALL MESSENGER CABLE

REMOVE EXISTING COMMUNICATIONS CABLE AND MESSENGER CABLE

REMOVE EXISTING COMMUNICATIONS CABLE

INSTALL SERVICE CONDUCTORS

INSTALL CABLE STORAGE GUIDE(S) [SNOW SHOE(S)] AND STORE 100 FEET OF EACH CABLE

INSTALL DELINEATOR MARKER

STORE 50 FEET OF COMMUNICATIONS CABLE (EACH CABLE)

LASH CABLE(S) TO EXISTING SIGNAL/COMMUNICATIONS CABLE

LASH CABLE(S) TO EXISTING MESSENGER CABLE

56 LASH CABLE(S) TO NEW MESSENGER CABLE

MODIFY EXISTING ELECTRICAL SERVICE FOR CCTV

58 INSTALL NEW ELECTRICAL SERVICE FOR CCTV OR RADIO

59 INSTALL NEW POLE MOUNTED CCTV CABINET (336)

60 INSTALL NEW CCTV CABINET (NEMA TYPE 4)

60A INSTALL NEW POLE MOUNTED CABINET FOR ANTENNA (RADIO CABINET)

REMOVE EXISTING CCTV CAMERA ASSEMBLY

NEW CABINET ENTRANCE INTO NEW FOUNDATION

DRILL/CORE DRILL EXISTING FOUNDATION

CONSTRUCTION NOTE SYMBOLOGY KEY

(XX INDICATES NUMBER OF CABLES, LOOPS, ETC.

INSTALL CCTV METAL POLE

COIL CITY IT CABLE


WITH EXTENDER (336)

74

INDICATES NUMBER OF FIBERS PER CABLE, TWISTED PAIRS PER CABLE, ETC.


INDICATES NUMBER OF RISER(S)/CONDUIT(S)

INDICATES DIAMETER OF RISER(S)/CONDUIT(S) (INCH)

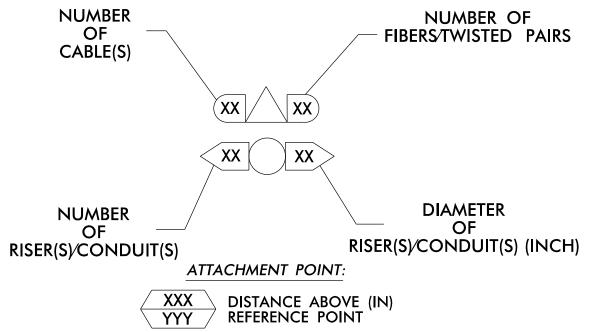

YYY REFERENCE POINT DISTANCE BELOW (IN)



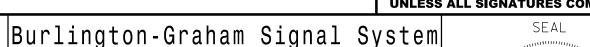



Construction Notes

Burlington & Division 7 Alamance County PLAN DATE: December 2017 REVIEWED BY: HA Badgett

AH/AW REVIEWED BY: BJ Slocum REVISIONS

**DOCUMENT NOT CONSIDERED FINAL** 

NTS

Melissa B. Toth6/13/2018


CADD Filename: 270\_098\_U-6015\_0

CRP-6.001 U-6015 (**13**) FO, CAT6 **19**) FO, CAT6 SEE SIGNAL PLAN FOR SYSTEM DETECTOR INSTALLATION/ASSIGNMENT DETAILS. REFER TO "SYSTEM DETECTORS AND CONTROL ZONES" SCHEMATIC. FOR ADDITIONAL INFORMATION. NEUT 43" CCTV-40 07 - 1251 1 6 12 √ DUKE-3004643 DUKE-T103 56 SLACK SPAN 1 4 24 PROP IT 51 1 |/4\|36) 1 4 24 PROP IT 47 56 ATTACHMENT POINT: DISTANCE ABOVE (IN) **NOTES:** REFERENCE POINT 1. UNLESS OTHERWISE NOTED: REFERENCE POINT - OVERLASH NEW FIBER OPTIC CABLE TO EXISTING COMMUNICATIONS CABLE. XXX / DISTANCE BELOW (IN) – ATTACH NEW MESSENGER CABLE 40" BELOW POWER. CONSTRUCTION NOTE SYMBOLOGY KEY - ATTACH ON FRONT SIDE (FS) OF POLE. 2. SEAL ALL CONDUIT ENDS WITH DUCT AND CONDUIT SEALER AT ALL JUNCTION BOX / CABINET NUMBER OF NUMBER OF CABLE(S)/LOOPS, ENTRANCES. FIBERS/TWISTED DETECTOR AMPLIFIERS, **PAIRS** GUYS, ANTENNAS LASH CABLE(S) TO EXISTING BOND RISER TO POLE INSTALL NEW CONDUIT INTO 43 REMOVE EXISTING WOOD POLE MODIFY EXISTING SPLICE INSTALL RIGID, GALVANIZED STEEL (22) CABINET BASE (USE EX CABINET MESSENGER CABLE GROUND INSTALL CATEGORY 6 CABLE RISER WITH WEATHERHEAD > ENCLOSURE OR INTERCONNECT ENTRANCE WHEN AVAILABLE) CENTER BOND TRACER WIRE TO LASH CABLE(S) TO NEW 44 | INSTALL AERIAL GUY ASSEMBLY 56 MESSENGER CABLE INSTALL NEW RISER INTO CABINET INSTALL RIGID, GALVANIZED STEEL EQUIPMENT GROUND BUS INSTALL LOW VOLTAGE POWER CABLE (23) BASE (USE EX CABINET ENTRANCE RISER WITH HEAT SHRINK TUBING REMOVE EXISTING SPLICE /HUB / CCTV CABINET **NUMBER** DIAMETER INSTALL STANDARD GUY MODIFY EXISTING ELECTRICAL BOND TRACER WIRE TO WHEN AVAILABLE) 45 ASSEMBLY OF OF SERVICE FOR CCTV POLE GROUND INSTALL HEAT SHRINK TUBING KIT INSTALL NEW CONDUIT INTO RISER(S)/ RISER(S)/ INSTALL COMPOSITE CCTV CABLE 58 INSTALL NEW ELECTRICAL INSTALL SIDEWALK GUY 34 | INSTALL CABINET FOUNDATION HANDLASH AND INSTALL POLE MOUNTED CABINET 69 CONDUIT(S) CONDUIT(S) (IN) 46 ASSEMBLY AERIAL CABLE PROTECTOR SERVICE FOR CCTV OR RADIO INSTALL HIGH DENSITY POLYETHYLENE CONDUIT ATKINS 1616 EAST MILLBROOK ROAD, SUITE 160 RALEIGH, NORTH CAROLINA 27609 (919) 876-6888 NCBEES #F-0326 INSTALL NEW RISER INTO POLE REMOVE EXISTING CABINET 59 INSTALL NEW POLE MOUNTED CCTV CABINET (336) INSTALL SMFO CABLE 35 | REMOVE LABORE INSTALL CCTV CABINET MOUNTED CABINET 47 INSTALL MESSENGER CABLE DISCONNECT DOCUMENT NOT CONSIDERED FINAL REMOVE EXISTING
COMMUNICATIONS 15 ) DIRECTIONAL DRILL CONDUIT INSTALL NEW CCTV CABINET **UNLESS ALL SIGNATURES COMPLETED** 36 | INSTALL CCTV CAMERA ASSEMBLY INSTALL MANAGED 60 (NEMA TYPE 4) INSTALL COAXIAL ANTENNA CABLE  $\langle 26 \rangle$  install digital video encoder ETHERNET SWITCH Prepared for the Offices of: CABLE AND MESSENGER CABLE INSTALL NEW POLE MOUNTED CABINET FOR ANTENNA (RADIO 72 POLE 16 ) BORE AND JACK CONDUIT INSTALL CCTV METAL REMOVE EXISTING |Burlington-Graham Signal System| 37 INSTALL CCTV WOOD POLE 49 COMMUNICATIONS CABLE INSTALL NEW ETHERNET EDGE 4 CARO INSTALL FIBER-OPTIC DROP CABLE SWITCH IN CABINET  $^{ot}$  CABINET) INSTALL CABLE(S) IN EXISTING Cable Routing Plans INSTALL STANDARD SIZE 38 JUNCTION BOX REMOVE EXISTING CCTV CONDUIT INSTALL INTERCONNECT CENTER,
PATCH PANEL, JUMPERS, AND
FUSION SPLICE CABLE IN CABINET 50 | INSTALL SERVICE CONDUCTORS REMOVE EXISTING CCTV 73 METAL POLE CAMERA ASSEMBLY INSTALL TRACER WIRE REMOVE WIRELESS INSTALL CABLE STORAGE GUIDE(S) INSTALL SPECIAL-SIZED Burlington & 18 ) INSTALL CABLE(S) IN NEW CONDUIT INSTALL CABLE STORAGE GUIDE(S)
[SNOW SHOE(S)] AND STORE 100

62 NEW CABINET ENTRANCE INTO NEW FOUNDATION 74 COMMUNICATIONS 025892 JUNCTION BOX Division 7 Guilford County INSTALL UNDERGROUND SPLICE ENCLOSURE Graham FEET OF EACH CABLE EQUIPMENT 19 ) INSTALL CABLE(S) IN EXISTING RISER(S) 8 ) INSTALL CONDUIT UNDERGROUND INSTALL OVER-SIZED JUNCTION DRILL/CORE DRILL EXISTING PLAN DATE: June 2018 REVIEWED BY: M B Toth BACKPULL AND COIL CITY 52 | INSTALL DELINEATOR MARKER 63 FOUNDATION IT CABLE Greenfield Parkway, Garner, NC 27529 PREPARED BY: AME/AJH/VJP/NAP/JAW REVIEWED BY: BJ \$10CUM INSTALL AERIAL SPLICE 41 BOX REMOVE EXISTING JUNCTION 64 INTERCEPT AND REROUTE EXISTING CONDUITS INSTALL CABLE(S) IN NEW RISER(S) **ENCLOSURE** 9 ) INSTALL PVC CONDUIT STORE 30' OF COMMUNICATIONS INSTALL 2.4 GHZ RADIO 53 CABLE (EACH CABLE) SCALE INIT. DATE Melissa B. Toth 13/2018 AND PANEL ANTENNA 77 INSTALL BASE MOUNTED CCTV CABINET WITH INSTALL CABLE(S) IN EXISTING  $\langle$  31angle install splice cabinet LASH CABLE(S) TO EXISTING SIGNAL/COMMUNICATIONS CABLE 65 BOND MESSENGER TO POLE GROUND INSTALL RIGID, GALVANIZED STEEL 42 INSTALL WOOD POLE 10 ) CABINET ENTRÀNCE CONDUIT 1"=50' EXTENDER (336) CADD Filename: CL-001.dgn

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PROJECT REFERENCE NO. CRP-6.002 U-6015



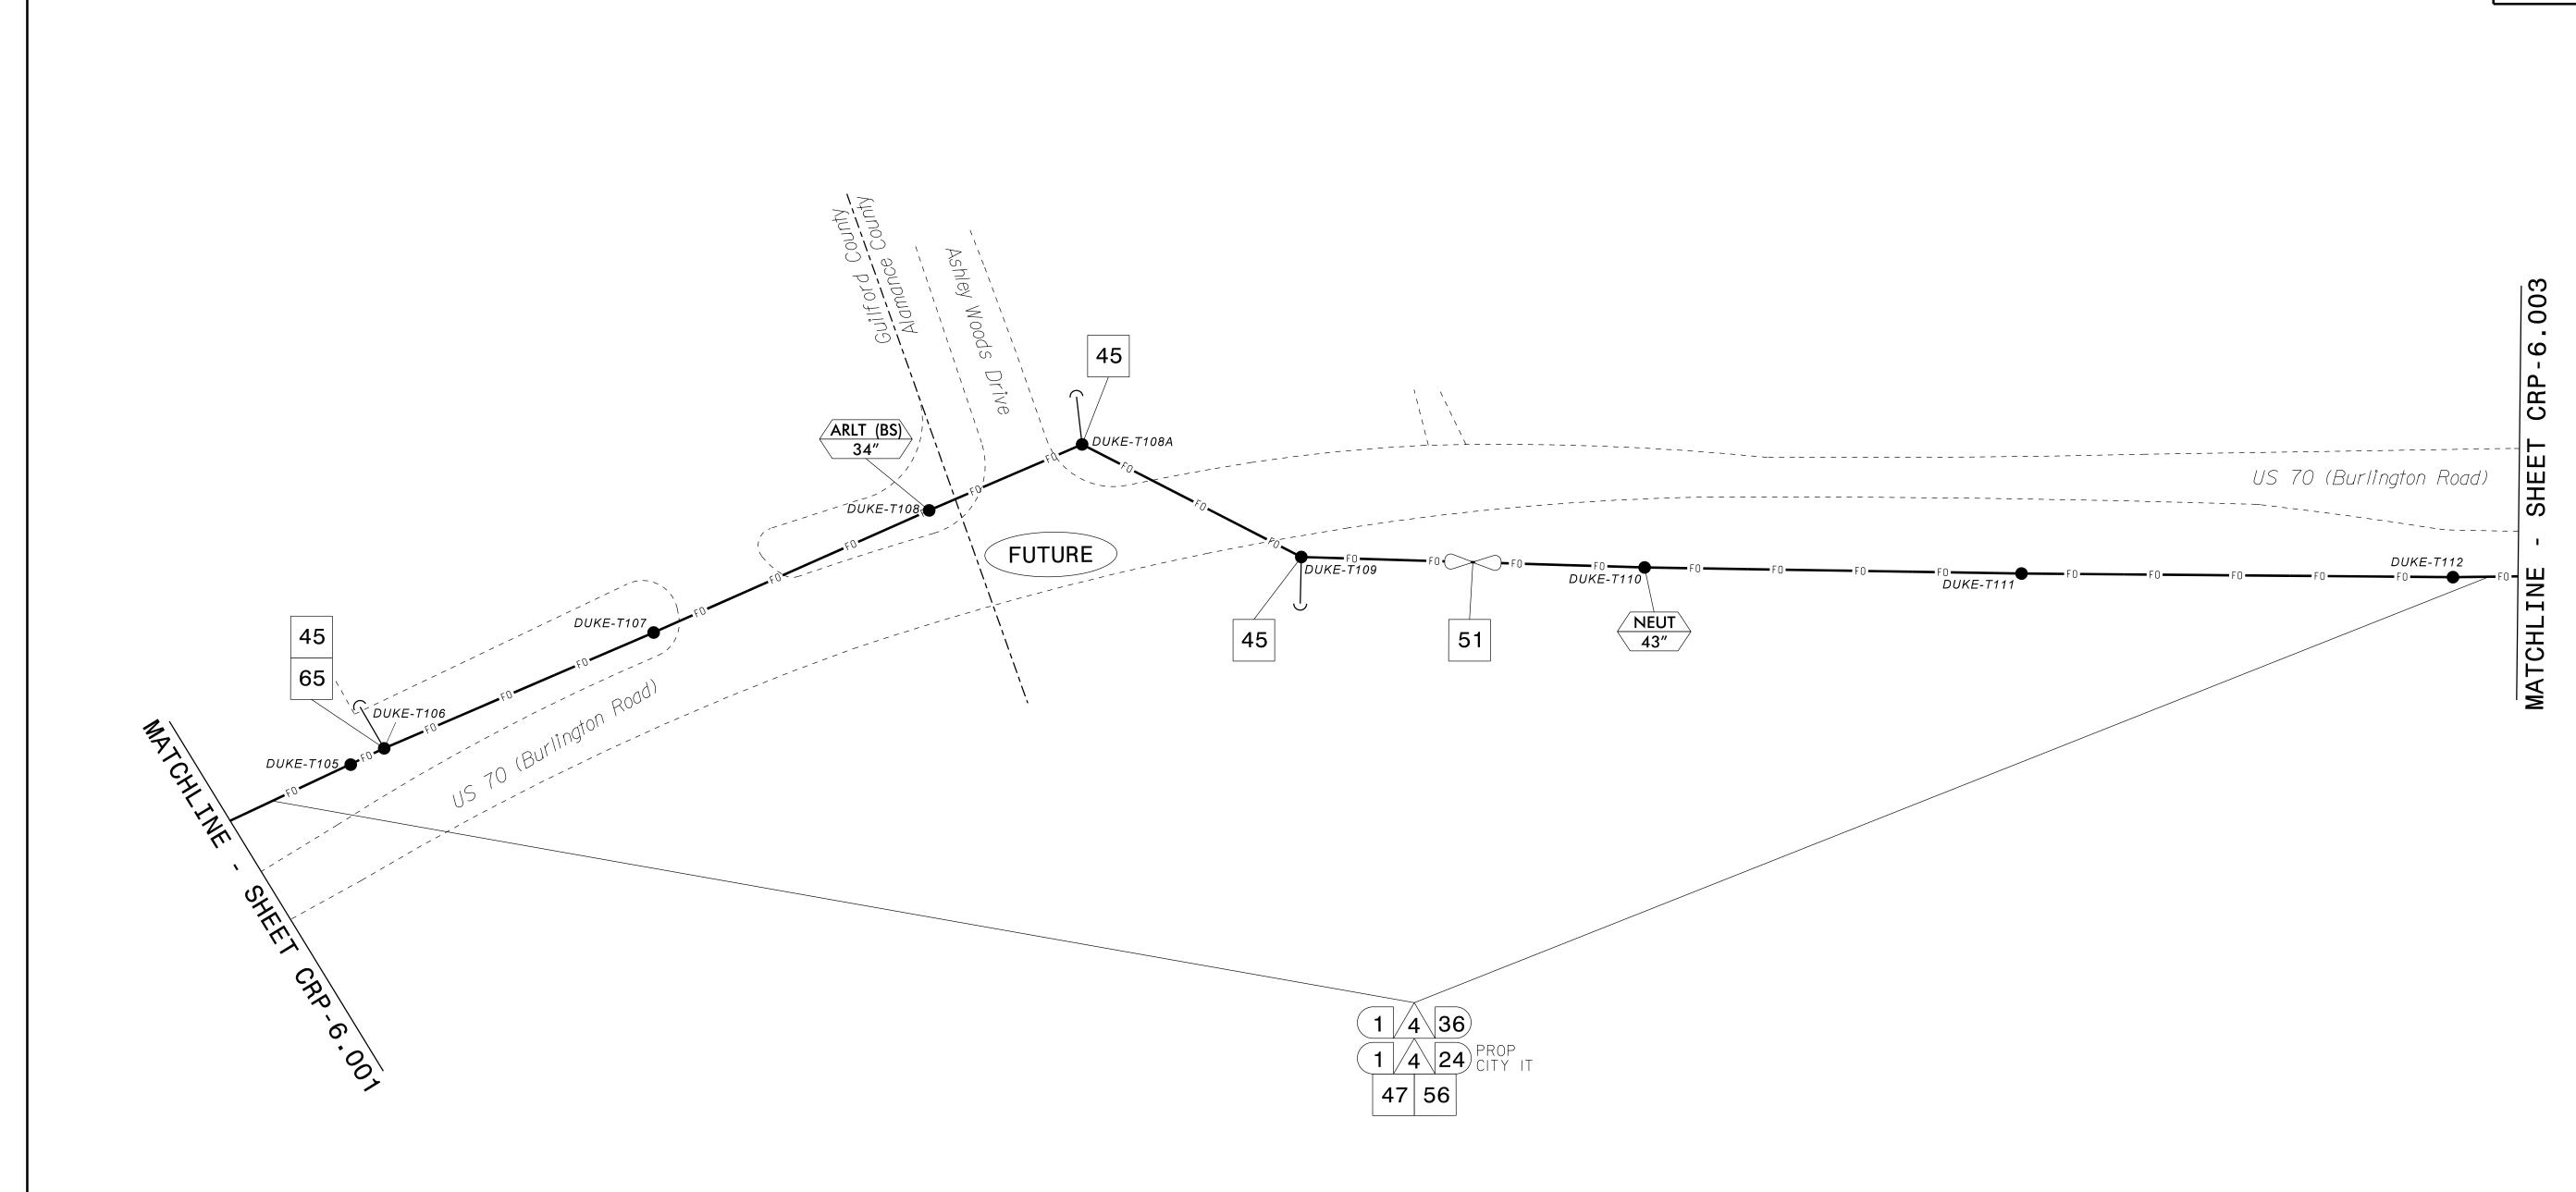

- 1. UNLESS OTHERWISE NOTED:
- OVERLASH NEW FIBER OPTIC CABLE TO EXISTING COMMUNICATIONS CABLE.
- ATTACH NEW MESSENGER CABLE 40" BELOW POWER.
- ATTACH ON FRONT SIDE (FS) OF POLE.
- 2. SEAL ALL CONDUIT ENDS WITH DUCT AND CONDUIT SEALER AT ALL JUNCTION BOX / CABINET

INSTALL RIGID, GALVANIZED STEEL

RISER WITH HEAT SHRINK TUBING

INSTALL HEAT SHRINK TUBING KIT

15 ) DIRECTIONAL DRILL CONDUIT

16 ) BORE AND JACK CONDUIT

INSTALL CABLE(S) IN EXISTING CONDUIT

18 ) INSTALL CABLE(S) IN NEW CONDUIT

19 ) INSTALL CABLE(S) IN EXISTING RISER(S)

INSTALL HIGH DENSITY POLYETHYLENE CONDUIT

	ENTRANCES.	
$\wedge$		

INSTALL RIGID, GALVANIZED STEEL INSTALL CATEGORY 6 CABLE RISER WITH WEATHERHEAD

INSTALL LOW VOLTAGE POWER CABLE (24VAC)

INSTALL COMPOSITE CCTV CABLE

INSTALL SMFO CABLE

INSTALL COAXIAL ANTENNA CABLE

INSTALL FIBER-OPTIC DROP CABLE

INSTALL TRACER WIRE

8 ) INSTALL CONDUIT UNDERGROUND

9 ) INSTALL PVC CONDUIT INSTALL RIGID, GALVANIZED STEEL 10 )

CONDUIT

20 ) INSTALL CABLE(S) IN NEW RISER(S) INSTALL CABLE(S) IN EXISTING CABINET ENTRÀNCE

INSTALL NEW CONDUIT INTO (22) CABINET BASE (USE EX CABINET ENTRANCE WHEN AVAILABLE) INSTALL NEW RISER INTO CABINET

(23) BASE (USE EX CABINET ENTRANCE WHEN AVAILABLE) INSTALL NEW CONDUIT INTO POLE MOUNTED CABINET

INSTALL NEW RISER INTO POLE MOUNTED CABINET

 $\langle 26 \rangle$  install digital video encoder INSTALL NEW ETHERNET EDGE SWITCH IN CABINET

INSTALL INTERCONNECT CENTER,

PATCH PANEL, JUMPERS, AND
FUSION SPLICE CABLE IN CABINET INSTALL UNDERGROUND SPLICE ENCLOSURE

INSTALL AERIAL SPLICE **ENCLOSURE**  $\langle$  31 $\rangle$  INSTALL SPLICE CABINET 42 INSTALL WOOD POLE

43 REMOVE EXISTING WOOD POLE MODIFY EXISTING SPLICE > ENCLOSURE OR INTERCONNECT CENTER

REMOVE EXISTING SPLICE /HUB / CCTV CABINET 45 ASSEMBLY

INSTALL SIDEWALK GUY 34 INSTALL CABINET FOUNDATION 46 ASSEMBLY REMOVE EXISTING CABINET 35 | REMOVE LABORE

REMOVE EXISTING
COMMUNICATIONS 36 | INSTALL CCTV CAMERA ASSEMBLY 37 INSTALL CCTV WOOD POLE

38 INSTALL STANDARD SIZE JUNCTION BOX | 50 | INSTALL SERVICE CONDUCTORS INSTALL SPECIAL-SIZED JUNCTION BOX

40 INSTALL OVER-SIZED JUNCTION BOX 52 | INSTALL DELINEATOR MARKER REMOVE EXISTING JUNCTION BOX 53 CABLE (EACH CABLE)

44 INSTALL AERIAL GUY ASSEMBLY INSTALL STANDARD GUY

47 INSTALL MESSENGER CABLE

CABLE AND MESSENGER CABLE REMOVE EXISTING 49 COMMUNICATIONS CABLE

**INSTALL CABLE STORAGE GUIDE(S)** INSTALL CABLE STORAGE GUIDE(S)

[SNOW SHOE(S)] AND STORE 100

[SNO FEET OF EACH CABLE

STORE 30' OF COMMUNICATIONS LASH CABLE(S) TO EXISTING SIGNAL/COMMUNICATIONS CABLE 65 BOND MESSENGER TO POLE GROUND

LASH CABLE(S) TO EXISTING MESSENGER CABLE LASH CABLE(S) TO NEW 56 MESSENGER CABLE

MODIFY EXISTING ELECTRICAL SERVICE FOR CCTV 58 INSTALL NEW ELECTRICAL SERVICE FOR CCTV OR RADIO

59 INSTALL NEW POLE MOUNTED CCTV CABINET (336) INSTALL NEW CCTV CABINET 60 (NEMA TYPE 4)

INSTALL NEW POLE MOUNTED CABINET FOR ANTENNA (RADIO 72 POLE  $^{ot}$  CABINET) 61 REMOVE EXISTING CCTV CAMERA ASSEMBLY

DRILL/CORE DRILL EXISTING 63 FOUNDATION

64 INTERCEPT AND REROUTE EXISTING CONDUITS

BOND RISER TO POLE GROUND

BOND TRACER WIRE TO POLE GROUND HANDLASH AND INSTALL

DISCONNECT 71 INSTALL MANAGES
ETHERNET SWITCH

73 METAL POLE

EQUIPMENT 75 IT CABLE BACKPULL AND COIL CITY

EXTENDER (336)

69 AERIAL CABLE PROTECTOR

DETECTOR AMPLIFIERS, GUYS, ANTENNAS

BOND TRACER WIRE TO EQUIPMENT GROUND BUS

INSTALL CCTV CABINET

INSTALL CCTV METAL

74 COMMUNICATIONS

INSTALL 2.4 GHZ RADIO
AND PANEL ANTENNA 77 INSTALL BASE MOUNTED CCTV CABINET WITH

**NUMBER** RISER(S)/ CONDUIT(S)

REMOVE EXISTING CCTV REMOVE WIRELESS

Prepared for the Offices of:

ATTACHMENT POINT:

YYY /

NUMBER OF

CABLE(S)/LOOPS,

OF

DISTANCE ABOVE (IN)

REFERENCE POINT

REFERENCE POINT

 $\chi \chi \chi \chi$  / DISTANCE BELOW (IN)

CONSTRUCTION NOTE SYMBOLOGY KEY

|Burlington-Graham Signal System| Cable Routing Plans

DOCUMENT NOT CONSIDERED FINAL

**UNLESS ALL SIGNATURES COMPLETED** 

CARO

025892

Melissa B. Toth 13/2018

CADD Filename: CL-002.dgn

Guilford & Alamance Burlington & Division 7 Counties Graham REVIEWED BY: M B Toth PLAN DATE: June 2018

NUMBER OF

FIBERS/TWISTED

DIAMETER

OF

RISER(S)/

TKINS 1616 EAST MILLBROOK ROAD, SUITE 160 RALEIGH, NORTH CAROLINA 27609 (919) 876-6888 NCBEES #F-0326

CONDUIT(S) (IN)

**PAIRS** 

Greenfield Parkway, Garner, NC 27529 PREPARED BY: AME/AJH/VJP/NAP/JAW REVIEWED BY: BJ \$10CUM SCALE INIT. DATE 1"=50'