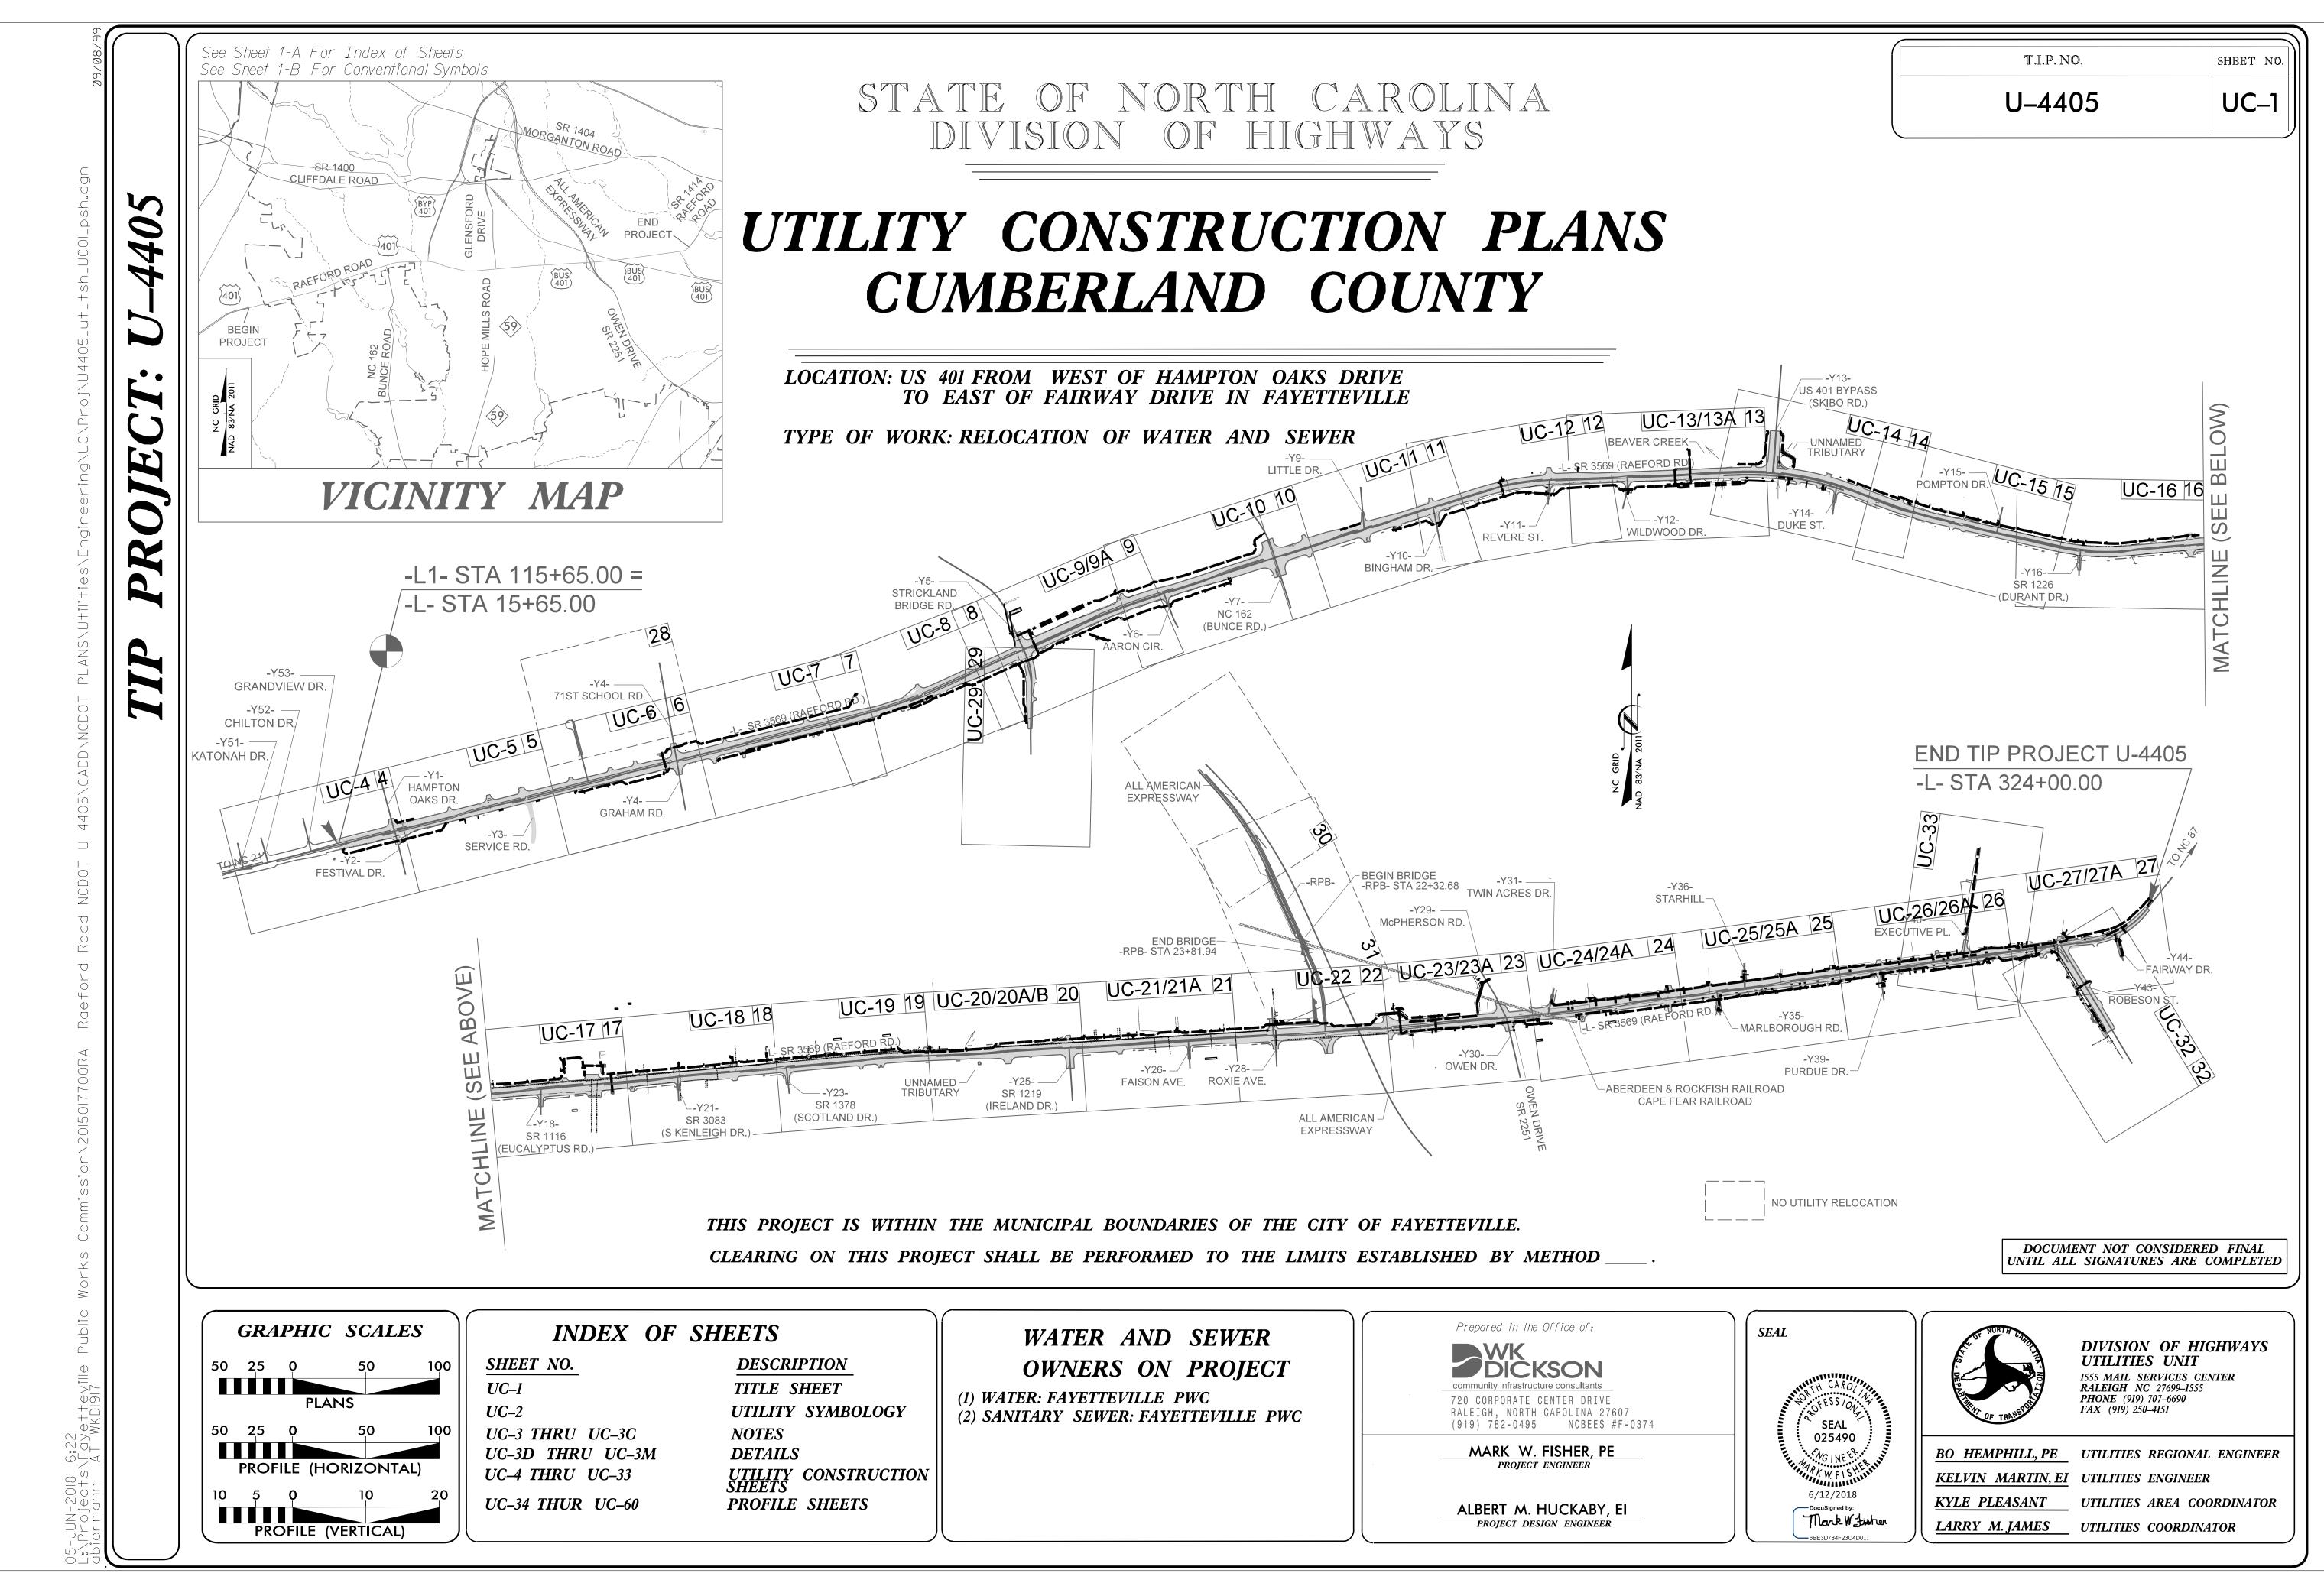
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PROPOSED WATER SYMBOLS

Water Line (Sized as Shown)
11 ¹ ⁄4 Degree Bend
22½ Degree Bend
45 Degree Bend
90 Degree Bend
Plug ·····
Tee
Cross +++
Reducer
Gate Valve
Butterfly Valve 🔤
Tapping Valve
Line Stop
Line Stop with Bypass
Blow Off
Fire Hydrant 🛶
Relocate Fire Hydrant
Remove Fire Hydrant
Water Meter PWM
Relocate Water Meter
Remove Water Meter
Water Pump StationPS(W)
RPZ Backflow Preventer
DCV Backflow Preventer
Relocate RPZ Backflow Preventer
Relocate DCV Backflow Preventer

PROPOSED SEWER SYMBOLS

Gravity Sewer Line (Sized as Shown)	Ab
Force Main Sewer Line	En
Manhole (Sized per Note)	
Sewer Pump Station	

REV: 2/1/2012

UTILI

STATE OF NORTH CAROLINA DIVISION OF HIGHWAYS	PROJECT REFERENCE NO. SHEET N U-4405 UC-2	
TIES PLAN SHEET SYMB	OLS	
PROPOSED MISCELLANOUS	UTILITIES SYMBOLS	
Power Pole	Thrust Block	
Telephone Pole	Air Release Valve	
Joint Use Pole	Utility Vault	
Telephone Pedestal ····································	Concrete Pier	
Utility Line by Others (Type as Shown)	Steel Pier	
Trenchless Installation	Plan Note	
Encasement by Open Cut	Pay Item Note PAY ITEM	

EXISTING UTILITIES SYMBOLS

Power Pole	*Underground Power Line
Telephone Pole	*Underground Telephone Cable
Joint Use Pole	*Underground Telephone Conduit
Utility Pole	*Underground Fiber Optics Telephone Cable ———— TFO———
Utility Pole with Base	*Underground TV Cable
H-Frame Pole	*Underground Fiber Optics TV Cable
Power Transmission Line Tower	*Underground Gas Pipeline
Water Manhole	Aboveground Gas Pipeline
Power Manhole	*Underground Water Line
Telephone Manhole	Aboveground Water Line
Sanitary Sewer Manhole	*Underground Gravity Sanitary Sewer Line—ss
Hand Hole for Cable	Aboveground Gravity Sanitary Sewer Line
Power Transformer	*Underground SS Forced Main Line
Telephone Pedestal	Underground Unknown Utility Line
CATV Pedestal	SUE Test Hole 🚥
Gas Valve	Water Meter
Gas Meter	Water Valve
Located Miscellaneous Utility Object 💿	Fire Hydrant
Abandoned According to Utility Records AATUR	Sanitary Sewer Cleanout
End of Information E.O.I.	

*For Exis Utility I (Type as Designate (Type as

sting Utilities	
Line Drawn from Records	
ted Utility Lines Shown)	

GENERAL NOTES:

1. THE PROPOSED UTILITY CONSTRUCTION SHALL MEET THE APPLICABLE REQUIREMENTS OF THE NC DEPARTMENT OF TRANSPORTATION'S "STANDARD SPECIFICATIONS FOR ROADS AND STRUCTURES" DATED JANUARY 2018 AND THE SPECIAL PROVISIONS TO NCDOT SPECIFICATION DIVISION 15.

2. FAYETTEVILLE PWC OWNS AND OPERATES THE EXISTING WATER AND SEWER UTILITIES EXCEPT FOR THE WATER UTILITIES IDENTIFIED AS AQUA AMERICA.

3. ALL WATER LINES TO BE INSTALLED WITHIN COMPLIANCE OF THE RULES AND REGULATIONS OF THE NORTH CAROLINA DEPARTMENT OF ENVIRONMENTAL QUALITY, DIVISION OF WATER RESOURCES, PUBLIC WATER SUPPLY SECTION. ALL SEWER LINES TO BE INSTALLED WITHIN COMPLIANCE OF THE RULES AND REGULATIONS OF THE NORTH CAROLINA DEPARTMENT OF ENVIRONMENT QUALITY, DIVISION OF WATER RESOURCES, WATER QUALITY SECTION. PERFORM ALL WORK IN ACCORDANCE WITH THE APPLICABLE PLUMBING CODES.

4. FAYETTEVILLE PWC OWNS THE EXISTING UTILITY FACILITIES AND WILL OWN THE NEW UTILITY FACILITIES AFTER ACCEPTANCE BY THE DEPARTMENT. THE DEPARTMENT OWNS THE CONSTRUCTION CONTRACT AND HAS ADMINISTRATIVE AUTHORITY. COMMUNICATIONS AND DECISIONS BETWEEN THE CONTRACTOR AND UTILITY OWNER ARE NOT BINDING UPON THE DEPARTMENT OR THIS CONTRACT UNLESS AUTHORIZED BY THE ENGINEER. AGREEMENTS BETWEEN THE UTILITY OWNER AND CONTRACTOR FOR THE WORK THAT IS NOT PART OF THIS CONTRACT OR IS SECONDARY TO THIS CONTRACT ARE ALLOWED, BUT ARE NOT BINDING UPON THE DEPARTMENT.

5. THE CONTRACTOR SHALL PROVIDE ACCESS FOR THE DEPARTMENT PERSONNEL AND THE OWNER'S REPRESENTATIVES TO ALL PHASES OF CONSTRUCTION. NOTIFY DEPARTMENT PERSONNEL AND THE UTILITY OWNER TWO WEEKS PRIOR TO COMMENCEMENT OF ANY WORK AND ONE WEEK PRIOR TO SERVICE INTERRUPTION. KEEP UTILITY OWNERS' REPRESENTATIVES INFORMED OF WORK PROGRESS AND PROVIDE OPPORTUNITY FOR INSPECTION OF CONSTRUCTION AND TESTING.

6. MAKE FINAL CONNECTIONS OF THE NEW WORK TO THE EXISTING SYSTEM WHERE INDICATED ON THE PLANS, AS REQUIRED TO FIT THE ACTUAL CONDITIONS, OR AS DIRECTED.

UTILITY CONSTRUCTION

7. THE PLANS DEPICT THE BEST AVAILABLE INFORMATION FOR THE LOCATION, SIZE, AND TYPE OF MATERIAL FOR ALL EXISTING UTILITIES. MAKE INVESTIGATIONS FOR DETERMINING THE EXACT LOCATION, SIZE, AND TYPE MATERIAL OF THE EXISTING FACILITIES AS NECESSARY FOR THE CONSTRUCTION OF THE PROPOSED UTILITIES AND FOR AVOIDING DAMAGE TO EXISTING FACILITIES. REPAIR ANY DAMAGE INCURRED TO EXISTING FACILITIES TO THE ORIGINAL OR BETTER CONDITION AT NO ADDITIONAL COST TO THE DEPARTMENT.

8. MAKE CONNECTIONS BETWEEN EXISTING AND PROPOSED UTILITIES AT TIMES MOST CONVENIENT TO THE PUBLIC, WITHOUT ENDANGERING THE UTILITY SERVICE, AND IN ACCORDANCE WITH THE UTILITY OWNER'S REQUIREMENTS. MAKE CONNECTIONS ON WEEKENDS, AT NIGHT, AND ON HOLIDAYS IF NECESSARY.

9. ALL UTILITY MATERIALS SHALL BE APPROVED PRIOR TO DELIVERY TO THE PROJECT. SEE 1500-7, "SUBMITTALS AND RECORDS" IN SECTION 1500 OF THE STANDARD SPECIFICATIONS.

10. PRIOR TO PLACEMENT OF PROPOSED SANITARY GRAVITY SEWER THE CONTRACTOR SHALL LOCATE ALL EXISTING SEWER SERVICE LATERALS (DEPTH AND PIPE DIAMETER) AND NOTIFY THE RESIDENT ENGINEER IF THERE ARE COMPLICATIONS WITH CONNECTING TO THE PROPOSED SANITARY GRAVITY SEWER. THE CONTRACTOR'S COST FOR ALL WORK ASSOCIATED WITH SEWER SERVICES, IS INCIDENTAL TO SEWER SERVICE PAYMENT ITEM.

11. PRIOR TO PLACEMENT OF PROPOSED WATERLINE THE CONTRACTOR SHALL LOCATE ALL EXISTING WATER SERVICE LATERALS (DEPTH AND PIPE DIAMETER) AND NOTIFY THE RESIDENT ENGINEER IF THERE ARE COMPLICATIONS WITH CONNECTING TO THE PROPOSED WATERLINE. THE CONTRACTOR'S COST FOR ALL WORK ASSOCIATED WITH WATER SERVICES, IS INCIDENTAL TO WATER SERVICE PAYMENT ITEM.

12. THE CONTRACTOR SHALL REFER TO THE "UTILITIES BY OTHERS" PLANS FOR PROPOSED GAS, TELECOMMUNICATIONS, AQUA AMERICA WATER, AND POWER UTILITY RELOCATIONS.

PROJECT SPECIFIC NOTES:


1. ALL PROPOSED WATER LINE 2" IN DIAMETER SHALL BE SDR21, PRESSURE CLASS 200 IN ACCORDANCE WITH ASTM D 2241 OR SDR-17 WITH A PRESSURE RATING OF 250 PSI, IN ACCORDANCE WITH ASTM D-224. ALL PROPOSED WATER LINE 4"-12" IN DIAMETER SHALL BE DI (DUCTILE IRON PUSH-ON) PC 350 PIPE, UNLESS SPECIFIED TO BE **RESTRAINED JOINT PIPE AND/OR SPECIAL** THICKNESS CLASS AS SHOWN ON THE PLAN/PROFILE. ALL PROPOSED WATERLINE LINE 16" IN DIAMETER AND LARGER SHALL BE DI (DUCTILE IRON PUSH-ON) PC 250 PIPE, UNLESS SPECIFIED TO BE RESTRAINED JOINT PIPE AND/OR SPECIAL THICKNESS CLASS AS SHOWN ON THE PLAN/PROFILE.

2. ALL PROPOSED GRAVITY SEWER LINES 12" IN DIAMETER AND SMALLER SHALL BE PROTECTO 401 LINED DI (DUCTILE IRON PUSH ON) PC 350 PIPE UNLESS OTHERWISE SPECIFIED. ALL PROPOSED GRAVITY SEWER LINES 16" IN DIAMETER AND GREATER SHALL BE PROTECTO 401 LINED DI (DUCTILE IRON PUSH ON) PC 250, UNLESS OTHERWISE SPECIFIED.

3. CONTRACTOR'S ATTENTION IS DIRECTED TO SECTIONS 102, 107, AND 1550 OF THE STANDARD SPECIFICATIONS CONCERNING TRENCHLESS INSTALLATION. IT IS CONTRACTOR'S RESPONSIBILITY TO HAVE BORE DESIGNED AND SEALED BY A LICENSED NORTH CAROLINA PROFESSIONAL ENGINEER. NO DAMAGE IS ALLOWED TO RIVER, WETLANDS, OR BUFFER ZONES.

4. IF HDPE PIPE IS INSTALLED BY DIRECTIONAL DRILL. IT SHALL BE FILLED WITH WATER AND NOT BE CONNECTED TO ANY OTHER PIPE OR FITTINGS FOR ONE WEEK FROM THE TIME OF INSTALLATION.

5. ALL CONSTRUCTION TO BE IN ACCORDANCE WITH ALL FAYETTEVILLE PWC AND/OR NCDOT STANDARDS AND SPECIFICATIONS.

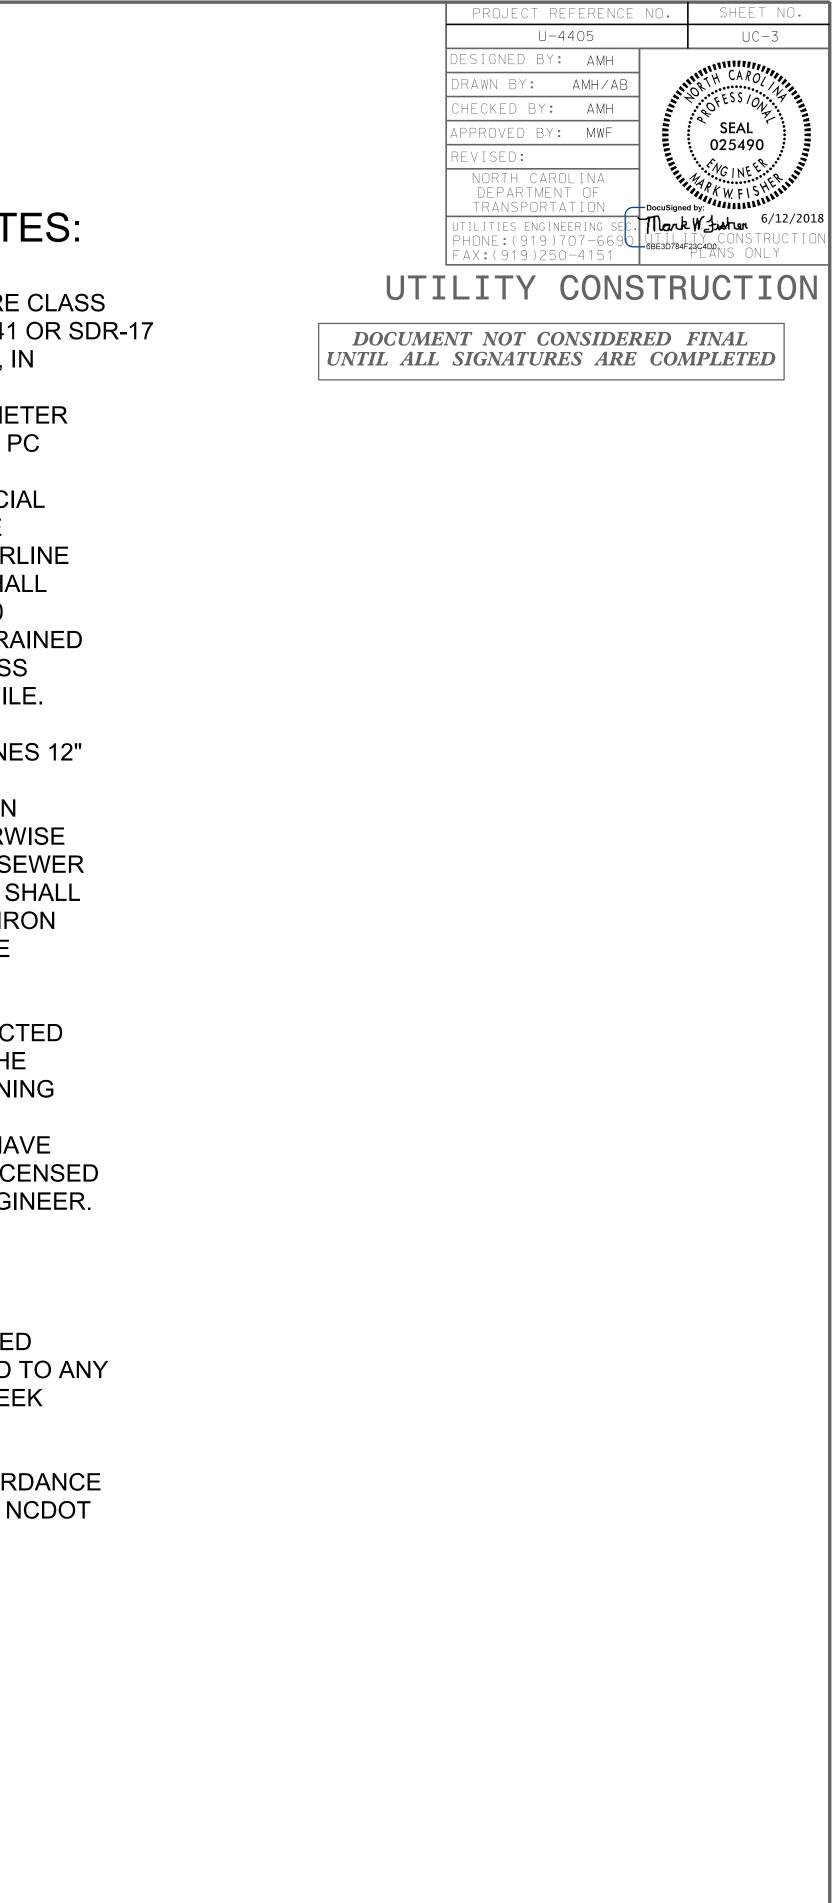

4. AFTER SLEEVING OF PROPOSED 24" MAIN TO EXISTING 24" MAIN, CONTRACTOR SHALL ADHERE TO CUT IN CONSTRUCTION REQUIREMENTS (AWWA C651) WHEN REINSTATING THE 24" MAIN. 5. WL-2, WL-3 AND WL-1 BETWEEN TAP AT -WL-1- STA 0+00 AND VALVE AT -WL-1- STA 8+95 SHALL BE INSTALLED AND OPERATIONAL BEFORE INSTALLING ANY OTHER PORTION OF WL-1. 6. PURSUANT TO TRAFFIC CONTROL REQUIREMENTS, CONTRACTOR MUST BE COMPLETE WITH THE PORTION OF WL-1 AND WL-2 BEFORE BEGINNING INSTALLATION OF WL-3. CONTRACTOR SHALL NOT BE PERFORMING WATER MAIN INSTALLATION LONGITUDINALLY TO THE ROAD ON BOTH SIDES. 7. SHUTDOWN TO CONNECT WL-1 TO EXISTING 24" MAIN AND PERFORM KILL-OUT OF EXISTING 24" MAIN AT TAPPING LOCATION SHALL BE FACILITATED THROUGH EV-1, EV-2A, EV-2C, EV-4 AND 24" TAPPING VALVE AND VALVE AT STA. 8+95. WL-2 AND WL-3 SHALL BE INSTALLED AND OPERATIONAL PRIOR TO SHUTDOWN FOR WL-1 TO BACKFEED SKATEWAY DRIVE. 8. PWC'S SAMPLING STATION SHALL NOT BE DISTURBED. PROVIDE NEW TAP AND LATERAL TO SAMPLING STATION IF 1" SERVICE LATERAL IS IN CONFLICT WITH PROPOSED DRAINAGE. SAMPLING STATION SHALL NOT BE INTERRUPTED DURING ANNUAL BURN OUT, WHICH OCCURS EVERY MARCH. OTHERWISE, SERVICE TO SAMPLING STATION MAY BE INTERUPTED SHOULD PLANNED SHUTDOWNS IMPACT THIS SERVICE LATERAL. 9. CITY OF FAYETTEVILLE HAS A 1" SERVICE FOR MEDIAN IRRIGATION. PROVIDE NEW TAP AND LATERAL TO RECONNECT 1" IRRIGATION SERVICE IF IT IS IN CONFLICT WITH PROPOSED DRAINAGE. CONTRACTOR SHALL REPLACE ALL DAMAGED IRRIGATION PIPING (INCIDENTAL AND THAT IS IN CONFLICT WITH WORK) AT NO ADDITIONAL COST. UC-6 UTILITY NOTES: 1.EXISTING METER AND SERVICE WAS NOT LOCATED. CONTRACTOR TO PROVIDE 1" METER SERVICE. COORDINATE LOCATION WITH PWC'S PROJECT COORDINATOR. 2.INSTALL AND HAVE OPERATIONAL WL-5 BETWEEN TAPPING VALVE TO 24"x24"x24" TEE AT -WL-5- STA 8+37.33. STUB-OUT WL-5 FOR CONNECTION TO EXISTING 24" MAIN. INSTALL AND HAVE OPERATIONAL WL-6 BETWEEN WL-5 AND 24" TAPPING VALVE FOR WL-6. STUB-OUT WL-7. 3. PURSUANT TO TRAFFIC CONTROL REQUIREMENTS, CONTRACTOR MUST BE COMPLETED WITH WORK ON WL-5 AS DEFINED IN ITEM 2 BEFORE BEGINNING INSTALLATION ON WL-6. CONTRACTOR SHALL NOT BE PERFORMING WATER MAIN INSTALLATION LONGITUDINALLY TO THE ROAD ON BOTH SIDES. 4. CONNECT EXISTING METERS ON EXISTING 24" MAIN TO WL-5 BEFORE PERFORMING EXISTING MAIN AND HYDRANT LEG ADJUSTMENTS BETWEEN EV-4 AND EV-8. 5. COORDINATE SHUTDOWN TO PERFORM EXISTING MAIN AND HYDRANT LEG ADJUSTMENTS BETWEEN EV-4 AND EV-8 WITH PWC'S PROJECT COORDINATOR AND KILLING OUT EXISTING MAIN AT TAPPING SLEEVE FOR WL-5 AT -WL-5- STA 0+00. EXISTING VALVES EV-4, EV-5, EV-8, AND TAPPING SLEEVE FOR WL-5 AT -WL-5- STA 0+00 SHALL FACILITATE SHUTDOWN AND MAINTAIN UNINTERRUPTED SERVICE TO CUSTOMERS. 6. AFTER COMPLETING ALTERATIONS IN NOTE 5, COMPLETE CONNECTION OF WL-5 TO EXISTING 24" MAIN BY CUTTING IN AND KILLING OUT EXISTING MAIN AT TAPPING SLEEVE FOR WL-6 UNDER PLANNED SHUTDOWN. CONSTRUCTION TIME FOR THIS WORK SHALL BE LIMITED TO WEEKEND AND SHALL NOT BEGIN UNTIL 6:00 P.M. ON FRIDAY. ALL WORK MUST BE COMPLETED AND WATER MAIN BACK IN OPERATION BEFORE 7:00 A.M. MONDAY. EXISTING VALVES EV-4, EV-5, EV-8A AND EV-9 SHALL FACLITATE SHUTDOWN TO MINIMIZE SERVICE INTERRUPTIONS. 7. WL-5 SLEEVE INTO EXISTING MAIN SHALL ENTAIL THE REMOVAL OF ONE 24" RJ BUTTERFLY VALVE AND ONE 24"x24" RJ TEE. EV-8A IS RESTRAINED AND SHALL NOT BE DAMAGED SO WL-5 CAN BE RECONNECTED TO IT USING NIPPLE AND FULL BODY MJ SLEEVE AND RESTRAINING GLANDS. 8. DURING INSTALLATION OF WL-5, CONTRACTOR SHALL REMOVE AND REPLACE 48 LF OF RCP AS SHOWN ON PLANS. 9. TEMPORARY SHORING IF REQUIRED FOR BUILDING FOUNDATION PROTECTION OR MAINTENANCE OF TRAFFIC WILL BE PAID AS TEMPORARY SHORING IN SQUARE FEET BELOW GROUND SURFACE.

UC-5 UTILITY NOTES:

1. CONTRACTOR SHALL LAY BACK INTO EXISTING 24" WATER MAIN WITH A MINIMUM OF 20 LF OF RESTRAINED JOINT UNDER PLANNED SERVICE INTERRUPTION. 2. CONTRACTOR SHALL PROVIDE A TEMPORARY RESTRAINED PLUG AND TEMPORARY BLOW OFF ASSEMBLY FOR TESTING AND FLUSHING PURPOSES BEFORE RECONNECTING TO EXISTING 24" MAIN. NO SEPARATE PAYMENT SHALL BE MADE FOR TEMPORARY BLOW-OFF ASSEMBLIES. 3. CONTRACTOR SHALL REMOVE TEMPORARY 24" PLUG AND SLEEVE TO EXISTING 24" WATER MAIN USING MJ x MJ FULL BODY SLEEVE AND RESTRAIN WITH RESTRAINING GLANDS.


5. WL-3 TO BE CONNECTED TO EXISTING MAIN UNDER SERVICE INTERRUPTION. ADHERE TO PWC'S PROCEDURES FOR SHUTDOWN. EXISTING VALVES EV-2A AND EV-2B SHALL BE CRITICAL IN ISOLATING CONNECTING POINTS. 6. KILL-OUT OF 24" SIDES OF 24"x24"x8"x8" CROSS TO BE FACILITATED BY SHUTDOWN WHEN KILLING OUT 24" MAIN AT TAPPING SLEEVE FOR WL-1. VALVES INCLUDING EV-1, EV-2A, EV-2B, EV-4 AND TAPPING VALVE FOR WL-1.

ON BOTH SIDES.

2. KILL OUT OF BRANCH LINE SIDE OF TAPPING SLEEVE SHALL BE COORDINATED WITH 24" MAIN SHUTDOWN FOR LAYING BACK NEW 24" MAIN INTO EXIST ALIGNMENT (SEE SHEET UC-5) 3. WL-2, WL-3 AND WL-1 BETWEEN TAP AT -WL-1- STA 0+00 AND VALVE AT APPROX -WL-1- STA. 8+95 SHALL BE INSTALLED AND OPERATIONAL BEFORE INSTALLING ANY OTHER PORTION OF WL-1 4. PURSUANT TO TRAFFIC CONTROL REQUIREMENTS, CONTRACTOR MUST BE COMPLETE WITH THE PORTION OF WL-1 AND WL-2 AS DEFINED IN NOTE 3 BEFORE BEGINNING INSTALLATION OF WL-3. CONTRACTOR SHALL NOT BE PERFORMING WATER MAIN INSTALLATION LONGITUDINALLY TO THE ROAD

DETAIL W-22.

UC-4 UTILITY NOTES: 1. FULLY GROUT MIN. 60LF OF 24" EXIST MAIN. PLUG EACH END OF ABANDONED MAIN PER PWC

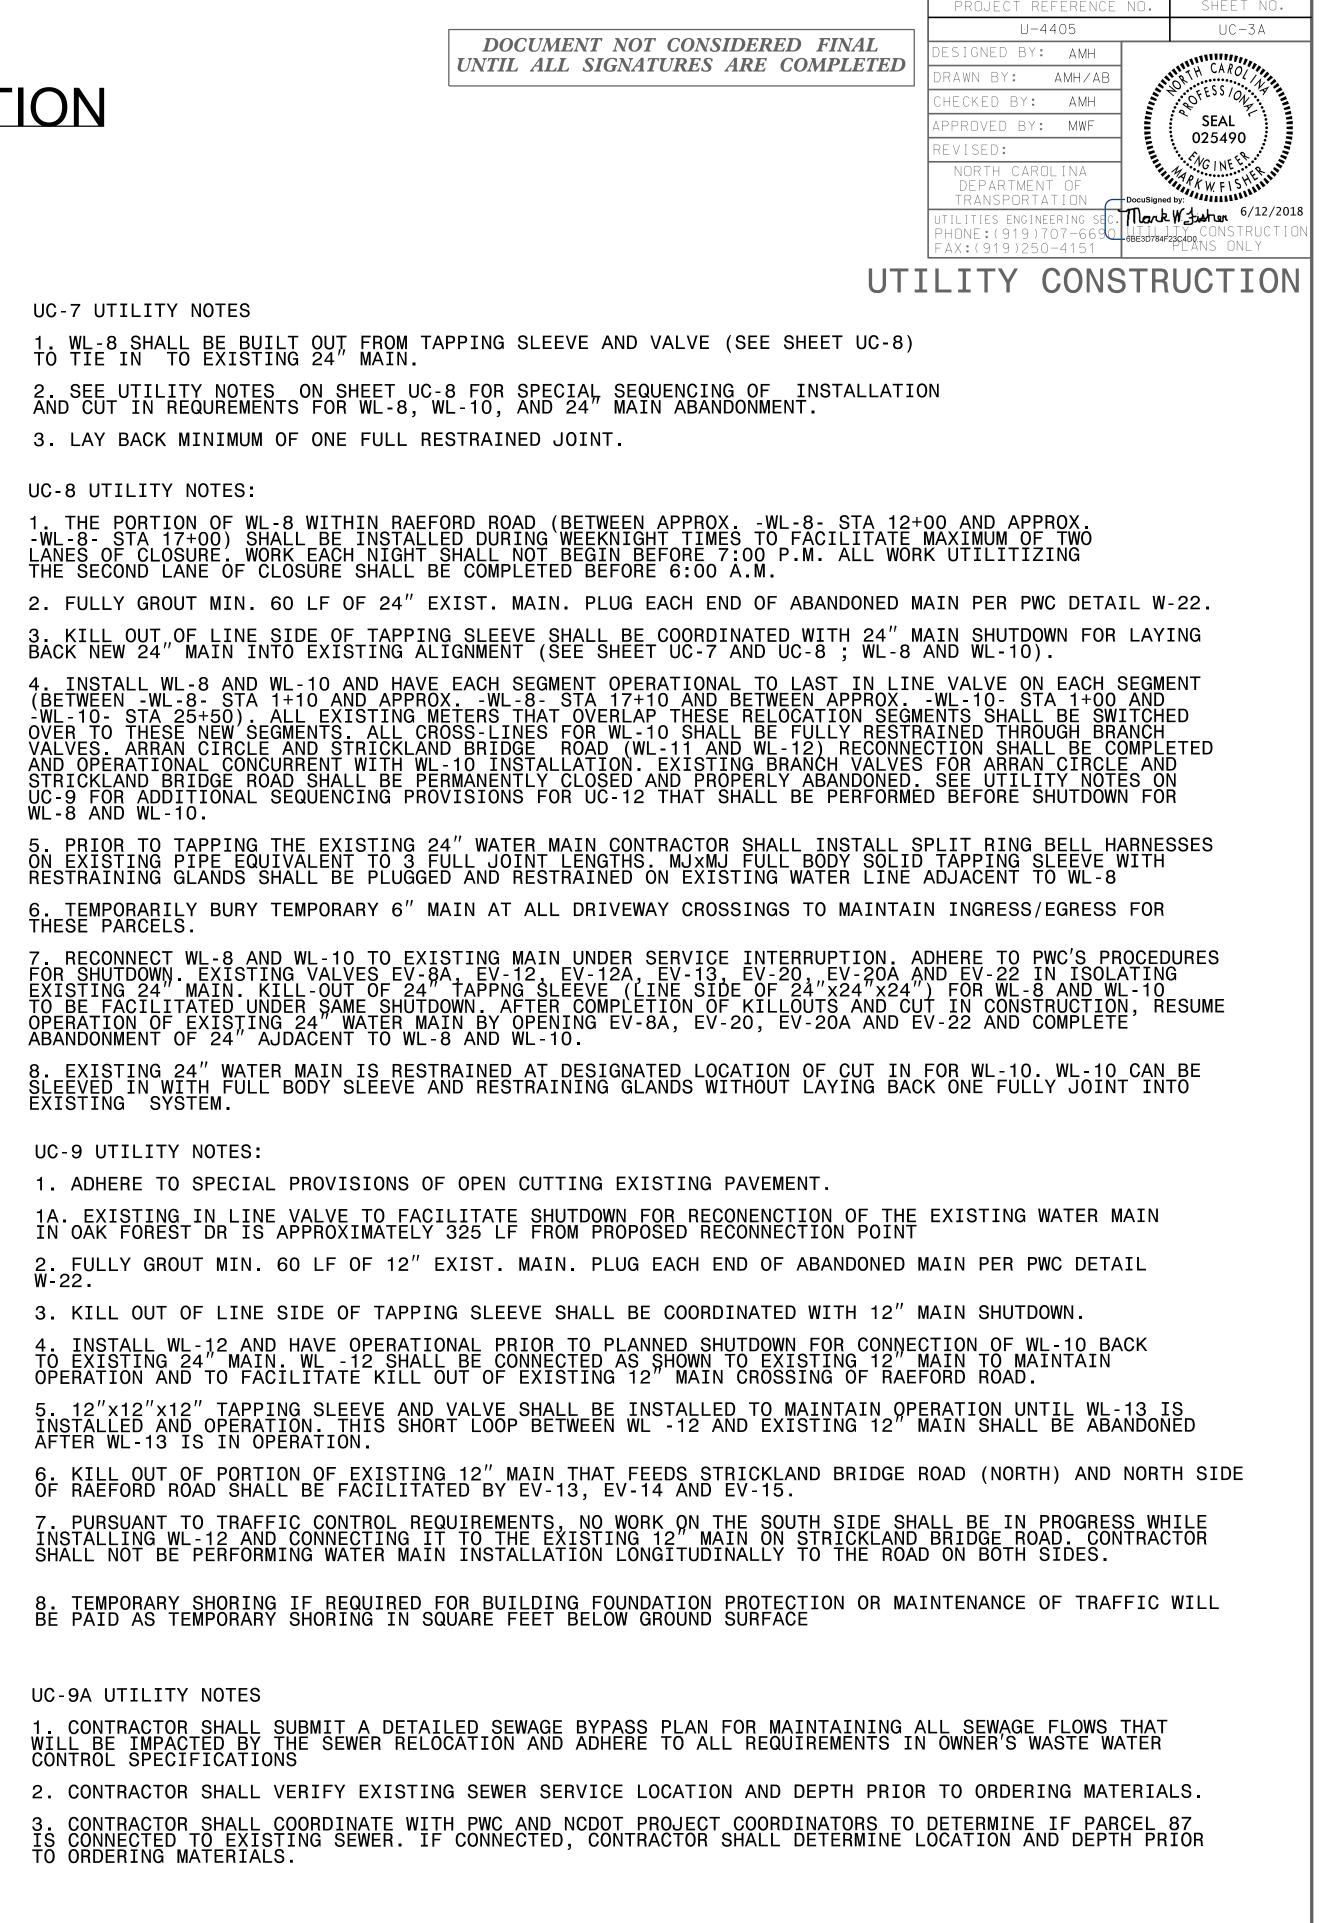

UTILITY CONSTRUCTION

UC-7 UTILITY NOTES

3. LAY BACK MINIMUM OF ONE FULL RESTRAINED JOINT.

UC-8 UTILITY NOTES:

UC-9 UTILITY NOTES:

1. ADHERE TO SPECIAL PROVISIONS OF OPEN CUTTING EXISTING PAVEMENT.

AFTER WL-13 IS IN OPERATION.

UC-9A UTILITY NOTES

UTILITY CONSTRUCTION UC-10 UTILITY NOTES: UC-13 UTILITY NOTES: 1. EXISTING IN LINE VALVE TO FACILITATE SHUTDOWN FOR RECONNECTION OF THE EXISTING WATER MAIN IN ARRAN CIRCLE IS APPROXIMATELY 760 LF FROM PROPOSED RECONNECTION POINT. 1. INSTALL WL-14 AND HAVE IT OPERATIONAL TO LAST IN LINE VALVE . ALL EXISTING METERS THAT OVERLAP THESE RELOCATION SEGMENTS SHALL BE SWITCHED OVER TO THESE NEW SEGMENTS. ALL CROSS-LINES FOR WL-14 SHALL BE FULLY RESTRAINED THROUGH BRANCH VALVES. BINGHAM DRIVE, WL-15, WL-15A AND WILDWOOD DRIVE RECONNECTIONS SHALL BE COMPLETED 2. CONTRACTOR SHALL LAY BACK A MINIMUM OF 1 FULL JOINT OF RESTRAINED DUCTILE IRON PIPE. AND OPERATIONAL CONCURRENT WITH WL-14 INSTALLATION. EXISTING BRANCH VALVES FOR THESE CROSS LINES SHALL BE PERMANENTLY CLOSED AND PROPERLY ABANDONED. SEE UTILITY NOTES ON UC-12 FOR ADDITIONAL SEQUENCING PROVISIONS FOR WL-15 THAT SHALL BEPERFORMED BEFORE SHUTDOWN FOR WL-14. 3. FULLY GROUT MIN. 60LF OF 24" EXIST MAIN. PLUG EACH END OF ABANDONED MAIN PER PWC DETAIL W-22 4. KILL OUT OF BRANCH SIDE OF TAPPING SLEEVE SHALL BE COORDINATED WITH 24" MAIN SHUTDOWN FOR LAYING BACK NEW 24" MAIN INTO EXIST 2. PRIOR TO SHUTTING DOWN 24" MAIN TO FACILITATE KILL OUT OF EXISTING 24" MAIN AT WL-14 TAPPING SLEEVE AND CUT IN CONSTRUCTION FOR WL-14 TIE BACK TO EXISTING 24" MAIN, INSTALL WL-16 AND HAVE IT OPERATIONAL. RECONNECT ALL SERVICES TO WL-16. SEE UC-13 FOR ADDITIONAL SEQUECING PROVISIONS FOR WL-16 THAT SHALL BE PERFORMED BEFORE SHUTDOWN FOR WL-14. ALIGNMENT 5. REFERENCE UTILITY NOTES ON SHEET UC-8 FOR SEQUENCE OF WL-10 AND ABANDONMENT OF EXISTING 24" MAIN. 6. WL-13 UP TO PROPOSED IN LINE VALVE NEAR STATION -WL-13- STA 24+00 AND THE EXISTING CROSS-LINE THAT SERVES OAK FOREST DRIVE SHALL BE INSTALLED AND IN OPERATION PRIOR TO RECONNECTING TO THE EXISTING 12" IN BUNCE ROAD. ADHERE TO PROVISIONS FOR OPEN CUTTING PAVEMENT AND WORKING WITHIN TRAFFIC TO RECONNECT PROPOSED 12" MAIN TO EXISTING MAIN. EXISTING MAIN AT POINT OF CONNECTION IS RESTRAINED. CONNECT TO EXISTING RESTRAINED JOINT PIPE WITH FULL BODY MJ X MJ SLEEVE AND RESTRAINING GLANDS. 3. BORE AND JACK FOR WL-15A SHALL BE INSTALLED AHEAD OF WL-14 SO BORE PIT WILL NOT BE IN CONFLICT WITH WL-14. BORE INSTALLATION IS ANTICIPATED TO BE IN CONFLICT WITH EXISTING SEWER. INSTALL TEMPORARY DOGHOUSE SSMH FOR RECEIVING SEWAGE BYPASS. READY SEWER BYPASS TO MAINTAIN SEWER SERVICE. UPON COMPLETION OF ENCASEMENT INSTALLATION AND THREADING OF 2-INCH MAIN, COMPLETE SEWER REPLACEMENT AS SHOWN ON UC-13A WHILE SEWER FLOW IS UNDER BYPASS. SEE ADDITIONAL PROVISIONS ON SHEET UC-13A. 7. CONNECT WL-13 TO EXISTING MAIN UNDER SERVICE INTERRUPTION. ADHERE TO PWC'S PROCEDURES FOR SHUTDOWN. EXISTING VALVES EV-20, BRANCH VALVE AT EV-21, EXISTING IN LINE VALVE AT EV-21A, NEW TAPPING VALVE ON WL-12 THAT LOOPED TO EXISTING MAIN (SEE PREVIOUS SHEET) TO FACILITATE SHUTDOWN. SHUTDOWN SHALL BE PERFORMED BETWEEN 11:00 P.M. AND 5:00 A.M. SERVICE SHALL BE RESTORED TO EXISTING 12" MAIN TO MINIMIZE SERVICE DISRUPTION TO EXISTING CUSTOMERS BETWEEN 1103 BUNCE RD AND 1165 BUNCE RD. 4. PROTECT WORK AREA TO MAINTAIN INGRESS/EGRESS TO BUSINESS AND STORE FRONT PARKING. 5. REMOVE INSITU MATERIAL COMPLETELY FOR 2" WATER MAIN ACROSS PARCEL 140 DUE TO POTENTIAL OF PRIOR CONTAMINATION. MINIMUM TRENCH WIDTH FOR INSITU MATERIAL AND SELECT BACKFILL SHALL BE 2 FEET WIDE BY 4 FEET DEEP. 6. TEMPORARY SHORING IF REQUIRED FOR BUILDING FOUNDATION PROTECTION OR MAINTENANCE OF TRAFFIC WILL BE PAID AS TEMPORARY SHORING IN SQUARE FEET 8. AFTER RECONNECTION, ABANDON CROSS-OVER LINE FROM WL-12 TO EXISTING WATER MAIN. SEE PREVIOUS SHEET AND KILL OUT EXISTING 12" MAIN AT VALVE EV-20. METER RECONNECTION NOTES FOR PARCEL NO. 136 1. PROVIDE 2" TAP WITH 2" CURB STOP AND 2" BLOW OFF ASSEMBLY. 4-1" STD. PWC METER ASSEMBLIES SHALL BE PROVIDED. 9. TEMPORARY SHORING IF REQUIRED FOR BUILDING FOUNDATION PROTECTION OR MAINTENANCE OF TRAFFIC WILL BE PAID AS TEMPORARY SHORING IN SQUARE FEET BELOW GROUND SURFACE 2. RECONNECT TO CUSTOMER'S EXIST. 3-1" PVC WATER LATERALS. FIELD COORDIANTE WATER SERVICE PIPING ROUTE. 3. RECONNECT PROPOSED IRRIGATION METER TO CUSTOMERS EXIST. RPZ. FIELD COORDINATE IRRIGATION PIPING TO ENCLOSURE. UC-11 UTILITY NOTES: 1. FULLY GROUT MIN. 60 LF OF 24" EXIST. MAIN. PLUG EACH END OF ABANDONED MAIN PER PWC DETAIL W-22. UC-13A UTILITY NOTES: 1. PLUG EXISTING 8" OPENING IN SSMH AFTER PROPOSED SEWER IS OPERATIONAL. 2. KILL OUT OF LINE SIDE OF TAPPING SLEEVE SHALL BE COORDINATED WITH 24" MAIN SHUTDOWN FOR LAYING BACK NEW 24" MAIN INTO EXISTING ALIGNMENT (SEE SHEET UC-13). 2. PROP. SSMH SHALL BE CUT IN (DOG-HOUSE STYLE). EXISTING LINE FOR TEMPORARY SEWAGE BYPASS. IT SHALL BE OPERATIONAL PRIOR TO INITIATING BORE AND JACK AND SETTING PROPOSED UPSTREAM SSMH. PROP. SSMH SHALL BE ABANDONED AFTER NEW SEWER 3. INSTALL AND HAVE OPERATIONAL THE FOLLOWING SEGMENTS: WL-14 TO LAST IN LINE VALVE, WL-15, WL-17 AND CROSS LINES AT BINGHAM DRIVE, REVERE STREET AND WILDWOOD DRIVE. RECONNECT ALL METERS TO WL-14 AND WL-17. SEE ADDITIONAL SEQUENCING FOR WL-15 ON SHEET UC-12 AND WL-17 ON SHEET UC-13 AND UC-14. IS OPERATIONAL AND BYPASS PUMPING CAN BE DISCONTINUED 3.PROP. SSMH SHALL BE 4' DIA. RECONNECT EXISTING DI AT SAME SLOPE USING DI COUPLING RATED FOR SEWER SERVICE. 4. KILL OUT OF LINE SIDE OF TAPPING SLEEVE FOR WL-14 SHALL BE COORDINATED WITH CUT IN CONSTRUCTION (SLEEVE IN) OF WL-14 TO EXISTING 24" MAIN (SEE SHEET UC-13). KILL OUT SHALL BE PERFORMED UNDER PLANNED SHUTDOWN OF EXISTING 24" MAIN AND SHALL BE PERFORMED BETWEEN 600 P.M. AND 9:00 A.M. ON SUNDAY. EXISTING 4" MAIN SHALL BE BACK IN OPERATION SO WATER SERVICE TO PARCELS 107, 112, 113 AN 115 ARE NOT IMPACTED DURING NORMAL BUSINESS HOURS. ADHERE TO PWC'S PROCEDURES FOR SHUTDOWN. EXISTING VALVES EV-22, EV-28, EV-31 AND EV-28A SHALL FACILITATE SHUTDOWN. AFTER COMPLETION OF KILLOUTS AND CUT IN CONSTRUCTION, RESUME OPERATION OF EXISTING 24" WATER MAIN BY RE-OPENING EV-22 AND EV-31. 4. CONNECTION TO EXISTING SSMH SHALL BE BY FIELD CORE. CORE SHALL BE NEAT AND EQUIPPED WITH BOOTED CONNECTION. 5. LOCATE ELECTRICAL CIRCUITRY TO LIGHTS PRIOR TO SEWER INSTALLATION. ALL CIRCUITRY SHALL BE PROTECTED. ANY DAMAGE SHALL BE REPAIRED AND SHALL MEET LOCAL ELECTRICAL REQUIREMENTS. 6. REMOVE INSITU MATERIAL COMPLETELY FOR 2" WATER MAIN ACROSS PARCEL 140 DUE TO POTENTIAL OF PRIOR CONTAMINATION. MINIMUM TRENCH WIDTH FOR INSITU MATERIAL AND SELECT BACKFILL SHALL BE 2 FEET WIDE BY 4 FEET DEEP. 5. RECONNECTION OF EXISTING 24" MAIN ON BINGHAM DRIVE SHALL BE BY PLANNED SHUTDOWN. EXISTING VALVES TO FACILITATE SHUTDOWN INCLUDE EV-23A AND EV-23B. LAY BACK 20 LF OF RESTRAINED JOINT DUCTILE IRON PIPE AND RECONNECT TO EXISTING MAIN USING FULL BODY MJ SLEEVE WITH RESTRAINING GLANDS. RECONNECTION SHALL BE PERFORMED BETWEEN 6:00 P.M. AND 6:00 A.M. ONLY ON A WEEKNIGHT. 7. TEMPORARY SHORING IF REQUIRED FOR BUILDING FOUNDATION PROTECTION OR MAINTENANCE OF TRAFFIC WILL BE PAID AS TEMPORARY SHORING IN SQUARE FEET BELOW GROUND SURFACE 8. CONTRACTOR SHALL VERIFY SEWER SERVICE DEPTH AND LOCATION PRIOR TO ORDERING MATERIALS. 9. CONTRACTOR SHALL REPLACE EXISTING CLEAN OUT AND SEWER SEVICE LINE AT SAME DEPTH ĂND ŠLOPE UC-12 UTILITY NOTES: 10. CONTRACTOR SHALL REMOVE EXISTING CLEAN OUT AND EXISTING SEWER SERVICE TO PROPOSED CLEAN OUT LOCATION. CONTRACTOR SHALL GROUT FILL EXISTING SERVICE CORE IN MANHOLE WITH 1. CONNECTION OF WL-15 TO EXISTING WATER MAIN SHALL BE UNDER PLANNED SHUTDOWN. EXISTING VALVE EV-28 AND EV-28A SHALL FACILITATE SERVICE INTERRUPTION. REMOVE PLUG AND CONNECT TO EXISTING MAIN USING FULL BODY MJ SLEEVE AND RESTRAINING GLANDS. WL-15 SHALL BE INSTALLED AND OPERATIONAL TO MAINTAIN SERVICE TO THE NORTH SIDE AND FACILITATE KILL OUT OF THE 24" MAIN ON THE SOUTH SIDE. NON-SHRINK GROUT. 2. PURSUANT TO TRAFFIC CONTROL REQUIREMENTS, NO WORK ON THE SOUTH SIDE SHALL BE IN PROGRESS WHILE INSTALLING WL-15 AND CONNECTING IT TO THE EXISTING ON THE NORTH SIDE. CONTRACTOR SHALL NOT BE PERFORMING WATER MAIN INSTALLATION LONGITUDINALLY TO THE ROAD ON BOTH SIDES. 3. TEMPORARY SHORING IF REQUIRED FOR BUILDING FOUNDATION PROTECTION OR MAINTENANCE OF TRAFFIC WILL BE PAID AS TEMPORARY SHORING IN SQUARE FEET BELOW GROUND SURFACE

PROJECT REFERENCE NO. SHEET NO. DOCUMENT NOT CONSIDERED FINAL U−4405 UC-3B UNTIL ALL SIGNATURES ARE COMPLETED SIGNED BY: AMH W CARI RAWN BY: AMH/AB OFESSION HECKED BY: AMH SEAL PPROVED BY: MWF 025490 EVISED: MGINE ER NORTH CAROLINA KW. FIST DEPARTMENT OF TRANSPORTATION Mark W. Fister 6/12/2018 TILITIES ENGINEERING S HONE:(919)707-66 -68E3D784F23C4D0.... FAX: (919)250-4151 PLANS ONLY UTILITY CONSTRUCTION UC-14 UTILITY NOTES: 1. CONNECTION OF WL-16 TO EXISTING 8" SHALL BE PERFORMED UNDER PLANNED SERVICE INTERRUPTION. LENGTH OF BURIED PIPE BETWEEN DEAD END PLUG AND EV-33A IS LESS THAN 95 LF FOR BURIAL DEPTH OF 3 FEET. EXISTING VALVE EV-33A, EV-33B AND EXISTING HYDRANT BETWEEN THESE TWO VALVES SHALL FACILITATE SHUTDOWN TO REMOVE EXISTING DEAD END PLUG, INSTALL PROPOSED 8" RJ GATE VALVE AND MINIMUM OF THREE JOINTS OF PROPOSED PIPE. PROPOSED VALVE AND MINIMUM OF THREE JOINTS OF PROPOSED PIPE. PROPOSED VALVE AND MINIMUM OF THREE JOINTS OF PIPE INSTALLATION SHALL BE PERFORMED DURING NON-BUSINESS HOURS (BETWEEN 10:00 P.M. AND 6:00 A.M.). COORDINATE WITH PWC PROJECT COORDINATOR. EV-33A AND EV-33B SHALL BE TEMPORARILY CLOSED AND EXISTING HYDRANT SHALL BE UTILIZED TO LOWER PRESSURE SO EXISTING 8" PLUG CAN BE SAFELY REMOVED AND CONNECTION CAN BE MADE. REFERENCE PWC DETAIL M.15. 2. AFTER INSTALLATION OF 8" RJ GATE VALVE AND MINIMUM OF 60 LF OF PIPE, COORDINATE WITH PWC PROJECT COORDINATOR TO RESTORE OPERATION OF EV-33B. MAINTAIN CLOSURE OF EV-33A UNTIL WATER MAIN LENGTH EXCEEDS 125 LF FROM NEW 8" RJ VALVE. AT THAT POINT, DISINFECT EXISTING MAIN BETWEEN EV-33A AND NEW VALVE AND PERFORM BACTERIOLOGICAL TESTING BEFORE PLACING IT BACK IN OPERATION. UTILIZE EXISTING 2" BLOW ASSEMBLY TO FLUSH EXISTING MAIN. MAINTAIN CLOSURE OF NEW 8" RJ GATE VALVE AND RESUME OPERATION OF EV-33A AND CONTINUE INSTALLATION OF WL-16. 3. AFTER EXISTING SEGMENT BETWEEN EV-33A AND NEW VALVE HAS BEEN PLACED BACK IN SERVICE, ABANDON EXISTING 2" TAP AND REMOVED BLOW ASSEMBLY. 4. WL-16 SHALL BE IN OPERATION BEFORE CUT IN CONSTRUCTION FOR WL-14. SEE SEQUENCE NOTES ON UC-13. 5. ADHERE TO NCDOT TRAFFIC CONTROL PROVISIONS. WL-16 INSTALLATION SHALL BE COORDINATED SO THAT IT IS PERFORMED WHEN LONGITUDINAL WORK ON THE SOUTH SIDE OF RAEFORD ROAD IS NOT OCCURRING. 6. COORDINATE WITH PWC'S PROJECT COORDINATOR FOR EXISTING VALVES TO FACILITATE TEMPORARY SHUT DOWN. 7. PROP. 8" GATE VALVE SHALL BE CUT IN AND MIN. 40 LF OF 8" PVC PIPE SHALL BE REMOVED AND REPLACED WITH RESTRAINED JOINT DIP AND SLEEVED BACK TO EXISTING PVC. WORK SHALL BE PERFORMED UNDER SERVICE INTERRUPTION. SERVICE INTERRUPTION SHALL BE CONSISTENT WITH PWC'S REQUIREMENTS. THIS WORK SHALL BE PERFORMED AND COMPLETED PRIOR TO BEGINNING WORK ON EXTENSION OF EXISTING 84" CMP AND TRENCHLESS 72" STORM CROSSINGS. 8. CUT IN VALVE AND EXISTING 8" VALVE AT 8" CONNECTION TO EXISTING 24" MAIN SHALL BE UTILIZED TO ISOLATE EXISTING 8" FOR DRAINAGE WORK. 9. WL-18 SHALL BE INSTALLED AND OPERATIONAL PRIOR TO EXTENDING 84" CULVERTS AND INSTALLING 72". WL-18 WILL BE REQUIRED TO BACK FEED CUSTOMERS WHEN ISOLATING EXISTING 8" MAIN AS DEFINED IN NOTE 3. 10. FULLY GROUT MIN. 60 LF OF 24" EXIST. MAIN. PLUG EACH END OF ABANDONED MAIN PER PWC DETAIL W-22. 11. KILL OUT OF LINE SIDE OF TAPPING SLEEVE SHALL BE COORDINATED WITH 24" MAIN SHUTDOWN FOR LAYING BACK NEW 24" MAIN INTO EXISTING ALIGNMENT (SEE SHEET UC-14). UC-15 UTILITY NOTES: 1. FULLY GROUT MIN. 60LF OF 24" EXIST MAIN. PLUG EACH END OF ABANDONED MAIN PER PWC DETAIL W-22. 2. KILL OUT OF BRANCH LINE SIDE OF TAPPING SLEEVE SHALL BE COORDINATED WITH 24" MAIN SHUTDOWN FOR LAYING BACK NEW 24" MAIN INTO EXIST ALIGNMENT UC-17 UTILITY NOTES: 1. PRIOR TO BEGINNING WORK ON PORTION OF WL-18 BETWEEN EUCALYPTUS AND HOPE MILLS ROAD, CONTRACTOR SHALL COMPLETE FOLLOWING: A. WL-18 BETWEEN SANDALWOOD AND EUCALYPTUS SHALL BE OPERATIONAL B. WL-19 BETWEEN HOPE MILLS ROAD AND CONNECTION TO EXISTING 8" AT FRED ANDERSON SHALL BE OPERATIONAL C. TEMPORARY 2" MAIN TO MAINTAIN WATER SERVICES FOR PARCEL 21 SHALL BE OPERATIONAL. 2. PARCEL 25 HAS 2-1" METERS AND 6" FIRELINE THAT WILL NEED TO BE REPLACED AND RECONNECTED 3. TEMPORARY SHORING IF REQUIRED FOR BUILDING FOUNDATION PROTECTION OR MAINTENANCE OF TRAFFIC WILL BE PAID AS TEMPORARY SHORING IN SQUARE FEET BELOW GROUND SURFACE

RIGHT OF ENTRY NOTE: 1. CONTRACTOR SHALL BE RESPONSIBLE FOR SECURING RIGHT OF ENTRY TO RECONNECT NEW MAIN TO EXISTING FIRE LINE IF RECONNECTION CANNOT BE MADE WITHIN PUE

1. 2" SERVICE IS ASSUMED TO BE IRRIGATION TAP FOR BYRAN HONDA. CONTRACTOR TO COORDINATE WITH PWC PROJECT COORDINATOR PRIOR TO PROVIDING NEW SERVICE AND ORDERING MATERIAL.

UC-20B UTILITY NOTES:

UC-20A UTILITY NOTES: 1. TEMPORARY SHORING IF REQUIRED FOR BUILDING FOUNDATION PROTECTION OR MAINTENANCE OF TRAFFIC WILL BE PAID AS TEMPORARY SHORING IN SQUARE FEET BELOW GROUND SURFACE

RIGHT OF ENTRY NOTE: 1. CONTRACTOR SHALL BE RESPONSIBLE FOR SECURING RIGHT OF ENTRY TO RECONNECT NEW MAIN TO EXISTING FIRE LINE IF RECONNECTION CANNOT BE MADE WITHIN PUE

UC-20 UTILITY NOTES: 1. 2" SERVICE IS ASSUMED TO BE IRRIGATION TAP FOR BYRAN HONDA. CONTRACTOR TO COORDINATE WITH PWC PROJECT COORDINATOR PRIOR TO PROVIDING NEW SERVICE AND ORDERING MATERIAL.

9. TEMPORARY SHORING IF REQUIRED FOR BUILDING FOUNDATION PROTECTION OR MAINTENANCE OF TRAFFIC WILL BE PAID AS TEMPORARY SHORING IN SQUARE FEET BELOW GROUND SURFACE

8. CONTRACTOR SHALL SECURE BYPASS PIPING ACROSS IRELAND DRIVE AND MAINTAIN TRAFFIC FLOW. TRAFFIC RATED RAMP OR OTHER ACCEPTABLE TEMPORARY MEANS SHALL BE PROVIDED TO MAINTAIN TRAFFIC FLOW FOR IRELAND DRIVE.

CONSTRUCTION SHALL SUBMIT A DETAILED SEWAGE BYPASS PLAN FOR MAINTAINING L SEWAGE FLOWS THAT WILL BE IMPACTED BY THE SEWER RELOCATION AND ADHERE TO L REQUIREMENTS IN OWNERS'S WASTEWATER FLOW CONTROL SPECIFICATIONS ALL 7.CONTRACTOR SHALL PROPERLY BARRICADE BYPASS PUMP MANHOLE AND ADHERE TO MUTCD FOR BARARICADE PLACEMENT AND SIGNAGE. TRAFFIC FLOW IN RAEFORD ROAD SHALL NOT BE OBSTRUCTED BY BYPASS PUMP OPERATION.

C. CONTRACTOR SHALL COORDINATE WITH PWC'S PROJECT COORDINATOR TO ISOLATE EXISTING 12" VALVE, EV-45, WEST OF HOPE MILLS ROAD INTERSECTION AND STATION -WL-20R2- STA 40+75 (EAST OF IRELAND DRIVE) SO 12" CAN BE TAKEN OFF LINE AND TO CONNECT ENDS OF PROPOSED 30". 6. (ALL

B.CONTRACTOR SHALL ALSO INSTALL WL-20R2 FROM MAIN LINE VALVE AT APPROX -WL-20R2- STA 33+12 TO WL-22 (APPROX. -WL-20R2- STA 53+50), HAVE OPERATIONAL AND RECONNECT ALL SERVICES AND EXISTING CROSS-LINES.

A.CONTRACTOR SHALL INSTALL WL-20R2 FROM HOPE MILLS ROAD TO PROP. MAIN LINE VALVE NEAR STATION 24+35, HAVE OPERATIONAL AND RECONNECT ALL SERVICES AND EXISTING CROSS-LINES .

5.CONTRACTOR SHALL SAFEGUARD EXIST. 12" AC DURING INSTALLATION OF 30" BY IMPLEMENTING THE FOLLOWING SPECIAL PROVISION:

4.CONTRACTOR SHALL RE-ROUTE 1" SERVICE FOR PARCEL 215 BEFORE INSTALLING WL-20.

2.PRIOR TO PERFORMING BORE AND JACK OF WL-19A, CONTRACTOR SHALL PROVIDE TEMPORARY 1" SERVICE TO NEW METER. TEMPORARY 1" SERVICE SHALL BE TAPPED OFF OF THE EXISTING 12". ONCE WL-20 IS OPERATIONAL, RECONNECT METER TO 30" 3.CONTRACTOR SHALL RE-ROUTE 4" LATERAL ON PARCEL 213 TO CLEAR ISLAND FOR PROP. HYDRANT. RE-ROUTE 4" LATERAL BEFORE INSTALLING WL-20.

1.EXIST. 2" MAIN CONFLICTS WITH TRENCH FOR PROP. 8" MAIN. CONTRACTOR SHALL MAINTAIN EXIST. 2" SERVICE WHILE INSTALLING PROP. 8". CONTRACTOR SHALL COORDINATE WITH PWC PROJECT COORDINATE WHEN INSTALLING TEMPORARY SERVICE LATERAL TO 2" METER.


UC-19 UTILITY NOTES:


UTILITY CONSTRUCTION

UC-21 UTILITY NOTES:


1. CONTRACTOR SHALL COORDINATE WITH BRYAN HONDA PRIOR TO CONSTRUCTION TO COORDINATE TRENCHING THROUGH PARKING LOT. CONTRACTOR SHALL POTHOLE IN ADVANCE OF CONSTRUCTION AND IDENTIFY ALL LIGHTING CIRCUITRY AND CONTROL CONDUIT. LOCATIONS ON DRAWINGS ARE APPROXIMATE AND SHALL BE VERIFIED. 2. CONTRACTOR SHALL NOT DISTURB ANY CONDUIT FOR POWER AND CONTROL WIRING FOR LIGHT POLE AND DRIVEWAY SENSORS. CONTRACTOR SHALL TAKE PRECAUTIONS AND MEASURES TO PROTECT EXISTING CONDUITS. 3. CONTRACTOR SHALL PROTECT LIGHT POLES FROM TRENCHING OF WATER MAIN. CONTRACTOR SHALL BE RESPONSIBLE FOR COORDINATION AND ALL COSTS ASSOCIATED WITH DISMANTLING AND REINSTALLING LIGHT POLES DURING INSTALLATION OF WATER MAIN, ACCORDING TO DRAWINGS PROVIDED BY DEALERSHIP, POLE BASES ARE 2'-6" SQUARE AND INSTALLED 7" DEEP. 4. COORDINATE METER PLACEMENTS WITH 6" CONDUIT THAT POWERS AND CONTROLS DRIVEWAY SENSORS. 5. 3" WATER SERVICE AND 8" SPRINKLER LINE ARE BASED ON RECORDS OBTAINED FROM DEALERSHIP. COORDINATE WITH PWC PROJECT COORDINATOR AND DEALERSHIP TO VERIFY IF MAINS NEED TO BE RECONNECTED. QUANTITIES ARE INCLUDED IN BID ESTIMATES. VERIFY MATERIAL PRIOR TO ORDERING MATERIAL FOR RECONNECTION. 6. BACKFLOW FOR 8" FIRE LINE IS PRESUMABLY IN BUILDING.


UC-32 UTILITY NOTES: 1. FULLY GROUT MIN. 60LF OF 24" EXIST MAIN. PLUG EACH END OF ABANDONED MAIN PER PWC DETAIL W-22.

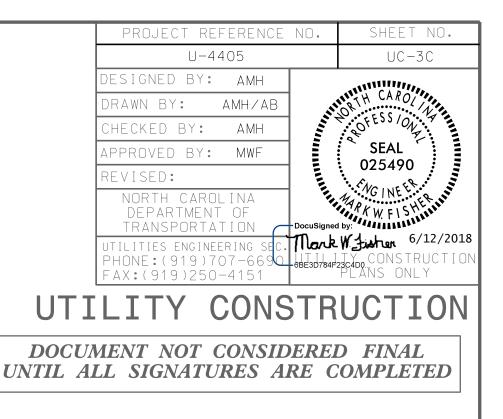


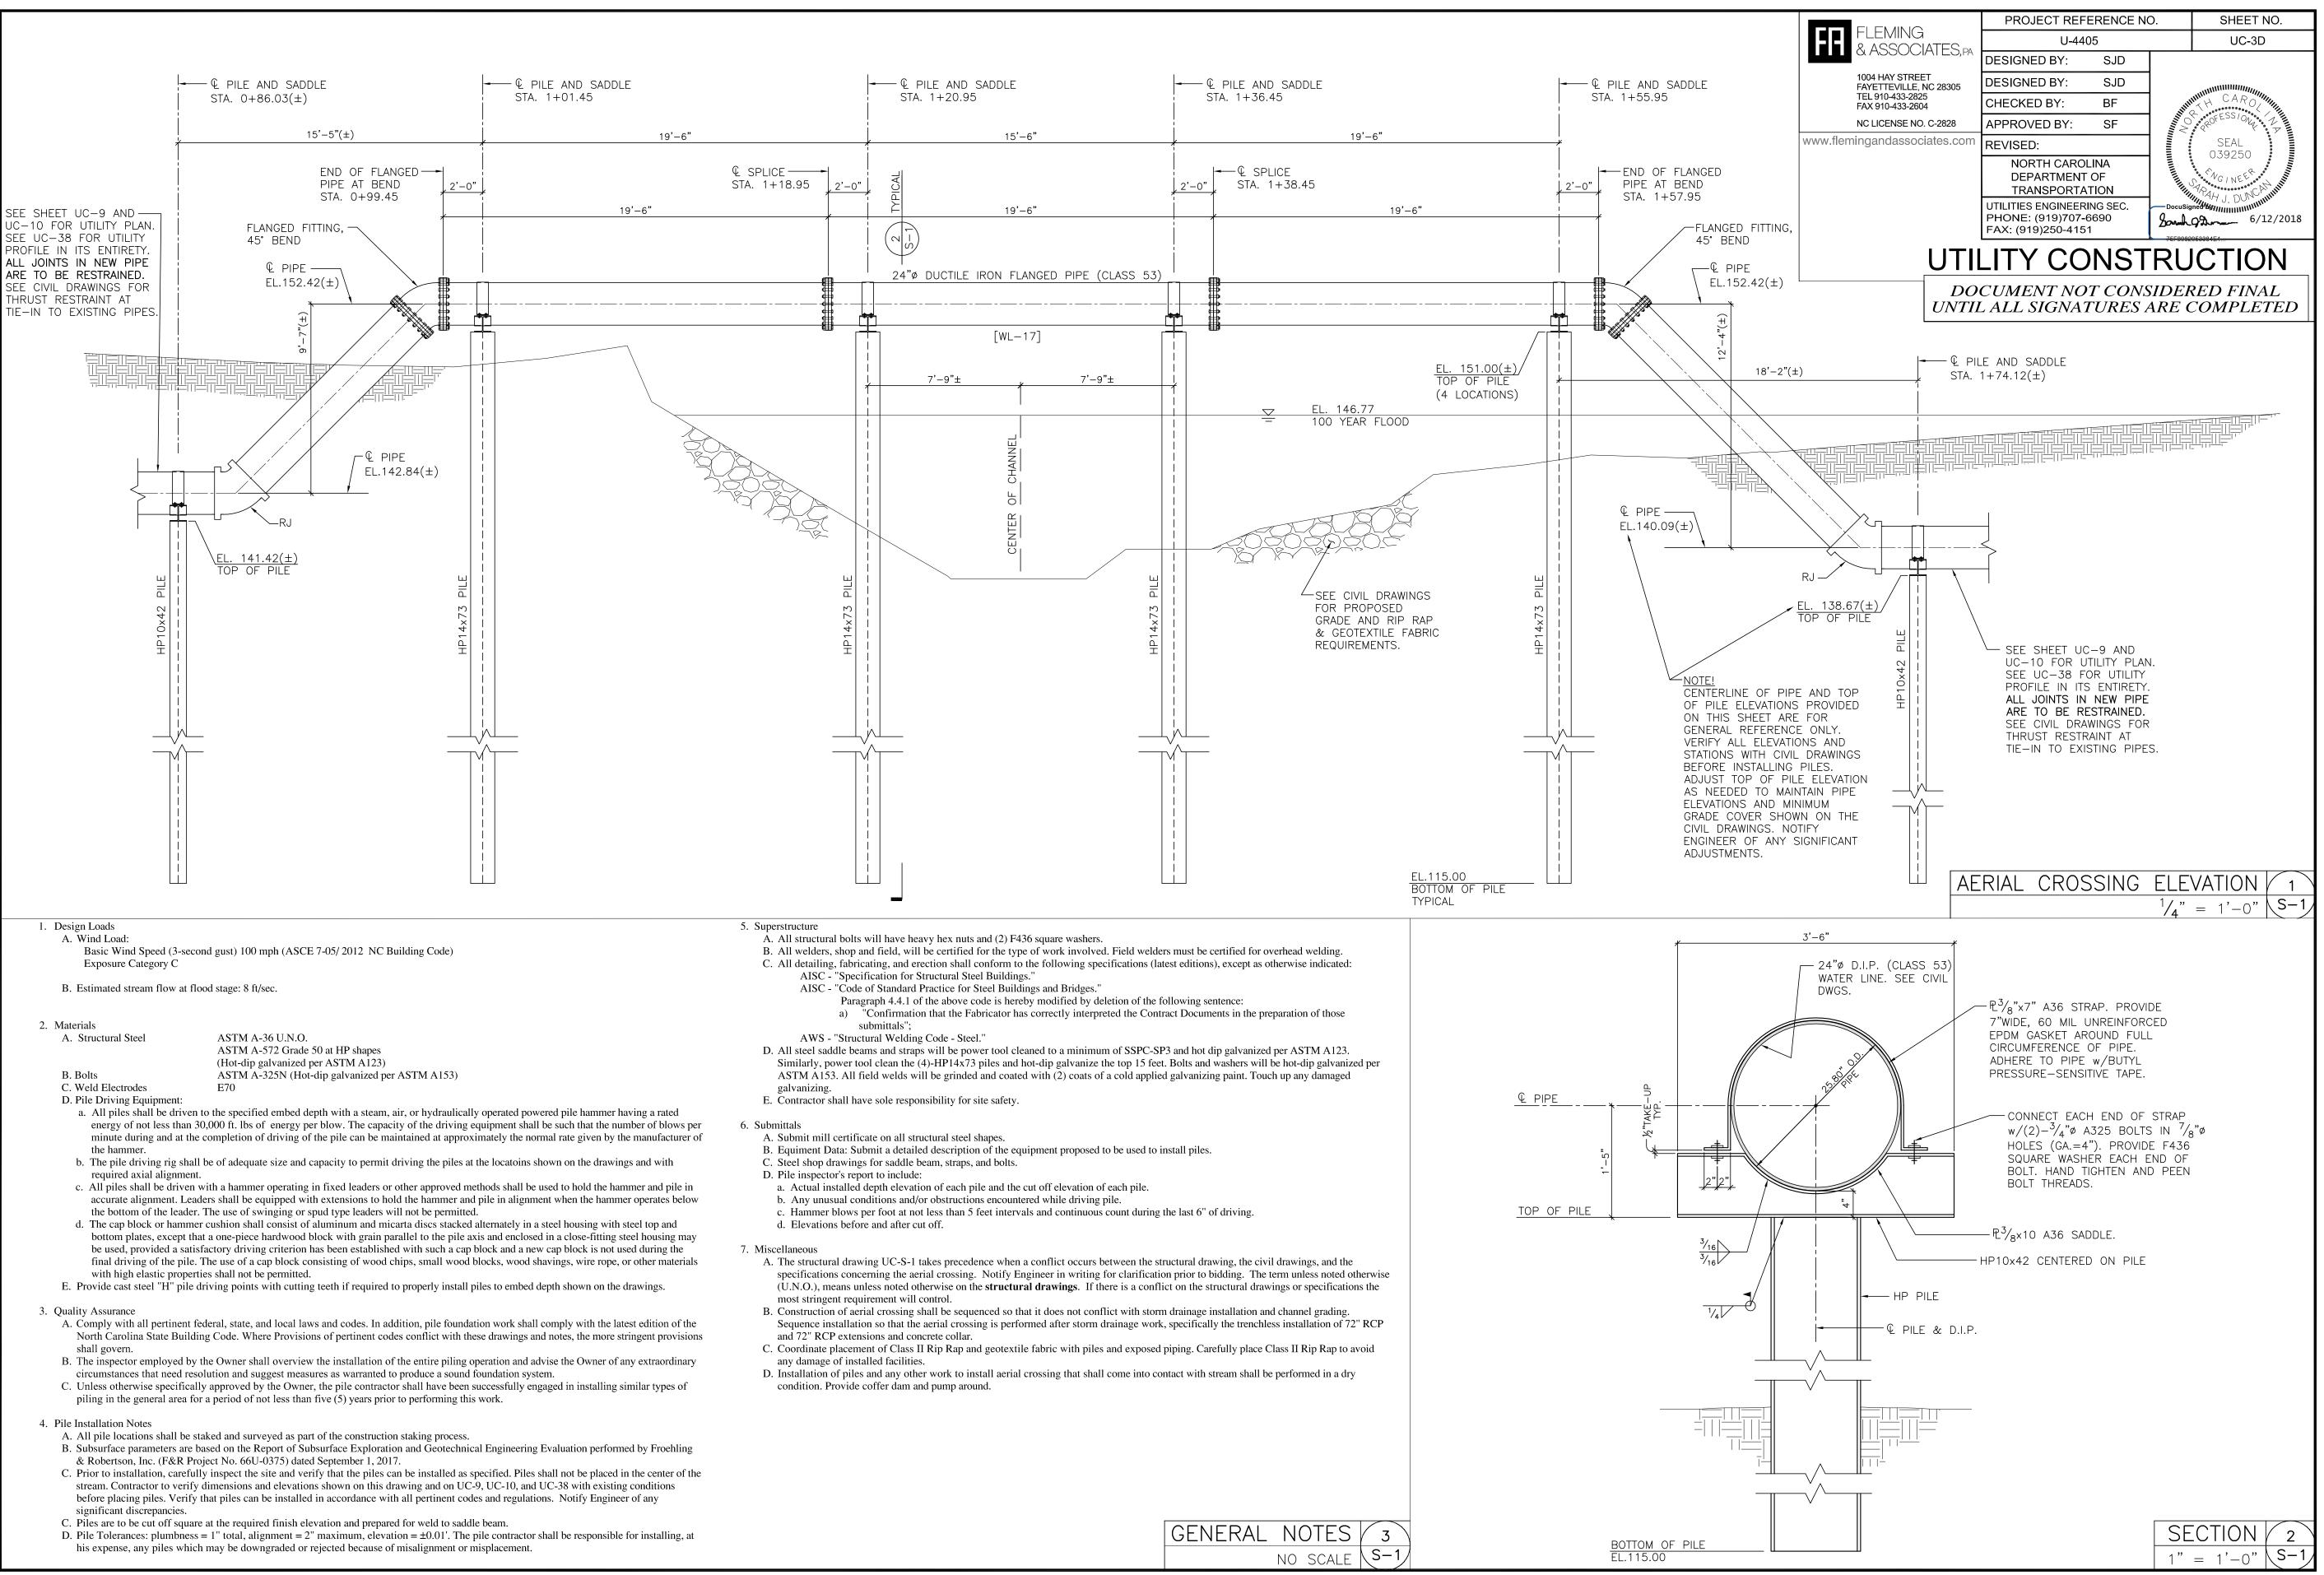



GENERAL	NOTES	3
	NO SCALE	\ S-

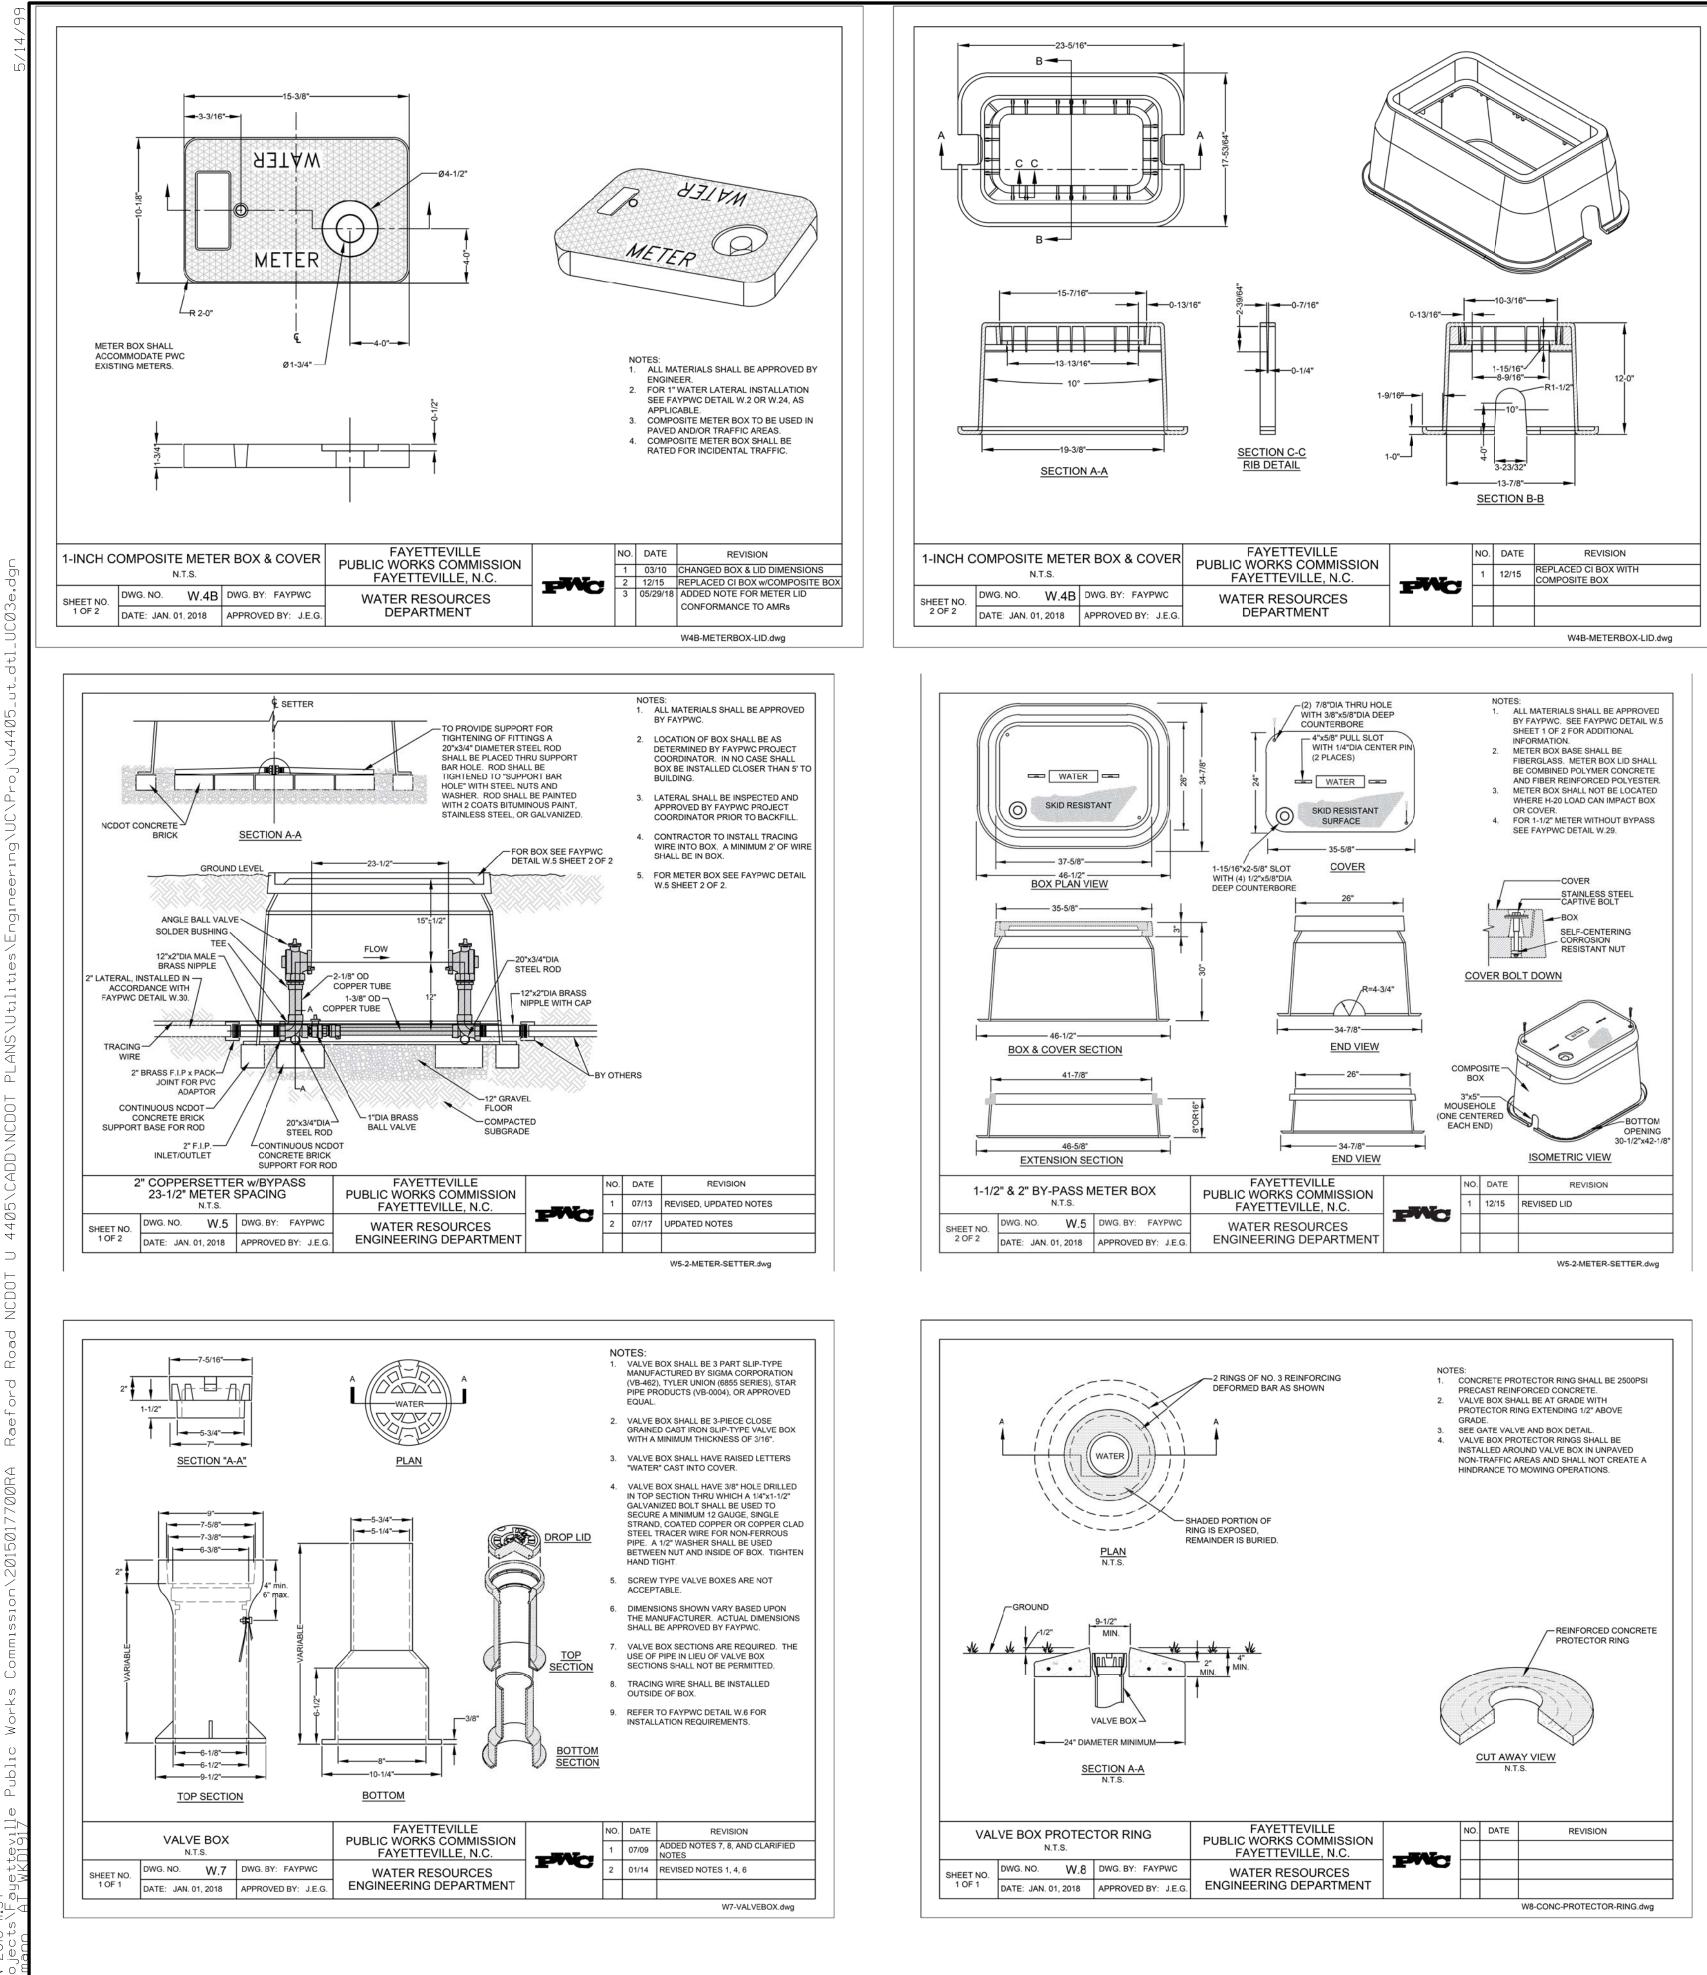


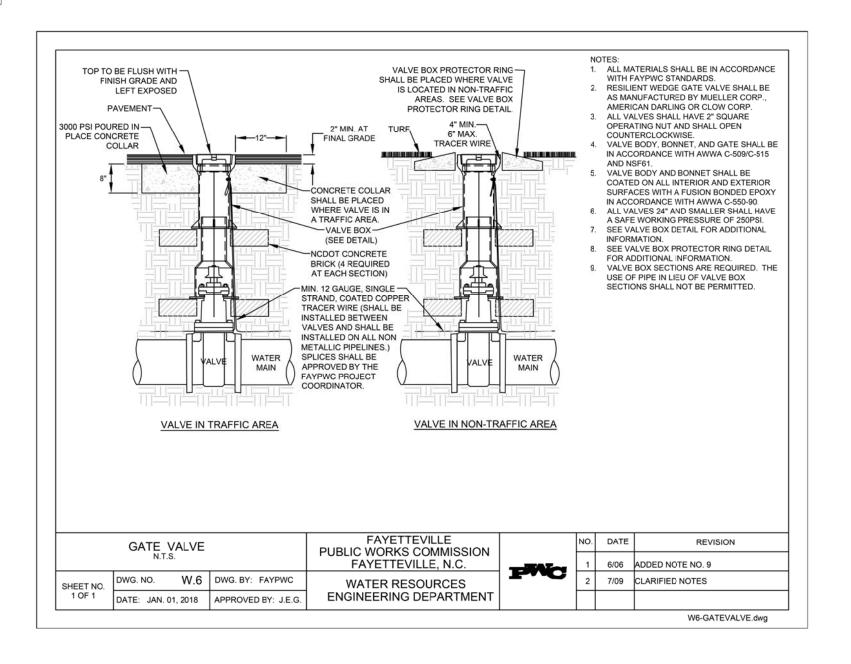

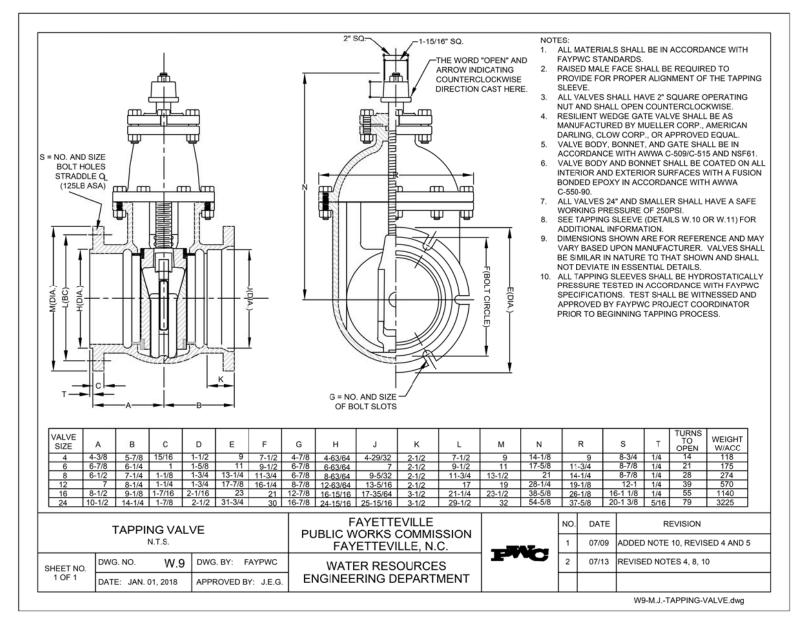

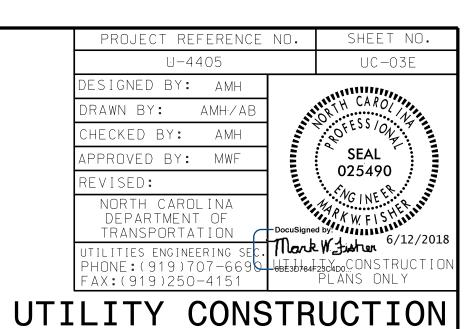


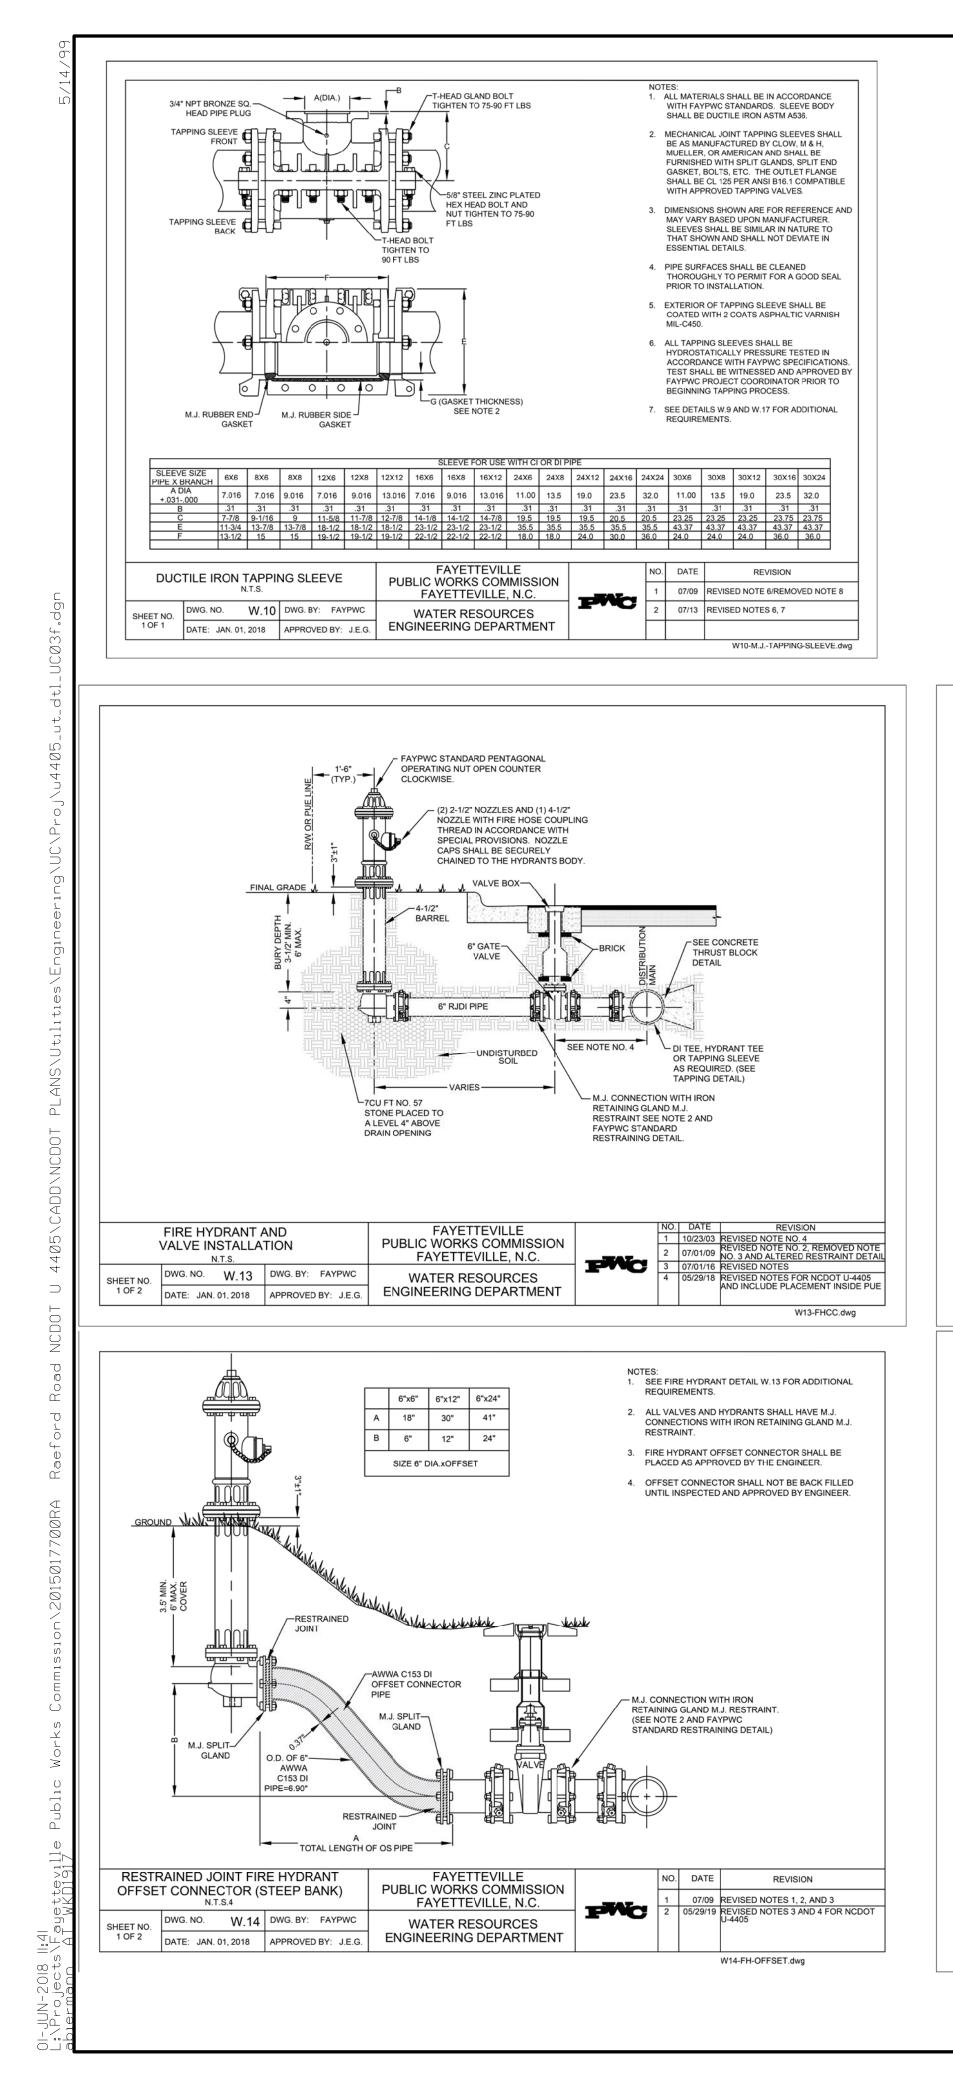

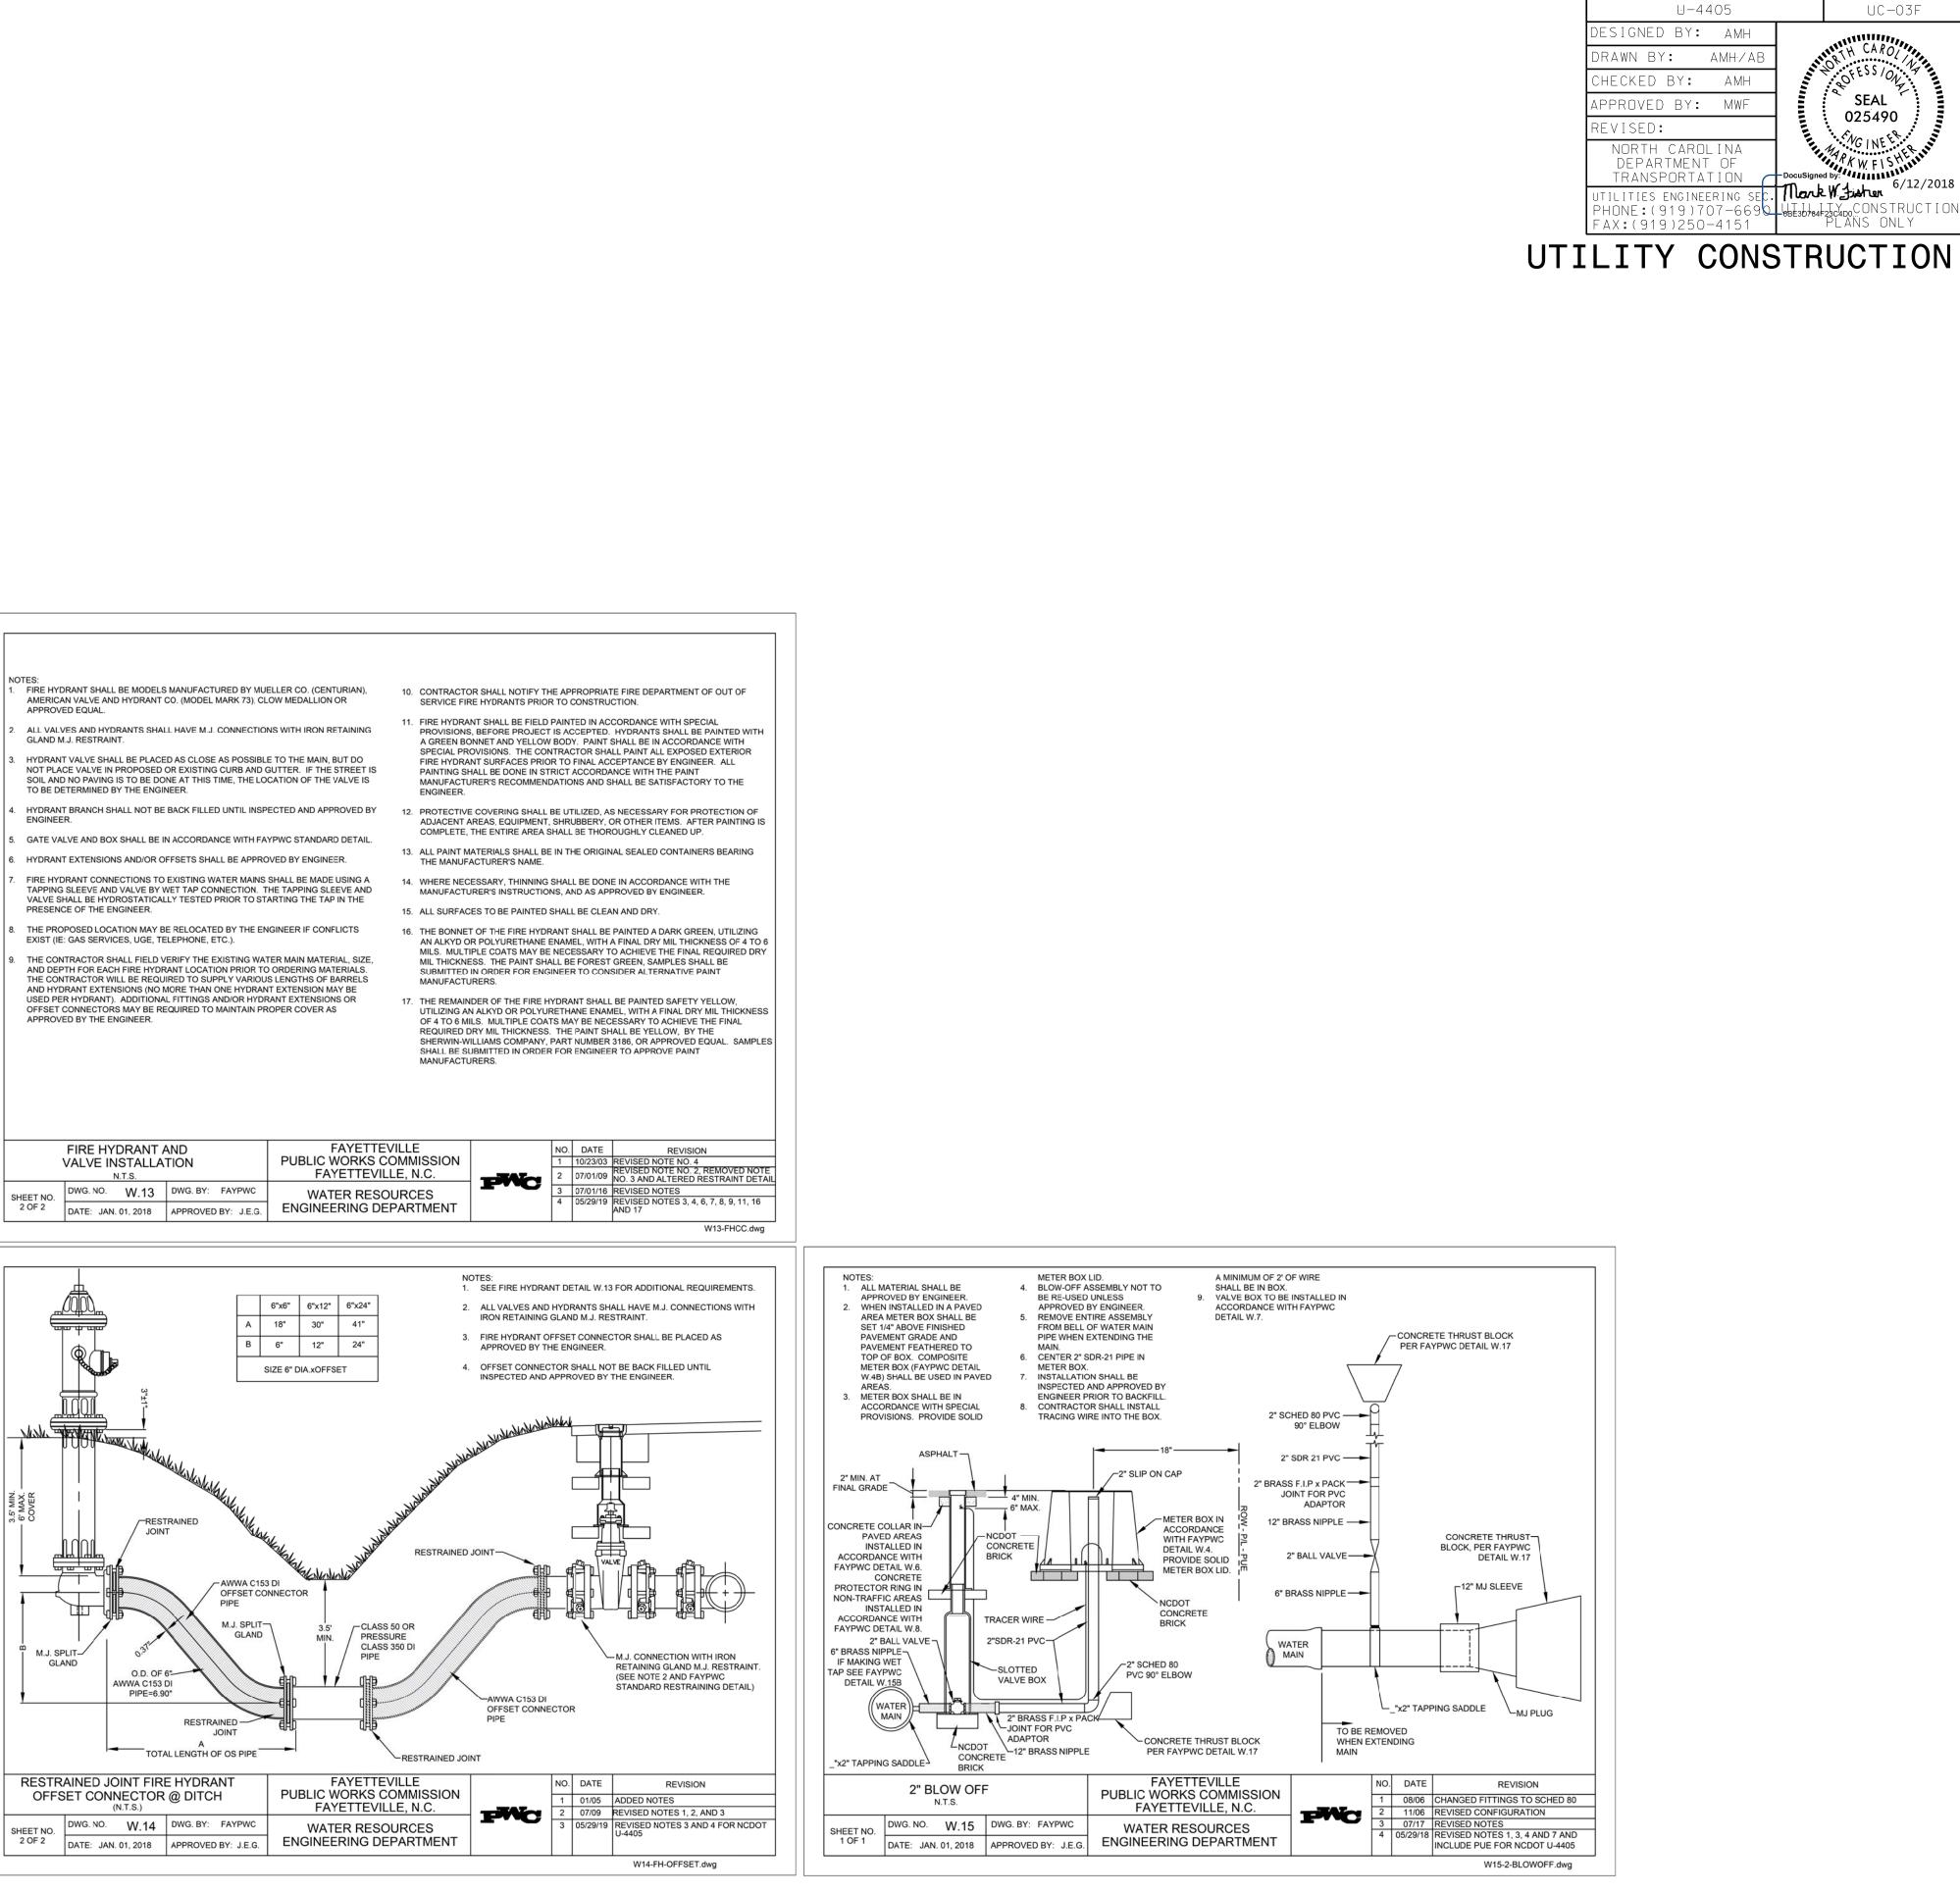

PROJECT REFERENCE NO.

SHEET NO.

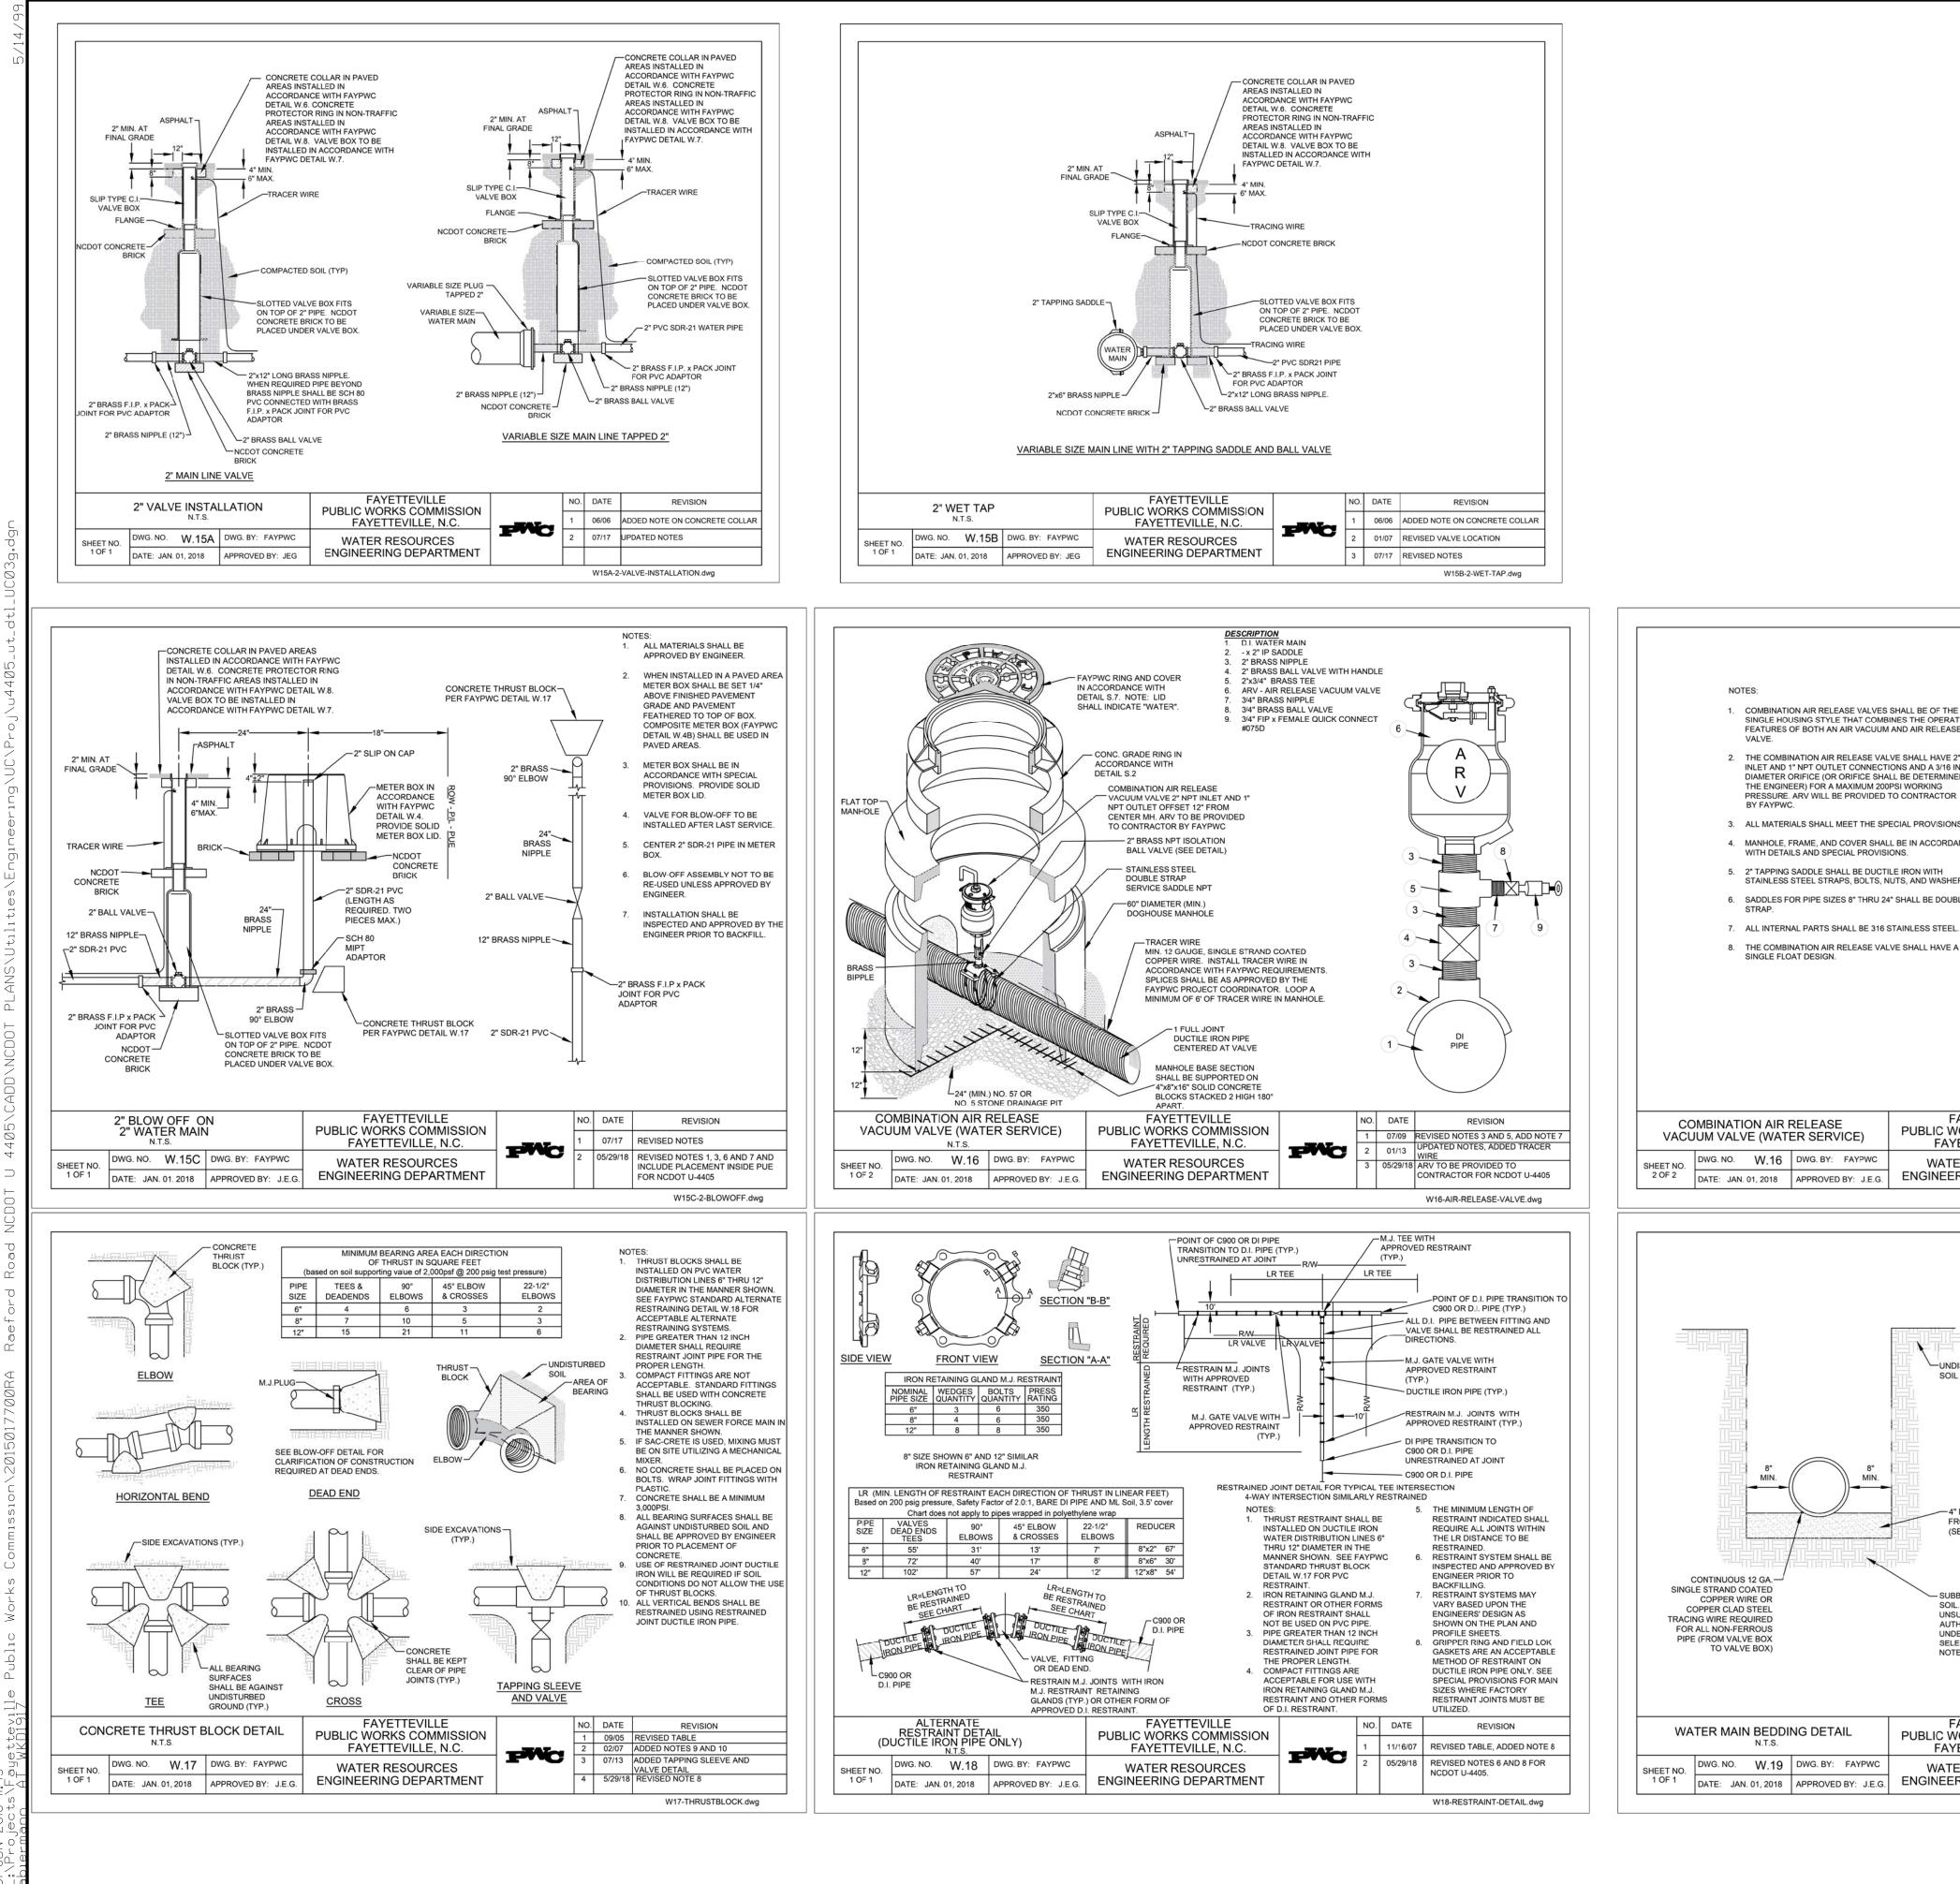

—	HONE: (919)707-6690 AX: (919)250-4151	SEAL 025490 MGINE Docusigned by: Mork W FISH UTLITY CONSTRUCTION BBE3D784F23C4DNS ONLY STRUCTION
 8. ALL COMBINATION AIR RELEASE VALVES SHALL BE INSTALLED IN ACCORDANCE WITH MANUFACTURER RECOMMENDATIONS. 10. ALL COMBINATION AIR RELEASE VALVES SHALL BE PROVIDED BY THE CONTRACTOR BY PWC. E 2° NPT 11. COMBINATION AIR RELEASE VALVE SHALL BE CENTERED IN MANHOLE. OFFSET THE RING AND COVER TO ALLOW ACCESS. OR 12. TOP OF FORCE MAIN SHALL BE A MINIMUM 4' DEEP AT AIR RELEASE VALVE, UNLESS OTHERWISE REQUIRED DUE TO PORCE MAIN AND/OR COMBINATION AIR RELEASE VALVE SIZE. DANCE 13. COMBINATION AIR RELEASE VALVE BODIES SHALL BE MADE OF STAINLESS STEEL OR REINFORCED NYLON 14. THE MANHOLE SHALL BE CAST WITH AN ANTI-MICROBIAL ADDITIVE (CON-SHIELD OR APPROVED EQUAL.) UBLE EL. 		
FAYETTEVILLE NO. DATE REVISION WORKS COMMISSION 1 01/13 ADDED NOTE 16, REVISED NOTES YETTEVILLE, N.C. 2 07/16 DELETED NOTES 3, 16 TER RESOURCES 3 05/29/18 REVISED NOTES 2, 3, 4, AND 10 FOR NCDOT U-4405 NCDOT U-4405 NCDOT U-4405		
NOTES: 1. SUITABLE SOIL BEDDING IS DEFINED AS "NATIVE" SOIL EXCAVATED FROM THE TRENCH, FREE OF ROCKS, FOREIGN MATERIAL, AND FROZEN EARTH. 2. SUITABLE BEDDING MATERIAL SHALL EXTEND TO UNDISTURBED TRENCH WALLS. 3. IF GROUND CONDITIONS WARRANT, IT MAY BE NECESSARY TO BED DUCTILE IRON WATER MAINS IN SELECT BEDDING MATERIAL (NO. 5 OR NO. 57 STONE) TO THE SPRINGLINE OF THE PIPE. SUCH INSTALLATION SHALL BE AS DIRECTED BY THE ENGINEER.		
4" MIN. SUITABLE SOIL BEDDING FROM TRENCH EXCAVATION (SEE NOTE 1)		
JBBASE SHALL BE UNDISTURBED DIL. WHERE SOIL IS DEEMED NSUITABLE BY THE ENGINEER JTHORIZED AREA SHALL BE NDERCUT AND BACKFILLED WITH ELECT BEDDING MATERIAL (SEE DTE 3).		
FAYETTEVILLE WORKS COMMISSION YETTEVILLE, N.C. NO. DATE REVISION 1 01/01/17 REVISED NOTES 2 2 07/01/13 REVISED NOTE RE: TRACER WIRE 3 05/29/18 REVISED NOTES FOR NCDOT U-4405 W19-WATER-BEDDING.dwg		

PROJECT REFERENCE NO.

AMH / AB

U-4405

ESIGNED BY: AMH


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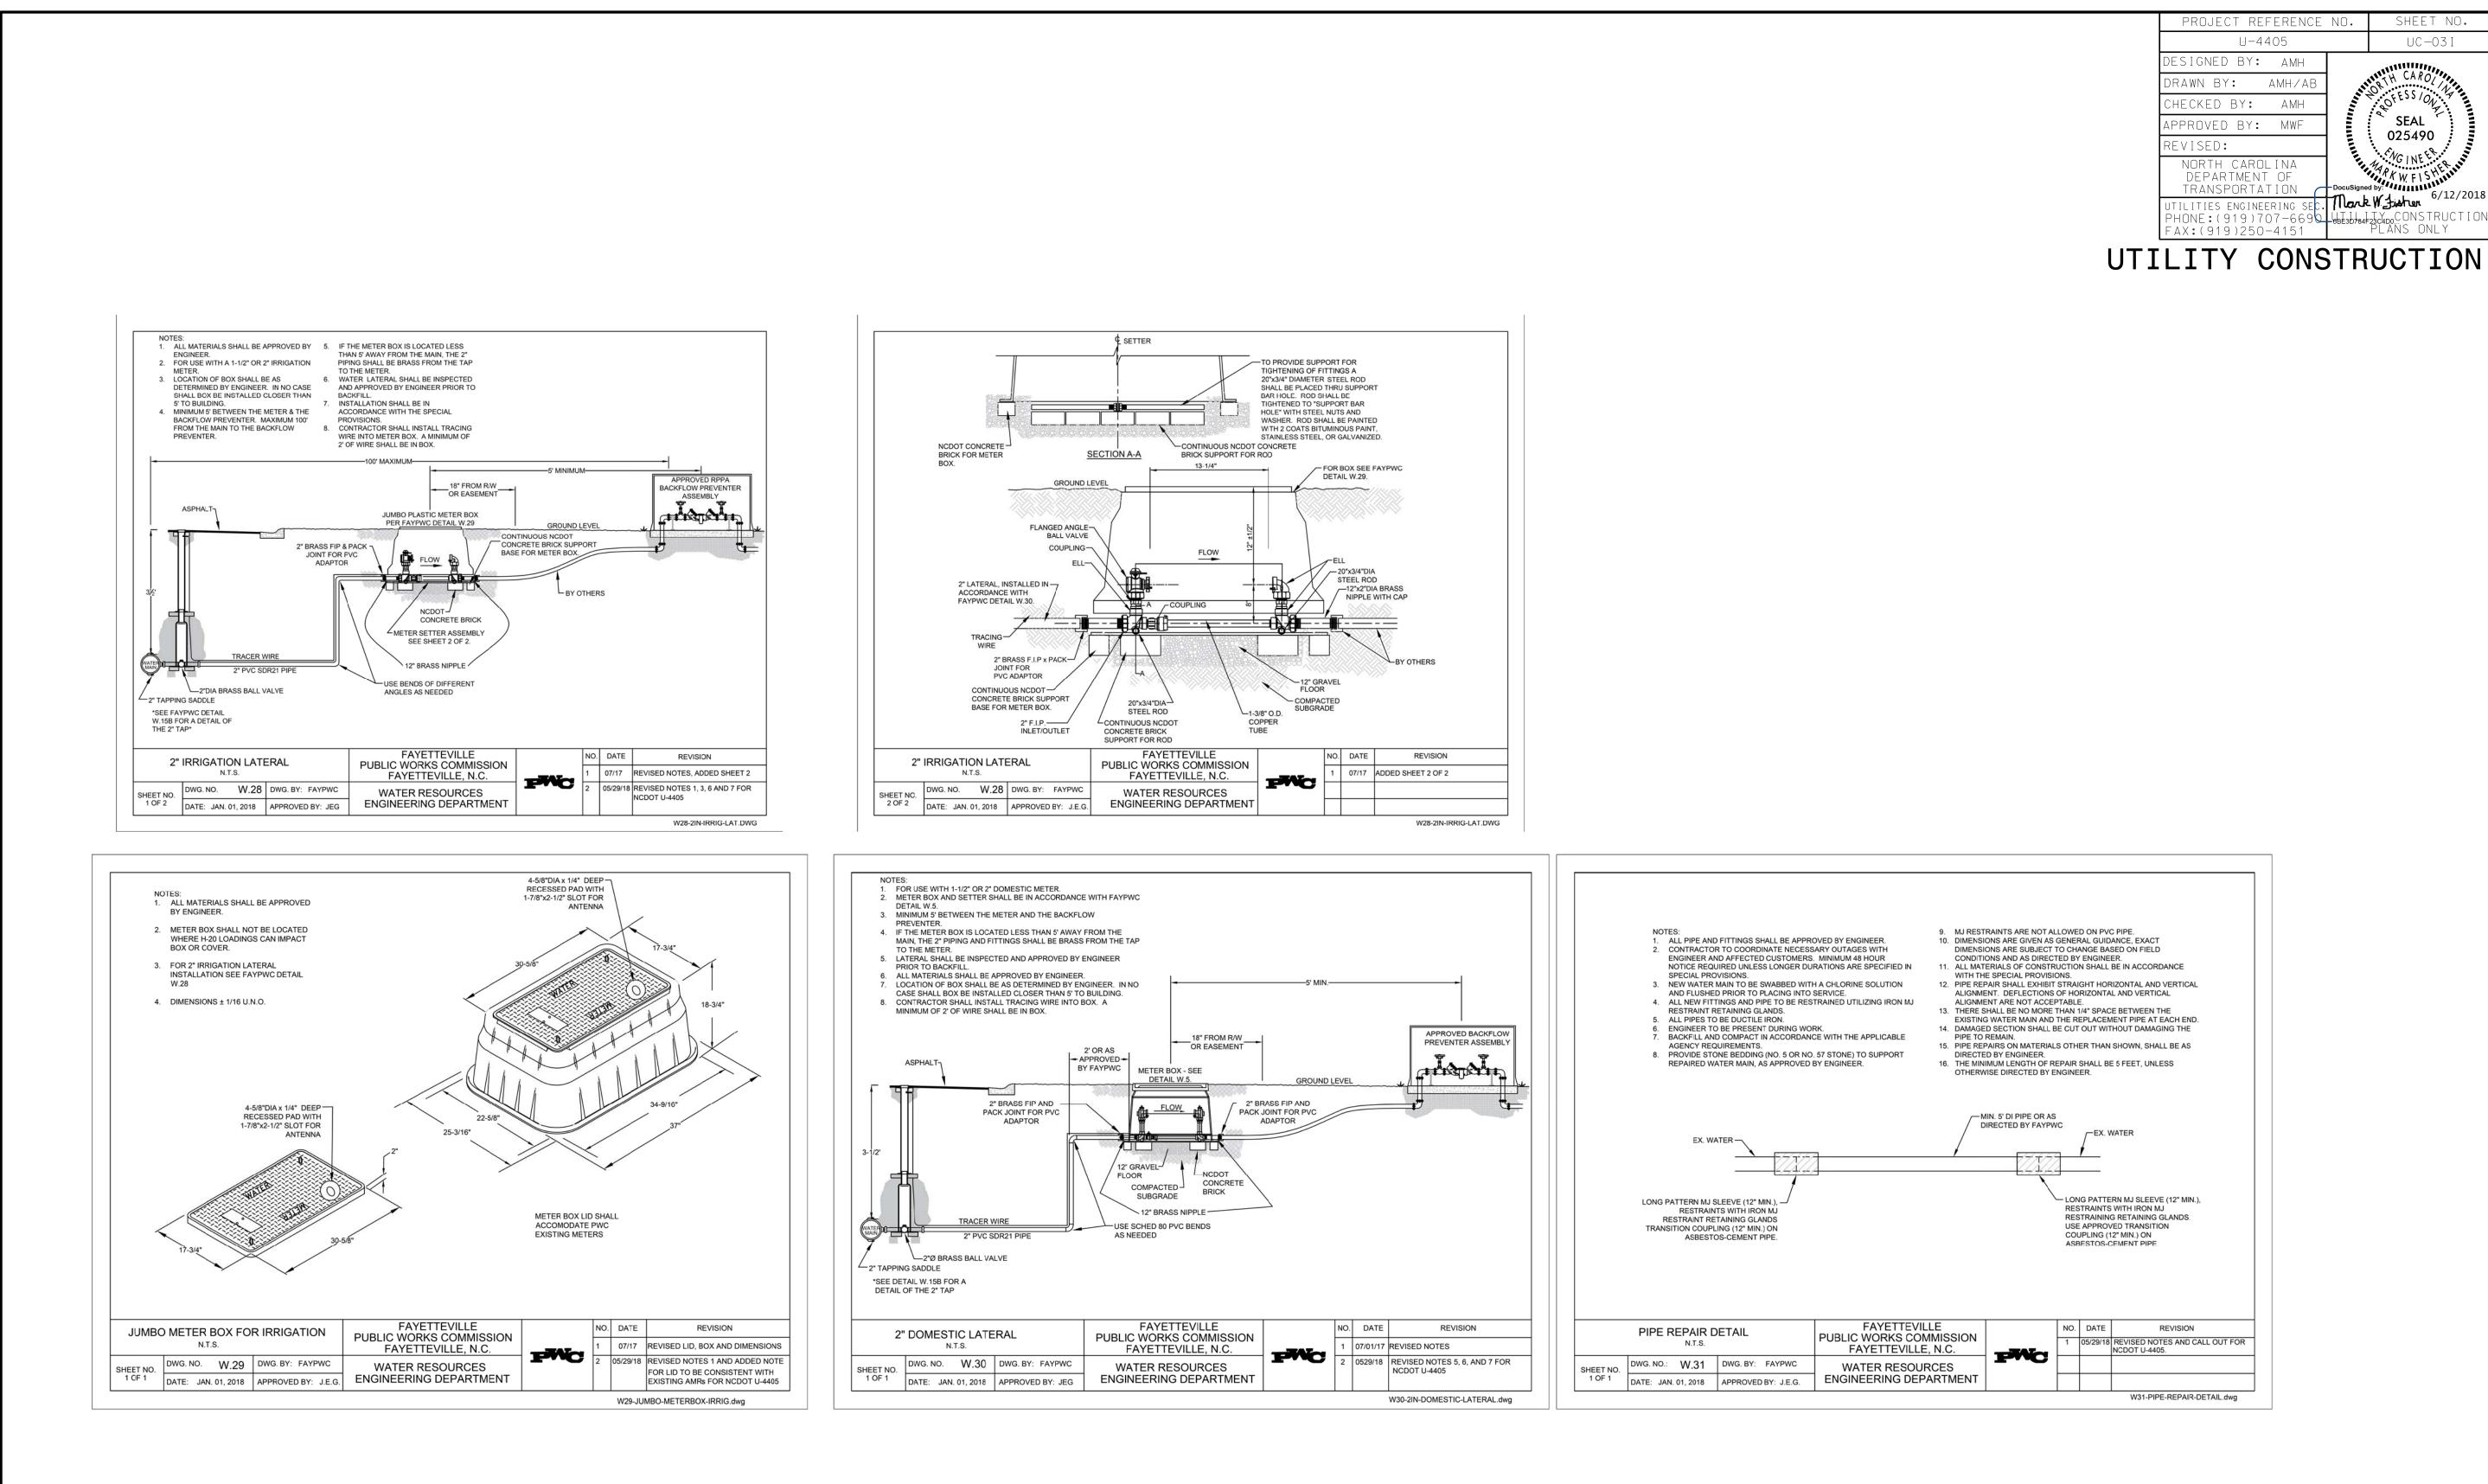
UC-03G


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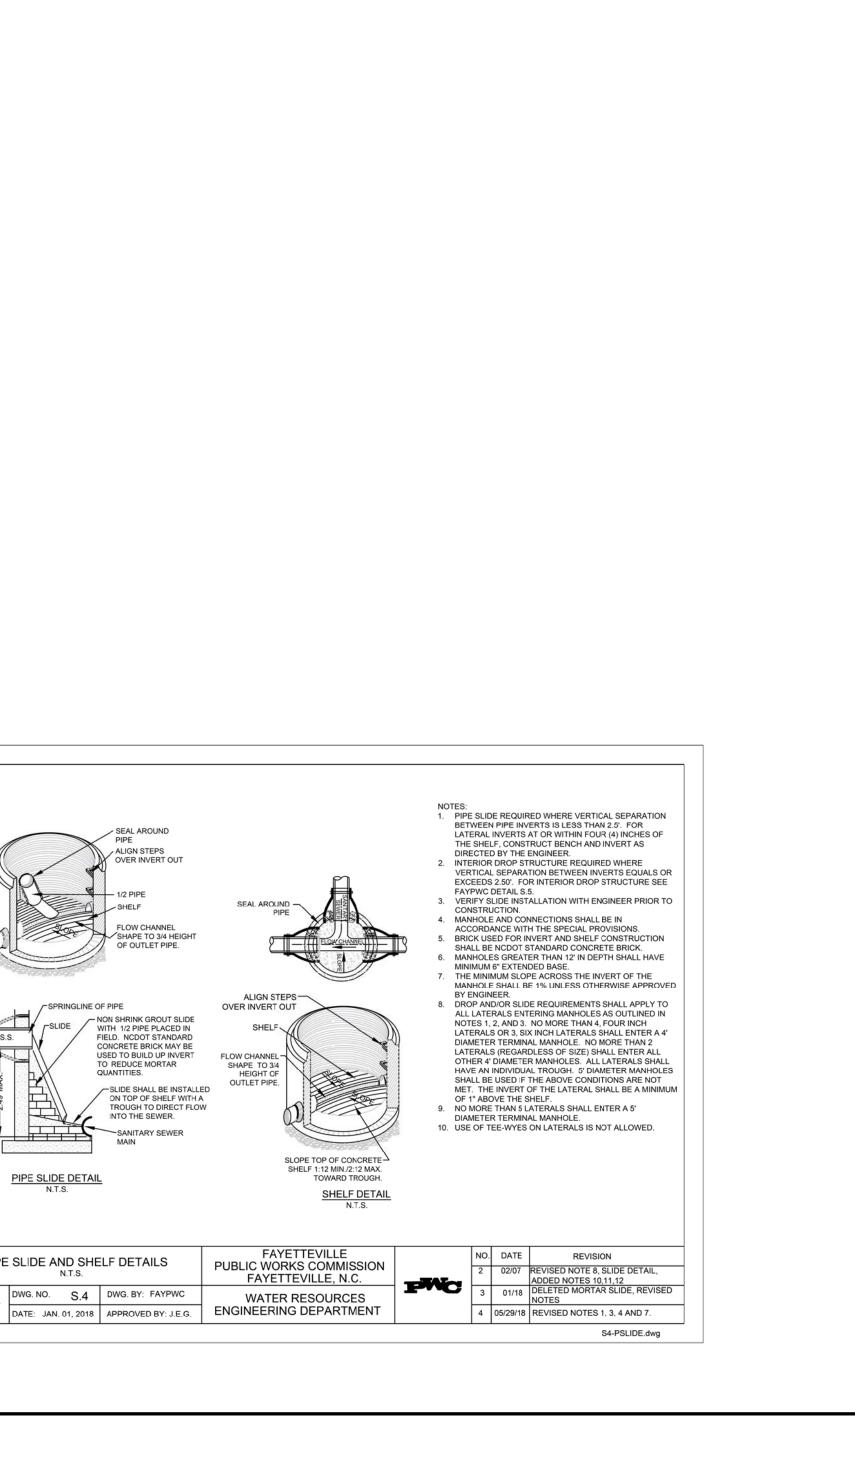
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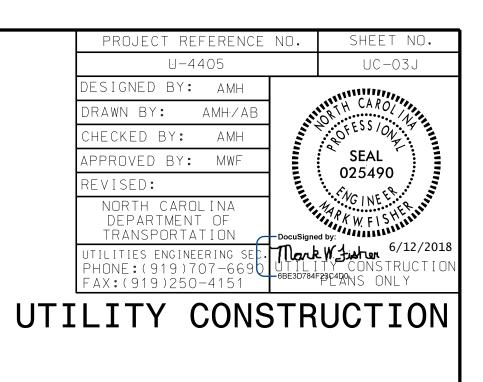



PROJECT REFERENCE NO. SHEET NO. U-4405 UC-03H ESIGNED BY: AMH RAWN BY: AMH•/AB FESS/0 HECKED BY: AMH SEAL PPROVED BY: MWF 025490 NORTH CAROLINA DEPARTMENT OF TRANSPORTATION Mark W Fisher 6/12/2012 ILITIES ENGINEERING SE 2HONE:(919)707-66 E30784F23C4D0 PLANS ONLY FAX: (919)250-4151 UTILITY CONSTRUCTION






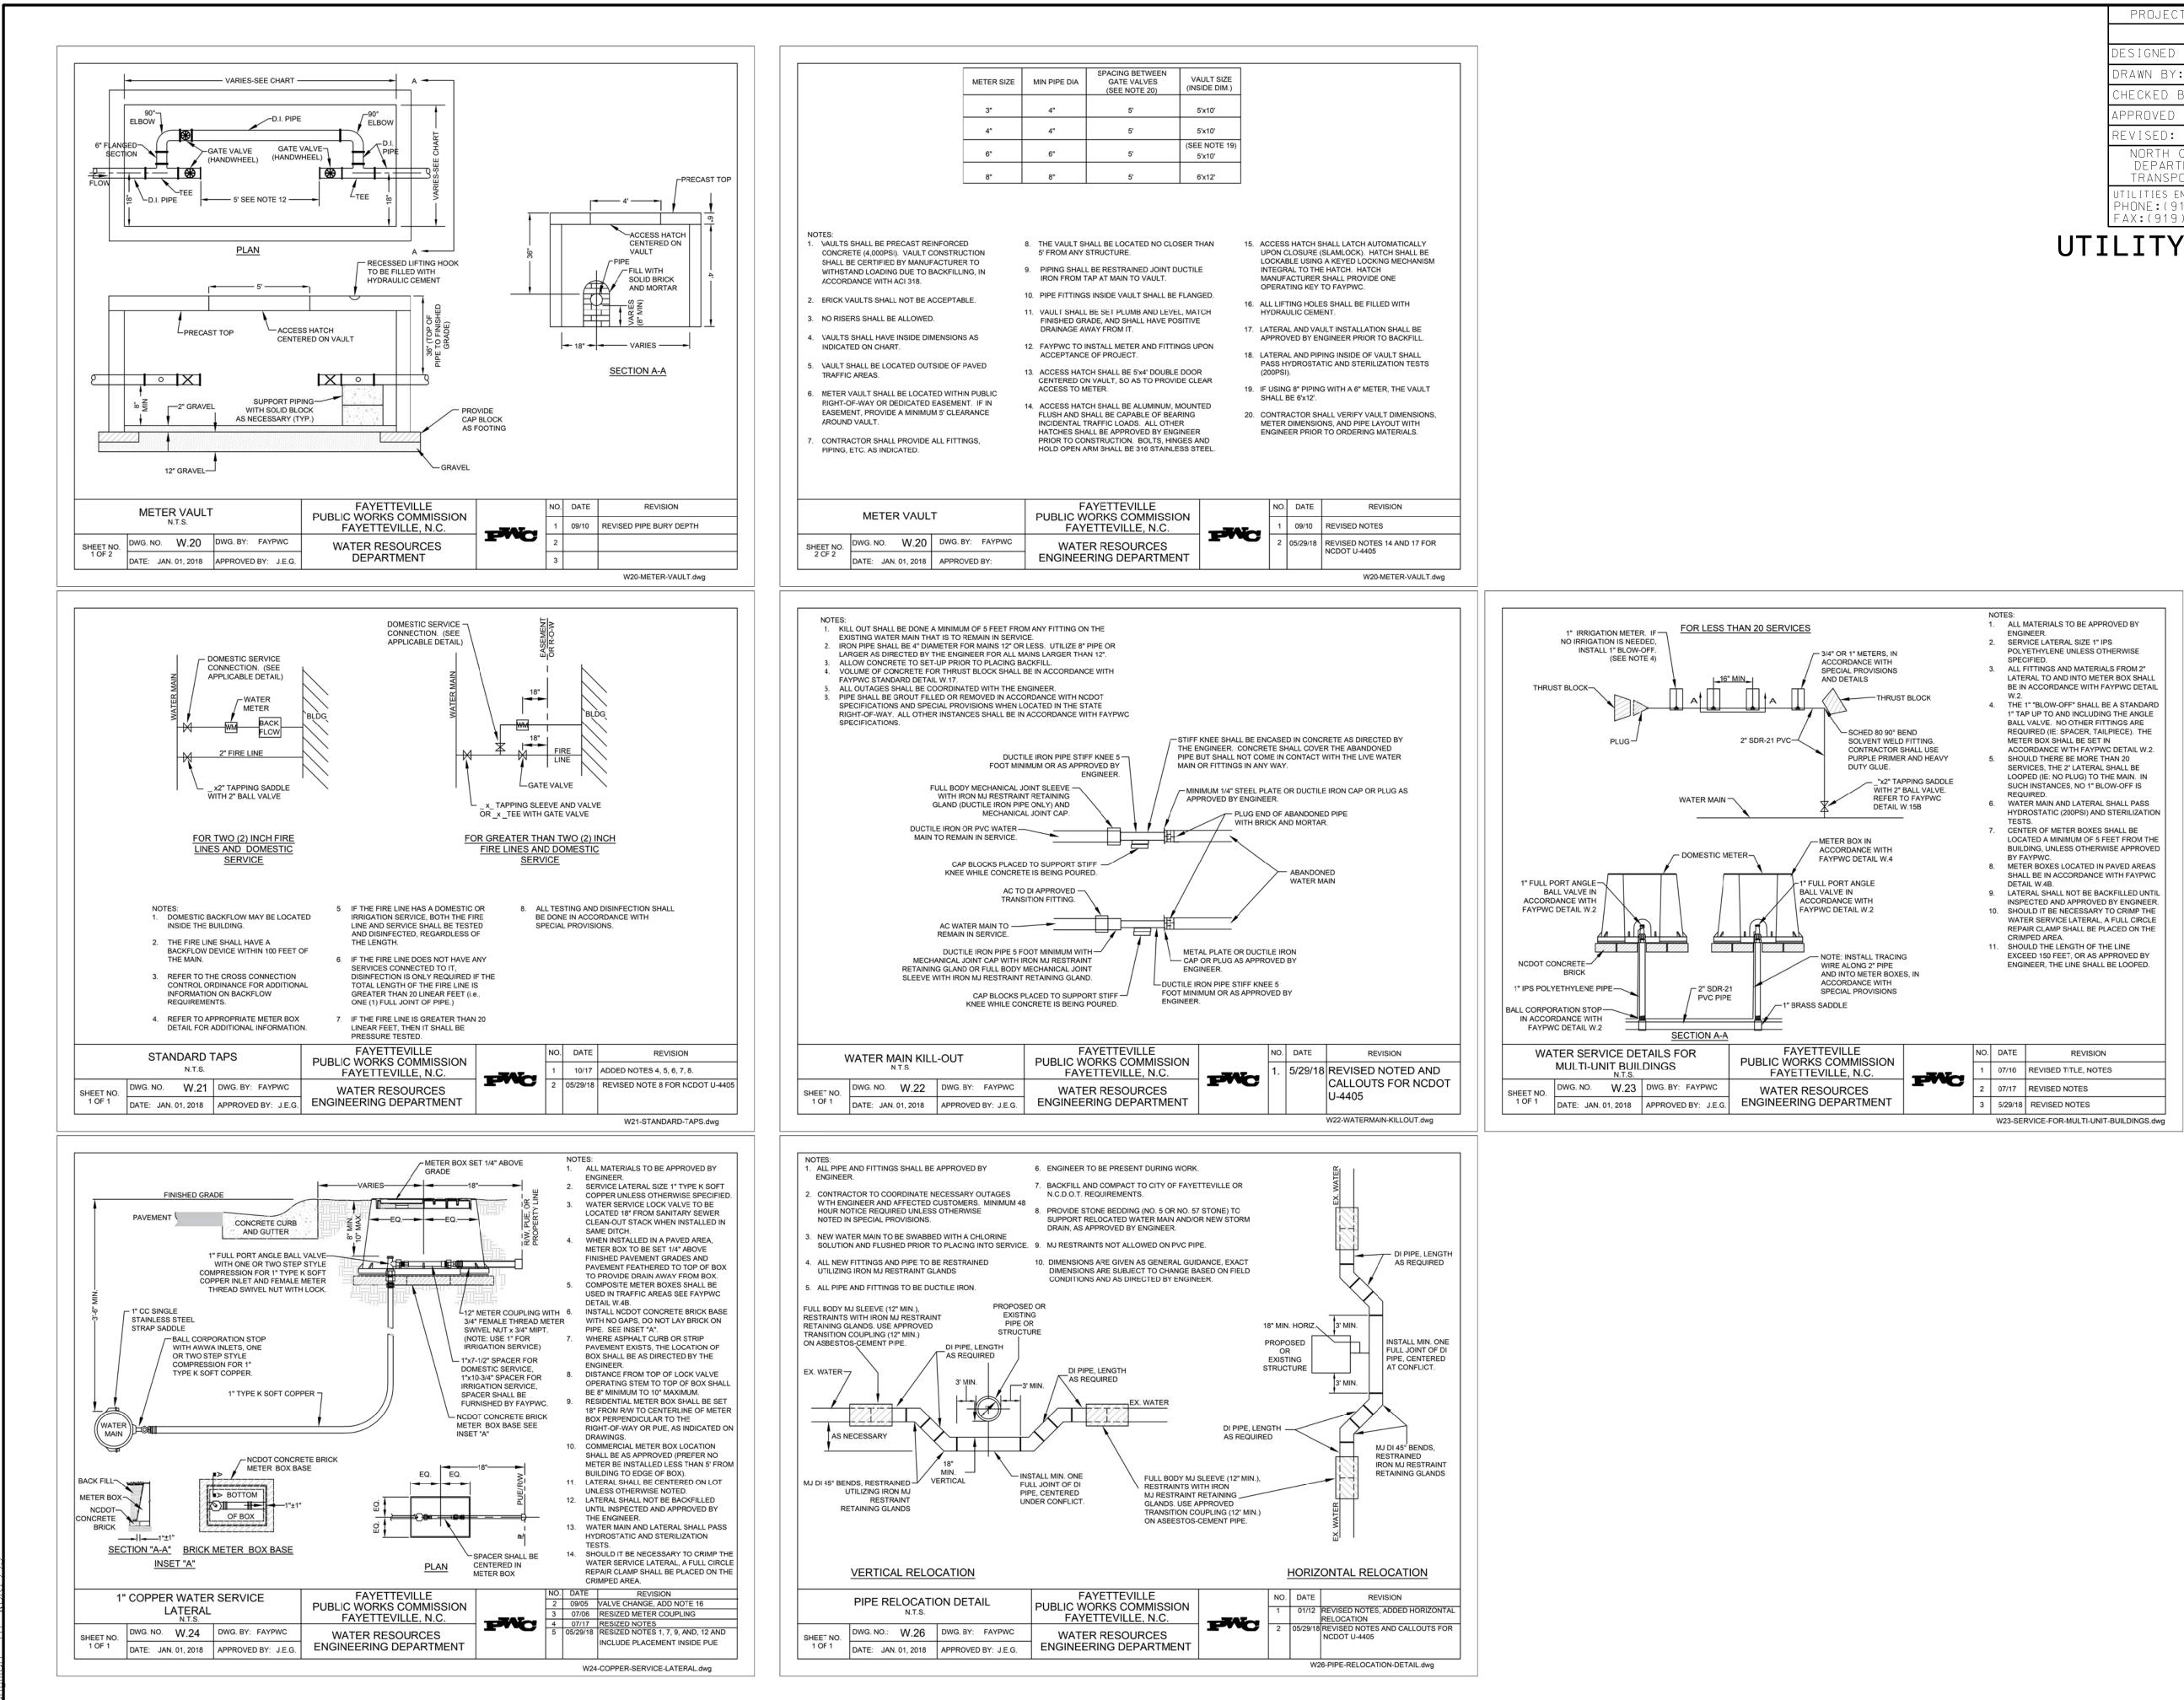

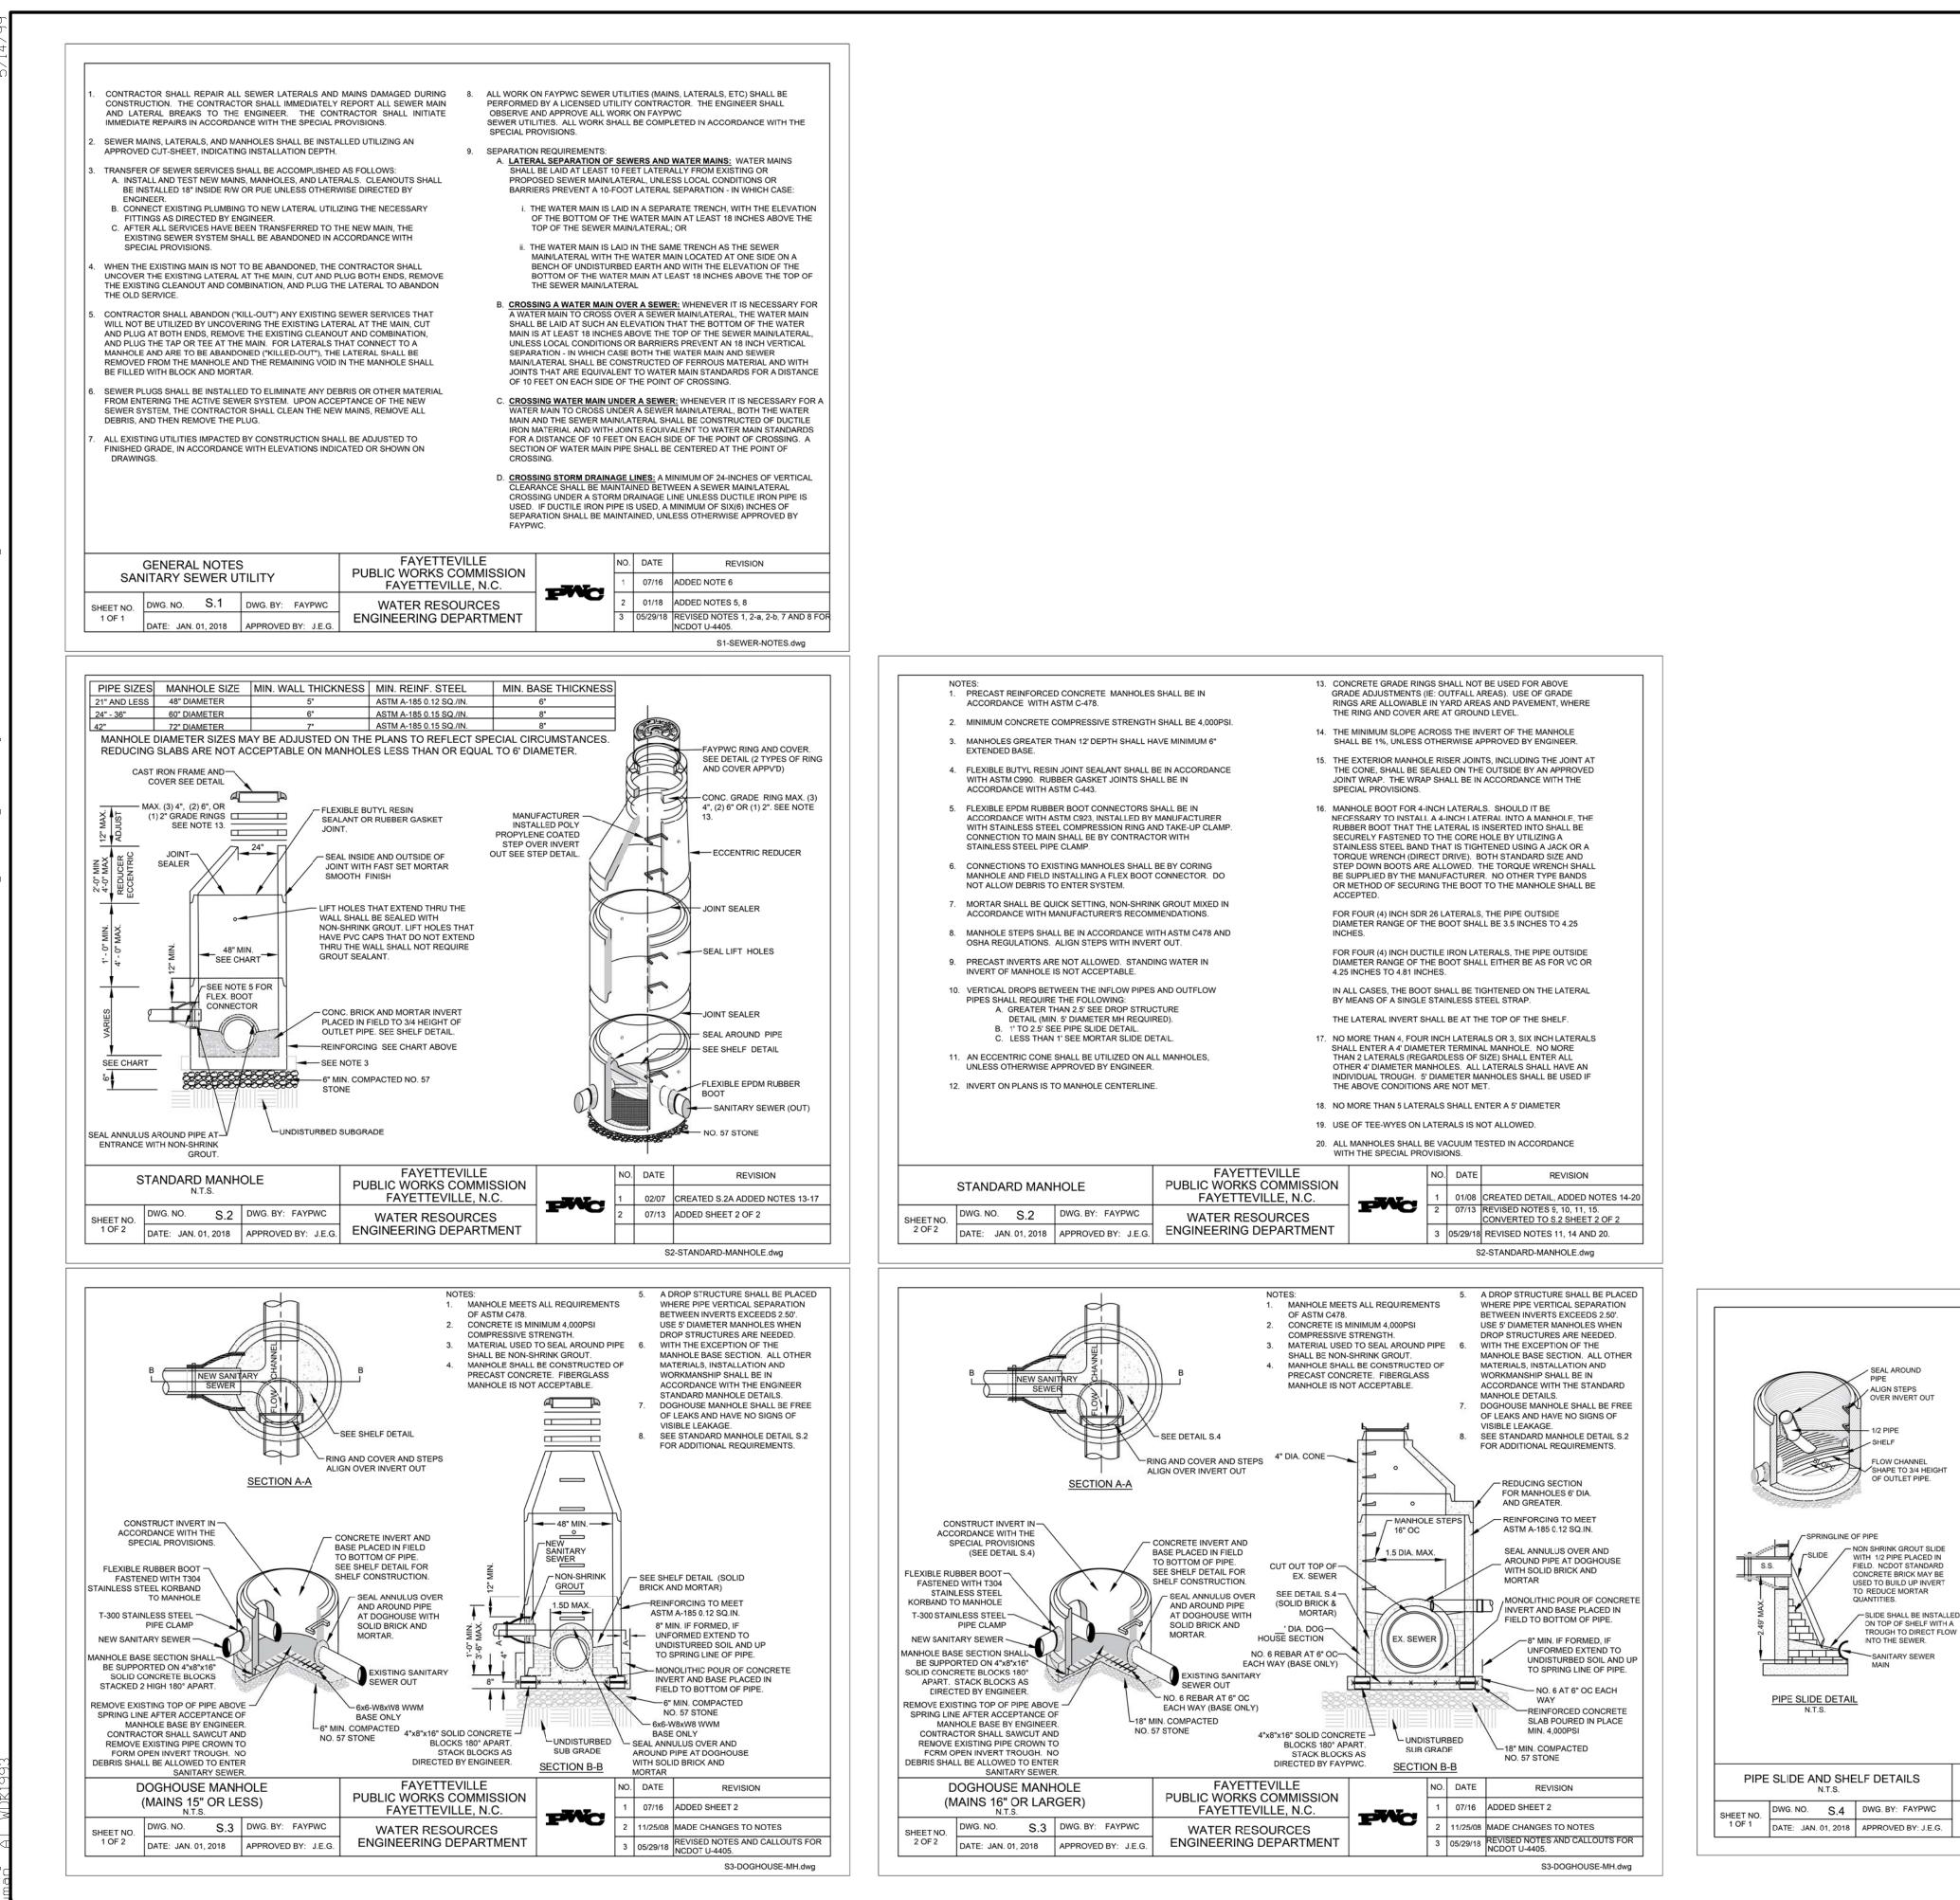

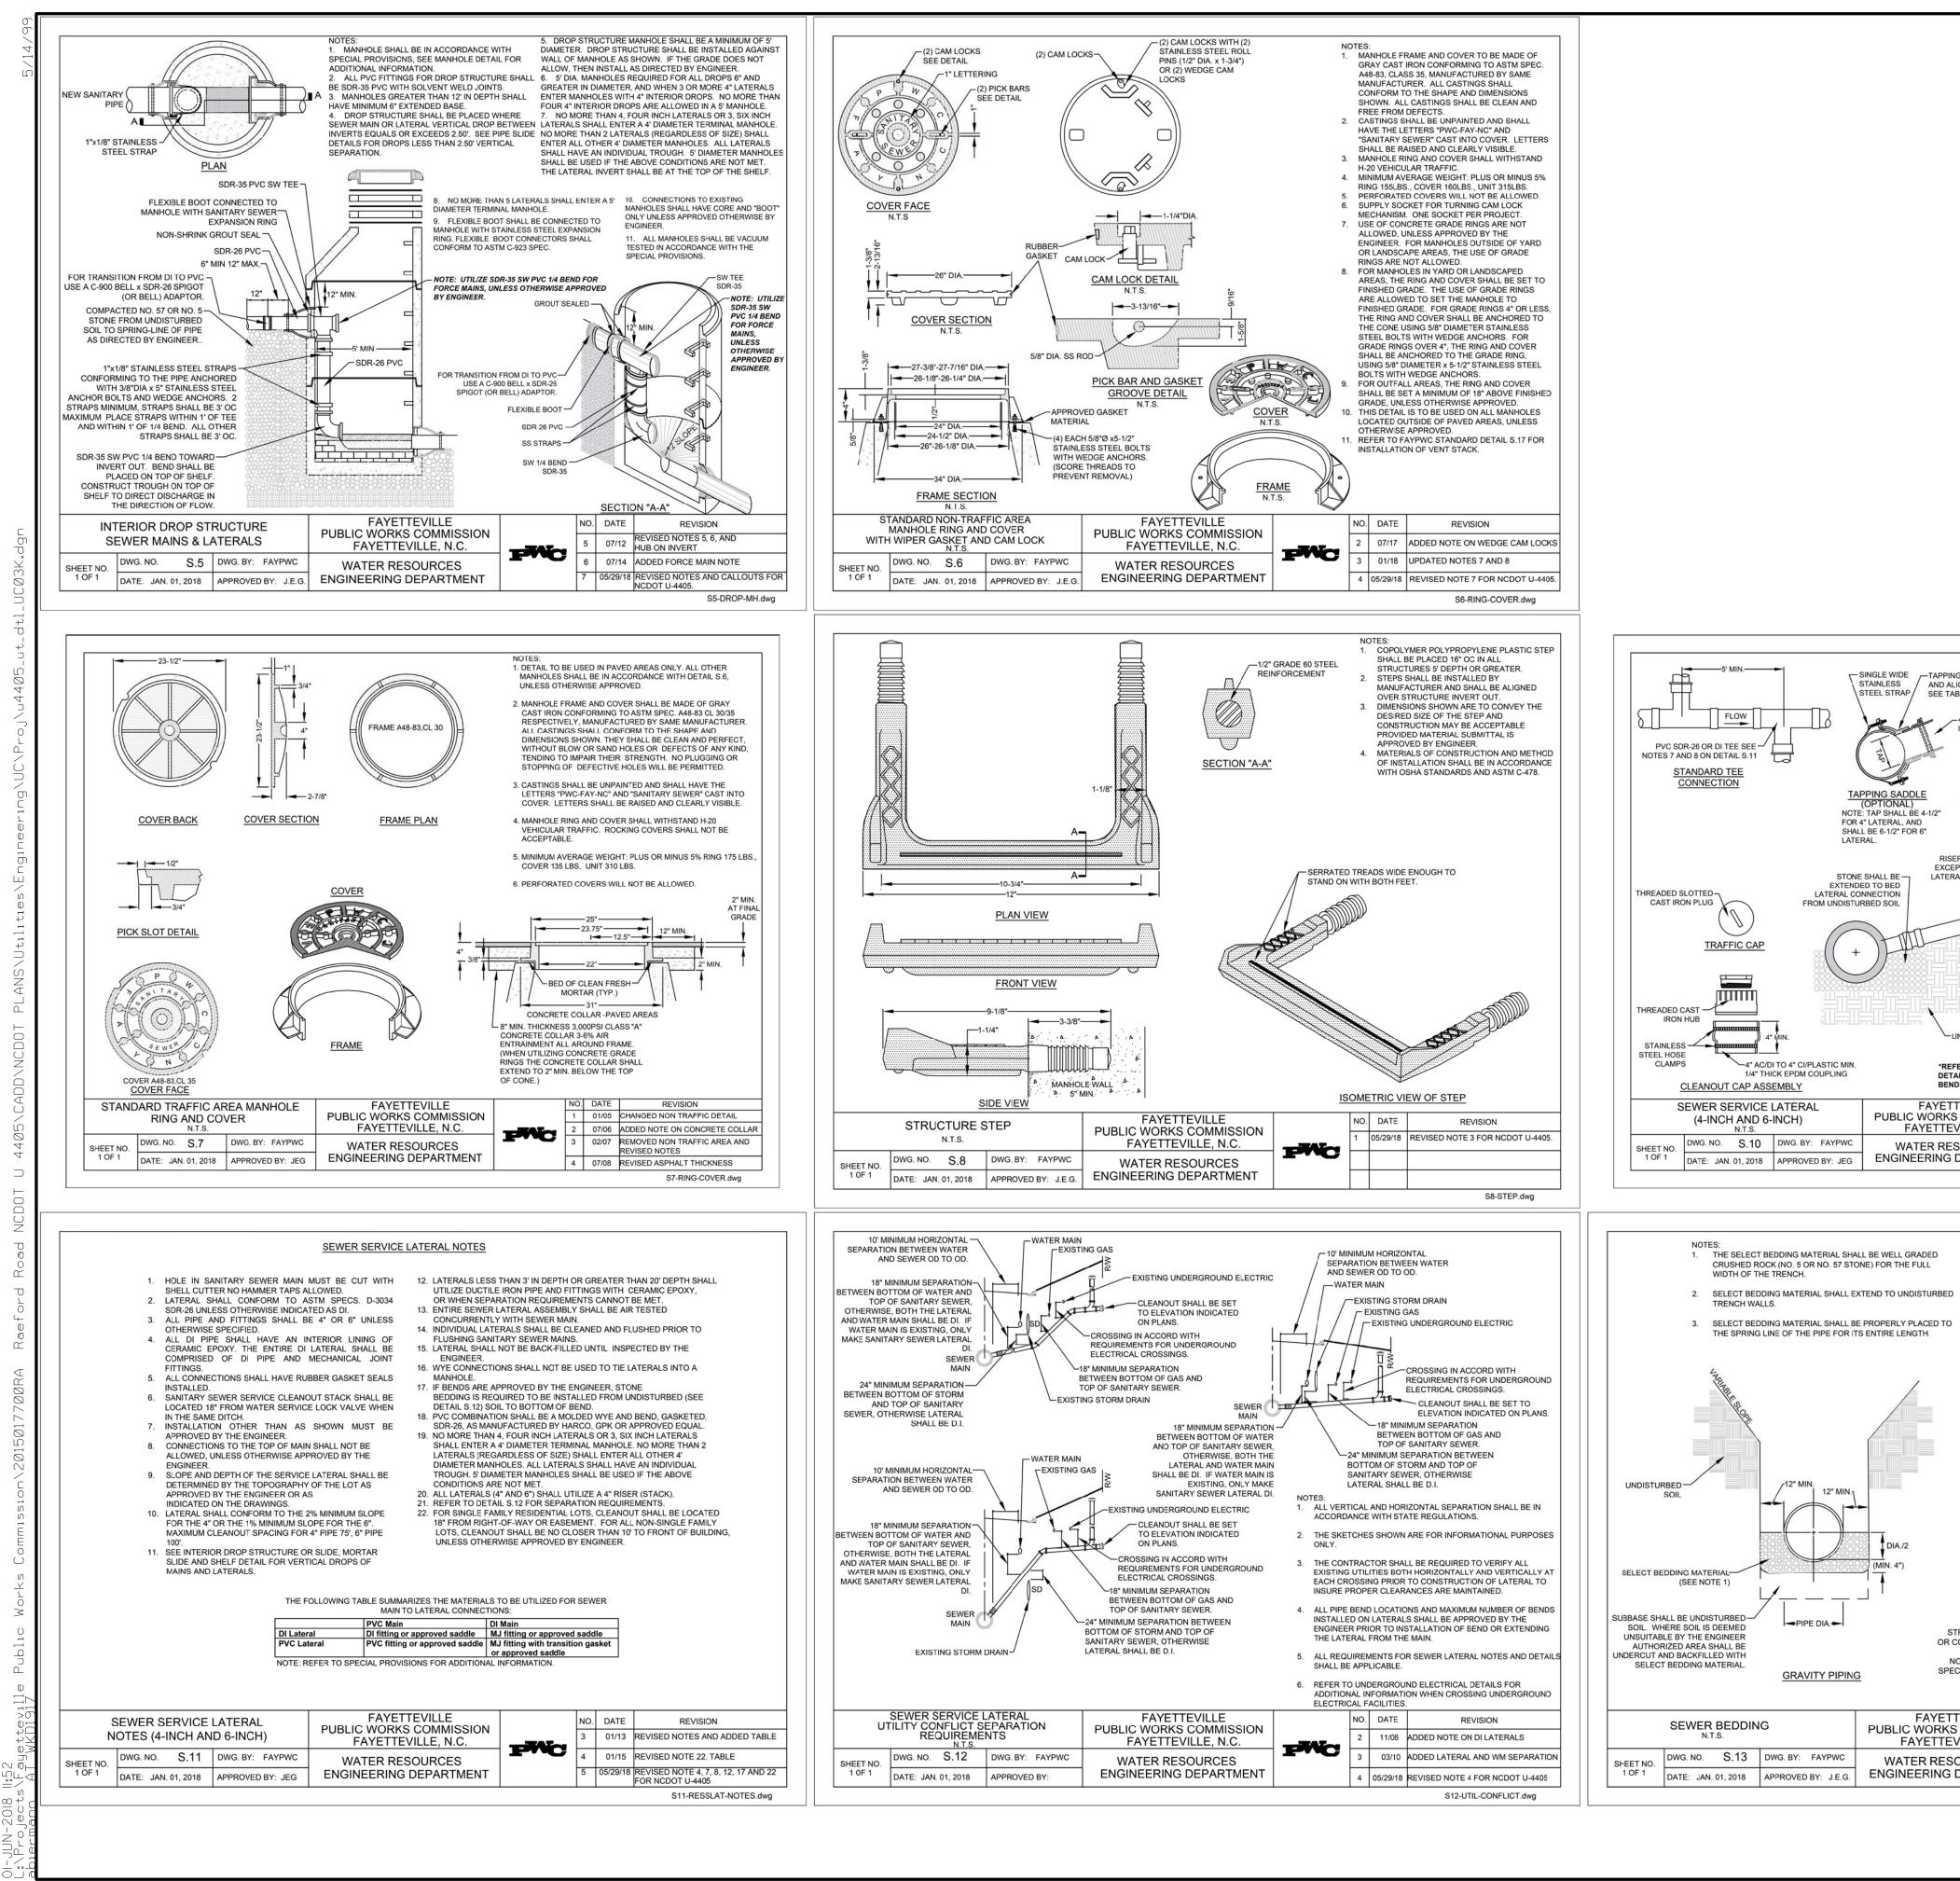

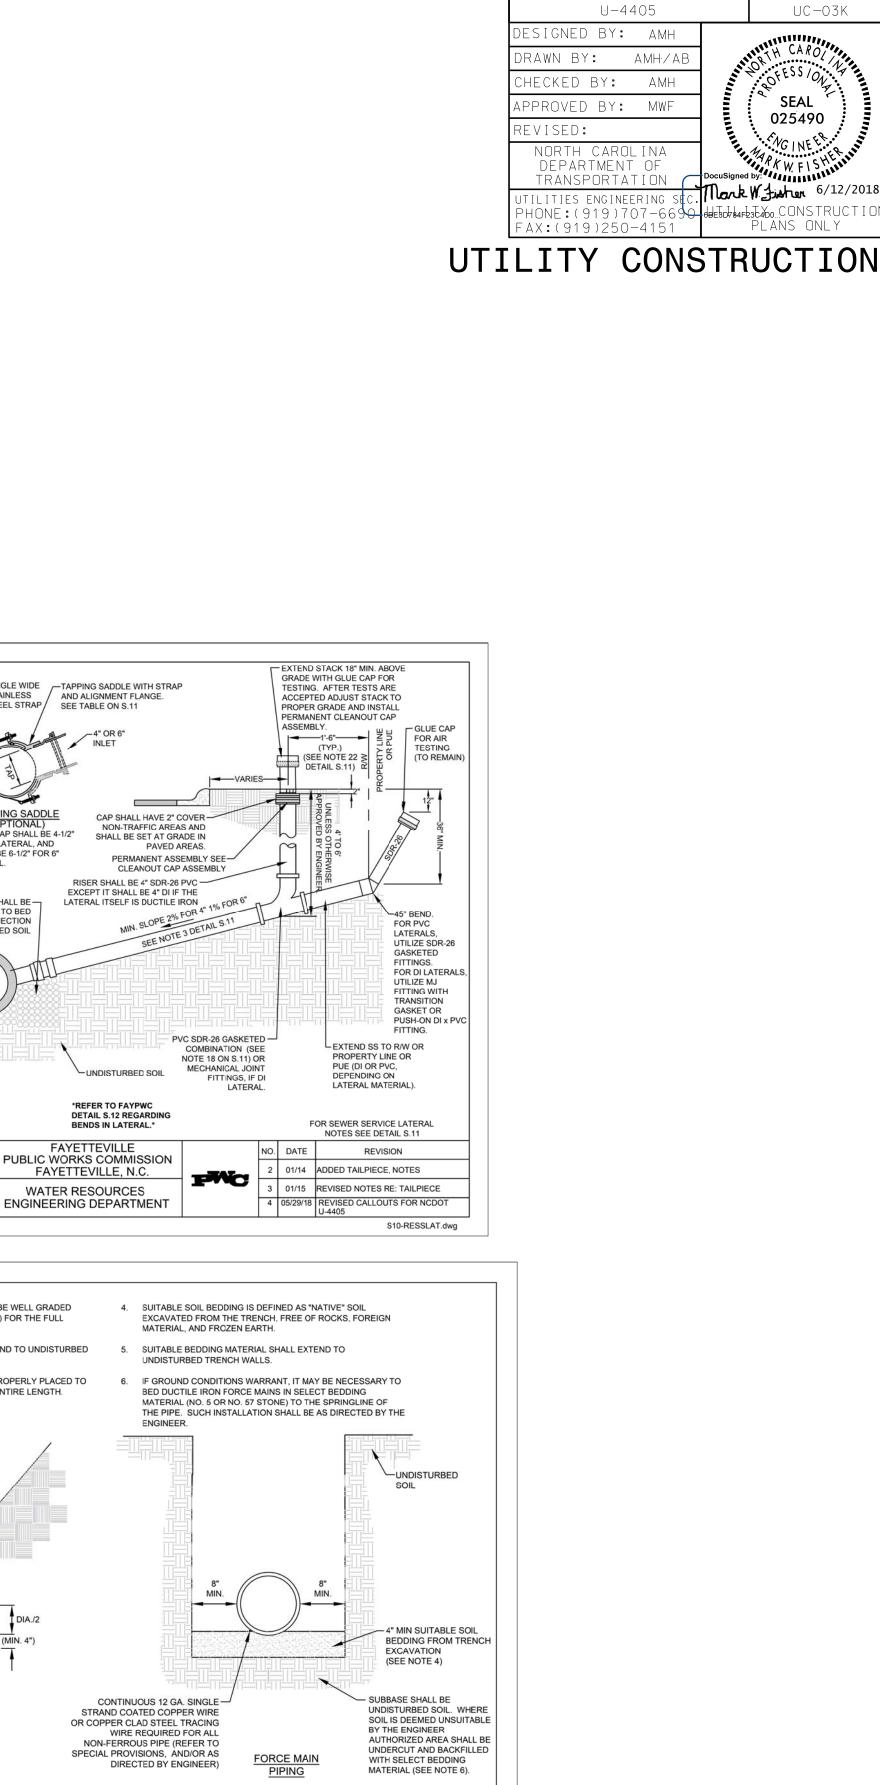


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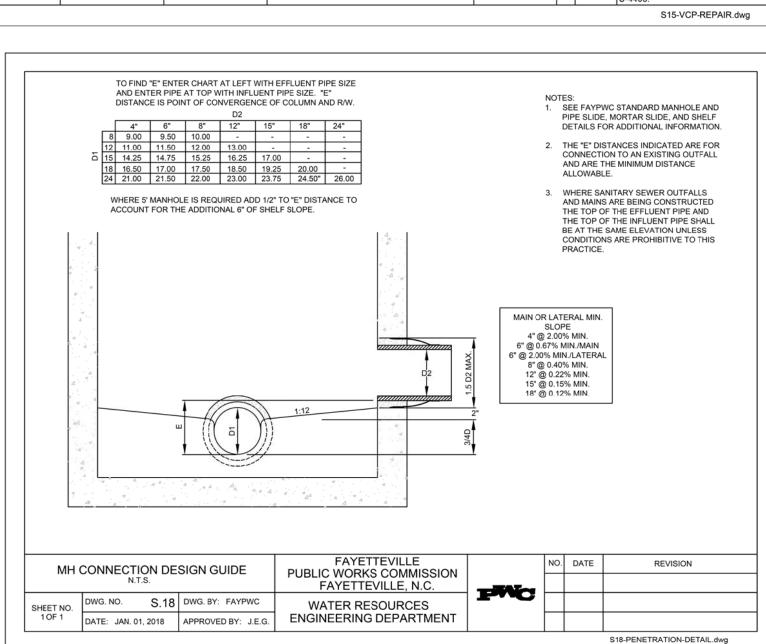
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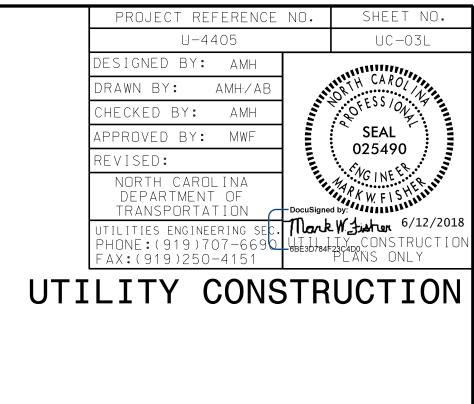



S13-SEWER-BEDDING.dwg






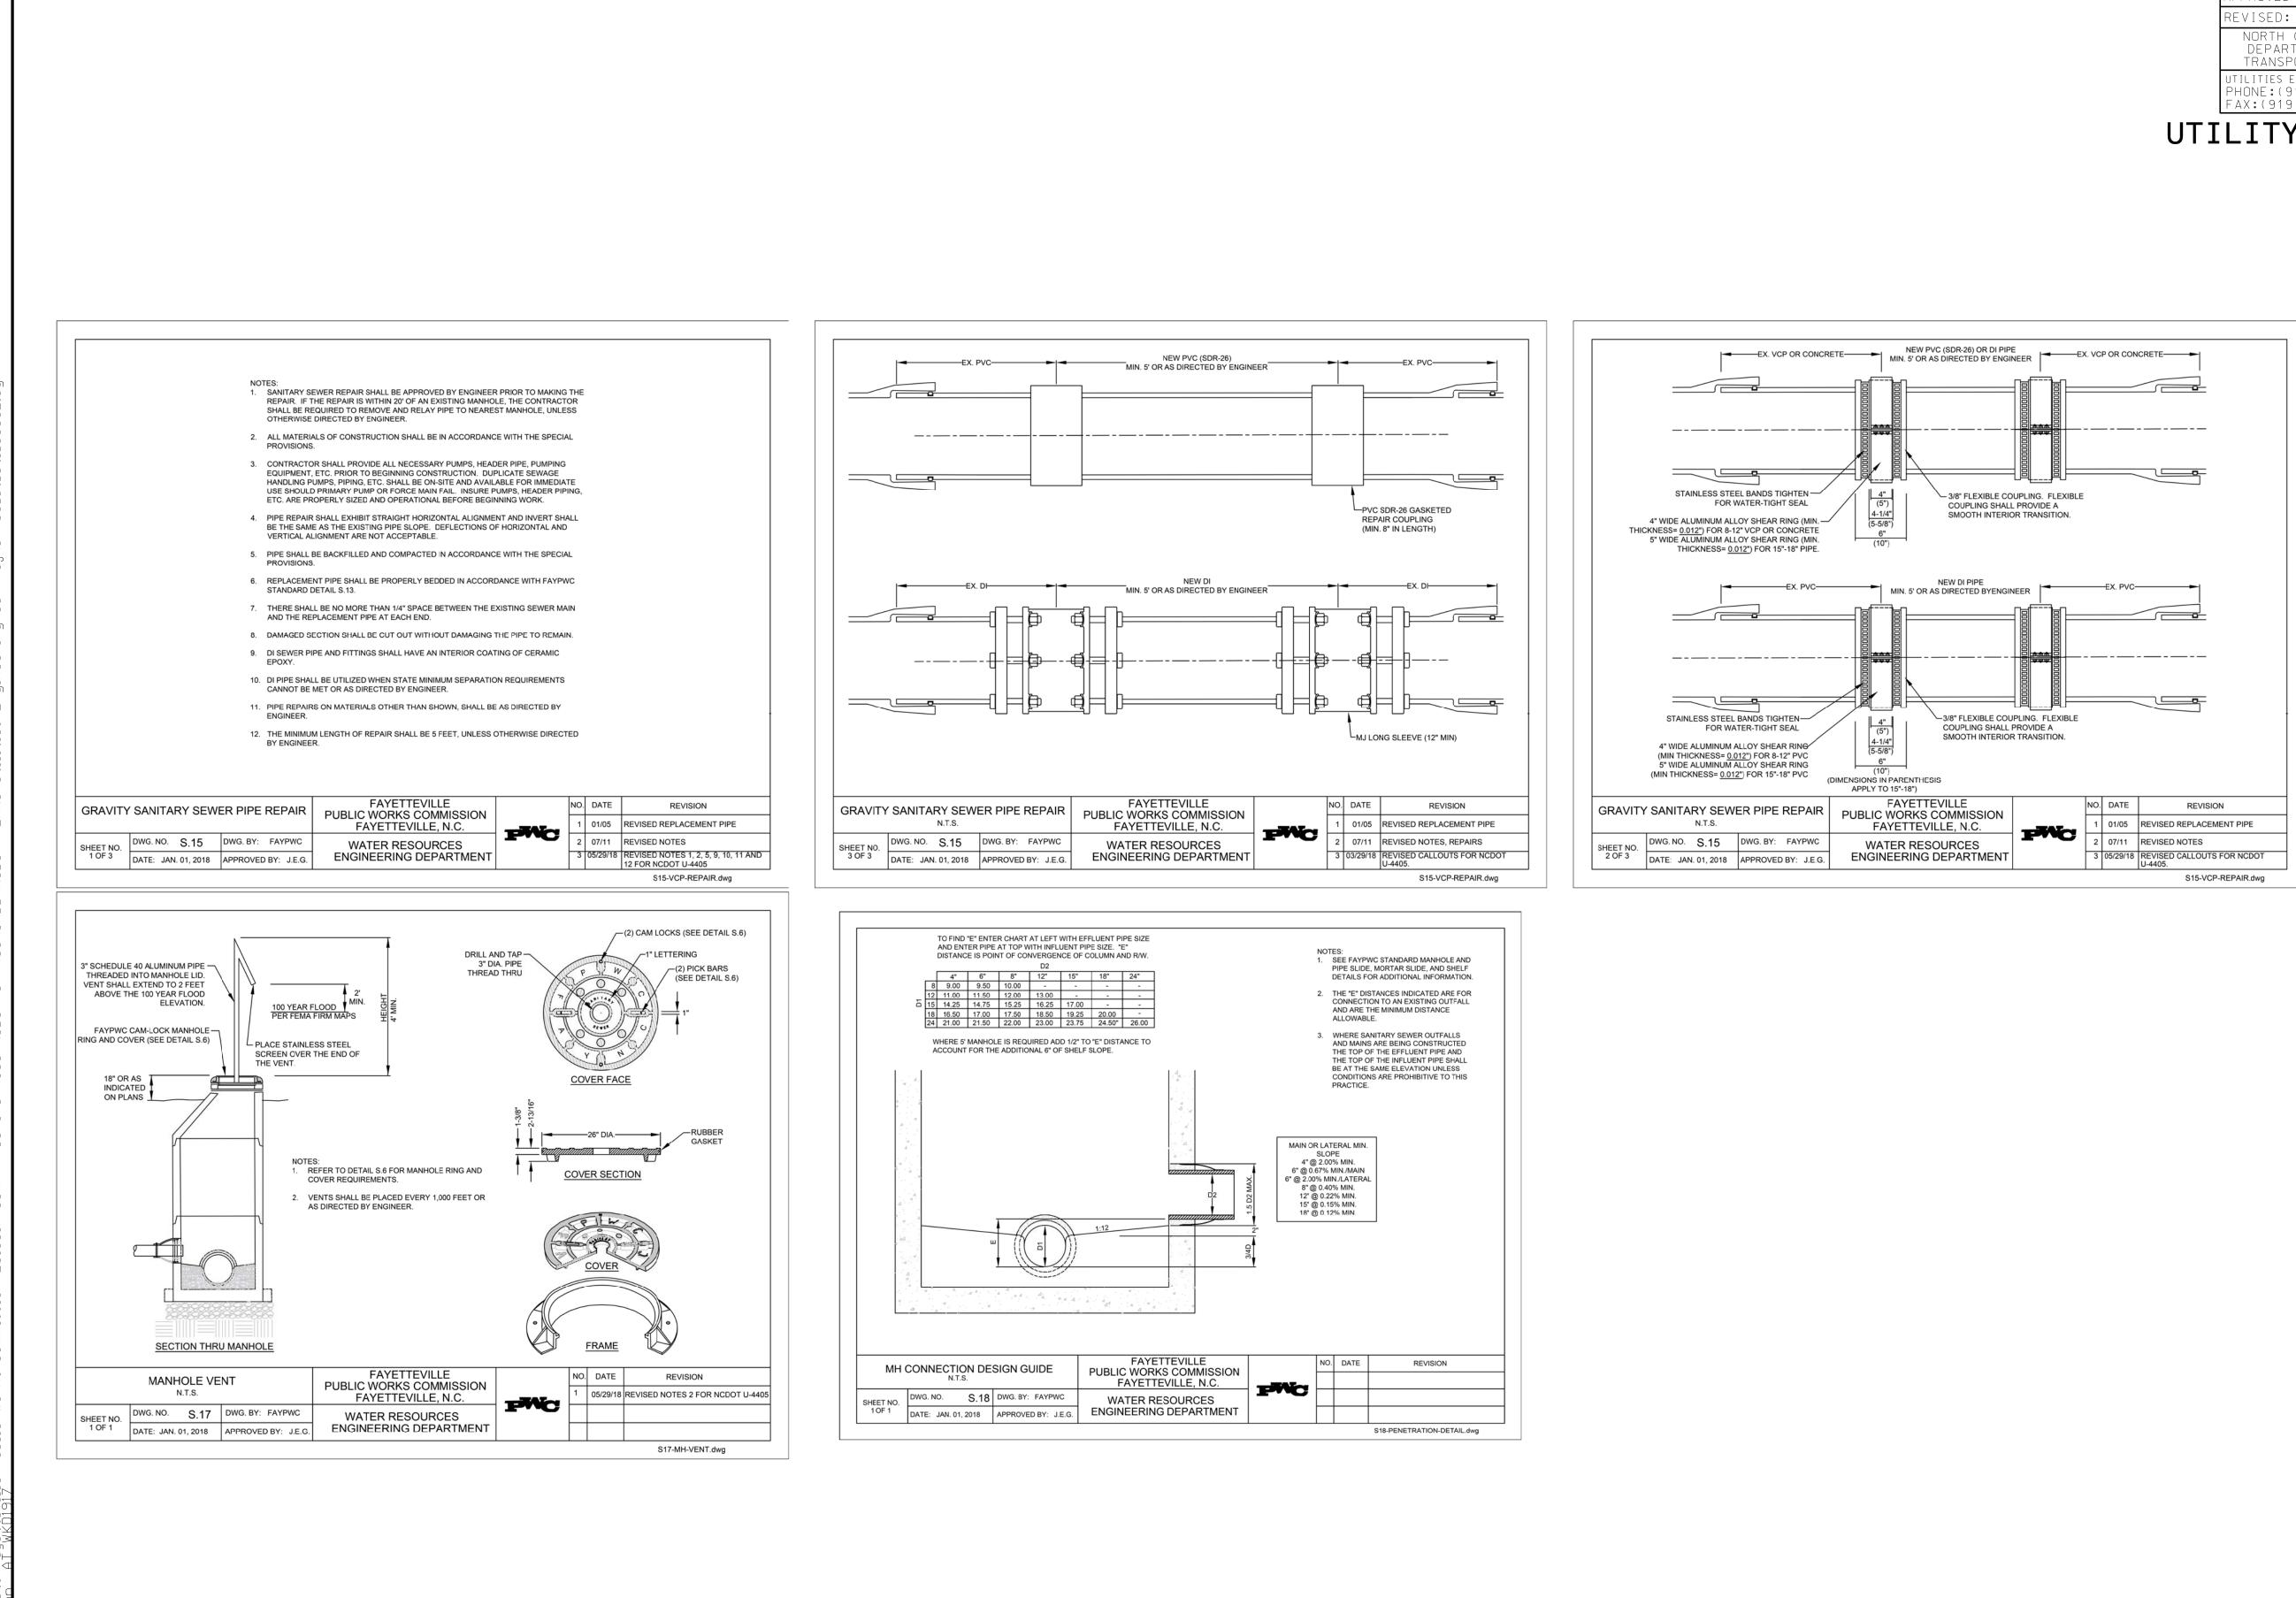




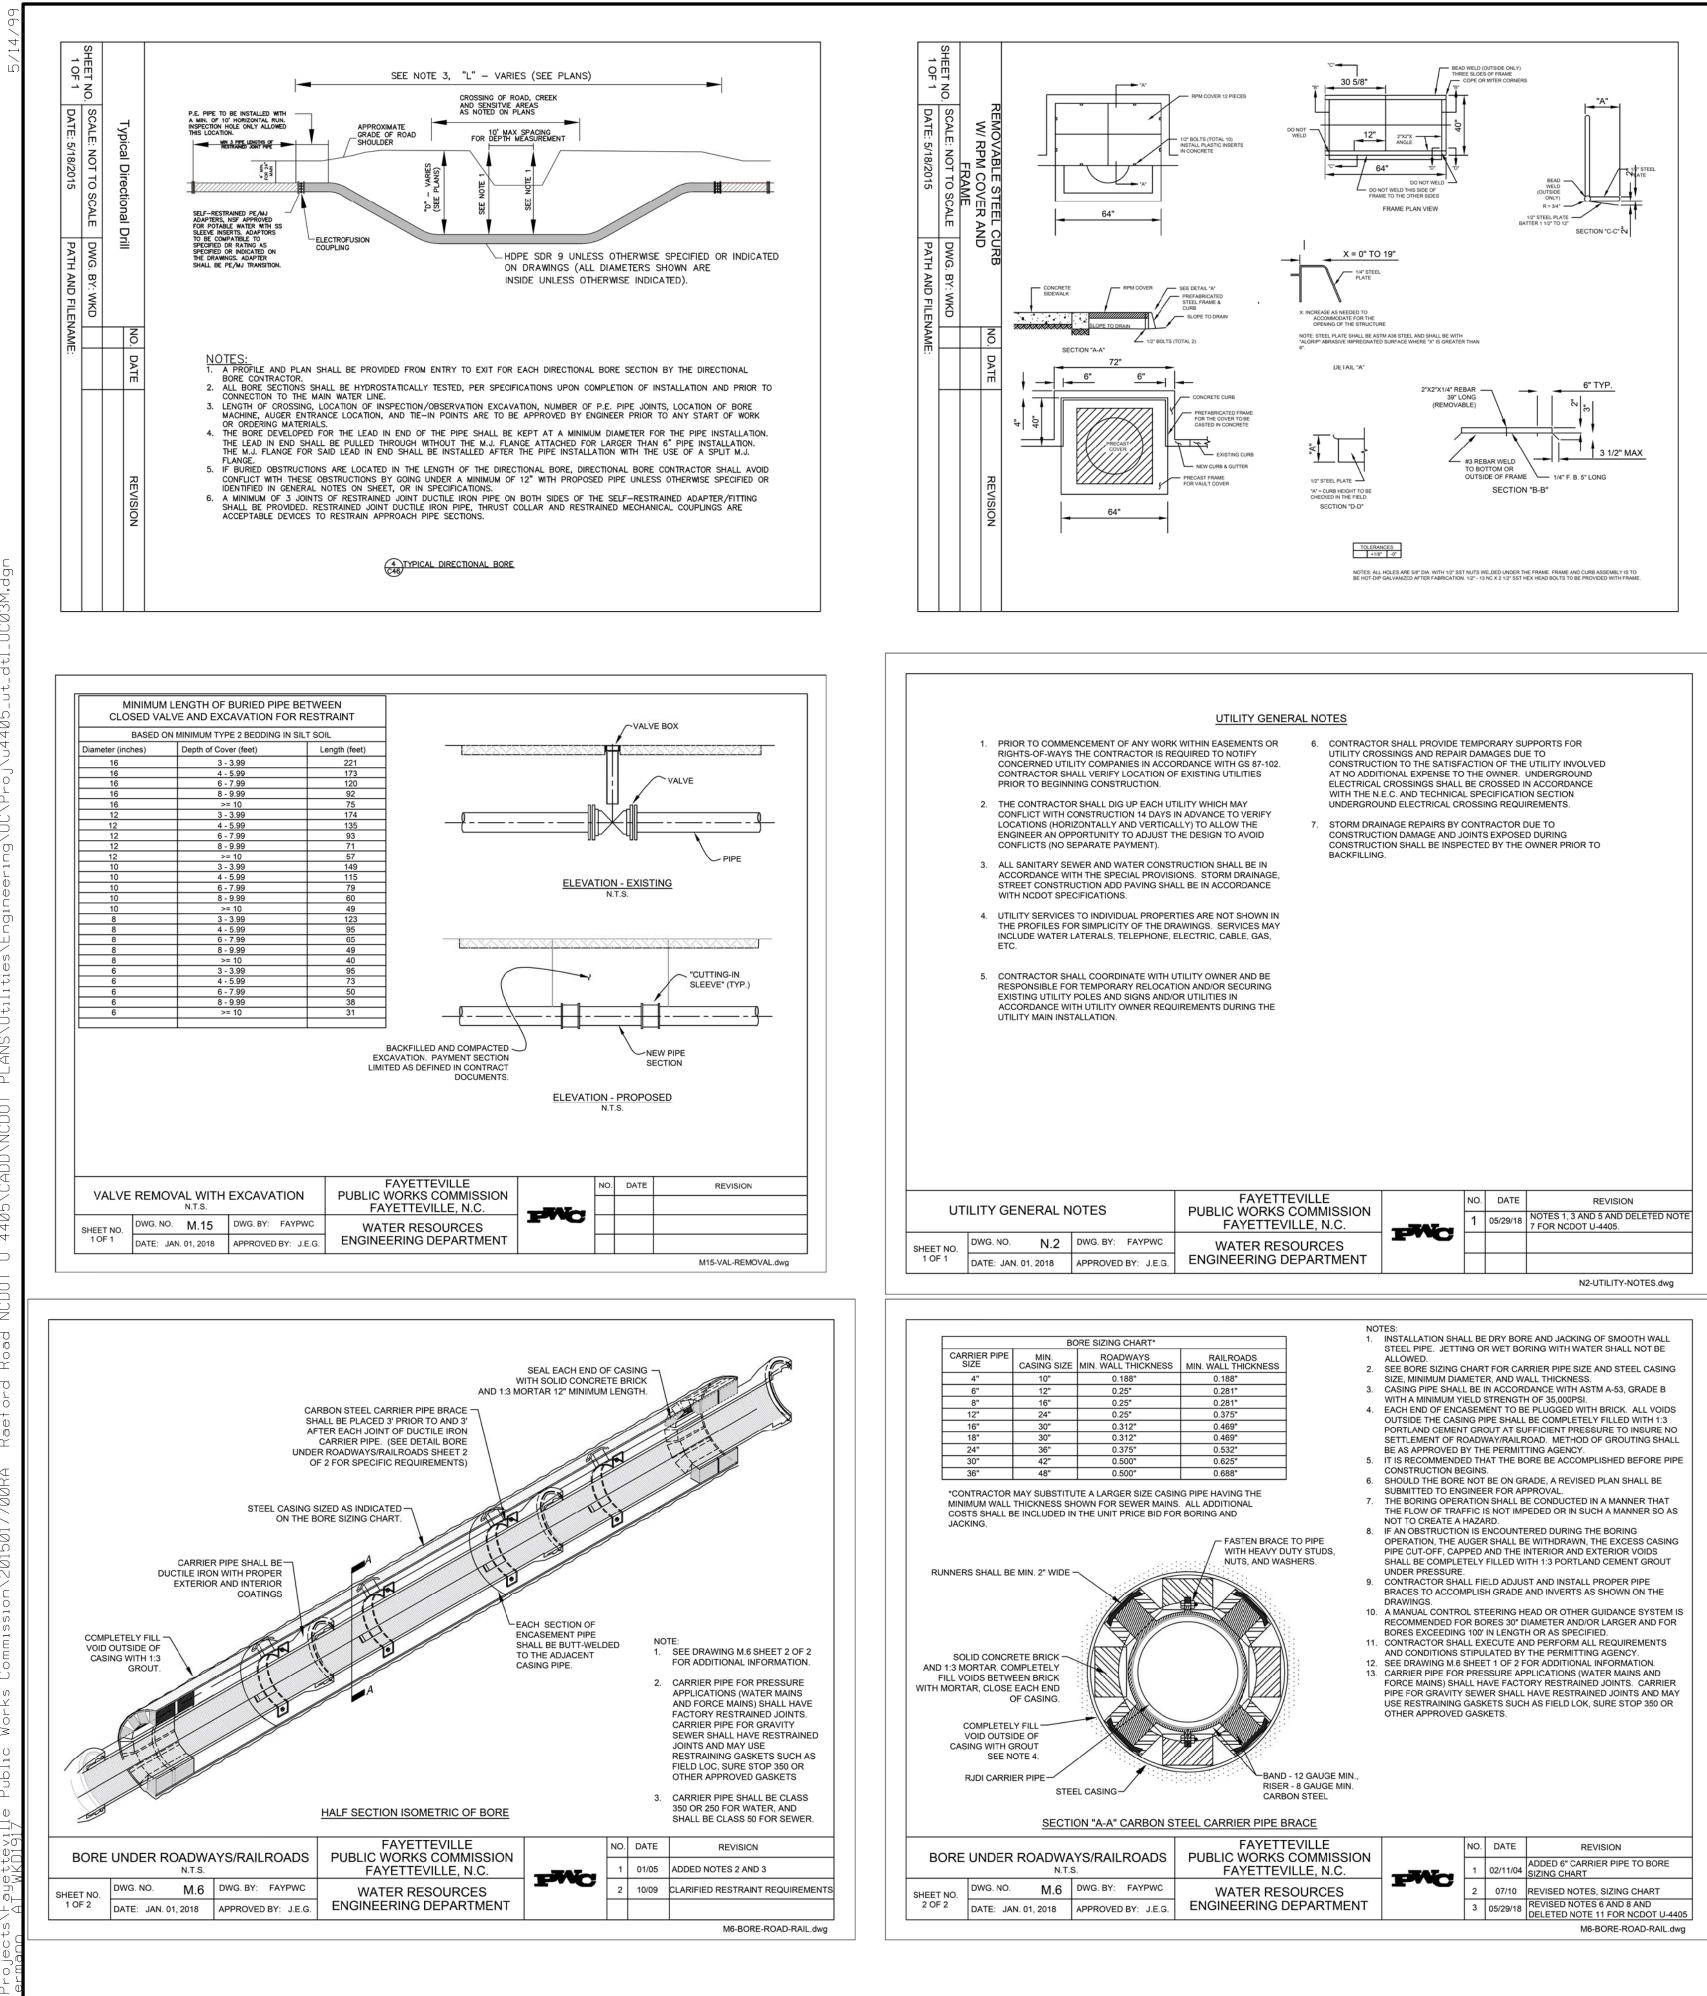

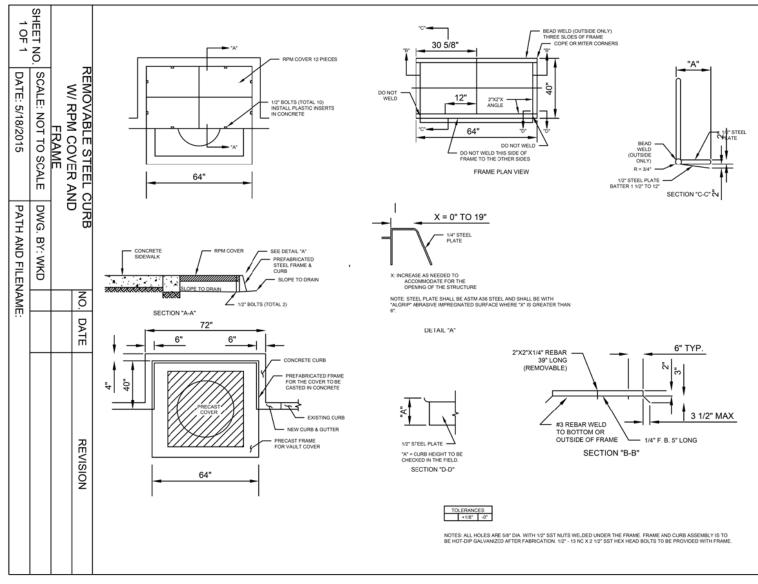

BORE UNDER ROADWAYS/RAILROADS			FAYETTEVILLE PUBLIC WORKS COMMISSION		NO.	DATE	REVISION		
					1	02/11/04	ADDED 6" CARRIER PIPE TO BORE SIZING CHART		Sł
SHEET NO.	DWG. NO. M.C	DWG. BY: FAYPWC	WATER RESOURCES		2		REVISED NOTES, SIZING CHART		
2052	DATE: JAN. 01, 2018	APPROVED BY: J.E.G.	ENGINEERING DEPARTMENT	3		REVISED NOTES 6 AND 8 AND DELETED NOTE 11 FOR NCDOT U-4405	l		

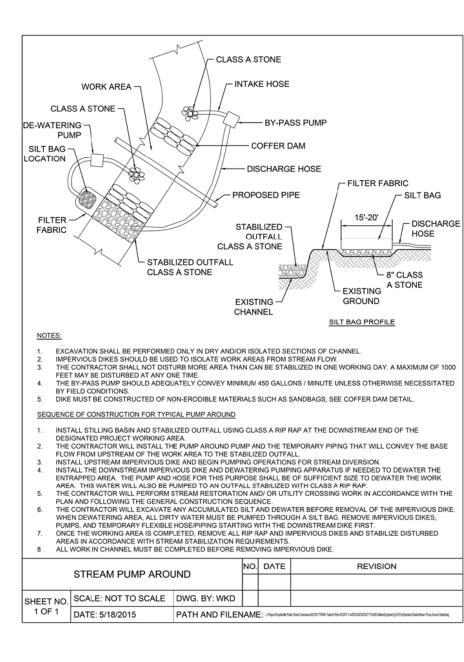



- ALL WORK AND MATERIALS TO BE IN ACCORDANCE WITH THE SPECIAL PROVISIONS.
- THIS DETAIL DEPICTS AN EXISTING BRICK MANHOLE WITH A TYPICAL
- CHIMNEY SECTION.
- CONTRACTOR TO MEASURE THE NSIDE DIAMETER OF EXISTING

SOLID OR WATERTIG

EXISTING GRADE

MANHOLE, SEE NOTES 3&4

FILL INSIDE JOINT

GROUT, SEE NOTE

EXISTING MANHOLE STEPS WHERE -APPLICABLE

WALL, SEE NOTE 2

RAME AND COVER, AS -DIRECTED ON PLANS

- MANHOLE TO SELECT APPROPRIATE DIAMETER OF NEW RISERS. CONTRACTOR TO REMOVE EXISTING WALLS TO SOLID STRUCTURE (TO AT LEAST BELOW THE CONE OR CHIMNEY SECTION) OR TO THEIR SPECIFIED LOCATION THE LIMITS OF REMOVAL SHALL BE APPROVED BY THE ENGINEER IN THE FIELD. CONTRACTOR TO ALSO REMOVE
- EXISTING FRAMES AND COVER VENT PIPES AND ALL APPURTENANCES, ETC CONTRACTOR TO DISPOSE OF ALL MATERIALS OFF-SITE. CONTRACTOR TO INSTALL NEW RISER AND CONE SECTIONS AS
- NECESSARY TO EXTEND THE MANHOLE TO THE ED ELEVATION THE FINAL ELEVATION MAY BE HIGHER THAN, LOWER THAN OR EQUAL TO THE EXISTING ELEVATION THIS DETAIL ILLUSTRATES A HIGHER ELEVATION. THE CONTRACTOR SHALL DETERMINE THE REQUIRED RISER AND CONE HEIGHTS TO MEET THE SPECIFIED ELEVATION. ENGINEER SHALL APPROVE FINAL ELEVATIONS IN THE FIELD. BOTTOM
- RISER TO BE PROVIDED WITH A FLAT JOINT UNLESS OTHERWISE APPROVED. CONTRACTOR TO INSTALL NEW RISER SECTION/EXISTING WALL JOINT TO BE PROVIDE A LEAK-TIGHT JOINT. THE CONTRACTOR SHALL PERFORM ALL WORK NECESSARY
- TO PROVIDE A LEAK-TIGHT SEAL WHERE POSSIBLE, BUTYL RUBBER SEALANT SHALL BE PROVIDED UNDER THE NEW RISER SECTION. IN ALL CASES, A CONCRETE COLLAR SHALL BE POURED AROUND THE JOINT. COLLAR TO BE MINIMUM 6 INCHES WIDE AND 12 INCHES HIGH
- ON THE INSIDE OF THE JOINT, CONTRACTOR TO SEAL JOINT WITH NON-SHRINK GROUT, GROUT TO COMPLETELY FILL JOINT AND SHALL EXTEND AT LEAST 6 INCHES EACH SIDE OF JOINT ALL AROUND. GROU TO BE TAPERED TO THE EXISTING WALL SECTION BELOW THE JOINT.

CENTERED ON JOINT ALL AROUND

GROUT TO BE RESISTANT TO HYDROGEN-SULFIDE. NO. DATE RAISE AND REPLACE EXISTING MANHOLE SHEET NO. SCALE: NOT TO SCALE DWG. BY: WKD 1 OF 1 DATE: 5/18/2015 PATH AND FILENAME:

